


A PARTIAL ELECTRICAL SITE PLAN
SCALE: 1 : 750

NOTES:
1. FIBRE OPTIC CABLE IS TO BE 62.5/125 MICRON MULTIMODE CONDUCTOR SUITABLE FOR DIRECT EARTH BURIAL. FIBRE OPTIC CABLE WILL ENTER THE BUILDING WITH THE POWER CONDUCTORS TO THE DAF INFLUENT GALLERY PLATFORM. THE FIBRE OPTIC CABLE WILL THEN CONTINUE TO THE THIRD FLOOR SERVER ROOM WHERE IT WILL BE TERMINATED AT A NEW FIBRE PATCH PANEL. FINAL LOCATION OF PATCH PANEL TO BE DETERMINED ON SITE.

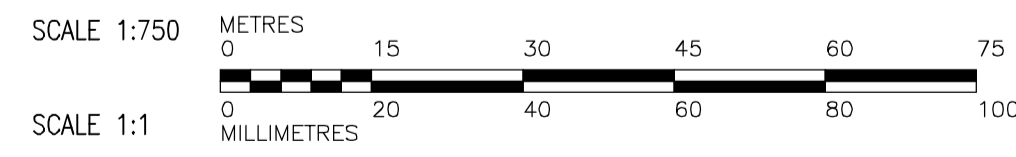

APEGM
Certificate of Authorization
Earth Tech Canada Inc.
No. 730

B.M. ELEV.			
DESIGNED BY	BLM	CHECKED BY	PS
DRAWN BY	ERC	APPROVED BY	AHL
SCALE:	AS SHOWN	RELEASED FOR CONSTRUCTION BY:	R. SOROKOWSKI
NO. REVISIONS	DATE	BY	DATE
02	ISSUED FOR ADDENDUM 7	07/12/21	
01	ISSUED FOR ADDENDUM 4	07/12/14	ERC
00	ISSUED FOR TENDER	07/11/09	ERC

CH2M HILL
Frederickson Cooper ARCHITECTS

EarthTech
A Tyco International Ltd. Company

ENGINEER'S SEAL
ORIGINAL SIGNED BY
P. STRYK
2007/11/09

CONSULTANT DRAWING NO.
WY-E0180

THE CITY OF WINNIPEG
WATER AND WASTE DEPARTMENT
ENGINEERING DIVISION

WATER TREATMENT PLANT
CONSTRUCTION OF ROADS AND LANDSCAPING

ELECTRICAL
SITE LIGHTING PLAN

CITY FILE NUMBER
SHEET OF

CITY DRAWING NUMBER
1-0601Y-A-E0180-001-02D