

INSTALL 2.44 m HIGH x 7.32 m WIDE ALPHA GATE C/W 3 STRANDS OF BARBED WIRE

PILE 0+181.373

CUT OFF ELEV 32.160

PILE 0+177.869

CUT OFF ELEV 32.160

INSTALL 3.05 m HIGH
CHAINLINK FENCE C/W 3
STRANDS OF BARBED WIRE—

O/S 7.395L-

O/S 15.728L —

PILE 0+185.484

PILE 0+183.416

CUT OFF ELEV 32.160

O/S 12.468L

CUT OFF ELEV 32.160

O/S 14.359L-

NOTES:

─INSTALL 3.05 m HIGH CHAINLINK

FENCE C/W 3 STRANDS OF


BARBED WIRE

CUT OFF ELEV 32.160

PILE 0+191.028


O/S 19.430L

- 1. ALL PAVEMENT DIMENSIONS ARE TO BACK OF CURB.
- 2. CONTACT THE WATER AND WASTE DEPARTMENT'S CONSTRUCTION SERVICES COORDINATOR AT 204-986-4289, 7 DAYS PRIOR TO THE COMMENCEMENT OF CONSTRUCTION TO ARRANGE FOR AN INSPECTION.
- 3. PRIOR TO ANY CONSTRUCTION, THE AQUEDUCT MUST BE EXPOSED BY A SOFT DIG METHOD SO AS TO CONFIRM DEPTH AND LOCATION.
- 4. A MINIMUM CLEARANCE OF 0.5m MUST BE PROVIDED BETWEEN THE UNDERSIDE OF THE PROPOSED WORKS AND THE TOP ANY EXISTING AQUEDUCT BY TRENCHLESS OR OPEN TRENCH.

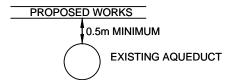

- 5. DO NOT OPERATE VIBRATORY EQUIPMENT OVER OR WITHIN 3.0m OF THE AQUEDUCT CENTERLINE.
- 6. CONCRETE DEMOLITION AND REMOVAL WITHIN 3 METERS HORIZONTALLY OF THE AQUEDUCT SHALL BE COMPLETED BY SAWCUTTING AND REMOVAL, OR BY THE USE OF HAND HELD JACKHAMMERS. USE OF MACHINE MOUNTED CONCRETE BREAKERS ABOVE THE AQUEDUCT SHALL NOT BE PERMITTED.
- 7. ADD 200.000m TO ABBREVIATED ELEVATIONS TO OBTAIN GEODETIC ELEVATIONS.

CENTERLINE - GEOMETRIC CONTROL POINT COORDINATES							
POINT/STATION	NORTHING	EASTING					
POT 0+150.000	9733.753	10347.099					
POT 0+200.000	9750.724	10394.130					

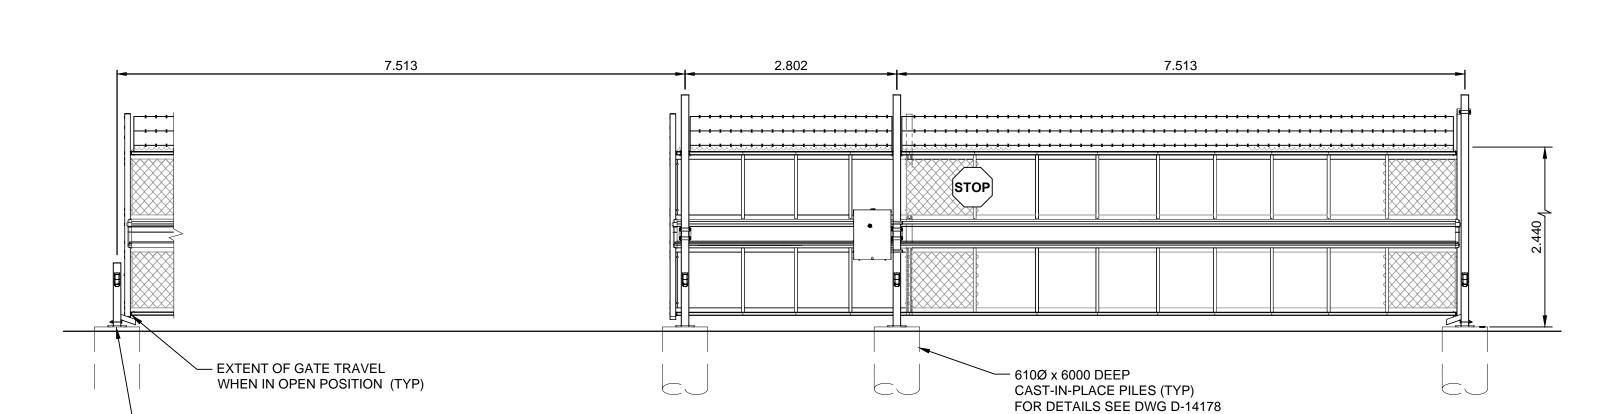

2.44m (8') HIGH x 7.32m (24') WIDE ALPHA GATE




W130024-PL-08.DWG

PLAN OF AUTOMATED GATE AREA

SCALE: 1:100 0 2.5 5.0m

LOCATION APPROVED UNDERGROUND STRUCTURES	ELE,	33-002 / 232.284m	Tblt. in S. wall of W. Bldg. S 681 Plinquet St., 5.8 m W. o		al Ltd.,	mı	
SUPR. U/G STRUCTURES DATE COMMITTEE							MORR
NOTE: LOCATION OF UNDERGROUND STRUCTURES AS SHOWN ARE BASED ON THE BEST INFORMATION AVAILABLE BUT NO GUARANTEE IS GIVEN THAT ALL EXISTING UTILITIES ARE SHOWN OR THAT THE GIVEN LOCATIONS ARE EXACT. CONFIRMATION OF EXISTENCE AND EXACT LOCATION OF ALL SERVICES MUST BE OBTAINED FROM THE INDIVIDUAL UTILITIES BEFORE PROCEEDING						DESIGNED BY	GFC
						DRAWN	DML
	D	ISSUED FOR	R ADDENDUM 1	16/03/03	GFC	BY	
	С	ISSUED FOR	RTENDER	16/02/05	GFC		AS SHOWN AS SHOWN
	В	ISSUED FOR	REVIEW	16/01/13	GFC		
	Α	ISSUED FOR	CLIENT REVIEW	14/07/17	GFC		
WITH CONSTRUCTION.	No.	REVISIONS		YY/MM/DD	BY	DATE	13/11/16

— GATE REST PORTAL

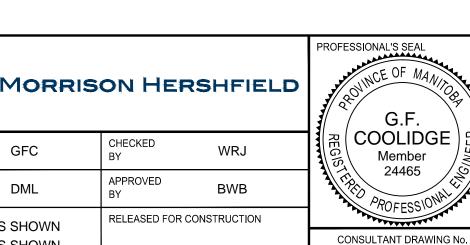

DATE



THE CITY OF WINNIPEG WATER AND WASTE DEPARTMENT

AUTOMATED SECURITY GATES & PAVEMENT
WORKS - McPHILLIPS PUMPING STATION &
PLINGUET YARD

PLINGUET YARD - MESSIER ACCESS
SITE PLAN & DETAILS

8 13
CITY DRAWING NUMBER

D-14032