


1 MAIN FLOOR PLAN - TRACK 13-24 - NEW CONSTRUCTION - PLUMBING
SCALE: 1/16" = 1'-0"

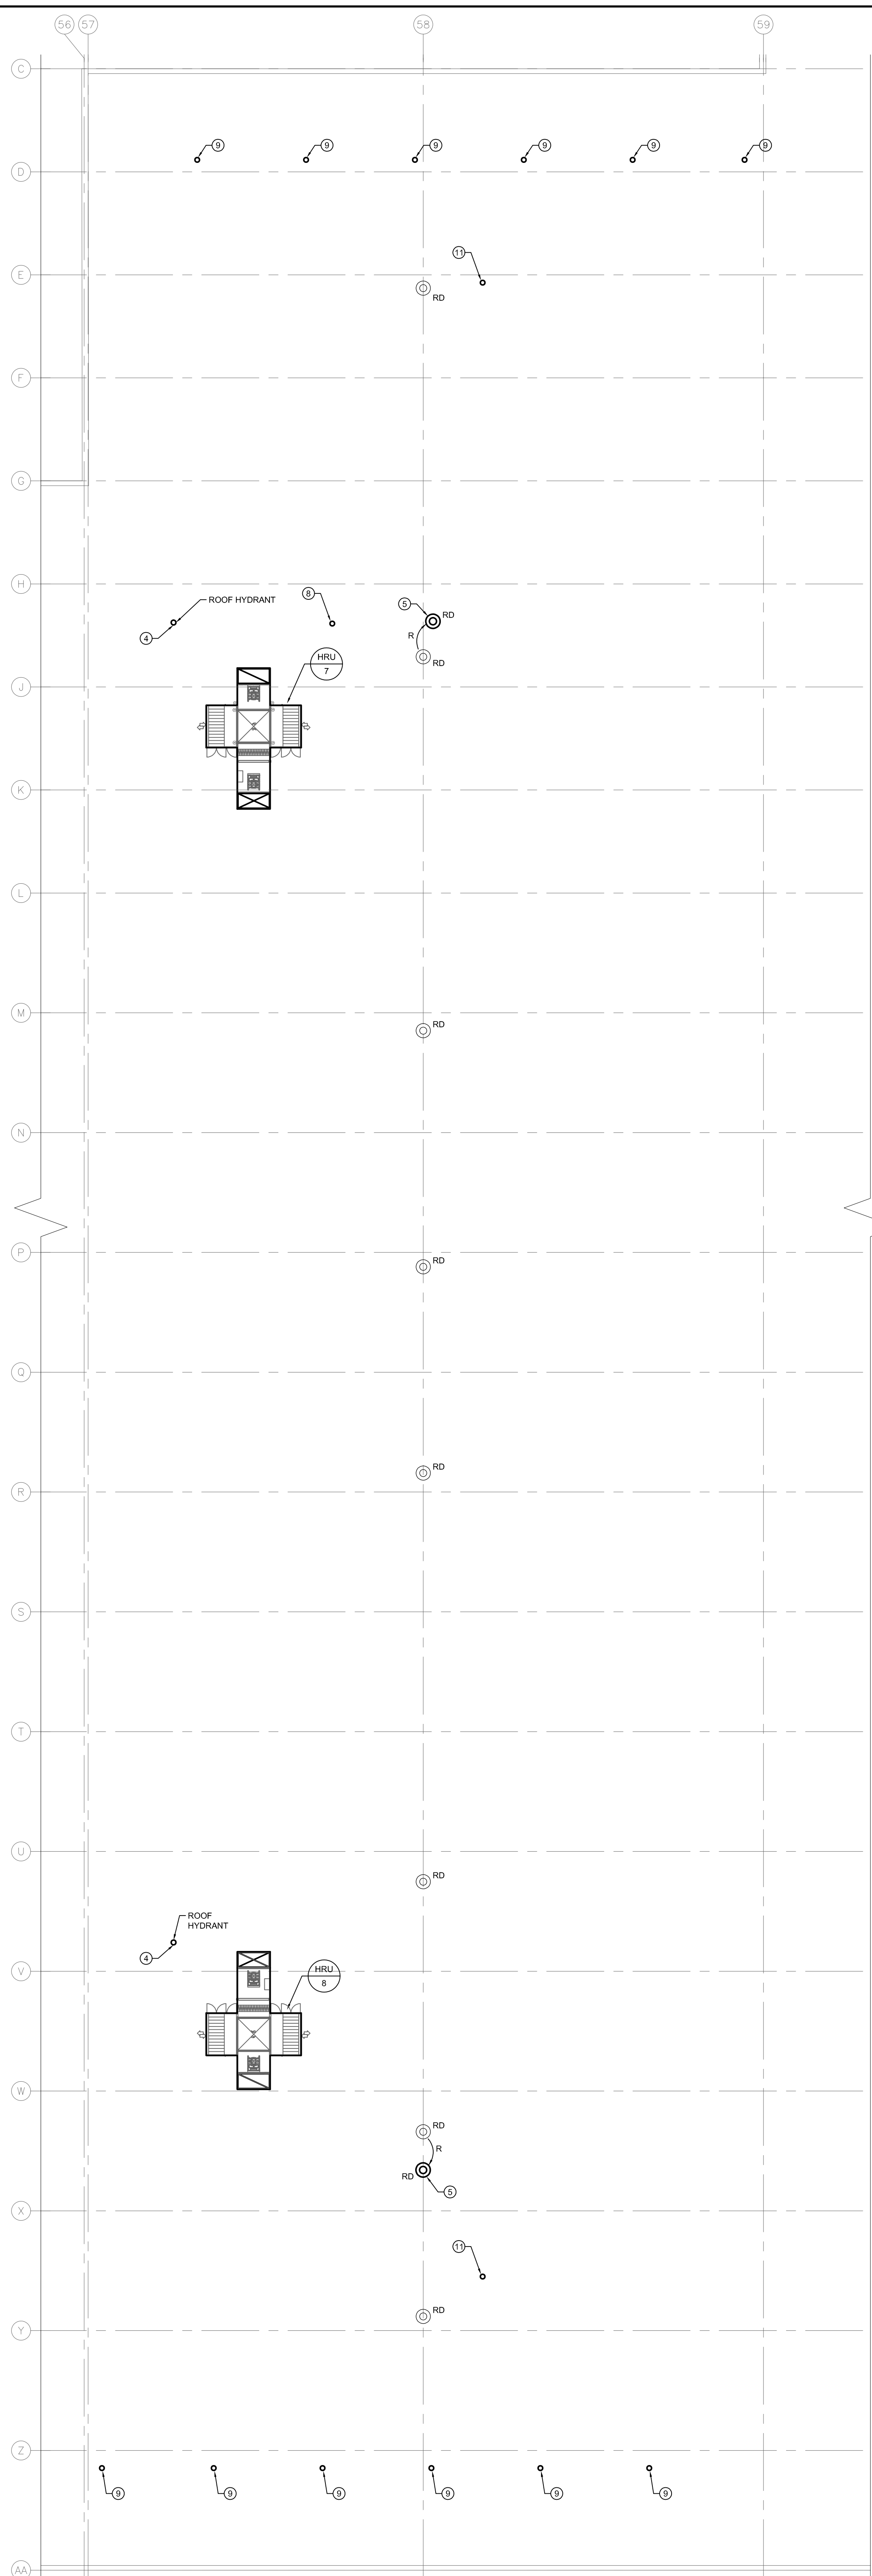


2 ROOF PLAN - TRACK 13-24 - NEW CONSTRUCTION - PLUMBING
SCALE: 1/16" = 1'-0"

GENERAL NOTES


- A. ALL ABANDONED EQUIPMENT AND SERVICES WITHIN AREA OF WORK SHALL BE REMOVED.
- B. THIS BUILDING MAY CONTAIN ASBESTOS. REFER TO FRONT END SPECIFICATIONS FOR FURTHER INFORMATION.
- C. REFER TO ROOF DETAILS AND SPECIFICATIONS FOR ALL NEW AND CAPPED OPENINGS.

KEY NOTES

1. CONNECT TO ROOF HYDRANT ABOVE ON ROOF.
2. CONNECT TO EXISTING WATER SUPPLY PIPING LINE. CONTRACTOR TO VERIFY EXACT LOCATION ON SITE.
3. REFER TO SCHEMATIC 340.1 FOR DETAILS OF NEW ROOF HYDRANT SYSTEM.
4. NEW ROOF HYDRANT LOCATED BESIDE BOTTOM OF ACCESS PLATFORM STAIR. COORDINATE FINAL LOCATION ON SITE.
5. RELOCATE EXISTING ROOF DRAIN OFFSET ASSOCIATED R/W TO SUIT NEW STEEL PLATFORM STANDS. SLOPE ROOF TO NEW ROOF DRAIN LOCATION.
6. PROVIDE HOT TAP FOR TIE-IN TO AVOID SHUTTING DOWN DOMESTIC WATER SERVICE.
7. PROVIDE NEW GAS FIRED INFRARED HEATER. INSTALL AS HIGH AS POSSIBLE BUT AT LEAST 5" ABOVE HEIGHT OF BUS. PROVIDE MAXIMUM ALLOWANCE STACKING HEIGHT SIGNS AND OTHER SIGNS REQUIRED BY MANUFACTURER. PROVIDE LOWER RADIANT SHIELD TO BURNER. INSTALL IN ACCORDANCE WITH MANUFACTURER REQUIREMENTS.
8. RELOCATE EXISTING PRV VENT. CONTRACTOR TO CONFIRM THE EXACT LOCATION ON SITE.
9. INSTALL FLUE VENT IN ACCORDANCE WITH MANUFACTURER REQUIREMENTS.
10. PROVIDE NEW THERMOSTAT AND WIRE TO BLACK BULL SENSOR MOUNTED BETWEEN UNITS. INSTALL IN ACCORDANCE WITH MANUFACTURER REQUIREMENTS.
11. PRV VENT THROUGH THE ROOF. PROVIDE WEATHER TIGHT SEAL. CONTRACTOR TO CONFIRM THE EXACT LOCATION ON SITE.

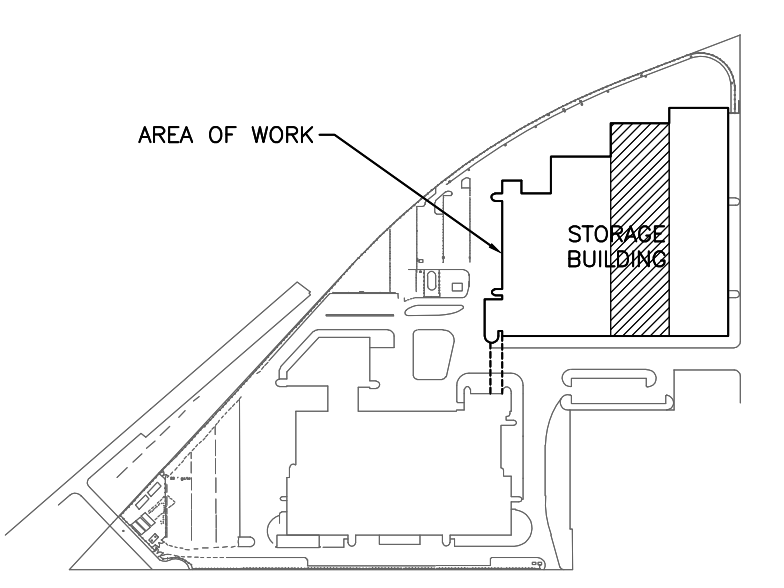

KEY PLAN
NTS

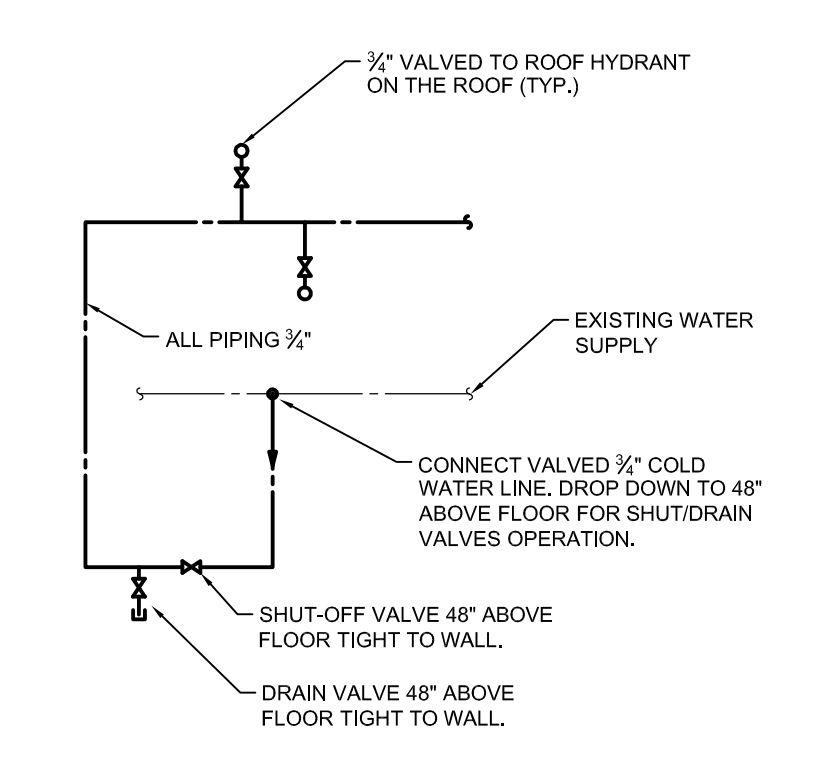

3 SCHEMATIC DETAILS
SCALE: NTS

| | | | |
|-----|-------------------------|----|----------|
| NO. | Description | BY | DDMMYY |
| 1 | ISSUED FOR ADDENDUM 3 | JH | 09/12/18 |
| 0 | ISSUED FOR CONSTRUCTION | JH | 09/11/18 |

ENGINEERS
GEOSCIENTISTS
MANITOBA
Certificate of Authorization
SMS Engineering Ltd.
No. 166

OFFICIAL
CONTRACT DRAWING
BONED AND SEALED BY
J.T. HOPKOCKS, P. ENG
NOVEMBER 9, 2018

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Project Title
CITY OF WINNIPEG FORT ROUGE TRANSIT BASE - STORAGE TRACK 13-24 - MECHANICAL UPGRADE

WINNIPEG MANITOBA
MAIN FLOOR AND ROOF PLAN - TRACK 13-24 - NEW CONSTRUCTION - PLUMBING

| | | |
|-----------------|----------------|-------------|
| Drawn By | Checked By | Approved By |
| AS/AS | XZ | JH |
| Scale | Date | Project No. |
| AS NOTED | NOVEMBER, 2018 | 18-240-01 |
| Revision Number | Drawing Number | Sheet Order |
| 1 | M2.1 | 6 OF 12 |