
NOTES:

- STATION IN CENTRE OF RIGHT-OF-WAY UNLESS OTHERWISE NOTED.
- WEST PROPERTY LINE OF ROTHESAY AVENUE IS STA 1+00
- 3. ALL MEASUREMENTS TO BACK OF CURB. 4. ALL EXISTING TREES TO BE PROTECTED AND MAINTAINED THROUGHOUT
- CONSTRUCTION UNLESS NOTED OTHERWISE. 5. HAND OR SOFT DIG METHODS REQUIRED OVER GAS UTILITIES AT INTERVALS
- DETERMINED BY THE CONTRACT ADMINISTRATOR TO DETERMINE DEPTH OF COVER. 6. NO WORKS, INCLUDING CONCRETE CUTTING OR BREAKING, TO BE UNDERTAKEN NEAR GAS LINES UNTIL DEPTH OF COVER IS DETERMINED AND A MANITOBA
- HYDRO SAFETY WATCH REPRESENTATIVE IS ON SITE. NO VIBRATORY COMPACTION PERMITTED WITHIN 1.0M OF GAS MAINS.
- 8. INSTALL MODIFIED BARRIER CURB AT ALL INTERSECTION RADII, ALLEY RADII, AND BULLNOSES.
- 9. CONSTRUCT NEW MONOLITHIC CURB RAMP (10mm HEIGHT INTEGRAL) 10. INSTALL DETECTABLE WARNING SURFACE TILE AT STREET INTERSECTIONS.
- 11. REMOVE EXISTING CURB AND CONSTRUCT NEW BARRIER CURB 150mm REVEAL,
- 12. INSTALL CATCH BASIN AND BARRIER CURB AND GUTTER INLET FRAME (SD-023). INSTALL NEW 250 LEAD @ 2% MINIMUM GRADE
- 13. CONSTRUCT ASPHALT OVERLAY ON DRIVEWAYS TO ACHIEVING MINIMUM GRADE
- 14. CONCRETE REPAIRS SHOWN BASED ON VISUAL INSPECTION PRIOR TO REMOVAL OF ASPHALT OVERLAY. FINAL REPAIR LIMITS AND DIMENSIONS MAY VARY FROM
- 15. ADJUST ALL WATER VALVES, WATER SERVICE VALVES, MANHOLES AND CATCH BASINS TO GRADE.

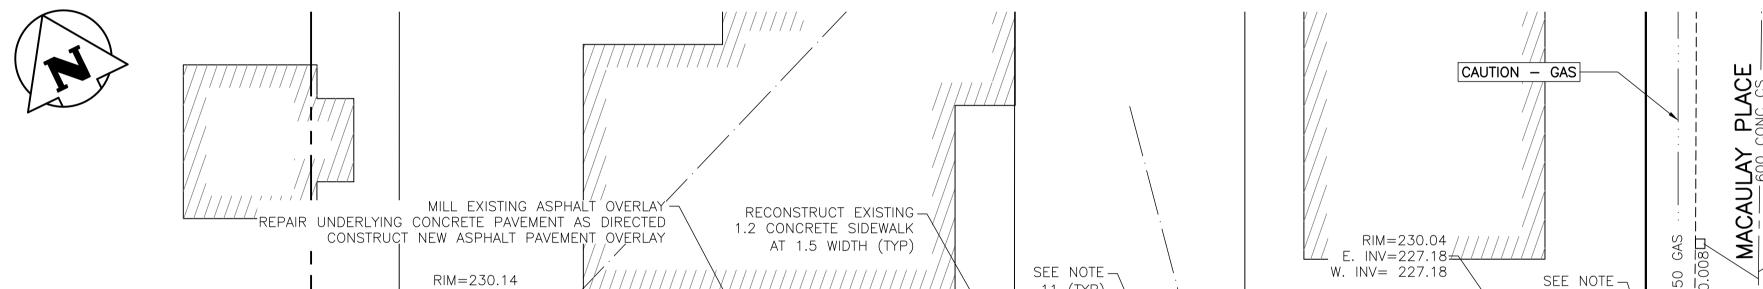

LIMIT OF PROPOSED WATER MAIN RENEWAL (BY OTHERS) -SEE NOTE 9 & 10 (TYP) 11 (TYP) -E. INV = 227.398 (TYP) CAUTION: W. INV=227.68 WATER VALVE #459 #475 #465 \ #471 { } I €³ €°} 230.415 8.500

#474

FULL DEPTH-

REPAIR (TYP)

LOCATION OF ALL SERVICES MUST BE

OBTAINED FROM THE INDIVIDUAL UTILITIES

BEFORE PROCEEDING WITH CONSTRUCTION.

CONCRETE PAVEMENT

_ _4+25 _

CAUTION:

(BY OTHERS)

NO. REVISIONS

WATER VALVE

AND HYDRANT

LIMIT OF PROPOSED -

WATER MAIN RENEWAL

-4+00 230.446

CAUTION - GAS

3+150 450 CONC (230.219) EDISON AVENUE #470 #460 CAUTION: WATER VALVE AND HYDRANT

EDISON AVENUE - PLAN

LEGEND-PROFILE

|R|**|--**

COORDINATE SYSTEM: CGVD28 ENGINEER'S SEAL LOCATION APPROVED **KGS** UNDERGROUND STRUCTURES GROUP CONSULTING ENGINEERS SUPV. U/G STRUCTURES COMMITTÉE DESIGNED CHECKED LOCATION OF UNDERGROUND STRUCTURES AS SHOWN ARE BASED ON THE BEST INFORMATION DRAWN APPROVED VAILABLE BUT NO GUARANTEE IS GIVEN RE-ISSUED FOR TENDER 19/05/08 THAT ALL EXISTING UTILITIES ARE SHOWN OR THAT THE GIVEN LOCATIONS ARE EXACT.
CONFIRMATION OF EXISTENCE AND EXACT

DATE

RIM = 230.04N. INV=227.32

E. INV=227.17

W. INV=227.17

THE CITY OF WINNIPEG PUBLIC WORKS DEPARTMENT ENGINEERING DIVISION

2019 LOCAL STREET PACKAGE

THE WATER DISTRIBUTION SYSTEM IN THIS AREA IS CATHODICALLY PROTECTED. ANY DAMAGE TO THIS SYSTEM MUST BE REPORTED TO THE WATER AND WASTE DEPARTMENT IMMEDIATELY AND ALL COSTS. MATERIALS AND LABOUR ASSOCIATED WITH

THE RESTORATION OF THIS SYSTEM WILL BE THE RESPONSIBILITY OF THE CONTRACTOR.

EDISON AVENUE

OMPUTER FILE NAME 18-0107-016_35 EDISON.DWG CITY DRAWING NUMBER

10.0 15.0 20.0m

LOCATIONS OF UNDERGROUND

NO GUARANTEE IS GIVEN THAT ALL

THE GIVEN LOCATIONS ARE EXACT.

BEFORE PROCEEDING WITH

CONSTRUCTION.

STRUCTURES AS SHOWN ARE BASED ON THE BEST INFORMATION AVAILABLE. BUT

EXISTING UTILITIES ARE SHOWN OR THAT

CONFIRMATION OF THE EXISTENCE AND

EXACT LOCATION OF ALL SERVICES MUST

BE OBTAINED FROM INDIVIDUAL UTILITIES

PROPERTY LIMITS DELINEATION

DELINEATION OF PROPERTY LIMITS AS

WARRANTY AS TO THE ACCURACY OF

PROPERTY LIMITS DELINEATED ON THIS DWG, NOR ON THE DIMENSIONAL ACCURACY OF DWG FEATURES RELATIVE

SHOWN ON THIS DWG DOES NOT REPRESENT A "LEGAL SURVEY". KGS GROUP MAKES NO REPRESENTATION OR

TO THOSE PROPERTY LIMITS.

WARNING

NOTIFY THE GAS COMPANY OF THE

GAS COMPANY INSTALLATIONS.

DETAILS.

PROPOSED LOCATION OF EXCAVATION.

METRIC

WHOLE NUMBERS INDICATE MILLIMETRES DECIMALIZED NUMBERS INDICATE METRES

NOT TO BE USED FOR CONSTRUCTION

TAKE PRECAUTION TO AVOID DAMAGE TO

SEE PROVINCIAL REGULATION 210/72 FOR

5.0

SCALE: 1:250m (A1)

SCALE: 1:10m (A1)

0		
		_
2	-	_
) 	-	_
) -)	-	
2		
(A-1		
-		

EXISTING

LEGEND-PLAN

PROPOSE

LAND DRAINAGE SEWER <u>300 lds</u> WASTE WATER SEWER 250 WWS TEST HOLE <u>250 WWS</u> GAS GUY WIRE HYDRO LIGHT STANDARD ••• _____ _____ BACK OF CURB M.T.S. <u> 150 WM</u> WATERMAIN CONCRETE © PROFILE ASPHALT —□ NORTH & WEST GUTTE HYDRANT D----⊙|SOUTH & EAST GUTTER|**O-----⊙|** \otimes VALVE \otimes SIDEWALK \circ MANHOLE PROPERTY LINE N/W LANE P CATCH BASIN SURVEY BAR S/E MEDIAN R ∇ CURB INLET EODETIC BENCHMARK PARKING/DRIVEWAY \bigcirc WINDOW/DOOR SILL POLES T-MTS 231.334 (32.231)77777 ELEVATION

LEGEND-PLAN

PROPOSE

EXISTING

EXISTING

HOR. SCALE: 1:250 RELEASED FOR 19/05/02 JB ISSUED FOR TENDER CONSTRUCTION: /ERTICAL: 1:10 19/03/05 JB A ISSUED FOR REVIEW

4+50

CAUTION:

2019/01/24

DATE

WATER VALVE

#486

CONSULTANT DRAWING NO. C111

#490

-PROPOSED WATER

MAIN RENEWAL

(BY OTHERS)

PLAN AND PROFILE

3+50 TO 4+75

21 11