



PROFILE
SCALE: 1:250H 1:100V

NOTE: CHAINAGES SHOWN ARE ALONG ϕ CULVERT

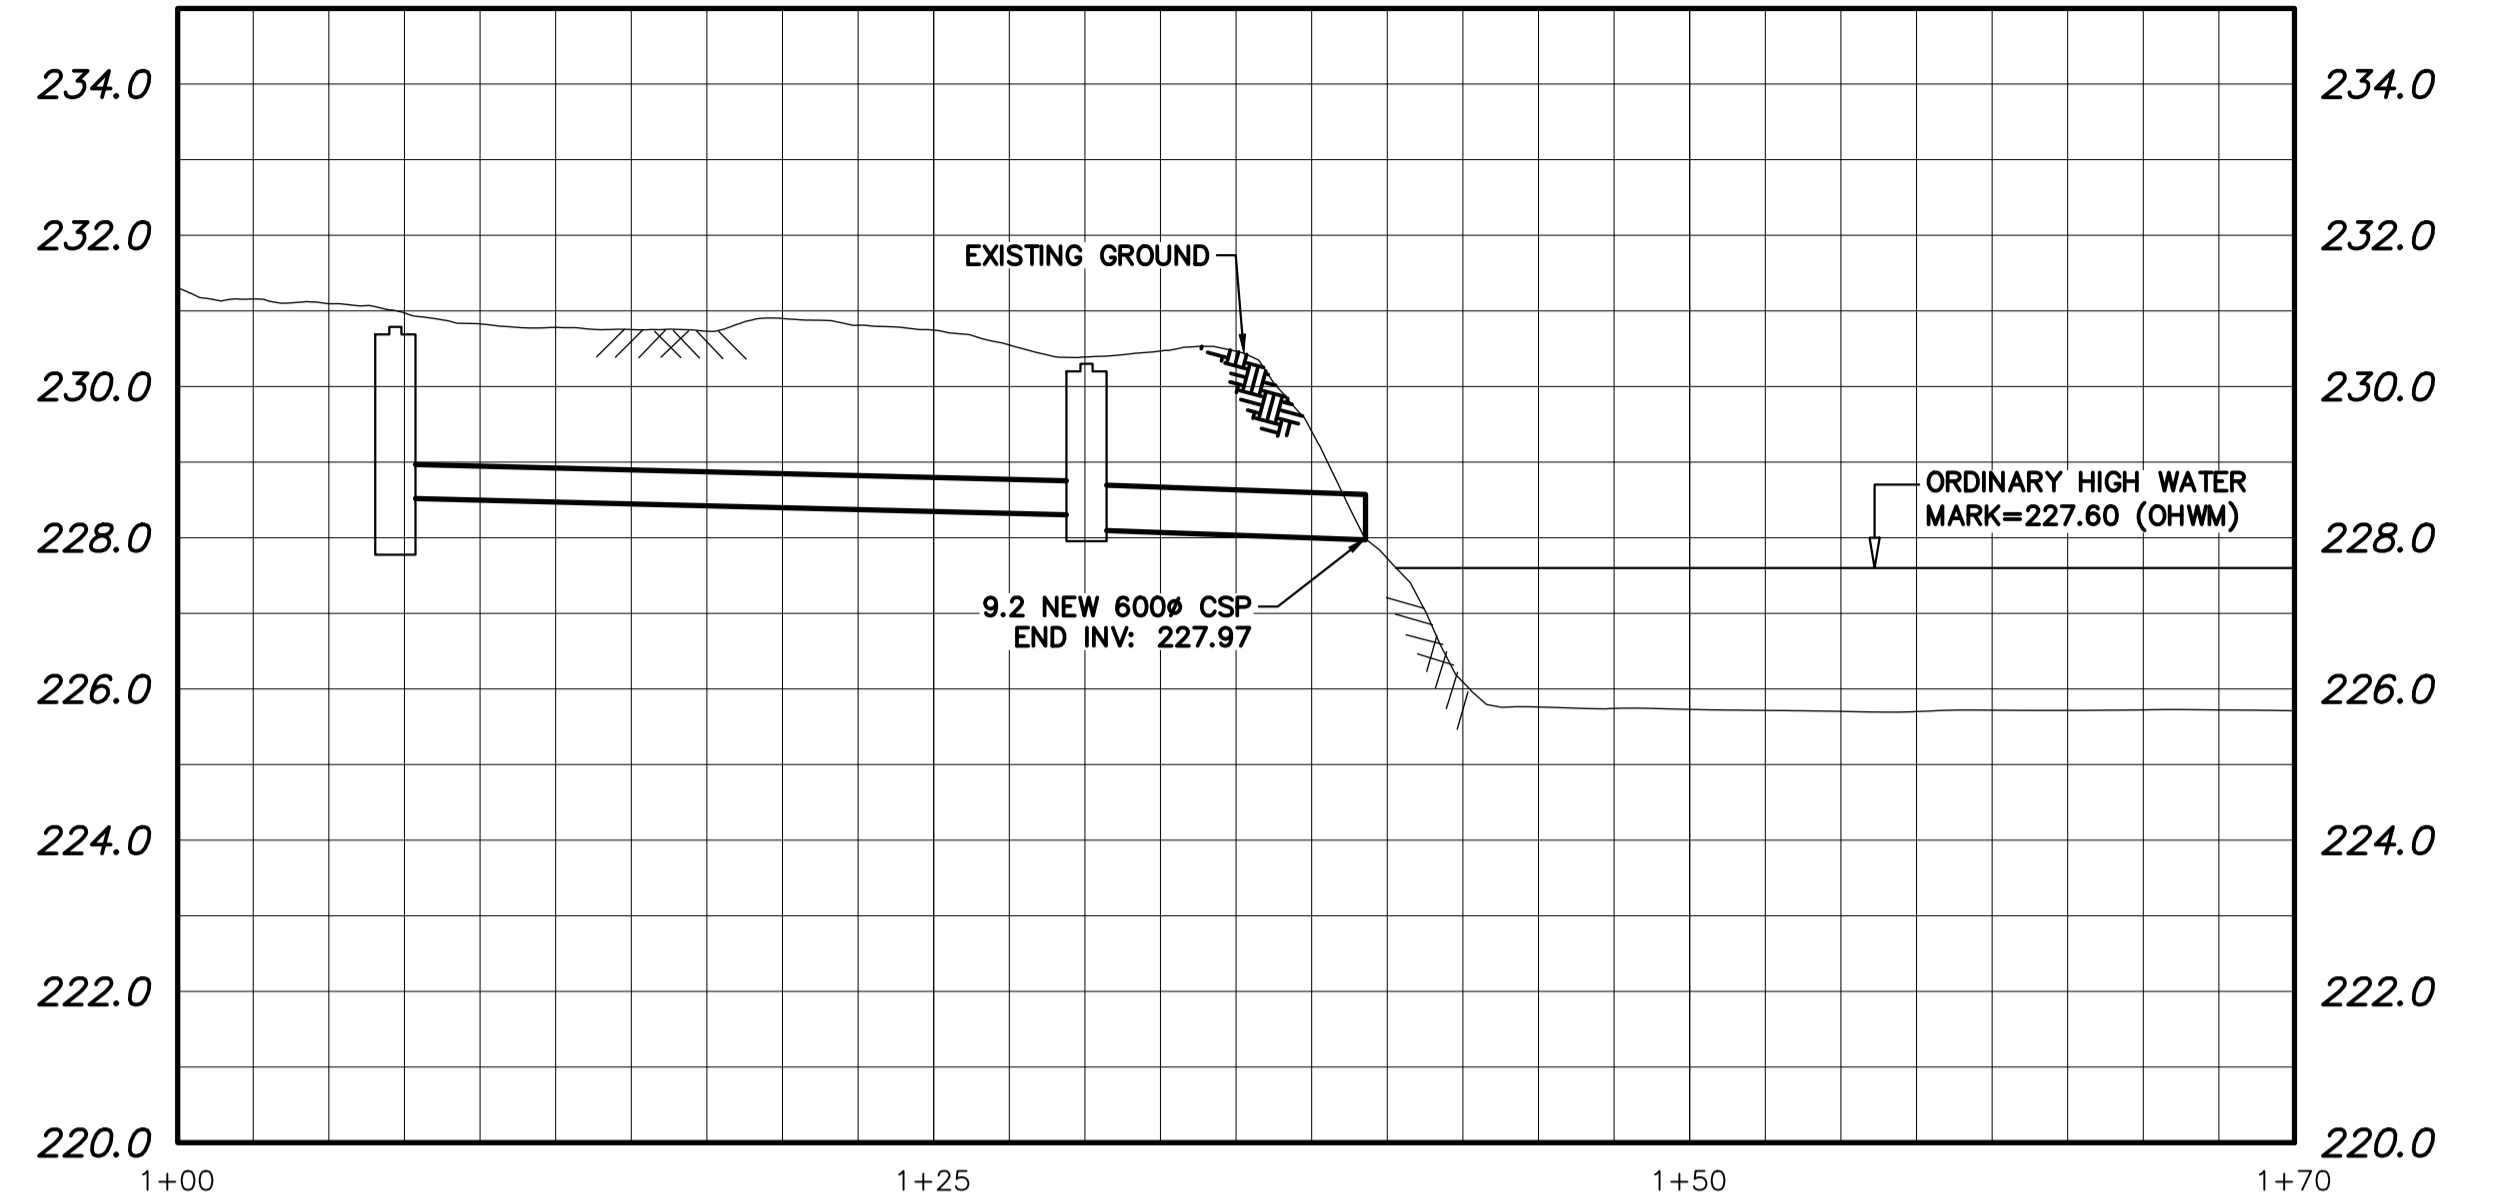


PROFILE
SCALE: 1:250H 1:100V

NOTE: CHAINAGES SHOWN ARE ALONG ϕ CULVERT & SWALE

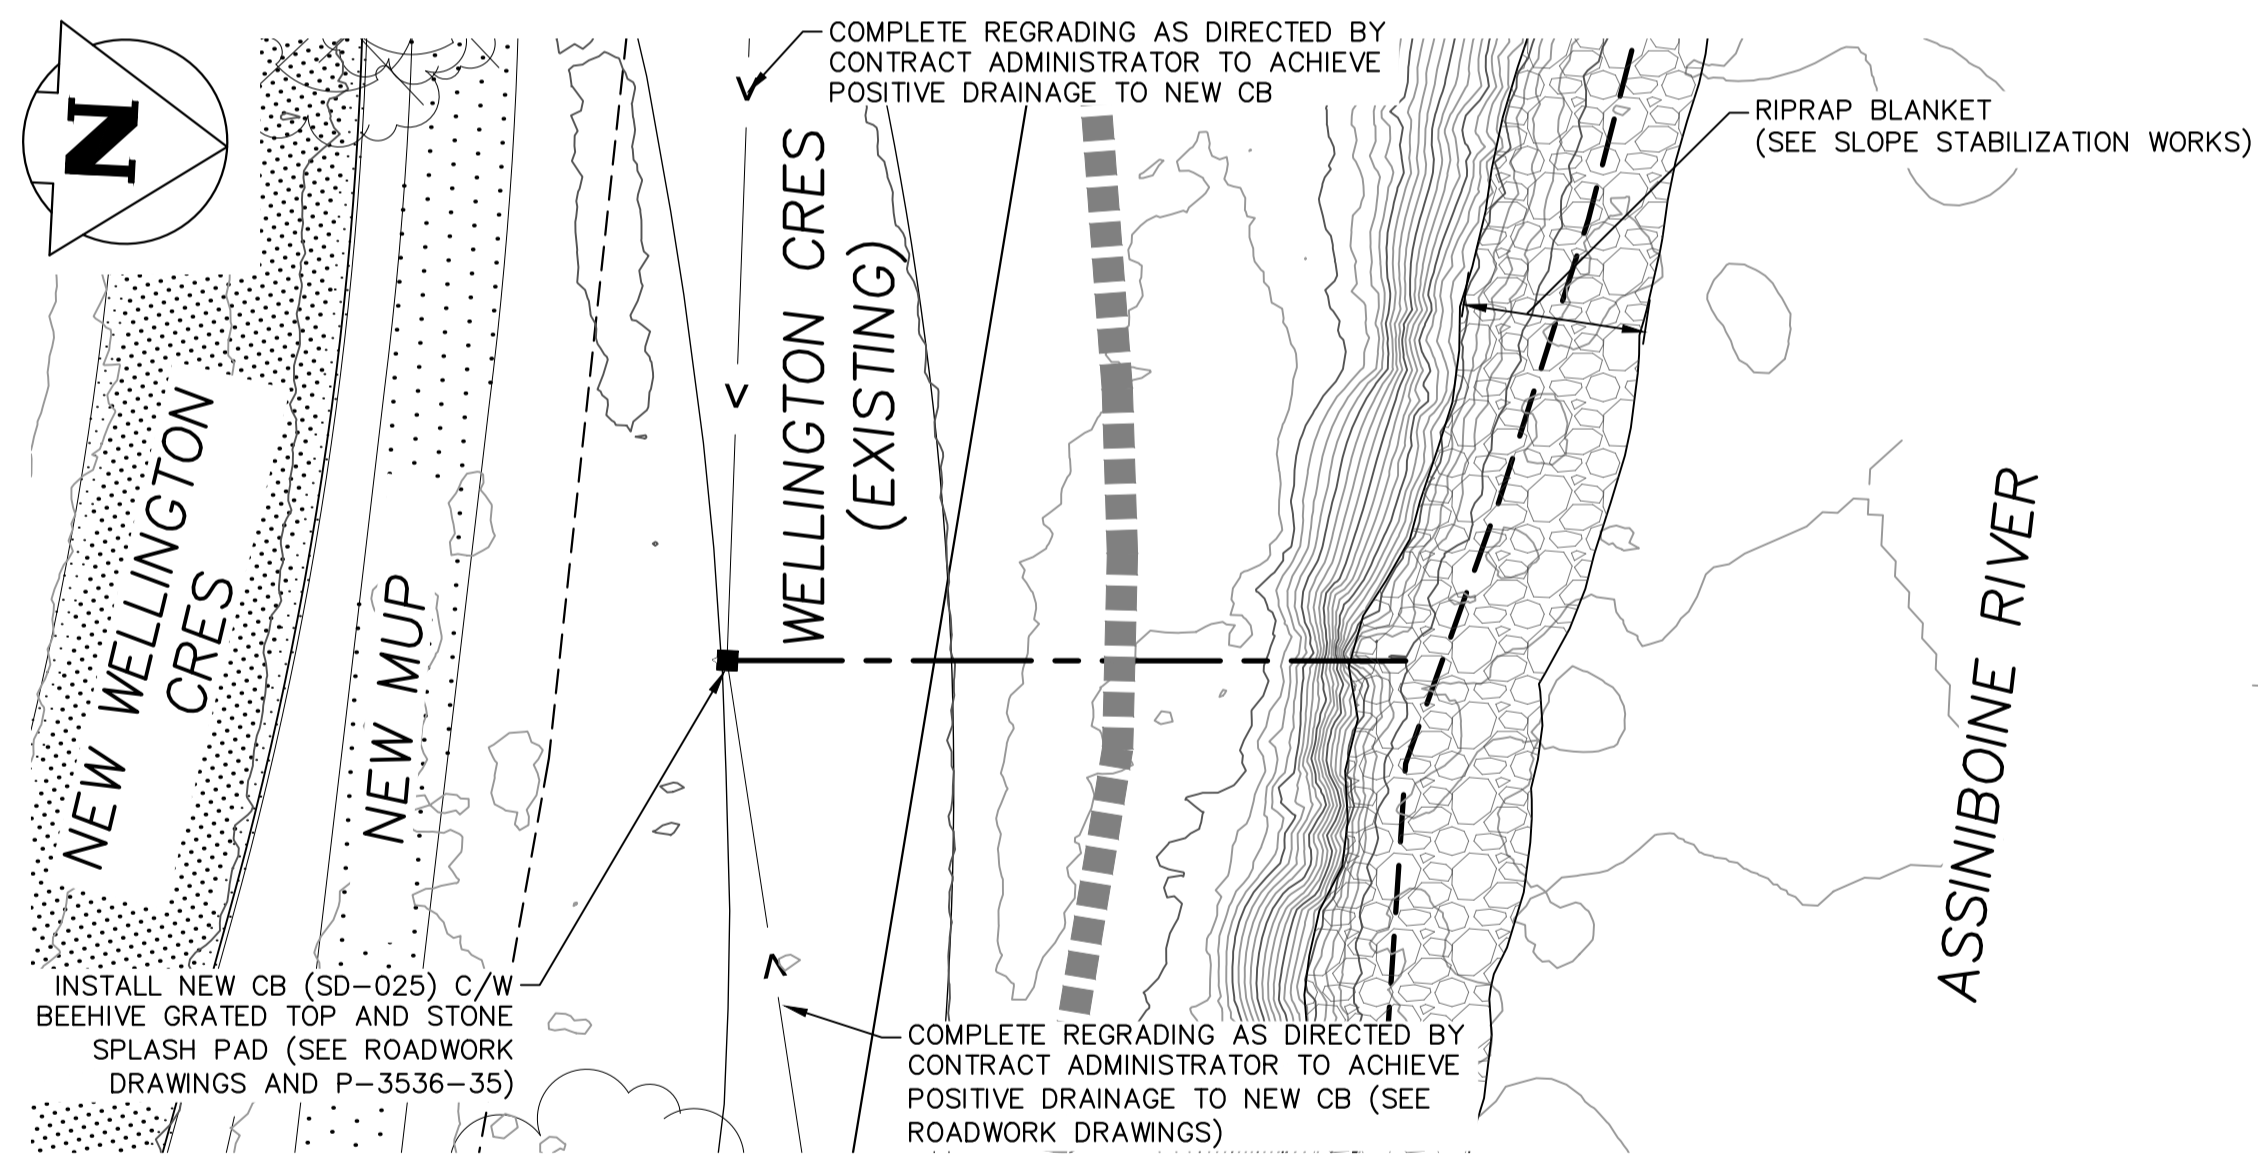

STORM DRAIN-14 PLAN
SCALE: 1:250

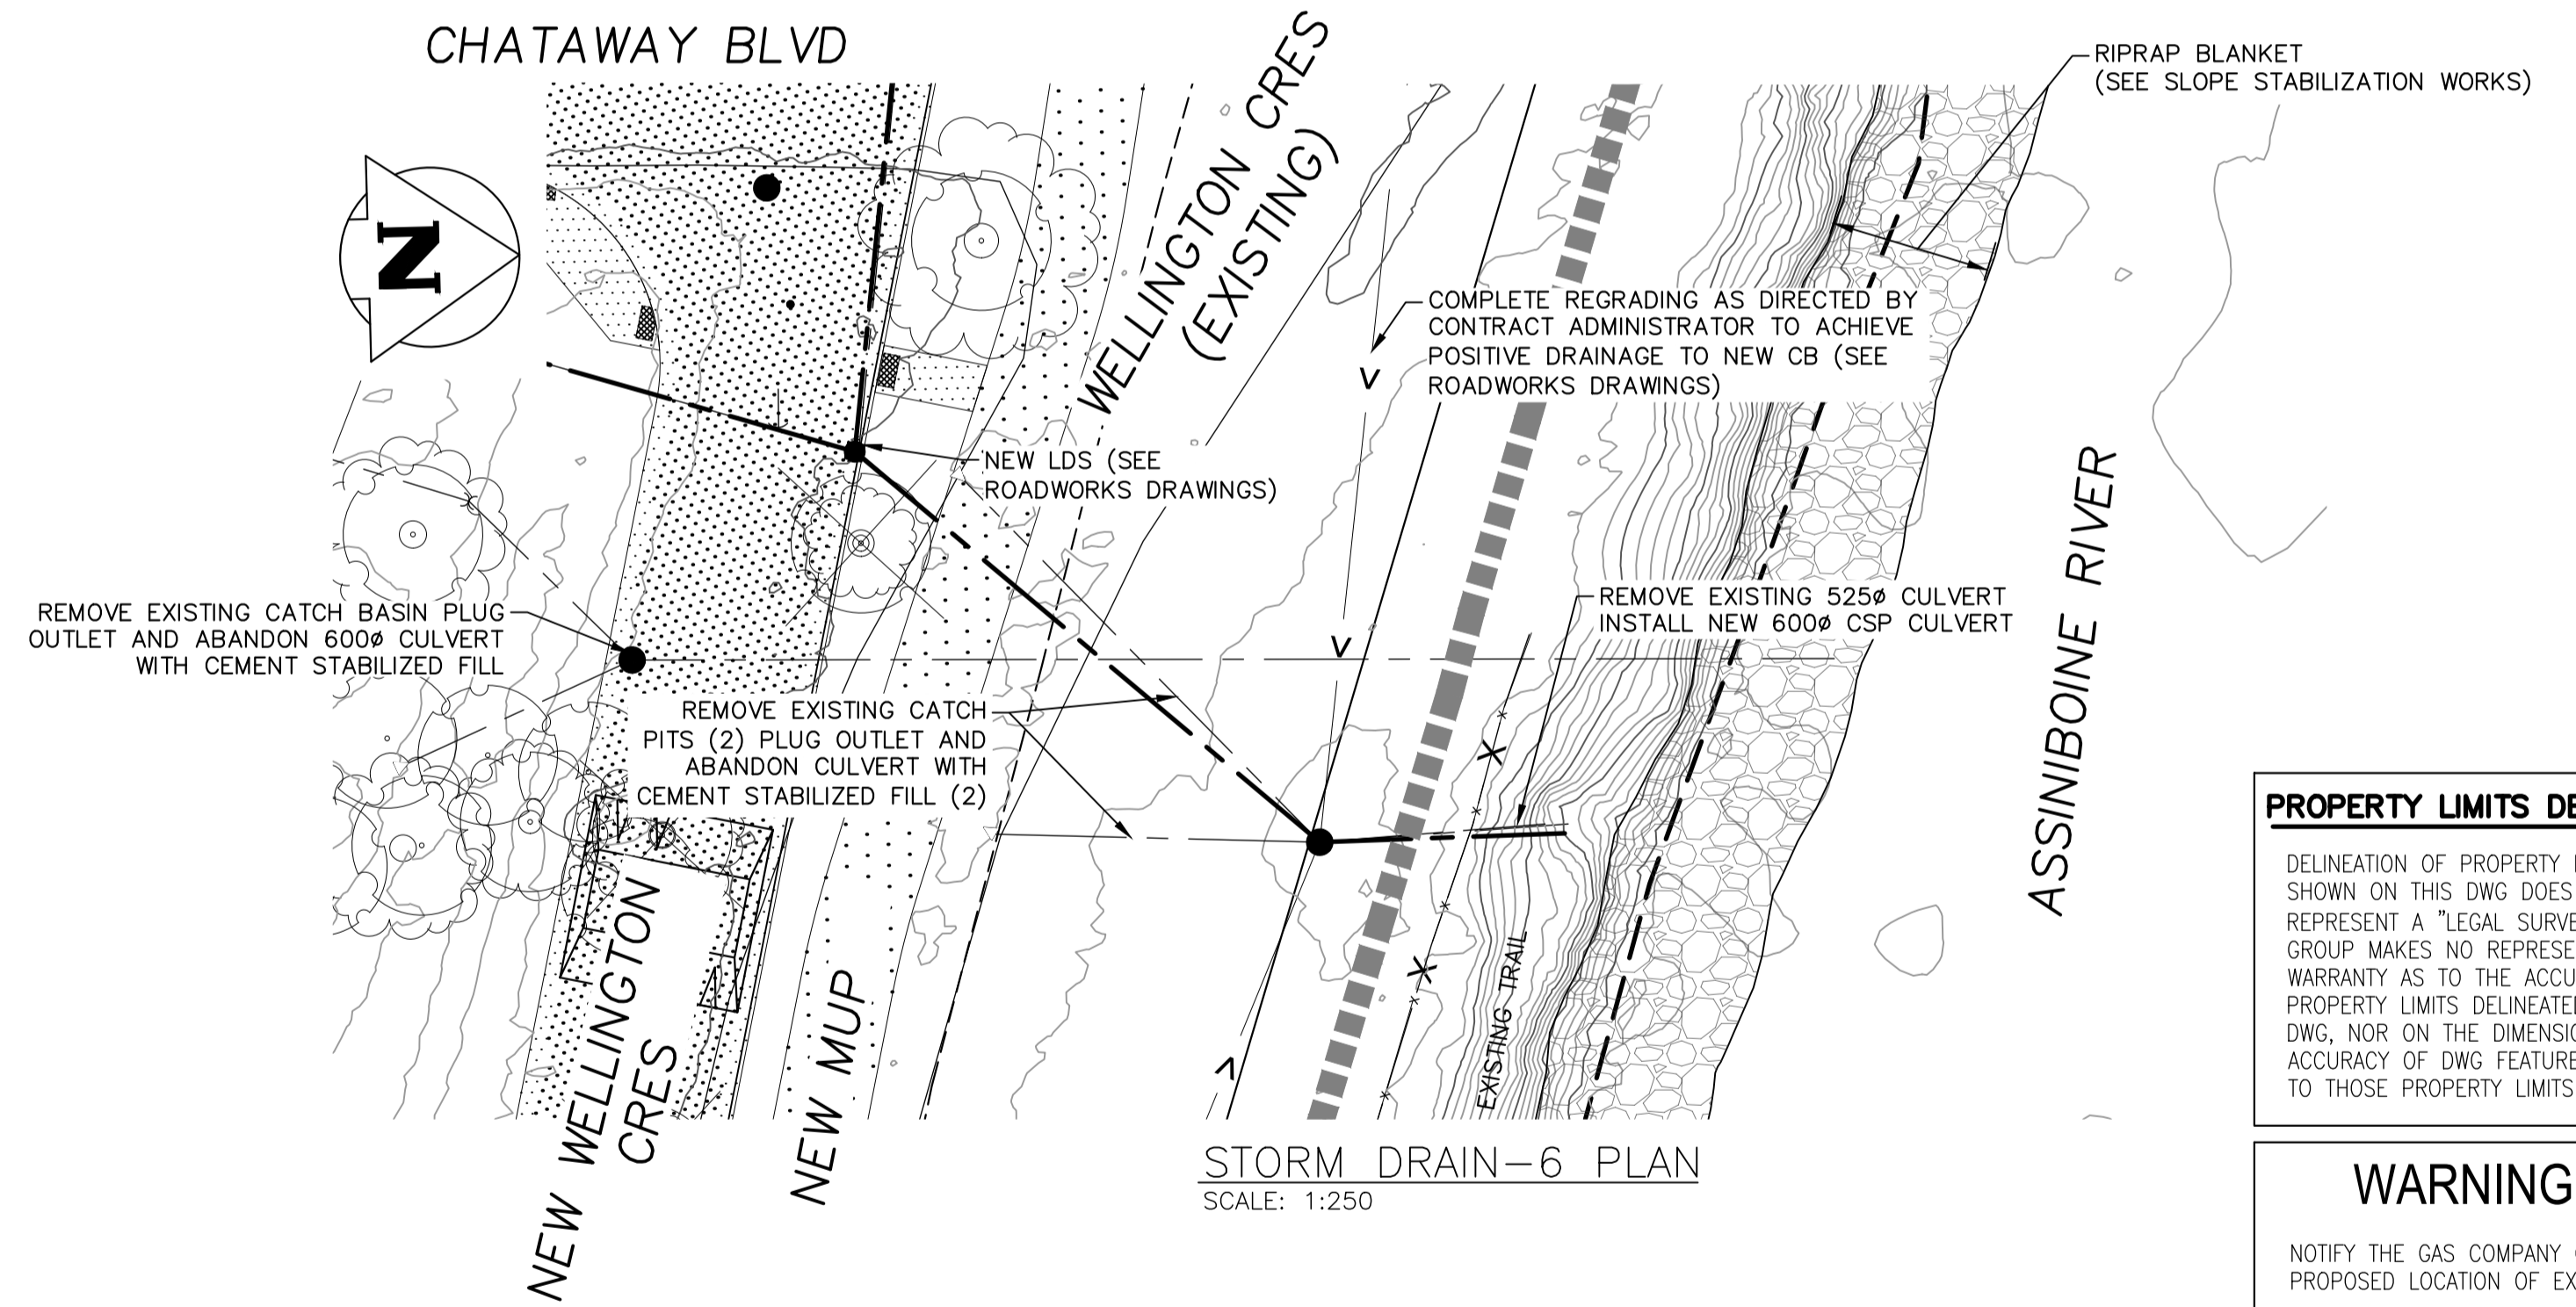

STORM DRAIN-6 PLAN
SCALE: 1:250

PROPERTY LIMITS DELINEATION

DELINEATION OF PROPERTY LIMITS AS SHOWN ON THIS DWG DOES NOT REPRESENT A "LEGAL SURVEY". KGS GROUP MAKES NO REPRESENTATION OR WARRANTY AS TO THE ACCURACY OF PROPERTY LIMITS DELINEATED ON THIS DWG, NOR ON THE DIMENSIONAL ACCURACY OF DWG FEATURES RELATIVE TO THOSE PROPERTY LIMITS.

WARNING

NOTIFY THE GAS COMPANY OF THE PROPOSED LOCATION OF EXCAVATION.
TAKE PRECAUTION TO AVOID DAMAGE TO GAS COMPANY INSTALLATIONS.
SEE PROVINCIAL REGULATION 210/72 FOR DETAILS.

METRIC

WHOLE NUMBERS INDICATE MILLIMETRES
DECIMALIZED NUMBERS INDICATE METRES

- NOTES:
1. ALL CSP MANHOLE CONNECTIONS TO BE 150 REINFORCED CONCRETE COLLAR C/W WATERSTOP GROUT RING.
2. EXACT ALIGNMENT AND PROFILE TO BE AS DIRECTED BY CONTRACT ADMINISTRATOR. APPROXIMATE LOCATIONS SHOWN.



300 LDS	LAND DRAINAGE SEWER	300 LDS		TEST HOLE			
250 WWS	WASTE WATER SEWER	250 WWS		GUY WIRE			
	GAS			LIGHT STANDARD	X X	C PROFILE	X X
	HYDRO			BACK OF CURB	□ □	NORTH & WEST GUTTER	□ □
	M.T.S.			CONCRETE	▨ ▨	SOUTH & EAST GUTTER	□ □
150 WM	WATERMAIN	150 WM		ASPHALT	▨ ▨	NORTH & WEST DITCH	▨ ▨
	HYDRANT			SIDEWALK	▨ ▨	SOUTH & EAST DITCH	▨ ▨
	VALVE			PROPERTY LINE	— —	N/W LANE P L	— —
	MANHOLE			SURVEY BAR	⊕	S/E MEDIAN P L	— —
	CATCH BASIN			GEODETIC BENCHMARK	⊕	PARKING/DRIVEWAY	— —
	CURB INLET			ELEVATION	232.231	WINDOW/DOOR SILL	— —
	POLES		231.334				
EXISTING	LEGEND-PLAN	PROPOSED	EXISTING	LEGEND-PLAN	PROPOSED	EXISTING	LEGEND-PROFILE
							PROPOSED

LOCATION APPROVED UNDERGROUND STRUCTURES

SUPV. U/G STRUCTURES DATE COMMITTEE

NOTE:
LOCATION OF UNDERGROUND STRUCTURES AS SHOWN ARE BASED ON THE BEST INFORMATION AVAILABLE BUT NO GUARANTEE IS GIVEN THAT ALL EXISTING UTILITIES ARE SHOWN OR THAT THE GIVEN LOCATIONS ARE EXACT. CONFIRMATION OF EXISTENCE AND EXACT LOCATION OF ALL SERVICES MUST BE OBTAINED FROM THE INDIVIDUAL UTILITIES BEFORE PROCEEDING WITH CONSTRUCTION.

B.M.	KGS_BASE	COORDINATE SYSTEM:	CGVD28
ELEV.	249.213		
NO.	REVISIONS	DATE	BY
1	RE-ISSUED FOR TENDER	20/10/15	RBO
0	ISSUED FOR TENDER	20/10/05	RBO

		ENGINEER'S SEAL	
		DESIGNED BY: NGV	CHECKED BY: RBO
DRAWN BY: GEL		APPROVED BY: RBO	
HOR. SCALE: 1:250		RELEASED FOR CONSTRUCTION:	
VERTICAL: 1:100		DATE: 04/21/20	

PROJECT TITLE	CONSULTANT DRAWING NO.
WELLINGTON CRESCENT RIVERBANK, PATH AND ROADWAY PROJECT	CU-07d

THE CITY OF WINNIPEG PUBLIC WORKS DEPARTMENT ENGINEERING DIVISION	
SHEET 30 OF 69	COMPUTER FILE NAME
STORM DRAINS SD-14 AND SD-6/19 PLAN AND PROFILES	
CITY DRAWING NUMBER P-3536-23	