α4 I I	FAN
×	
DY4mm	DES
294	MFG
	MAI
Λ	сст
Ā	
	1

PANEL				AMPS:		V	OLTS	:	F	HASE:		WIRE:	SURF. MOUNT
	PNL-F73			100	A	· ·	120)/240V		1ø		3W	FLUSH MOUNT
DESC	RIPTION: 120/240V DISTRIBUTION PANELBOARD									LOCATION:		MAIN FLOO	R
MFG ,	^{/ MODEL:} SQUARE D NF									INTERRUPT	ING RATIN	^{iG:} 14 kA	
MAIN	^{BREAKER:} 100A									INST. SETT	INGS:	N/A	
CCT.	DESCRIPTION	NOTE	WIRE (AWG)	BRKR AMPS	LOAD (VA)		 2	LOAD (VA)	BRI AMF		NOTE		
1	INTERIOR LIGHTING		12	15	1042		+1	350	15	5 12		CONTROL PANE	L CP-F81
3	PHOTOCELL JUNCTION BOX, OUTDOOR LIGHTING		12	15	120]+	┿Г	200	15	5 12		HVAC PANEL JE	BA-F83
5	EMERGENCY LIGHTING BATTERY BANK		12	15	100]∔-	+ľ	800	15	5 12	GFCI	SUMP PUMP R	ECEPTACLE
7	MAIN FLOOR RECEPTACLES		12	15	360	1+	∔ľ	360	15	5 12	GFCI	DRY WELL REC	EPTACLES
9	MAIN FLOOR RECEPTACLES		12	15	360	1∔-	+ľ	360	15	5 12	GFCI	DRY WELL REC	EPTACLES
11	COMBINED SEWER OVERFLOW (CSO) PANEL		12	15	150	1+	∔ľ	480	20) 12	GFCI	OUTDOOR RECE	PTACLES
13	SPARE			15		1∔-	4ľ		15	5		SPARE	
15	SPARE			15		1+	∔ľ		15	5		SPARE	
17	SPARE			15		┤╇╴	4ľ		15	;		SPARE	
19	SPARE			15		1+	∔¦		15	;		SPARE	
21	SPARE			15		┤╇╴	4ľ		15	;		SPARE	
23	SPARE			15		1+	∔ľ		15	5		SPARE	
25	SPARE			15		1∔-	+ľ		15	5		SPARE	
27	SPACE					1+	∔¦					SPACE	
29	SPACE					┤╇╴	4ľ					SPACE	
31	SPACE					1+	- ↓ [SPACE	
33	SPACE					1∔-	+ľ					SPACE	
35	SPACE					1+	∔†					SPACE	
37	SPACE					┤╇	4 t					SPACE	
39	SPACE					1+	∔†					SPACE	
41	SPACE					1∔-	4†					SPACE	
	CONNECTED LOAD: 4.282 KVA		LINE 1	•	2.132 k\	//	1-	7.76 A			_		NOTE LEGEND:
	4.202 NVA		LINE 1 LINE 2		2.132 kv 2.550 kv			7.76 A 7.92 A					AFCI ARC F GFCI GROUI LOCK LOCKE

NOTES: 1. ALL BREAKERS ARE SINGLE-POLE UNLESS OTHERWISE IDENTIFIED.


		MODEL	I	LAMPS		LOAD		NOTE
TYPE	MANUFACTURER	MODEL	QTY	TYPE	- VOLTS	VA	MOUNTING	
A	METALUX	4VT2-LD5-8-DR-UNV-L840-CD 1-WL-U	1	LED, 58W	120	58	AN	
E.X.	EATON CROUSE-HINDS	EVLEDBX2C701	1	LED, 43W	120	43	W	
EA	READY-LITE	NMMP-2-LD7	2	LED, 4W	12	8	W	1
W.P.	GARDCO	101L-16L-200-WW-G2-3-120 DD-BK		LED, 12W	120	12	AN	
MOUNTIN	NG LEGEND:	CH CHAIN HUNG CS CEILING SURFACE P PENDANT		R W TRC AN		OD AND CHA	NNEL	

EMERGENCY LIGHTING BATTERY SCHEDULE												
			INF	PUT		INTE	RNAL LAMPS	REM	IOTE FIXTURES			
ID	MANUFACTURER	MODEL	VOLTS	VA	OUTPUT VOLTS	QTY	TYPE	QTY	TOTAL REMOTE LOAD (W)	TOTAL LC (W)	AD DESIGN TIME	NOTE
ELB-F75	READY-LITE	LDX12-108NM2LD7	120	30	12	2	LED, 4W	3	24	32	>60 MIN.	1
NOTES: 1.	BATTERY RATED FOR	30 MIN. @ 108W.	-					(In				
118F-E0006	ELECTRICAL P	PLAN LAYOUT MAIN FLOOR	AND EXTERI	IOR								
118F-E0005	ELECTRICAL S	SINGLE LINE DIAGRAM										

REFERENCE DRAWINGS

- 69 /03/27 \proj\$\ AST

DRAWING NUMBER

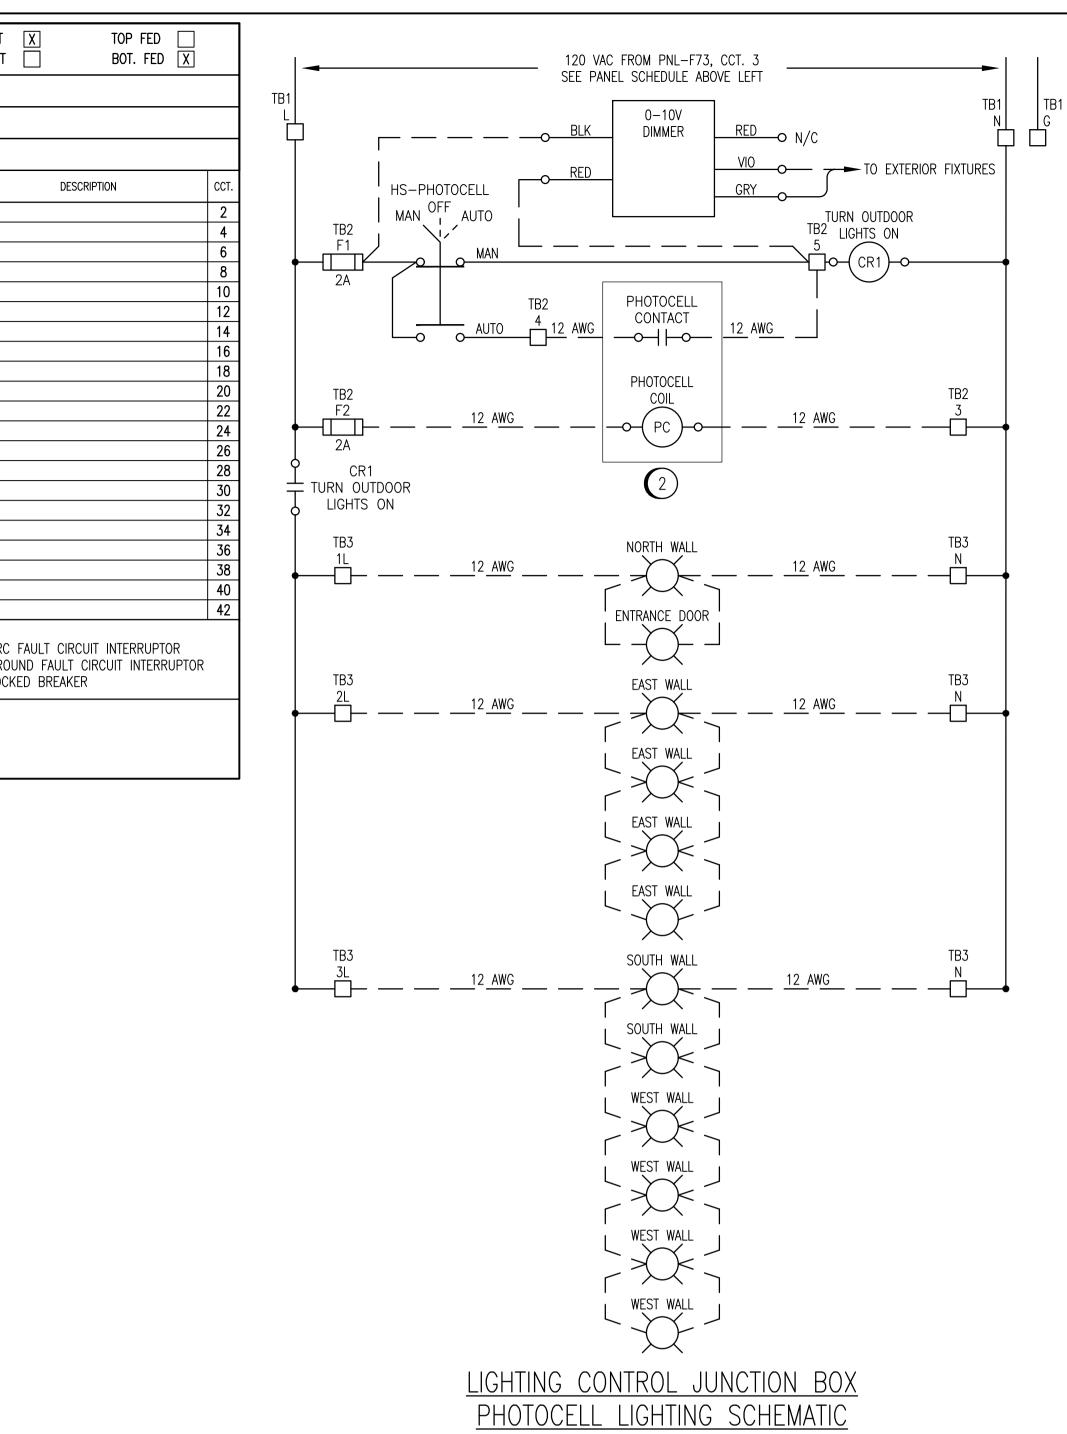



ITEM

1

2

3

5

6

8

9

10

11

12

13

14

15

7

4




SNC-Lavalin Inc. No. 4489

				_		•))	SNC-L 148 Natu
						SNC · LAVALIN	Winnipeg, 204–786
						DESIGNED BY: N. ESCHUK	CHECKE
						drawn by: B. WILKS	APPROV
						scale: N.T.S.	ISSUED BY:
ľ	01	ISSUED FOR ADDENDUM 01	2023/03/23	MS	BC	^{DATE:} 2022/06/29	DATE:
	00	ISSUED FOR CONSTRUCTION, TENDER 167-2023	2023/03/02	MS	BC	CONSULTANT NO.:	
	NO.	REVISIONS	DATE	DESIGN	CHECK		

<u>GENERAL NOTES:</u>

- 1. ALL EQUIPMENT AND CABLING IS NEW UNLESS OTHERWISE INDICATED AS EXISTING.
- 2. PROVIDE A TYPE WRITTEN PANEL DIRECTORY.

SPECIFIC NOTES:

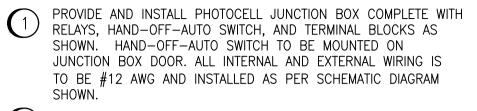

² PROVIDE AND INSTALL NEW OUTDOOR PHOTOCELL. RUN 4C #12 AWG RW90 IN 21mm CONDUIT TO CONNECT PHOTOCELL TO PHOTOCELL JUNCTION BOX.

LIGHTING CONTROL JUNCTION BOX MATERIAL LIST

	LIG	HTING CONTRO	L JUNCTIO	N BOX
		MATERIA	L LIST	
ΈM	QTY	DESCRIPTION	MANUFACTURER	CATALOG NUMBER
1	1	SINGLE–DOOR TYPE 4 WALL–MOUNTED ENCLOSURE C/W BACKPAN	HOFFMAN	A1212CHNF, A12P12
2	1	3-POSITION SELECTOR SWITCH	SCHNEIDER	9001KS43B, 9001KA1
3	1	35mm DIN RAIL	PHOENIX CONTACT	0801733
4	AS REQ'D	FEED-THROUGH TERMINAL	PHOENIX CONTACT	3046184
5	AS REQ'D	FUSED TERMINAL	PHOENIX CONTACT	3046142
6	AS REQ'D	FUSE CONNECTOR	PHOENIX CONTACT	3036806
7	AS REQ'D	POTENTIAL EARTH TERMINAL	PHOENIX CONTACT	3046207
8	AS REQ'D	TERMINAL END PLATE	PHOENIX CONTACT	3047141
9	AS REQ'D	TERMINAL END CLAMP	PHOENIX CONTACT	1201442
10	AS REQ'D	PLUG-IN BRIDGE	PHOENIX CONTACT	3030365
11	AS REQ'D	TERMINAL BLOCK MARKER	PHOENIX CONTACT	1004348
12	AS REQ'D	RELAY, 120 VAC, SPDT, LED	OMRON	G2R-1-SN-AC120(S)
13	1	RELAY BASE, SPDT	OMRON	P2RF-05
14	1	0–10V DIMMER (MOUNTED EXTERNALLY)	LEVITON	IP710
15	1	LAMACOID, WHITE PLATE WITH BLACK TEXT	-	-

	PHOTOCELL MA	ATERIAL LI	ST
QTY	DESCRIPTION	MANUFACTURER	CATALOG NUMBER
1	OUTDOOR PHOTOCELL	PRECISION	ST-15 SERIES

-LAVALIN INC. Nature Park Way Deg, MB, Canada R3P 0X7 786-8080	ENGINEER'S SEAL	Winnipeg THE CITY (WATER AND W						
CKED BY: B. CLEVEN		BANNATYNE FLOOD PUMPING STATION						
ROVED BY: B. CLEVEN		2023 UPGRADES ELECTRICAL SCHEDULES PANEL PNL-F73, LUMINAIRE AND EMERGENCY LIGHTING						
ED FOR CONSTRUCTION K. ZUREK								
: 2023/03/02		CITY DRAWING NUMBER	SHEET	REV.	SIZE			
		1-0118F-E0012	001	01	A1			