UNIT HEATER SCHEDULE									
TAG	SERVICE	HEATING CAPACITY	FLOW RATE	VOLTS/Ø	TYPE				
UH-F65	MAIN FLOOR	10 kW	330 L/s (700 CFM)	575/3	STELPRO ASHU 1063				
UH-F66	DRY WELL	10 kW	330 L/s (700 CFM)	575/3	STELPRO ASHU 1063				
NOTES: 1) UNIT HEAT	NOTES: 1) UNIT HEATERS SUPPLIED WITH THERMOSTAT, SETPOINT 15°C ADJUSTABLE.								

# DUCT HEATING SCHEDULE

TAG	SERVICE	HEATING CAPACITY	FLOW RATE	VOLTS/Ø	CONTROL	TYPE
HCE-F63	SUPPLY DUCT	39 kW	560 L/s (1185 CFM)	575/3	0-10V	PRICE DF CFOOV 610x230
NOTEO						

NOTES: 1) SUPPLY AIR TEMPERATURE SENSOR AT BOTTOM OF DUCT.

2) SETPOINT 15°C ADJUSTABLE. 3) INTEGRAL WITH AIR PROVING SWITCH

## DAMPER SCHEDULE

DAWIELK SCHEDULL									
TAG	SERVICE	AIRFLOW	SIZE	FAIL POSITION	VOLTAGE	CONTROL SIGNAL	TYPE		
FV-F601	OUTDOOR AIR	560 L/s (1185 CFM)	813x610 mm (32x24 in)	OPEN	24VAC	0-10V	TAMCO 9000 THERMALLY INSULATED DAMPER		
FV-F602	RETURN AIR	560 L/S (1185 CFM)	813x610 mm (32x24 in)	CLOSED	24VAC	0-10V	TAMCO 1000 AIR—FOIL CONTROL DAMPER		
FV-F603	EXHAUST AIR	560 L/S (1185 CFM)	1625x510 mm (64x20 in)	OPEN	24VAC	0-10V	TAMCO 9000 THERMALLY INSULATED DAMPER		
NOTES:									

1) DAMPERS CONTROLLED WITH BELIMO NFBUP-S ELECTRIC ACTUATORS, 24VAC, 0-10V, 90 IN-LB.

2)DAMPER POSITION CONTROLLED BY OCCUPANCY SWITCH. UNOCCUPIED: OA & EA DAMPERS 25% OPEN, RA DAMPER OCCUPIED: OA & EA DAMPERS 100% OPEN, RA DAMPER 0% OPEN.

## DIFFUSER SCHEDULE

	DITTOOER GOTTEDOEL									
TAG	SERVICE	AIRFLOW	SIZE	TYPE						
GRD-F641	MAIN FLOOR	1100 L/s (2330 CFM)	864x356 mm (34x14 in)	PRICE 34X14 520D/F/S/A/B12						
GRD-F642	MAIN FLOOR	1100 L/s (2330 CFM)	864x356 mm (34x14 in)	PRICE 34X14 520D/F/S/A/B12						
NOTES:										

1) ADJUST BLADES TO DISTRIBUTE AIR TOWARDS MOTORS

### COOLING EQUIPMENT SCHEDULE COOLING CAPACITY FLOW RATE TAG VOLTS/Ø SERVICE TYPE AC-F64 MAIN FLOOR 44 KW (12.5 TON) 2195 L/s (4650 CFM) 575/3 BARD W150APQ0ZEPXX3X W/LC60 NOTES: 1) COOLING SETPOINT 20°C, ADJUSTABLE 2) C/W RG-10W RETURN GRILLE


SUPPLY FAN SCHEDULE								
TAG	TAG SERVICE FLOW RATE VOLTS/Ø TYPE							
SF-F62	DRY WELL 560 L/s (1185 CFM) 575/3 GREENHECK SQ-130							
NOTES: 1) C/W WITH MATCHING AAF SUREPLEAT SIDE ACCESS FILTER HOUSING AND PERFECTPLEAT 100mm (4") HC M8 FILTERS								


e.		
M:\691232\4ENG\45MEC\DD		
1: \6	1-0118F-M0002	MECHANICAL PLAN LAYOUT, MAIN FLOOR AND EXTERIOR, NEW WORK
≥ ≓	1-0118F-P0001	PROCESS AND INSTRUMENTATION DIAGRAM HVAC SYSTEM
PAIH:	DRAWING NUMBER	REFERENCE DRAWINGS

							<u>GENERAL</u>	<u>_ NOTES</u>
FIRE EX	XTINGUISH	ER SCHEDULE		CONSTRUCTION NOTES:			1. COORDINATE THAT REQU	E WITH DIVISIO IRES NEW ELE
TAG	RATING/		NOTES	INSTALL NEW WATER METER (SUPP MAIN SHUTOFF VALVE.			2. ALL EQUIPM	IENT, DEVICES
FEX-F61	2A, 5BC, 4.5	KG (10 LB) DRY CHEMIC	CAL NEW	SUPPLY AND INSTALL NEW BACKFL RELIEF VALVE AIR GAP DRAIN TO S				
L				SUPPLY AND INSTALL NEW PUMP VALVES, SOLENOID VALVE, HAND V FLOW SWITCH.	ALVE FOR FLOW CO	DNTROL,	$\sim$	
SUMP	PUMP SC	HEDULE		4 SUPPLY AND INSTALL NEW HOSE E				$\backslash$
TAG	SERVICE	POWER VOLTS/Ø	TYPE	5 EXISTING SHUTOFF TO REMAIN IN STEM TO REMAIN. SUPPLY AND INSTALL NEW SUMP			SHUTOFF VALVE	WATER METER
P-F05	SUMP PIT	1 HP 120/1	SUBMERSIBLE, MIN. 250 L/MIN. @ 8M HEAD	6 SUPPLY AND INSTALL NEW SUMP AND CHECK VALVES, CONNECT TO WET WELL.	EXISTING DISCHAR	GE TO		<b>—</b> (M)—
		ES BEFORE DISCHARGE T						
2) MOTOR T	O INCLUDE AUTO	DMATIC THERMAL AND OVE	ERLOAD PROTECTION.			MAIN FLOOR		
								← HOSE BI
					EXTERIOR	DRY WELL		
			NEW FAN, DUC					- 4
			AND LOUVRE (I	REF.)		5		
TYP	E							<b>→</b>
TAMCO 9000 INSULATED DA	MPER							
TAMCO 1000 CONTROL DAM TAMCO 9000	IPER	M						
INSULATED DA		AN LINTER						
ER 75% OPEN	۱.	WATTE						
		WEST WA	ALL ENTRANCE					<b>→</b>
		WEST	THROUGH FLOOR NORTH	Μ.				
				WALL				
2								
2			EXIST. EXIST. WATER SERVIC	E /EACH ASSEMBLY TO BE				
			THROUGH WALL	MOUNTED ON EAST WALL NEXT TO CORRESPONDING PUMP.				<b>→</b>
			REFER					
				10 SCHELASS	EXISTING DISCHARGE			
			P	TO START	TO WET WELL		5	
5000			FO3 MC REFER	ASSEL R			-	
			HOSE PUL	TO SCART ASC			- L	<b>→</b>
			SIBB REFER	TO START		$  \bigcirc \downarrow \downarrow$	<u>-</u>	
		/		SCHEMATIC ASSEMBLY			2	
			SUMP T.					
						)   \   P	РІТ F05	
			PIPING ISOMETRIC SCALE: N.T.S.					

					SNC+LAVALIN	SNC-LAVALIN INC. 148 Nature Park Way Winnipeg, MB, Canada R3P 0X7 204-786-8080	ENGINEER'S SEAL	Winnipeg THE CITY OF WINNIPEG WATER AND WASTE DEPARTMENT
					designed by: N. LEE	CHECKED BY: S. NORSWORTHY		BANNATYNE FLOOD PUMPING STATION
					DRAWN BY: D. CALVERLEY	APPROVED BY: B. CLEVEN		2023 UPGRADES MECHANICAL SCHEDULES
<b>MANITOBA</b> Certificate of Authorization					SCALE: AS NOTED	ISSUED FOR CONSTRUCTION BY: K. ZUREK		NEW WORK
SNC-Lavalin Inc.	01	ISSUED FOR ADDENDUM 01	2023-03-27 NL	BC	DATE: 2022/08/17	DATE: 2023/02/17		CITY DRAWING NUMBER SHEET REV. SIZ
No. 4489	00	ISSUED FOR CONSTRUCTION, TENDER 167-2023	2023-03-02 NL	BC	CONSULTANT NO.:	1	1	
	NO.	REVISIONS	DATE DESIG	N CHEC	κ			1-0118F-M0003 001 01 A
								1-0118F-M0003.dwg

# <u>ES</u> SION 26 WHERE EQUIPMENT ELECTRICAL IS INSTALLED. CES AND CABLING ARE NEW.

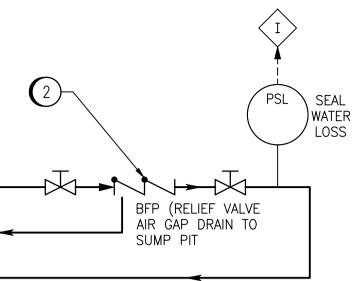

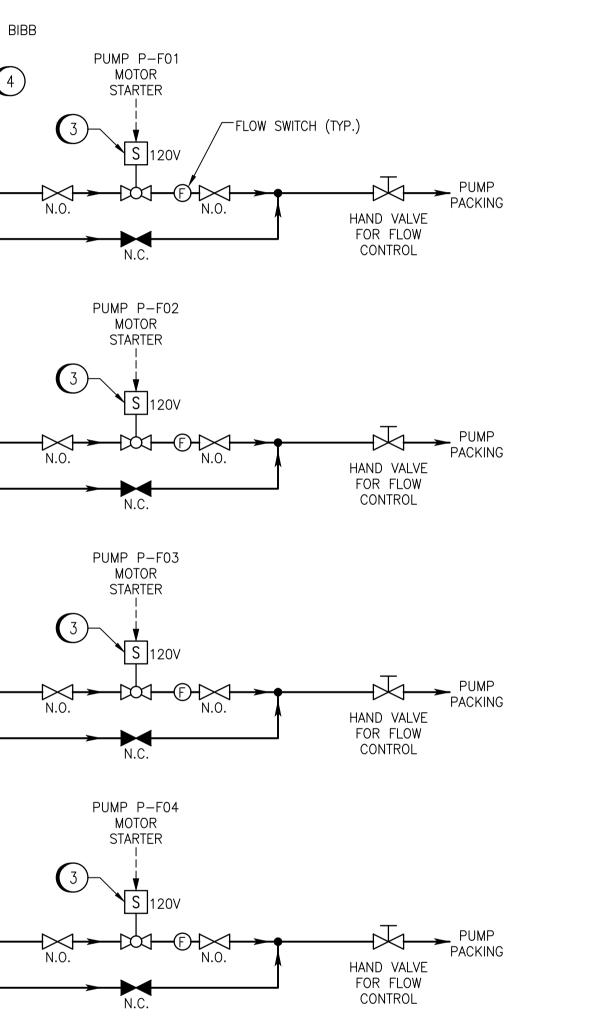

PIPING SCHEMATIC SCALE: N.T.S.