
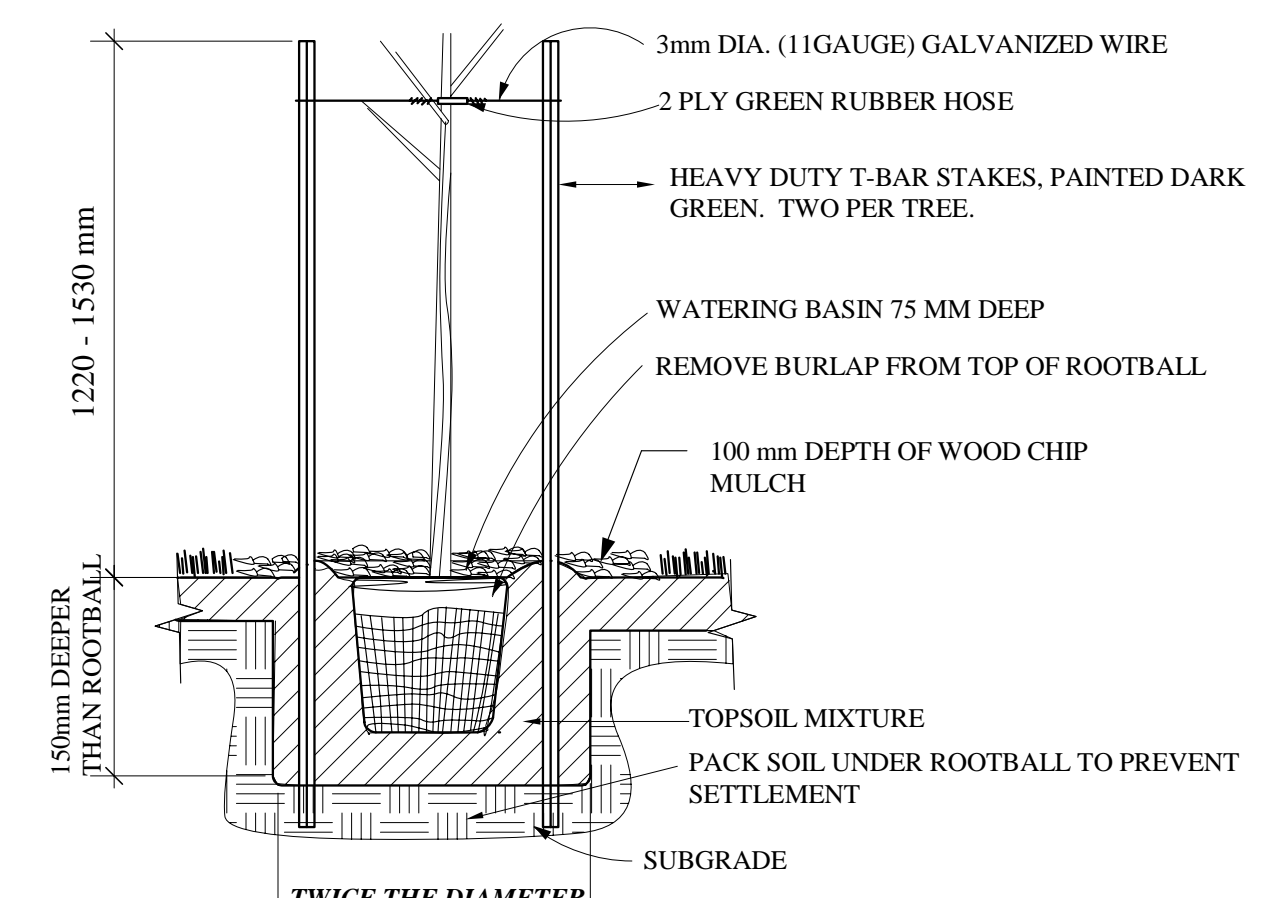


- NEW TREE PLANTING LEGEND:**
- AMERICAN BASSWOOD
 - AMUR MAPLE
 - BLACK WALNUT
 - BUTTERNUT
 - COTTONWOOD
 - GOLDEN WILLOW
 - JAPANESE TREE LILAC
 - LARUEL LEAF WILLOW
 - MANCHURIAN ASH
 - MOUNTAIN ASH
 - NORTHERN WEEPING WILLOW
 - NORTHWEST POPLAR
 - PATMORE ASH
 - EXISTING SPRUCE TREE
 - EXISTING DECIDUOUS TREE

1 LANDSCAPE PLAN
L1 Scale: 1:1000

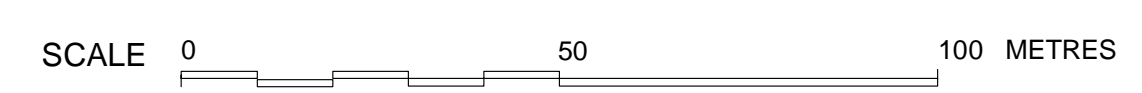

1 TREE PIT / PLANTING DETAIL
L1


QUANTITY	COMMON NAME / BOTANICAL NAME	SIZE/REMARKS
Trees		
55	Colorado Spruce/ <i>Picea pungens</i>	ALL TREES TO BE SPECIMEN QUALITY 40 @ 1220 mm ht. and 15 @ 1830 mm ht. 50% blue, 50% green. Install 1830 mm ht trees in equal proportion in middle of groupings or at backgrounds. Min. rootball size: 1220 ht/ 610mm dia., 1830 ht/ 750 dia. Single stake 1220 ht. Double stake 1830 ht.
47	Black Hills Spruce/ <i>Picea glauca densata</i>	35 @ 1220 mm ht. and 12 @ 1830 mm ht. Specification as per Colorado Spruce.
24	Scots Pine/ <i>Pinus sylvestris</i>	Min. 1220 mm ht. Specification as above.
44	Siberian Larch/ <i>Larix Siberica</i>	Min. 1220 mm ht. Specification as above.
41	American Basswood/ <i>Tilia americana</i>	Min. 50 mm cal. 2440 mm ht. All single stem (or contractor may supply all clump forms). Well branched head above 1220 mm ht. Min. 750 mm dia. rootball. Two stakes.
35	Manchurian Ash/ <i>Fraxinus mandshurica</i>	As above
2	Patmore Ash/ <i>Fraxinus Pennsylvanica subintegerrima "Patmore"</i>	As above
10	Northwest Poplar/ <i>Populus X jacksi "Northwest"</i>	As above
10	Plains Cottonwood/ <i>Populus deltoides occidentalis</i>	As above
8	Black Walnut/ <i>Juglans nigra</i>	As above
7	Butternut/ <i>Juglans cinerea</i>	As above
7	Golden Willow/ <i>Salix alba "Vitellina"</i>	Min. 4 stems, each stem to be min. 1220 mm ht. Container or b&b. Min. 400 mm dia. rootball. No staking required.
22	Laurel Leaf Willow/ <i>Salix petandra</i>	As above
8	Northern Fountain Weeping Willow/ <i>Salix "Northern Fountain"</i>	As above
5	American Mountain Ash/ <i>Sorbus americana</i>	As per American Basswood, 50 mm cal. and 1830 mm ht.
8	Japanese Tree Lilac/ <i>Syringa reticulata mandshurica</i>	Clumps. Min. 3 stems, each stem to be min. 1830 mm ht. Min. 500 mm dia. rootball. No staking required.
24	Amur Maple/ <i>Acer ginnala</i>	As above.
Seedlings		
60	Bur Oak/ <i>Quercus macrocarpa</i>	Seedlings. Min. 300 mm height. Install in planting pits min. 400 mm dia. and 300 mm depth. Leave top of topsoil mixture 50mm below surrounding grade to act as watering saucer. Install bamboo stake by each plant, min. 12mm dia. and 600 mm above grade.
18	Common Hackberry/ <i>Celtis occidentalis</i>	As above
Shrubs		
9	Littleleaf Lilac/ <i>Syringa Palibiana</i>	Min. 10 stems, each stem to be min. 500 mm ht. Container.
20	Dwarf Burningbush/ <i>Euonymus nanus "Turkestanicus"</i>	Min. 6 stems, each stem to be min. 500 mm ht. Container.

- GENERAL NOTES:**
- LOCATE AND PROTECT ALL UNDERGROUND UTILITIES PRIOR TO COMMENCING CONSTRUCTION.
 - REPAIR ALL SOD DAMAGE AS A RESULT OF CONSTRUCTION, TO PRIOR CONSTRUCTION CONDITIONS.
 - REMOVE ALL EXCAVATED TREE PIT MATERIAL AWAY FROM THE SITE.
 - THE CITY RESERVES THE RIGHT NOT TO AWARD ALL THE CONSTRUCTION COMPONENTS. SEE QUOTATION DOCUMENTS FOR FURTHER INFORMATION.
 - IN AREAS SHOWN TO BE NATURALIZED, THE EXISTING GRASS WILL BE ALLOWED TO GROW TALL. DURING THE TWO YEAR MAINTENANCE PERIOD, THE CONTRACTOR SHALL NOT DRIVE ON THESE AREAS, WHILE PERFORMING THE WATERING COMPONENT, OF THE TWO YEAR MAINTENANCE PROGRAM.
 - STAKE THE LOCATION OF ALL TREE PLANTINGS PRIOR TO EXCAVATING THE TREE PITS, AND HAVE CONTRACT ADMINISTRATOR APPROVE THE LOCATIONS.
 - SEE DRAWINGS L-2 AND L-3 FOR HARD LANDSCAPING REQUIREMENTS.

NO.	REVISIONS	BY	DATE

PROJECT TITLE
DR. MORLEY R. KARE PARK

DRAWING TITLE
SITE PLAN & LANDSCAPE IMPROVEMENTS

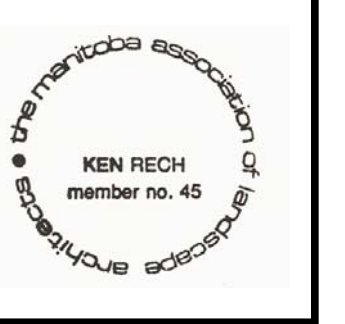

KEN RECH LANDSCAPE ARCHITECTS INC.
1480 Wellington Crescent Winnipeg Manitoba
Fax 489-6852 R3N 0B3 Tel(204) 489-6616

DRAWN BY	SCALE	SHEET NO.
K. RECH	1:1000	L-1
CHECKED	DATE	REVISION
	JAN. 30, 2004	
FILE NO.		
03-14A		

RELEASED FOR CONSTRUCTION
MANAGER PARKS & OPEN SPACE DIVISION