


NOTE: CHAINAGES SHOWN ARE ALONG N. R. OF RUE LA VERENDRYE.

- CONSTRUCTION NOTES:
- RESTORE ALL DISTURBED GRASS AREAS & BERM WITH IMPORTED TOP SOIL & SOD IN ACCORDANCE WITH CW 3510.
 - DO NOT REMOVE EXISTING TREES. PROVIDE TREE PROTECTION IN ACCORDANCE WITH SPECIFICATIONS.
 - LEAVE SLUICE GATE IN OPEN POSITION AT ALL TIMES EXCEPT WHEN ON-SITE WORKING ON GATE.
 - PROVIDE TEMPORARY PUMPING OF FLOW IN LAND DRAINAGE SEWER AS REQUIRED DURING CONSTRUCTION.
 - PREVENT EXCAVATED MATERIAL, BACKFILL MATERIAL AND SOIL/WATER SLURRY FROM ENTERING LDS OUTFALL TO THE RIVER.

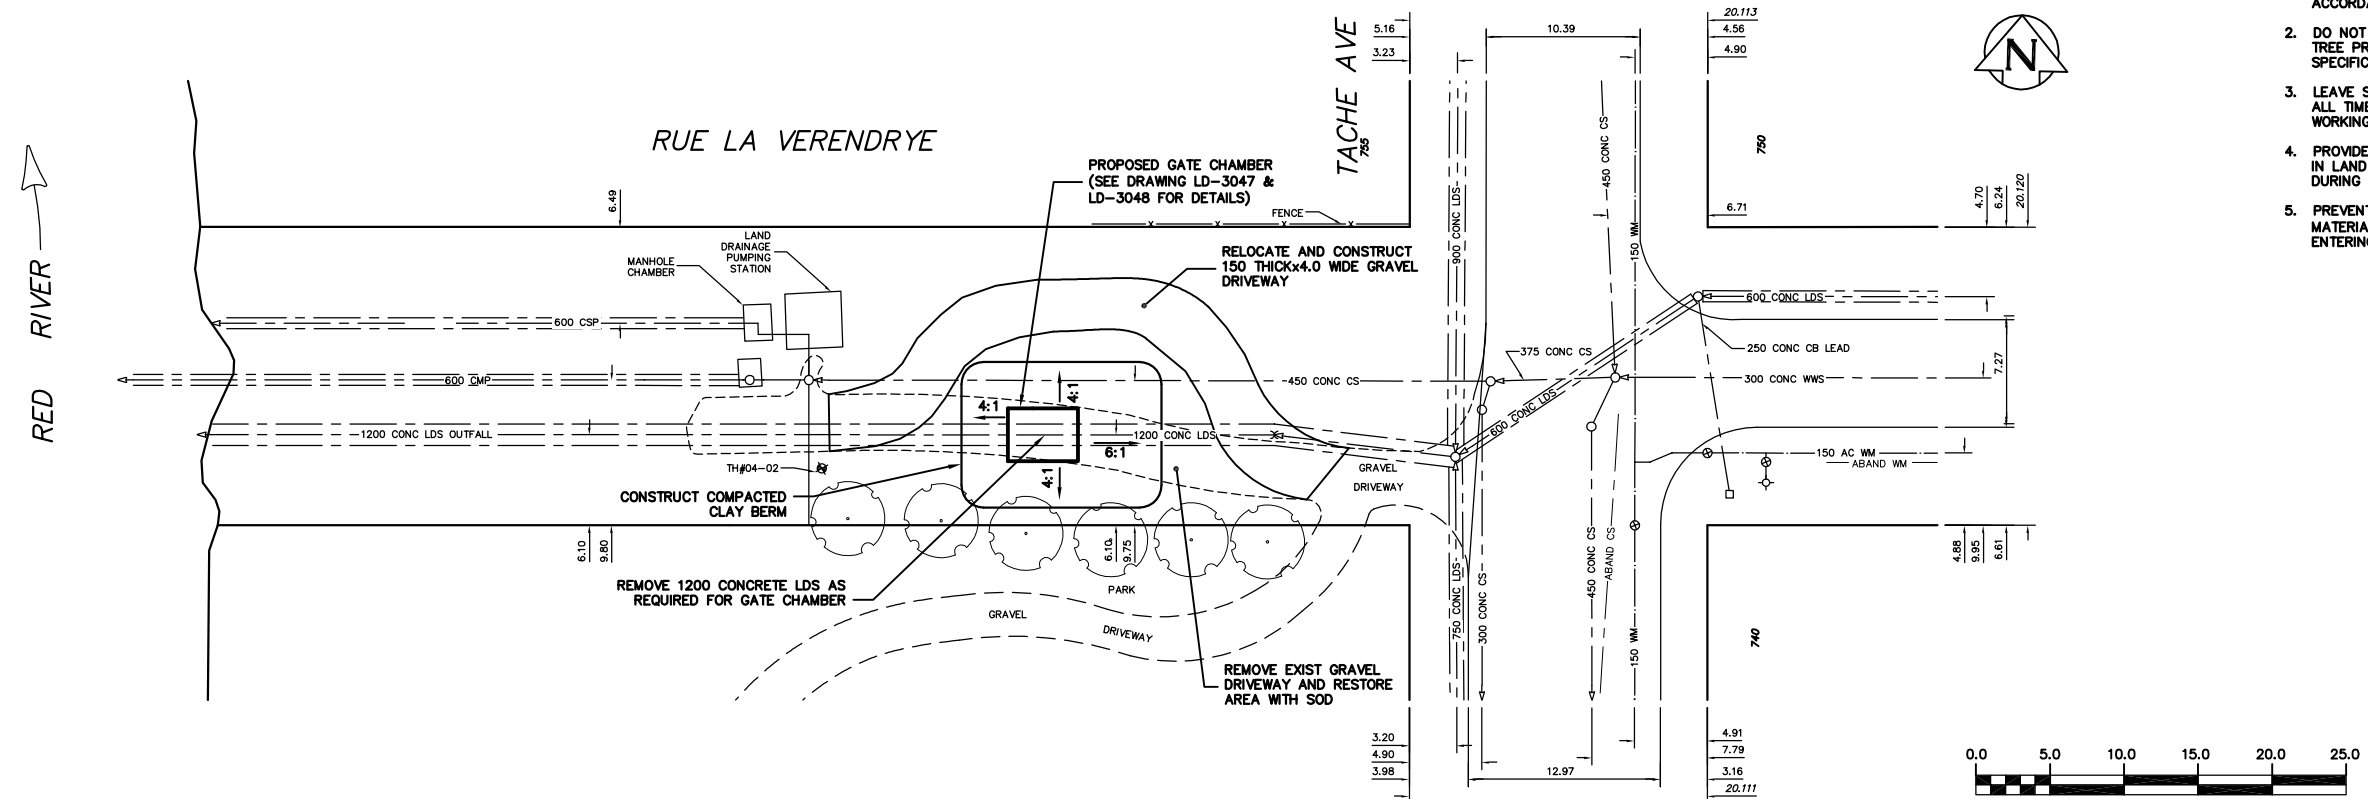

METRIC
WHOLE NUMBERS INDICATE MILLIMETRES
DECIMALIZED NUMBERS INDICATE METRES

WARNING
IF POWER EQUIPMENT OR EXPLOSIVES ARE TO BE USED FOR EXCAVATION ON THIS PROJECT THE CONTRACTOR MUST:
1) NOTIFY THE GAS COMPANY OF THE PROPOSED LOCATION OF EXCAVATION.
2) TAKE PRECAUTION TO AVOID DAMAGE TO GAS COMPANY INSTALLATIONS.
SEE PROVINCIAL REGULATION 210/72 FOR DETAILS

EXISTING	LEGEND-PLAN	PROPOSED	EXISTING	LEGEND-PLAN	PROPOSED	EXISTING	LEGEND-PROFILE	PROPOSED
200 WM	WATERMAIN	200 WM	SL, HYDRO	150 WM	WATERMAIN	150 WM	WATERMAIN	150 WM
525 LDS	LAND DRAINAGE SEWER	525 LDS	50 GAS	300 LDS	LAND DRAINAGE SEWER	300 LDS	LAND DRAINAGE SEWER	300 LDS
375 WWS	WASTEWATER SEWER	375 WWS	50 GAS	250 WWS	WASTEWATER SEWER	250 WWS	WASTEWATER SEWER	250 WWS
○	MANHOLE	●	***	—X—	PROFILE	—X—	PROFILE	—X—
□	CATCH BASIN	■	* * * * *	—X—	GROUND ABOVE PIPE	—X—	GROUND ABOVE PIPE	—X—
▽	CURB INLET	▽	* * * * *	—X—	G DITCH (SOUTH & EAST)	—X—	G DITCH (SOUTH & EAST)	—X—
— — —	JUNCTIONS	— — —	* * * * *	—X—	GUTTER (NORTH & WEST)	—X—	GUTTER (NORTH & WEST)	—X—
— — —	CULVERT	— — —	* * * * *	—X—				
— — —	ANODE	— — —	* * * * *	—X—				
— — —	LEGEND-PLAN	— — —	* * * * *	—X—				

LOCATION APPROVED	B.M. ELEV.	FIELD BOOK #
UNDERGROUND STRUCTURES	POSTED TO LBS	
SUPV. U/G STRUCTURES COMMITTEE	DATE	
NOTE:		
LOCATION OF UNDERGROUND STRUCTURES AS SHOWN ARE BASED ON THE BEST INFORMATION AVAILABLE BUT NO GUARANTEE IS GIVEN THAT ALL EXISTING UTILITIES ARE SHOWN OR THAT THE GIVEN LOCATIONS ARE EXACT. CONFIRMATION OF EXISTENCE AND EXACT LOCATION OF ALL SERVICES MUST BE OBTAINED FROM THE INDIVIDUAL UTILITIES BEFORE PROCEEDING WITH CONSTRUCTION.		
NO. REVISIONS	DATE	BY

CITY OF WINNIPEG
WATER AND WASTE
ENGINEERING DIVISION

DESIGNED BY: DGS
CHECKED BY: TW
DRAWN BY: SW/CJH
APPROVED BY: KZ
HOR. SCALE: 1:250
VERTICAL SCALE: 1:50
DATE: 2004.09.01

ENGINEER'S SEAL
ORIGINAL SIGNED BY K.R. ZUREK
04/09/03

THE CITY OF WINNIPEG
WATER AND WASTE DEPARTMENT

2004 OUTFALL GATE CHAMBER UPGRADES
RUE LA VERENDRYE
LDS OUTFALL GATE CHAMBER
SITE PLAN

SHEET 1 OF 14
CITY DRAWING NUMBER
LD-3046

BID OPPORTUNITY: 417-2004
FILENAME: LD-3046.dwg
PLOT DATE: 2004.09.03