
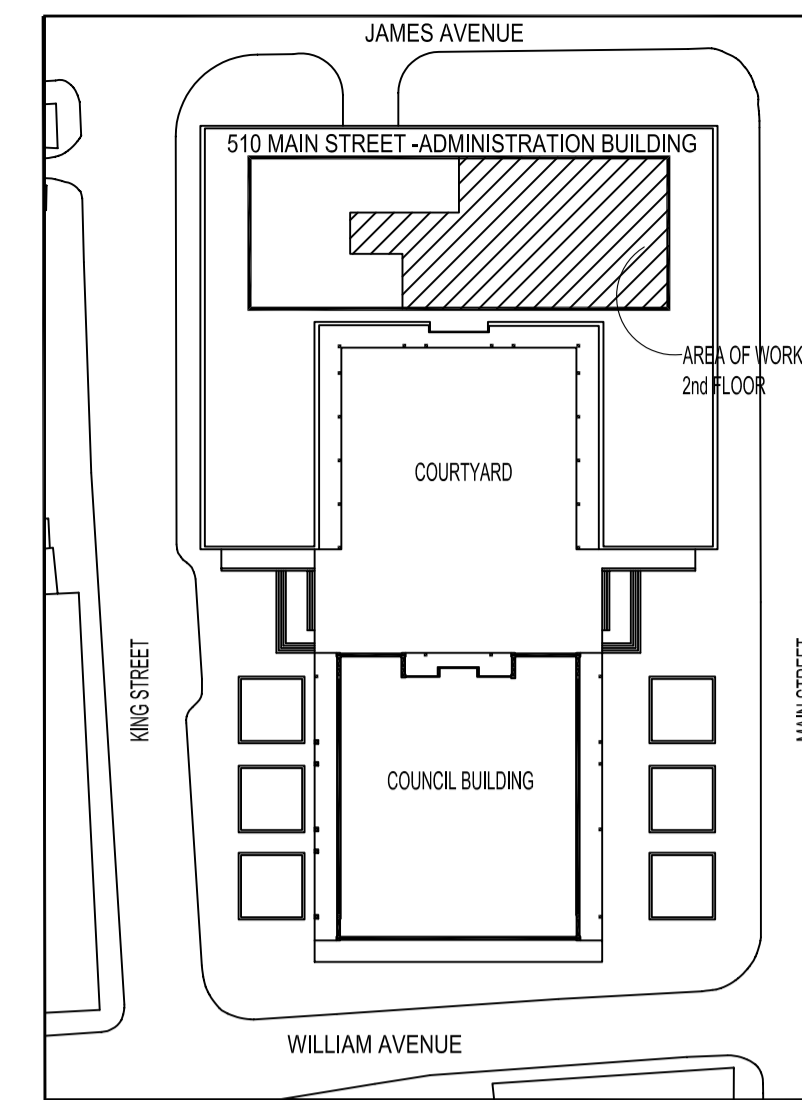


ELECTRICAL, DATA & PHONE SYMBOLS

TO BE REMOVED	
SYMBOL	DESCRIPTION
⊕	WALL LIGHT
E-1	EXIT LIGHT (EXISTING)
E-2	EXIT LIGHT (NEW)
⊕ ₂	DUPLEX RECEPTACLE
⊕ ₂	DUPLEX RECEPTACLE ABOVE COUNTER
⊕	TELEPHONE - WALL (REMOVE)
⊕	TELEPHONE - FLOOR
⊕	REDUNDANT CONDUIT WIRING - FLOOR
⊕	REDUNDANT CONDUIT WIRING - FLOOR
PB	PULL BOX, 24" X 24" X 8" GALV. 16 GA. MIN WITH KNOCKOUTS
⊕	FIRE ALARM BELL
⊕	FIRE ALARM PULL STATION
⊕	DATA
⊕	SINGLE POLE SWITCH
⊕ ³	3 WAY SWITCH
⊕	3 GANG SWITCH
⊕ ^{2PM}	DIMMER SWITCH
△ _F	COMMUNICATIONS - FLOOR
⊕ _{250V}	250V RECEPTACLE
⊕	SPECIAL RECEPTACLE - WALL
⊕ _{SD}	SMOKE DETECTOR

ELECTRICAL DEMOLITION NOTES:

- REFER TO DRAWING E-4 SPECIFICATIONS.
 ----- INDICATES DEMOLITION. INCLUDES ELECTRICAL SYMBOLS.
- REMOVE ALL IN-FLOOR CONDUIT WIRING BACK TO SOURCE. CAP ALL CONDUITS BENEATH FLOOR SURFACE. PATCH WITH CONCRETE AND FINISH FLOOR AS PER ARCHITECTURAL DRAWING.
 - REMOVE ON INDICATED WALL ALL WALL RECEPTACLES, SWITCHES, PANELS, DATA, TELEPHONE, REDUNDANT & ASSOCIATED WIRING BACK TO SOURCE EXCEPT ELEVATOR CONTROLS. PATCH WALLS AND FINISH AS PER ROOM FINISH SCHEDULE.
 - REMOVE INTERCOM BOX & WIRING BACK TO SOURCE. PATCH WALL AND FINISH AS PER ROOM FINISH SCHEDULE.
 - REMOVE MAIN TELEPHONE BOX & WIRING BACK TO SOURCE. PATCH WALL AND FINISH AS PER ROOM FINISH SCHEDULE.
 - REMOVE DATA JACKS AND WIREMOLD ON WALL. REMOVE DATA CABLING BACK TO SOURCE.
 - REMOVE RACEWAY COMPONENTS INCLUDING WIRING BACK TO SOURCE.
 - JOHNSON CONTROL SENSOR TO REMAIN. THERMOSTAT TO BE REMOVED BUT NOT ASSOCIATED PNEUMATIC LINES.

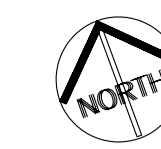


KEY PLAN
 SCALE: N.T.S.

DRAWING LIST - ELECTRICAL

E1	ELECTRICAL, DATA & PHONE DEMOLITION
E2	ELECTRICAL & DATA RENOVATION
E3	ELECTRICAL LIGHTING RENOVATION
E4	ELECTRICAL & DATA SPECIFICATIONS

NOTES :
 THESE DRAWINGS SHALL NOT BE SCALED.
 THE SUB-CONTRACTOR SHALL VISIT THE SITE AND SATISFY ONESELF ALL DIMENSIONS, DATUM, AND DETAILED INFORMATION SHOWN ARE CORRECT.
 THE SUB-CONTRACTOR IS TO REVIEW AND COORDINATE ALL ARCHITECTURAL, MECHANICAL, ELECTRICAL AND STRUCTURAL DRAWINGS FOR ADDITIONAL OPENINGS THROUGH FLOORS, WALLS, AND CEILINGS FOR DUCT, PIPE & ELECTRICAL RISERS AND ALL OPENINGS NOT SHOWN ON DRAWINGS.
 ALL OPENINGS THROUGH FIRE ASSEMBLIES ARE TO BE FIRE STOPPED AND SEALED WITH U.L.C. APPROVED FIRE STOPPING TO MAINTAIN THE INTEGRITY OF THE FIRE SEPARATION, AND PROVIDE A SMOKE-TIGHT BARRIER.
 ALL PRODUCTS AND MATERIALS TO BE USED AND INSTALLED SHALL CONFORM WITH MANUFACTURER'S SPECIFICATIONS & APPLICABLE CODES.
 THE SUB-CONTRACTOR SHALL BE RESPONSIBLE TO PATCH AND MAKE GOOD ALL EXISTING CONSTRUCTION AFFECTED BY THE REMOVAL OF ALL ITEMS FORMING THE PART OF THE RENOVATION WORK.
 WHERE NEW FLOORING AND BASE IS TO BE INSTALLED IN EXISTING AREAS (REFER TO FLOOR PLAN AND ROOM SCHEDULE) THE EXISTING FLOORING SURFACE AND BASE MUST BE REMOVED, UNLESS OTHERWISE NOTED. ALL FLOOR SURFACES SHALL BE PREPARED IN ACCORDANCE TO MANUFACTURER'S RECOMMENDATIONS FOR INSTALLATION OF NEW FLOOR.
 WHERE PAINTING OF EXISTING WALLS IS INDICATED ON THE ROOM SCHEDULE, THESE WALLS MUST BE CLEANED OF ANY EXISTING WALL COVERING, PATCHED & PREPARED TO ACCEPT NEW MATERIAL, UNLESS OTHERWISE NOTED.
 ALL NEW LIGHTING FIXTURES & NEW RECEPTACLES TO BE CONNECTED TO APPROPRIATE PANELS, EXCEPT FOR EMERGENCY LIGHT REMOTE HEADS TO BE CONNECTED TO EMERGENCY LIGHT BATTERY PACK(S).
 SUB-CONTRACTOR MAY REUSE EXISTING BREAKERS & WIRING PROVIDED SAME IS IN GOOD CONDITION & MEETS ALL APPLICABLE CODES.
 GENERAL DUTY RECEPTACLES SHALL BE CSA APPROVED. C/W TRIM PLATES MOUNTED AS PER EXISTING HEIGHT, EXCEPT FOR GFCI RECEPTACLES & ABOVE COUNTER. RECEPTACLE & TRIM PLATE COLORS TO BE DETERMINED.
 DIMMERS SHALL BE CSA APPROVED COMMERCIAL SLIDE TYPE TO SUIT CIRCUIT LOAD.
 SUPPLY & INSTALL LAMACOD NAME PLATES ON ALL NEW & EXISTING PANEL BOARDS, SWITCHES & RECEPTACLES. PANEL SCHEDULE SHALL BE TYPED & ADHERED TO INSIDE OF ASSOCIATED PANEL DOOR.
 ALL ABANDONED ELECTRICAL FIXTURES, COMPONENTS & RECEPTACLE WIRINGS SHALL BE REMOVED BACK TO SOURCE.
WARNING: ASBESTOS IS PRESENT IN THE MAIN FLOOR CEILING SPACE, & EAST & WEST AIR SHAFTS.

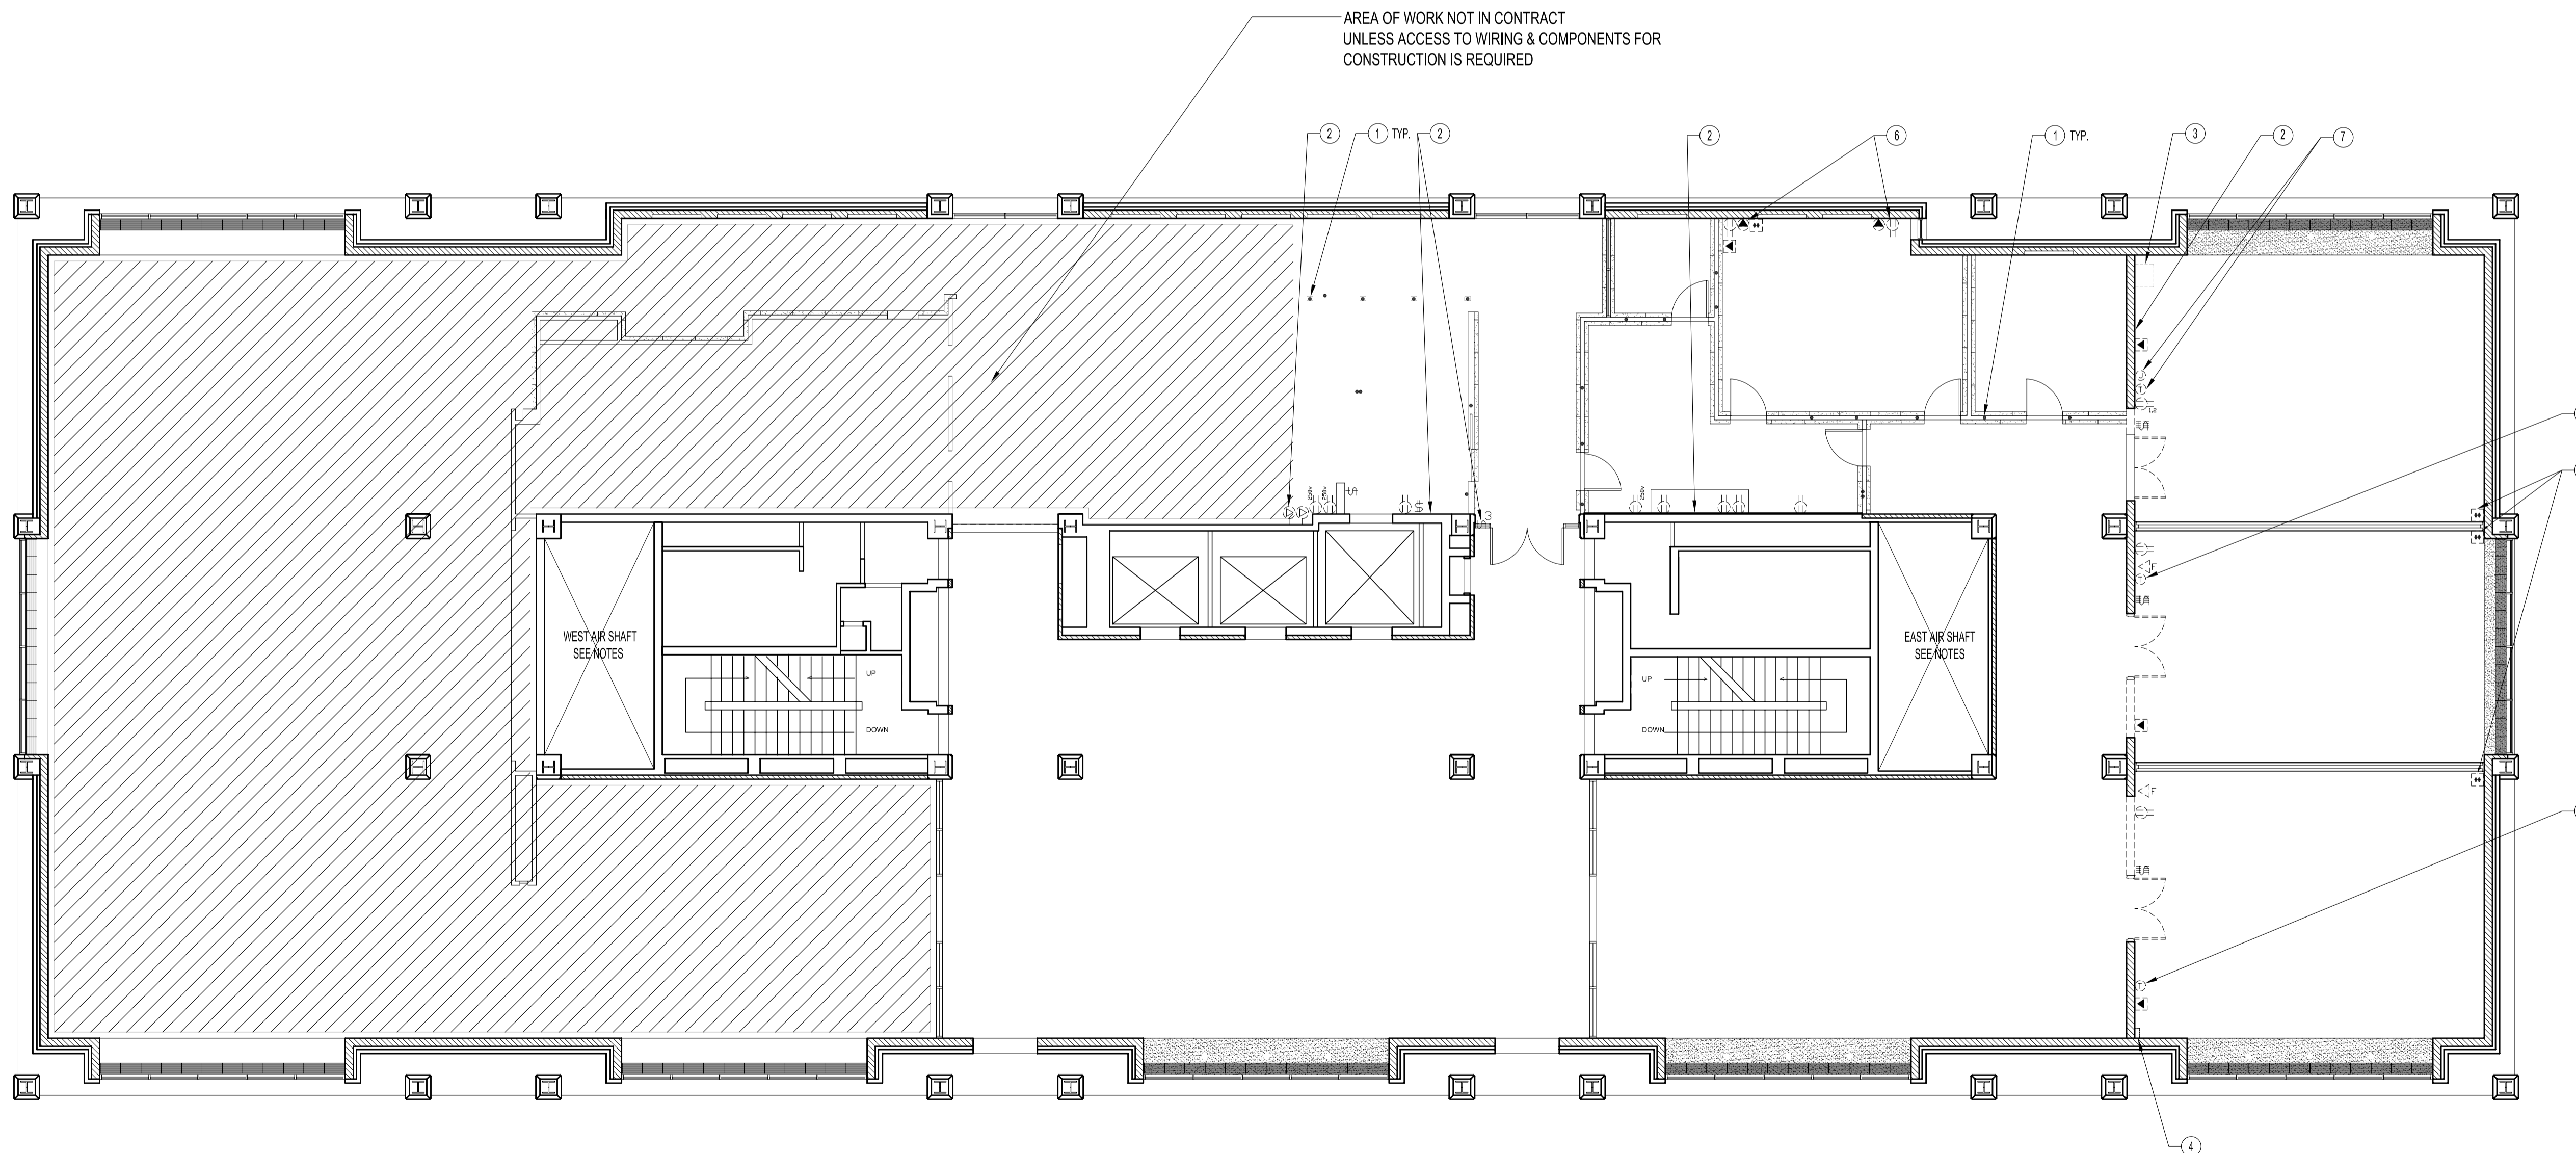

ORIGINAL SEALED BY:
 D.A. Paley P. Eng.
 Date: 2005.05.30

NO.	REVISION/DESCRIPTION	BY	DATE
SEALS			

DRAWN BY	RCP	CHECKED BY	APPROVED
DATE	2005.05.30	USER	APPROVAL

CITY OF WINNIPEG
 PLANNING, PROPERTY & DEVELOPMENT DEPARTMENT
 CIVIC ACCOMMODATIONS DIVISION
 300 - 65 GARRY ST. R3C 4K4

PROJECT
 ADMINISTRATION BUILDING
 2nd FLOOR RENOVATIONS
 CONFERENCE ROOM RENOVATIONS

510 MAIN STREET
SHEET TITLE
 SECOND FLOOR PLAN
 ELECTRICAL, DATA & PHONE
 DEMOLITION

SCALE	PROJECT NO.	SHEET NO.
AS SHOWN	2004-180	E1

SECOND FLOOR PLAN - ELECTRICAL, DATA & PHONE DEMOLITION
 SCALE: 1/8"=1'-0"