
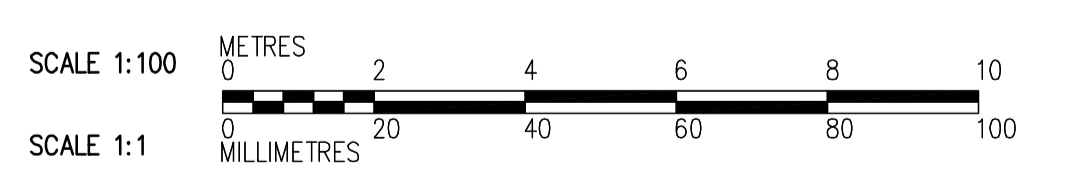


- NOTES:**
- FOR WALL TOC ELEVATIONS AND BOTTOM OF WALL ELEVATIONS SEE DWG. WO-S0205.
 - MONORAILS AND SUPPORT BEAMS TO BE PROVIDED AND INSTALLED IN SEPARATE CONTRACT. EMBEDDED ANCHOR RODS TO BE PROVIDED AND INSTALLED IN THIS CONTRACT.
 - AT ANY VERTICAL CONSTRUCTION JOINTS IN THE TANK PERIMETER WALLS INCLUDING THE WALL BETWEEN THE TWO TANKS ALONG B12, USE 316 STAINLESS STEEL WATERSTOP FOR OZONE TANKS AND PVC WATERSTOP FOR BACKWASH SUPPLY TANKS.

REBARS LEGEND:
 ——— TOP BARS
 - - - - - BOTTOM BARS

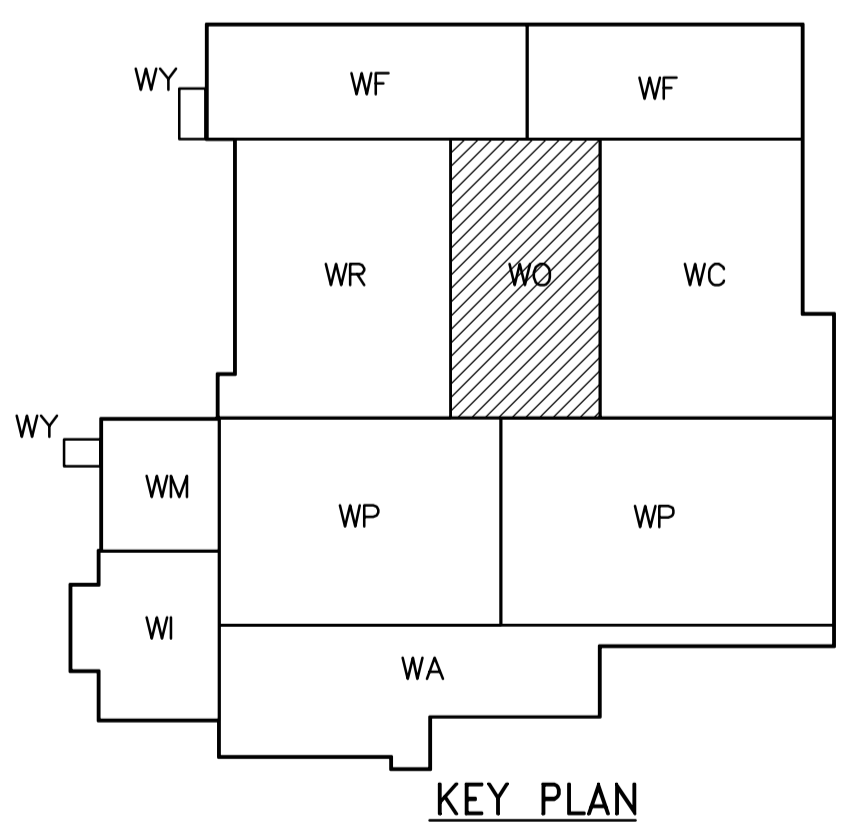

SECOND FLOOR PLAN
1:100

 Certificate of Authorization CH2M HILL Canada Ltd. No. 1441 Expiry: April 30, 2006	B.M. ELEV.	 Frederickson Cooper ARCHITECTS	 A Veolia International Ltd. Company	ENGINEER'S SEAL ORIGINAL SIGNED BY D. KRUGER 2006/02/06	 THE CITY OF WINNIPEG WATER AND WASTE DEPARTMENT ENGINEERING DIVISION WATER TREATMENT PLANT OZONE FOUNDATIONS AND CONCRETE STRUCTURES STRUCTURAL OZONATION AREA SECOND FLOOR PLAN	CITY FILE NUMBER
	00 ISSUED FOR TENDER 2006/02/03 MH NO. REVISIONS DATE BY	DESIGNED BY MH DRAWN BY RL SCALE: 1:100	CHECKED BY AP APPROVED BY DJT RELEASED FOR CONSTRUCTION BY: R. SOROKOWSKI	CONSULTANT DRAWING NO. WO-S0121		SHEET OF CITY DRAWING NUMBER 1-06010-A-30121-001-00D