


ROOF FRAMING PLAN
SCALE : 1:50



MASONRY WALL PLAN
SCALE : 1:50

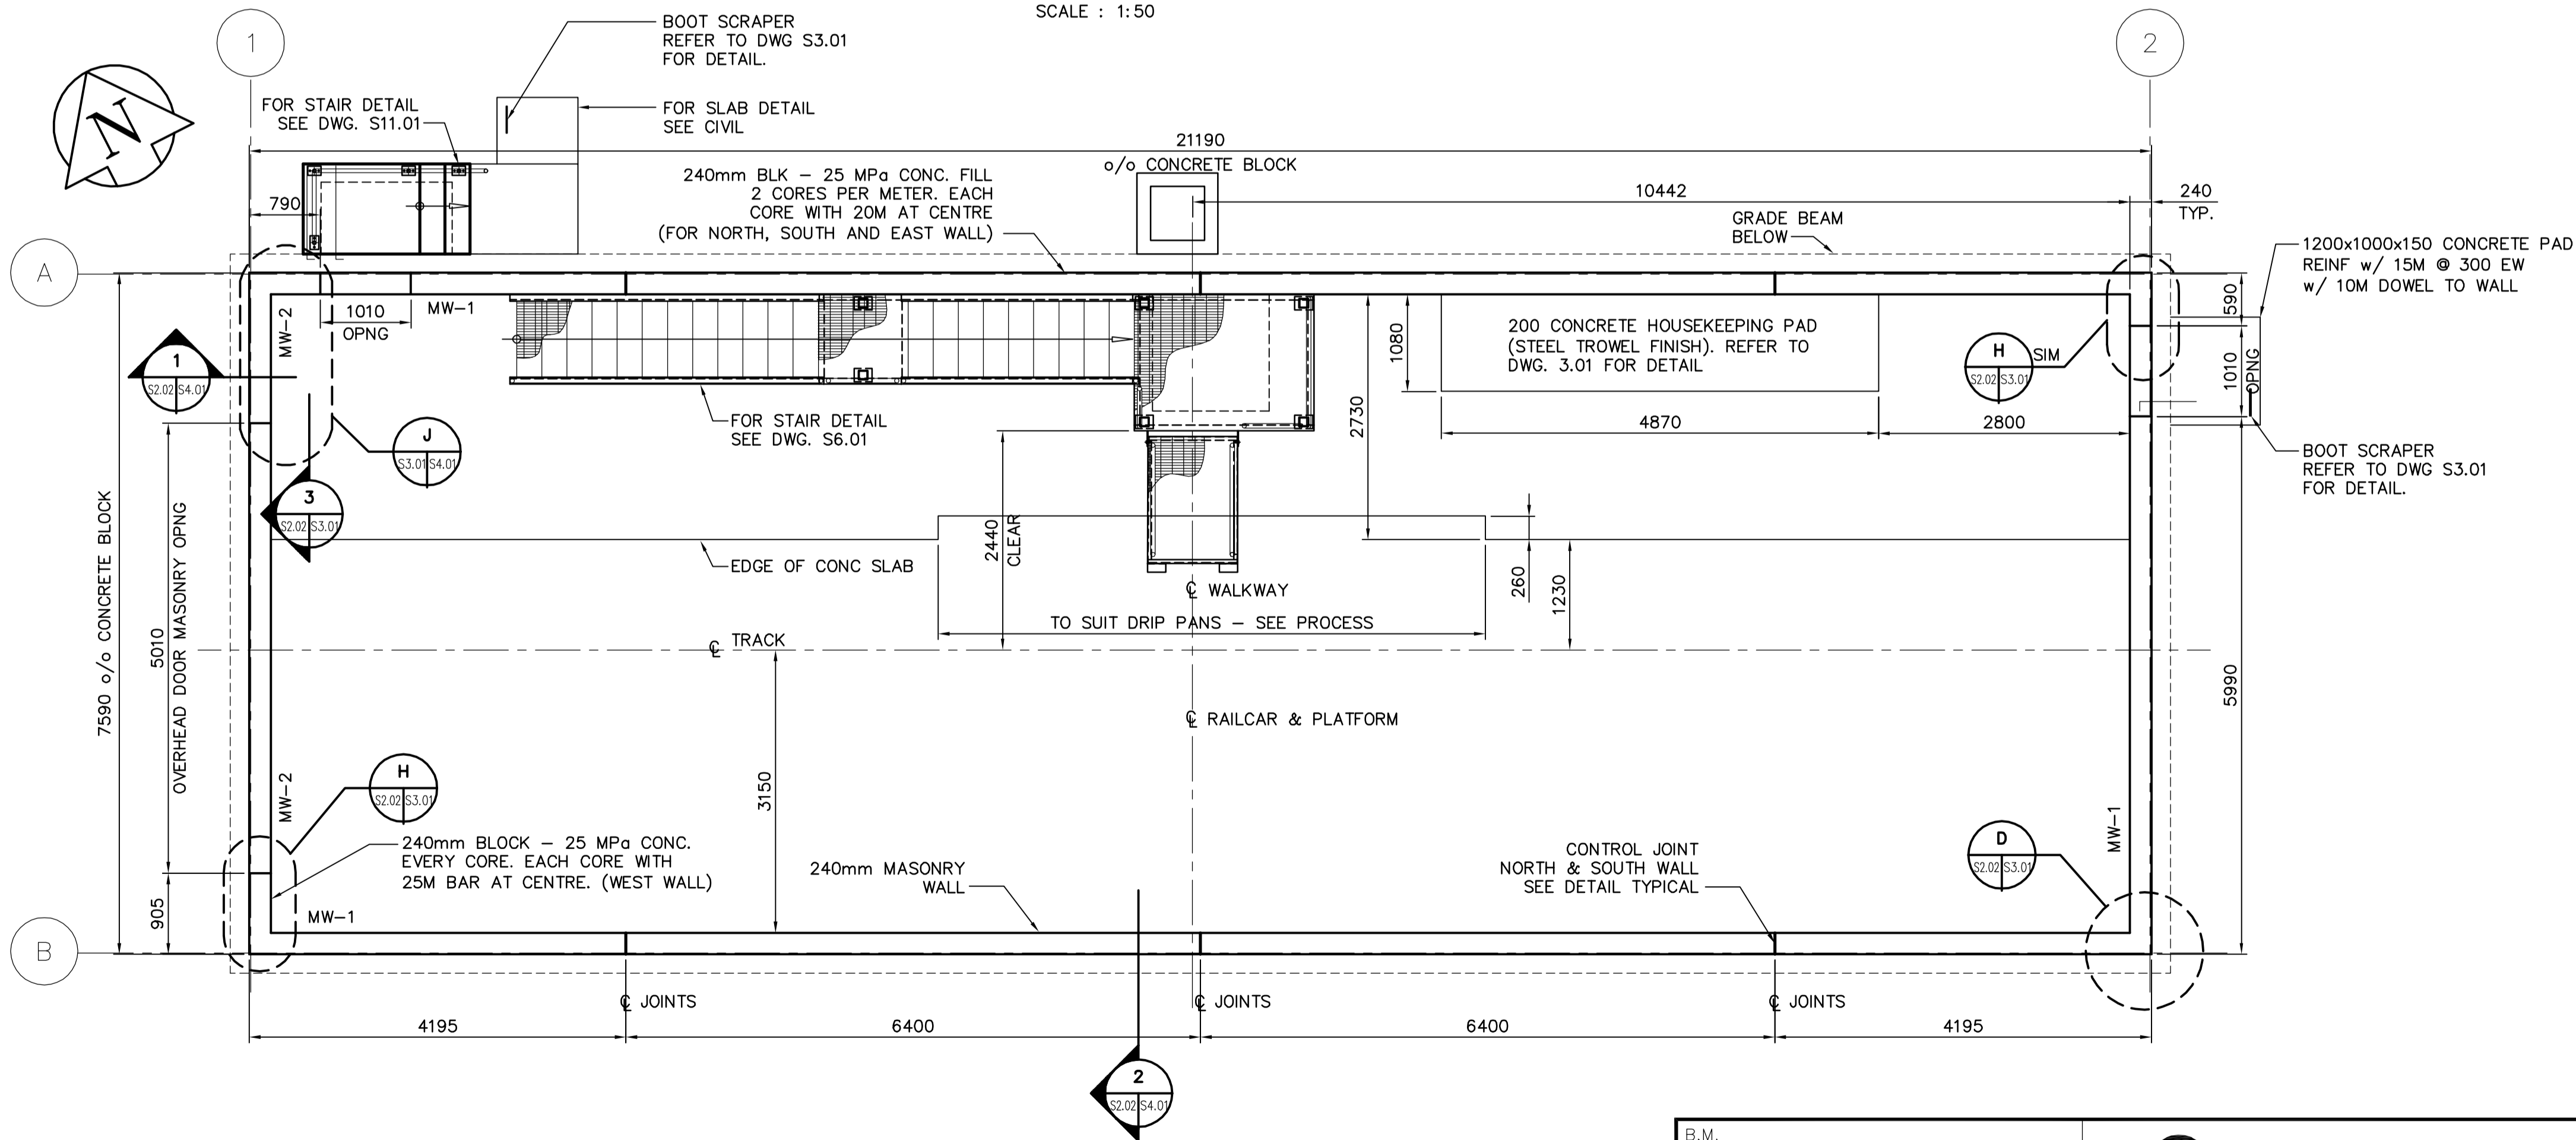

B.M. ELEV.			
DESIGNED BY	AP/GGP	CHECKED BY	MK
DRAWN BY	WDB	APPROVED BY	D. TANIGUCHI
SCALE:	AS NOTED	RELEASED FOR CONSTRUCTION BY:	K. MARTENS
NO. ISSUED FOR TENDER	05/12/2	DATE	2005/09/09
NO. REVISIONS		DATE	05/12/02



ENGINEER'S SEAL	
ORIGINAL SIGNED BY	M. KLASSON
	2005/12/02
CONSULTANT DRAWING NO.	CS2.02

THE CITY OF WINNIPEG
WATER AND WASTE DEPARTMENT
ENGINEERING DIVISION

NEWPCC CENTRATE NUTRIENT TREATMENT
PHOSPHORUS REMOVAL FACILITY
CONTRACT No. 1

STRUCTURAL
RAILCAR SHELTER
MASONRY WALL PLAN AND ROOF FRAMING PLAN

CITY FILE NUMBER

SHEET OF

CITY DRAWING NUMBER
1-00F-B-80002-001-00-D

MARK	SIZE	REINFORCING	TYPE	REMARKS
MW-1	240	20M BARS	NORMAL	15 MPa GROUT 2 CORES PER METER. EACH CORE WITH 20M AT CENTER
MW-2	240	25M BARS	NORMAL	15 MPa GROUT EVERY CORE. EACH CORE WITH 25M AT CENTER.

MARK	SIZE	MATERIALS	REMARKS
L-1	240x200	MASONRY	U BLOCK
L-2	240x400	CONCRETE	REINFORCED 2-20M T&B 10M STIRRUPS @ 200 o.c.

MARK	DEPTH	SPACING	FINISH	REMARKS
J-1	600	1600 MAX.	PAINTED SEE SPEC.	