

LUMINAIRE SCHEDULE						
Type	Manufacturer	Catalogue No.	Voltage	Lamps		Mounting
				No.	Type	
4	Cooper Lighting	IC VV 1 G	120	1	200W A21	Wall Mounted
9	Keene Lighting	PHA250MA6TLR-1B c/w PH522	120	1	250W MH	Pole Mounted c/w Twistlock photo control recept and polycarbonate shield



PANEL SCHEDULE									
Panel PP-L12									
DESCRIPTION	LOAD	BKR	CCT	A	B	CCT	BKR	LOAD	DESCRIPTION
Lighting - Area	250	15	1	*		2	15	1	Receptacle - Pole mounted
Lighting - Metering Chamber	400	15	3	*		4	15	1	Receptacle - Metering Chamber
Panel Heater	500	15	5	*		6	15	100	Pump Control Panel LCP-L11
Panel Heater	500	15	7	*		8			
			9	*		10			
			11	*		12			
			13	*		14			
			15	*		16			
			17	*		18			
			19	*		20			
			21	*		22			
			23	*		24			
			25	*		26			
			27	*		28			
			29	*		30			

Voltage: 120/240V/1Ø/3 wire Feeder:

Mains: Main Breaker: N/A

Location: Power Distribution Enclosure Power Source Transformer XFMR-PP-L12

Mounting:

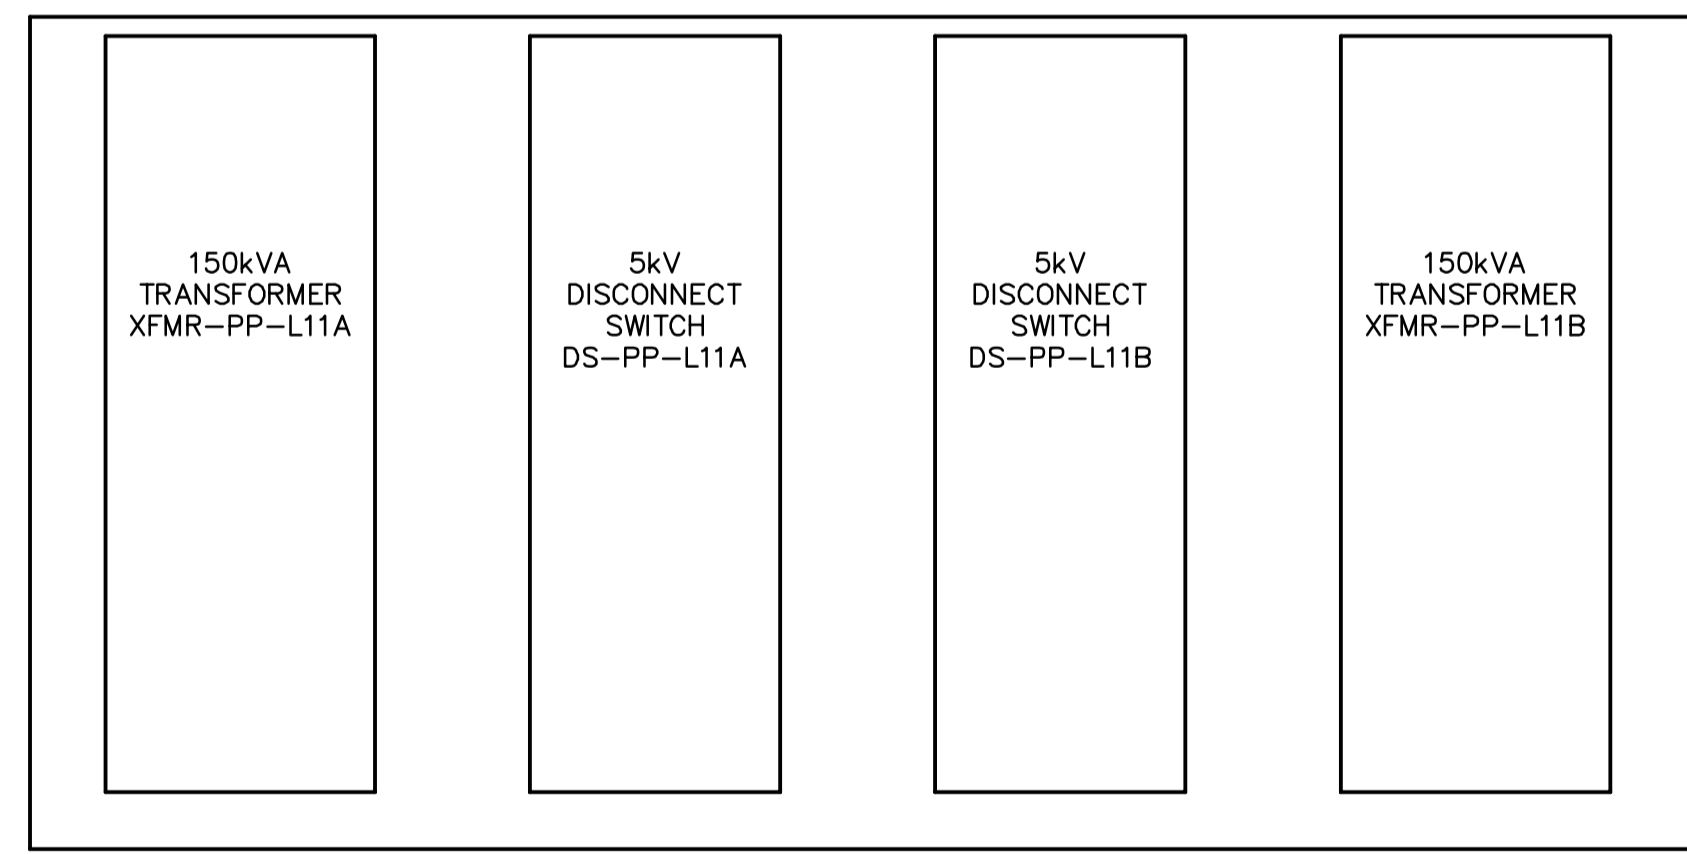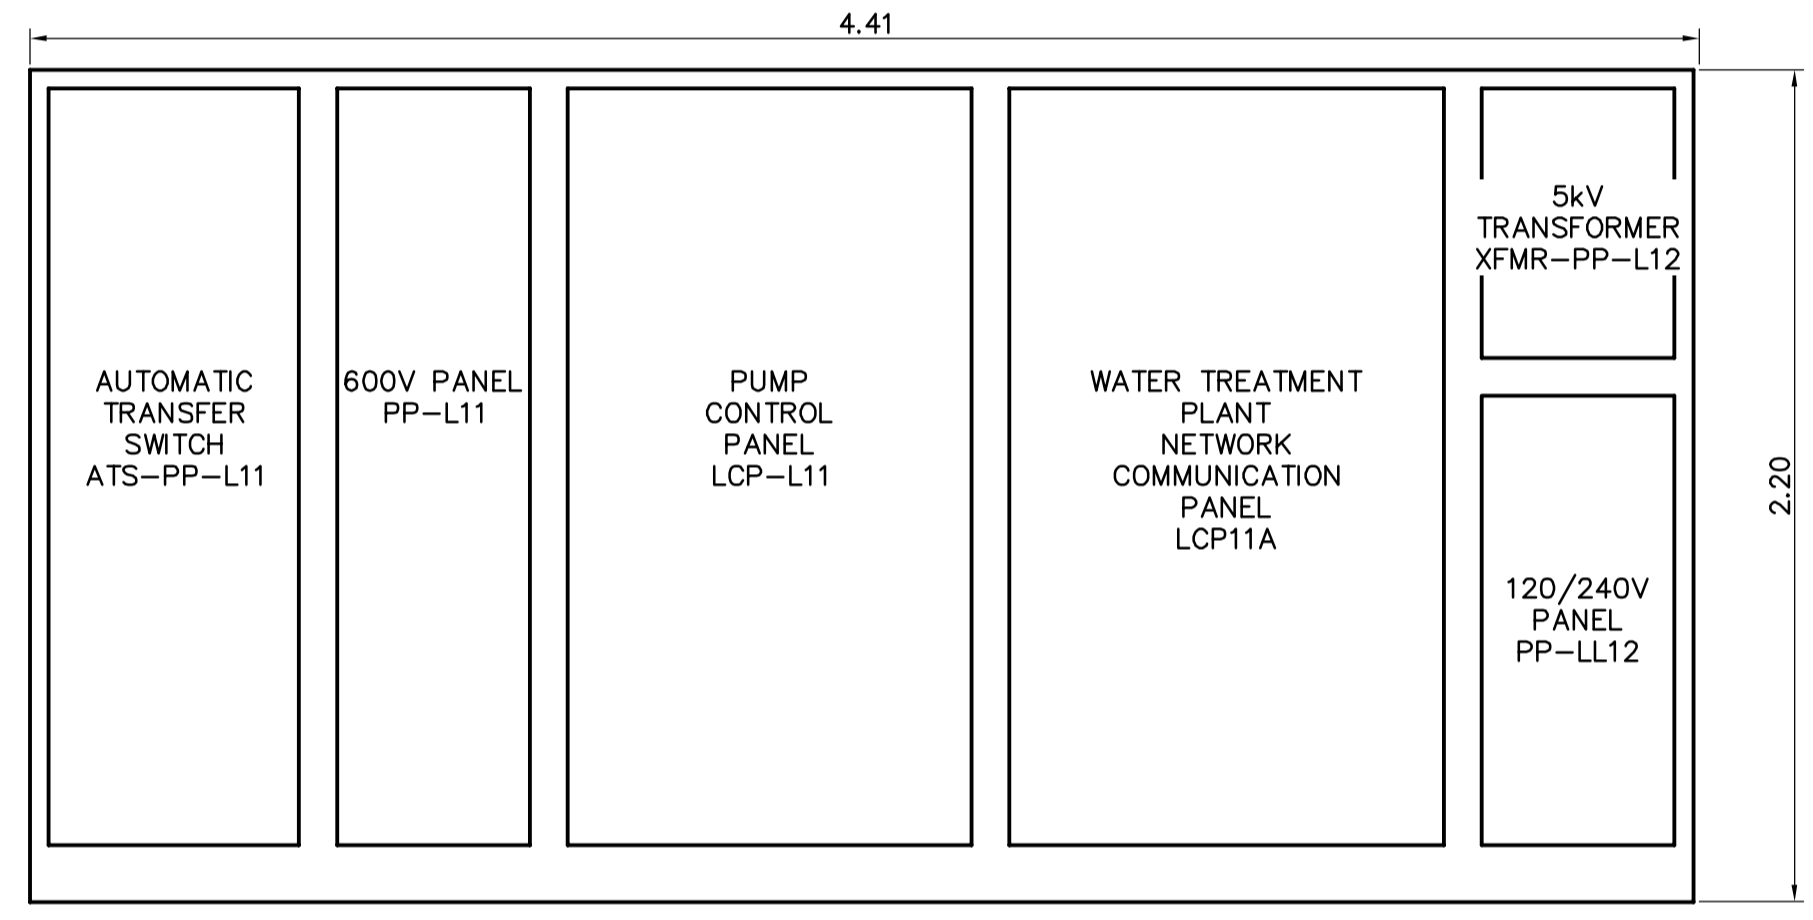

DETAIL - POWER DISTRIBUTION ENCLOSURE
1 : 20
*DOORS REMOVED FOR CLARITY

 APEGM Certificate of Authorization Earth Tech Canada Inc. No. 730 Expiry: April 30, 2006	B.M. ELEV.	 Frederickson Cooper ARCHITECTS	 A Tech International Ltd. Company	ENGINEER'S SEAL	 THE CITY OF WINNIPEG WATER AND WASTE DEPARTMENT ENGINEERING DIVISION		
	DESIGNED BY: BLM			CHECKED BY: PS		WATER TREATMENT PLANT DEWATERING CELLS CONSTRUCTION	CITY FILE NUMBER
	DRAWN BY: ERC			APPROVED BY:			SHEET OF
	SCALE: AS SHOWN			RELEASED FOR CONSTRUCTION BY:		CONSULTANT DRAWING NO. WL-E0112	CITY DRAWING NUMBER 1-0601L-A-E0112-001-000