

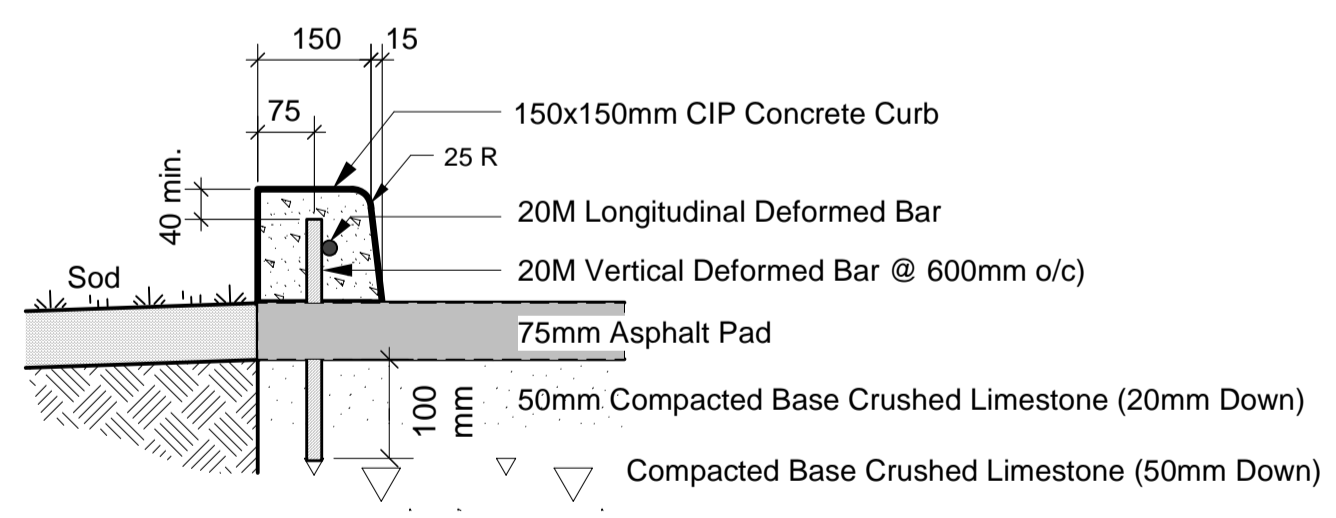



- CONSTRUCTION NOTES:**
- 1.) ALL EXCAVATION AND GRANULAR BASE WORK SHALL BE COMPLETED IN ACCORDANCE WITH CW 3110 - R7
  - 2.) ASPHALT WORK WILL BE DONE IN ACCORDANCE WITH CW 3410 - R5
  - 3.) CONCRETE WORK WILL BE DONE IN ACCORDANCE WITH CW 3310 - R8
  - 4.) GRANULAR BASE SHALL BE INSPECTED AND APPROVED BY THE CITY OF WINNIPEG PRIOR TO ASPHALT INSTALLATION
  - 5.) ALL GRADES TO BE CONFIRMED WITH CITY OF WINNIPEG PRIOR TO CONSTRUCTION
  - 6.) IF SOFT SPOTS AND/OR FROST SUSCEPTIBLE SILT DEPOSITS ARE ENCOUNTERED DURING THE COURSE OF COMMON EXCAVATION, CONSTRUCTION TRAFFIC SHALL BE RESTRICTED. THE SILT AND SOFT SPOTS SHALL BE SUBEXCAVATED TO THE LOWER LIMIT OF UNSUITABLE MATERIAL OR DO A DEPTH OF 600 mm BELOW THE ELEVATION OF THE BOTTOM SUBBASE AND REPLACED WITH A 600 mm THICK LAYER OF 100 mm DOWN DURABLE CRUSHED LIMESTONE IN ACCORDANCE WITH SPECIFICATION CW 3110 - R7. THE CONTRACTOR MUST OBTAIN THE CITY OF WINNIPEG'S APPROVAL PRIOR TO COMMENCEMENT OF THIS WORK.
  - 7.) DETERMINE LOCATION OF ALL UNDERGROUND UTILITIES AND OBTAIN CLEARANCES PRIOR TO CONSTRUCTION. UNDERGROUND INFORMATION IS BASED ON THE BEST INFORMATION AVAILABLE. THE CITY OF WINNIPEG MAKES NO GUARANTEE TO THE CORRECTNESS OF THE INFORMATION.
  - 8.) CONTRACTOR RESPONSIBLE TO CLEAN UP SITE AFTER CONSTRUCTION. THE CONTRACTOR SHALL RESTORE ALL AREAS OF THE SITE BEYOND THE ESTABLISHED LIMIT OF WORK TO AS GOOD OR BETTER THAN THE ORIGINAL CONDITION.
  - 9.) ALL MEASUREMENTS AND DIMENSIONS ARE IN METRIC.
  - 10.) ALL ELEVATIONS SHOWN ARE GEODETIC ELEVATIONS - ADD 200.00

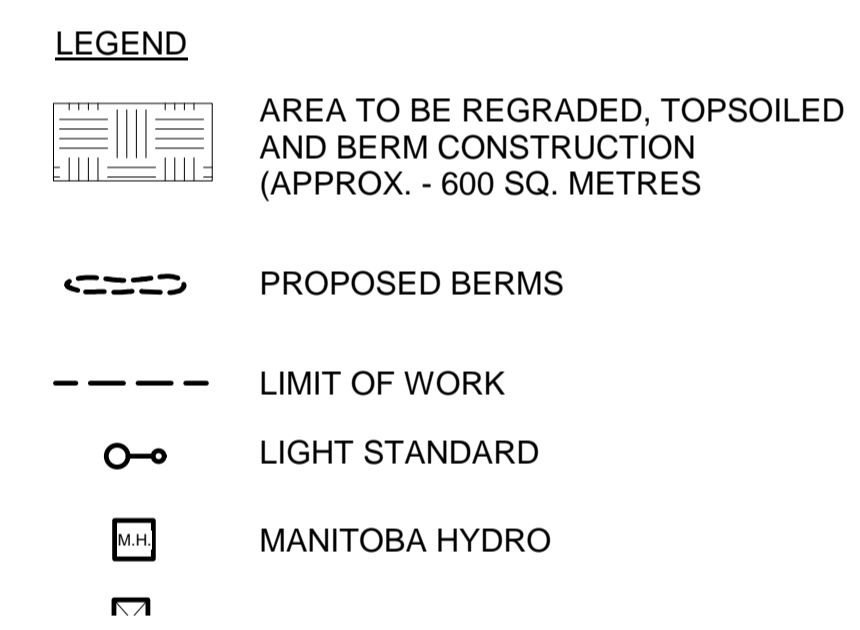

**2 CONCRETE BARRIER CURB**  
A.4 - P C.I.P.  
SCALE 1:10

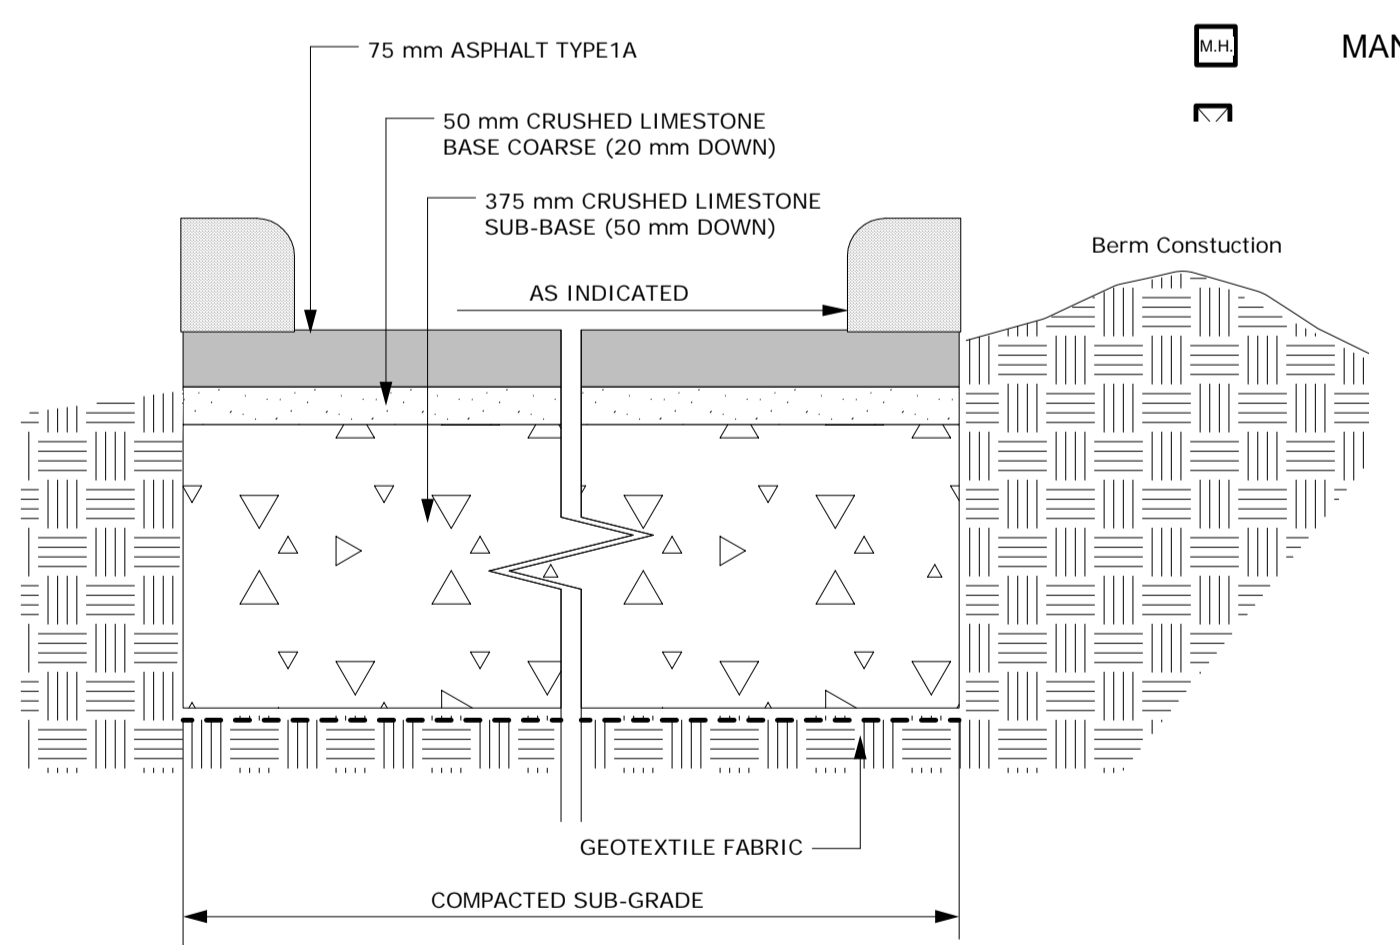

**1 TYPICAL ASPHALT PARKING LOT CROSS-SECTION**  
A.4 - P  
SCALE 1:25

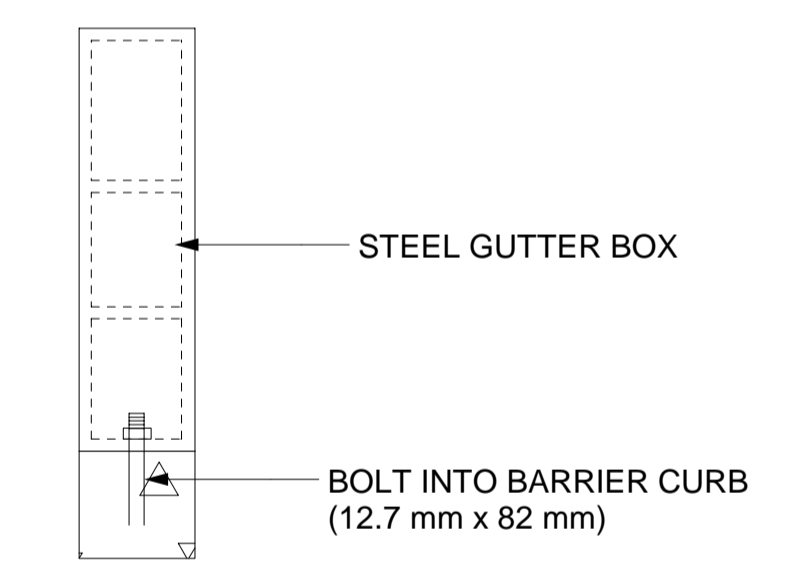

**3 STEEL GUTTER INLET BOX DETAIL**  
A.4 - P SEE SD-108  
SCALE 1:10

560 mm x 864 mm DRAWING SHEET - DO NOT SCALE

EXISTING	LEGEND - PLAN	PROPOSED	EXISTING	LEGEND - PLAN	PROPOSED	EXISTING	LEGEND - PROFILE	PROPOSED
+	WATERMAIN	+	+	HYDRO	+	150mm W.M.	+	150mm W.M.
+	HYDRANT VALVE	+	+	M.T.S. CONCRETE	+	150mm W.M.	+	HYDRANT VALVE
---	LAND DRAINAGE SEWER	---	---	ASPHALT	---	300mm L.D.S.	---	LAND DRAINAGE SEWER
---	WASTE WATER SEWER	---	---	PROPERTY LINE	---	250mm W.W.S.	---	WASTE WATER SEWER
○	MANHOLE	●	⊕	SURVEY BAR	⊕			
□	CATCH BASIN	■	⊕	CURB STOP	⊕			
△	CURB INLET	▲	⊕	C.B. LEAD	⊕			
				SIDEWALK				
				SIDEWALK RAMP				
				ELEVATIONS		32.55		32.55

**LOCATION APPROVED UNDERGROUND STRUCTURES**

SUPV. U/G STRUCTURES COMMITTEE DATE

**NOTE:**  
LOCATION OF UNDERGROUND STRUCTURES AS SHOWN ARE BASED ON THE BEST INFORMATION AVAILABLE BUT NO GUARANTEE IS GIVEN THAT ALL EXISTING UTILITIES ARE SHOWN OR THAT THE GIVEN LOCATIONS ARE EXACT. CONFIRMATION OF EXISTENCE AND EXACT LOCATION OF ALL SERVICES MUST BE OBTAINED FROM THE INDIVIDUAL UTILITIES BEFORE PROCEEDING WITH CONSTRUCTION.

NO.	REVISIONS	DATE	BY

THIS DRAWING SHALL NOT BE USED FOR CONSTRUCTION PURPOSES UNTIL SIGNED BELOW.

THE CONTRACTOR SHALL CHECK ALL DIMENSIONS AND OTHER DATA ON SITE AND REPORT ANY DISCREPANCIES TO THE CONTRACT ADMINISTRATOR.

FIGURED DIMENSIONS TO BE TAKEN IN PREFERENCE TO SCALED DIMENSIONS.

DESIGNED BY	J.F.	CHECKED BY	J.K.	RELEASED FOR CONSTRUCTION
DRAWN BY	J.F.	APPROVED BY	C.H.	MANAGER, PARKS AND OPEN SPACE
HORI. SCALE	1:200	DATE		
VERT. SCALE	1:200	DIRECTOR OF PLANNING, PROPERTY AND DEVELOPMENT DEPARTMENT		
DATE	June 2/2006			

ENGINEER'S / LANDSCAPE ARCHITECT'S SEAL

THE CITY OF WINNIPEG  
Planning, Property and Development Department  
Planning and Land Use Division  
Unit 15 - 30 Fort Street, Winnipeg, Manitoba R3C 4X5

**Assiniboine Forest Proposed Asphalt Parking Lot Site Plan**

DRAWING TITLE: Assiniboine Forest Proposed Asphalt Parking Lot Site Plan

CAD DRAWING NO. SHEET 1 OF 2 DRAWING NO. A.4 - P