


1 ROOF PLAN  
1:100



- DRAWING NOTES**
- ① 915x1220 RELIEF AIR HOOD ON ROOF c/w BACK DRAFT DAMPER. TERMINATE INTAKE OPENING APPROX. 600mm BELOW ROOF DECK. SEE DRAWING WG-H0402 DETAIL 5.
  - ② INSULATE ALL SUPPLY AIR DUCT WITH 25mm FOIL FACED INSULATION.
  - ③ EXTEND REFRIGERANT SUCTION, LIQUID AND HOT GAS PIPING UP THROUGH ROOF TO CONDENSING UNITS. SEE WG-H401 DETAIL 6.
  - ④ COMBINED VENTING/INLET AIR OPENING OF GAS FIRED UNIT HEATER.

- GENERAL NOTES**
1. COORDINATE WITH OTHER TRADES SO AS TO PREVENT CONFLICTS.
  2. ALL DUCTWORK SHALL BE SUPPORTED AND SUSPENDED AS PER SPECIFICATIONS AND LOCAL CODES (SEE DETAILS).

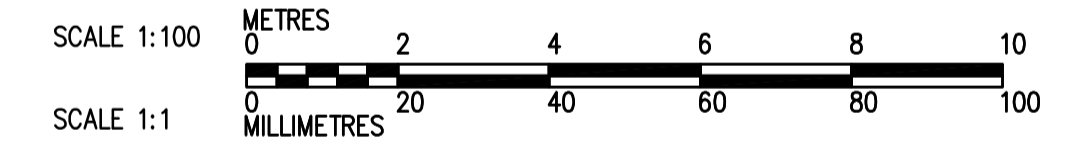

B.M. ELEV.		 		ENGINEER'S SEAL	
				ORIGINAL SIGNED BY	
		DESIGNED BY AB/LJW	CHECKED BY AMA, PVL	A. BURACHYNSKY	
		DRAWN BY LJW	APPROVED BY AHL	2006/08/30	
		SCALE: 1:100		CONSULTANT DRAWING NO.	
01 498-2006 ADDENDUM 3 06/09/28 DC		RELEASED FOR CONSTRUCTION BY: R. SOROKOWSKI		WG-H0140	
00 ISSUED FOR TENDER 06/08/28 LJW		DATE 2006/05/29	DATE 2006/08/30		
NO. REVISIONS		DATE	BY		

**THE CITY OF WINNIPEG**  
**WATER AND WASTE DEPARTMENT**  
**ENGINEERING DIVISION**

WATER TREATMENT PLANT  
 STANDBY POWER GENERATOR

MECHANICAL  
 VENTILATION PLAN

CITY FILE NUMBER  
 SHEET OF  
 CITY DRAWING NUMBER  
 1-0601G-A-H0140-001-01D