



PILE PLAN
1:20

DESIGN LOADS:
 D.L. = STRUCTURAL SELF-WEIGHT
 L.L. = 12.0 kPa

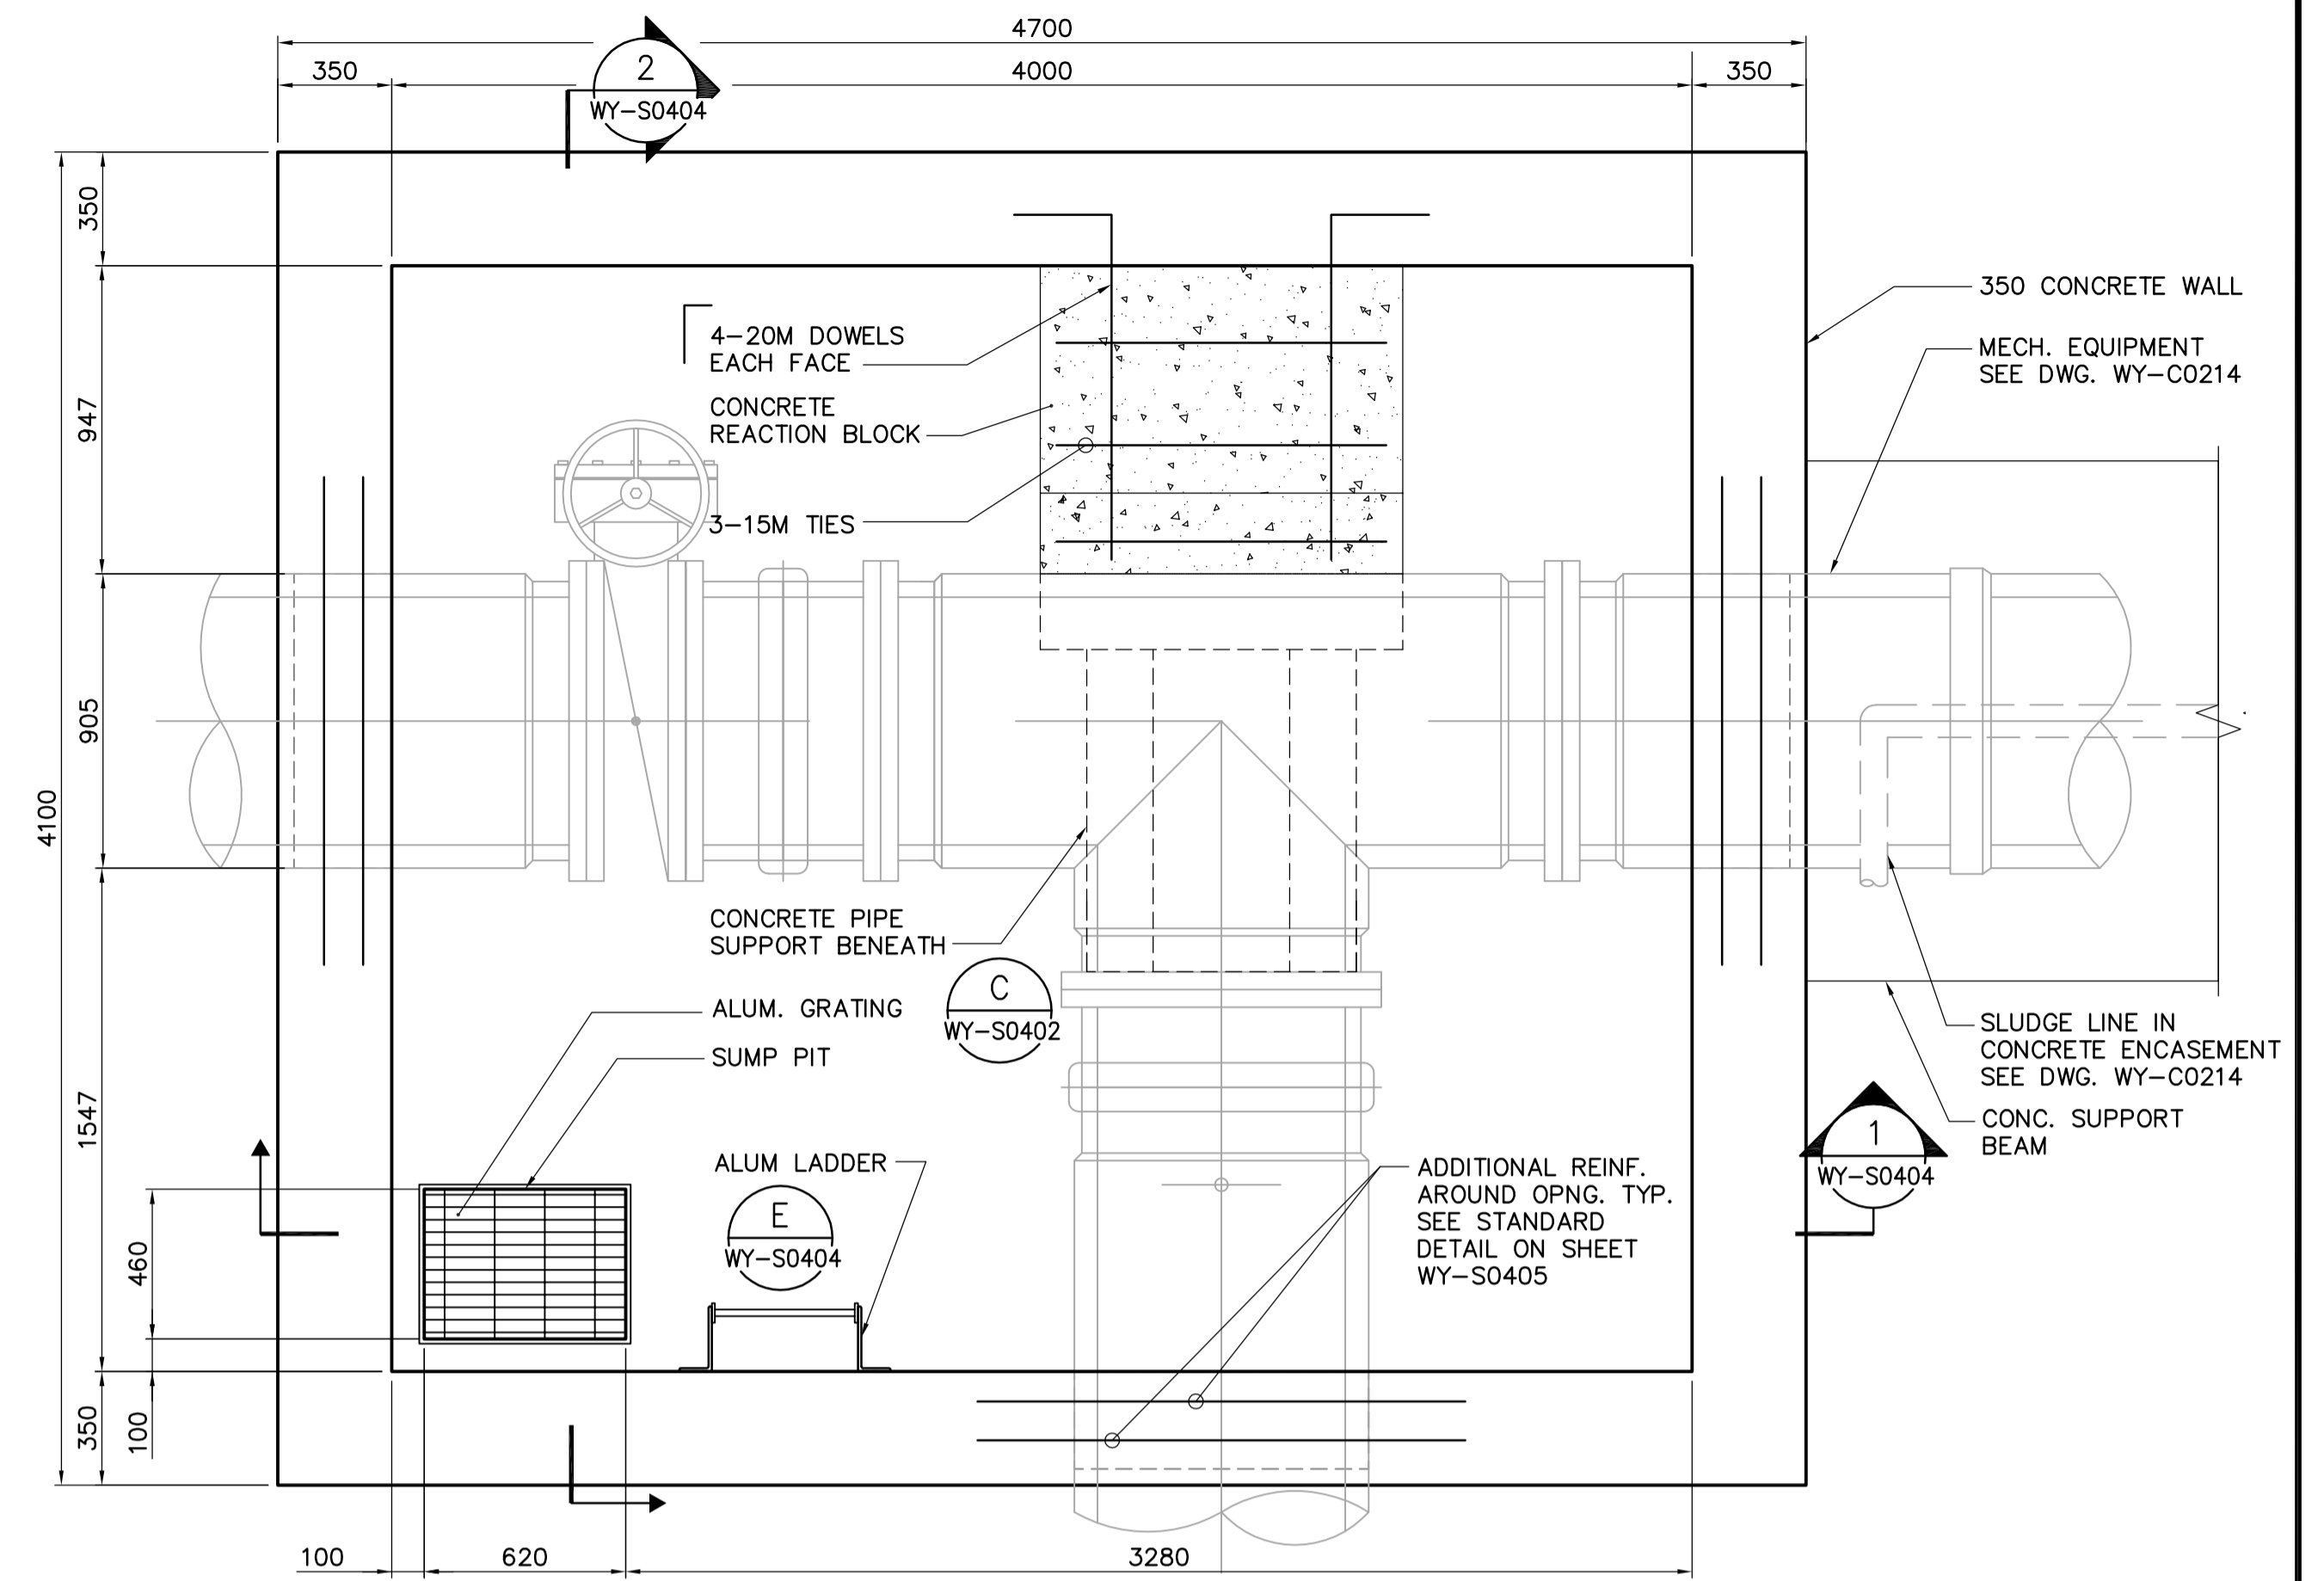


FLOOR PLAN
1:20

DESIGN LOADS:
 D.L. = STRUCTURAL SELF-WEIGHT
 L.L. = 12.0 kPa
 SNOW = 1.56 kPa

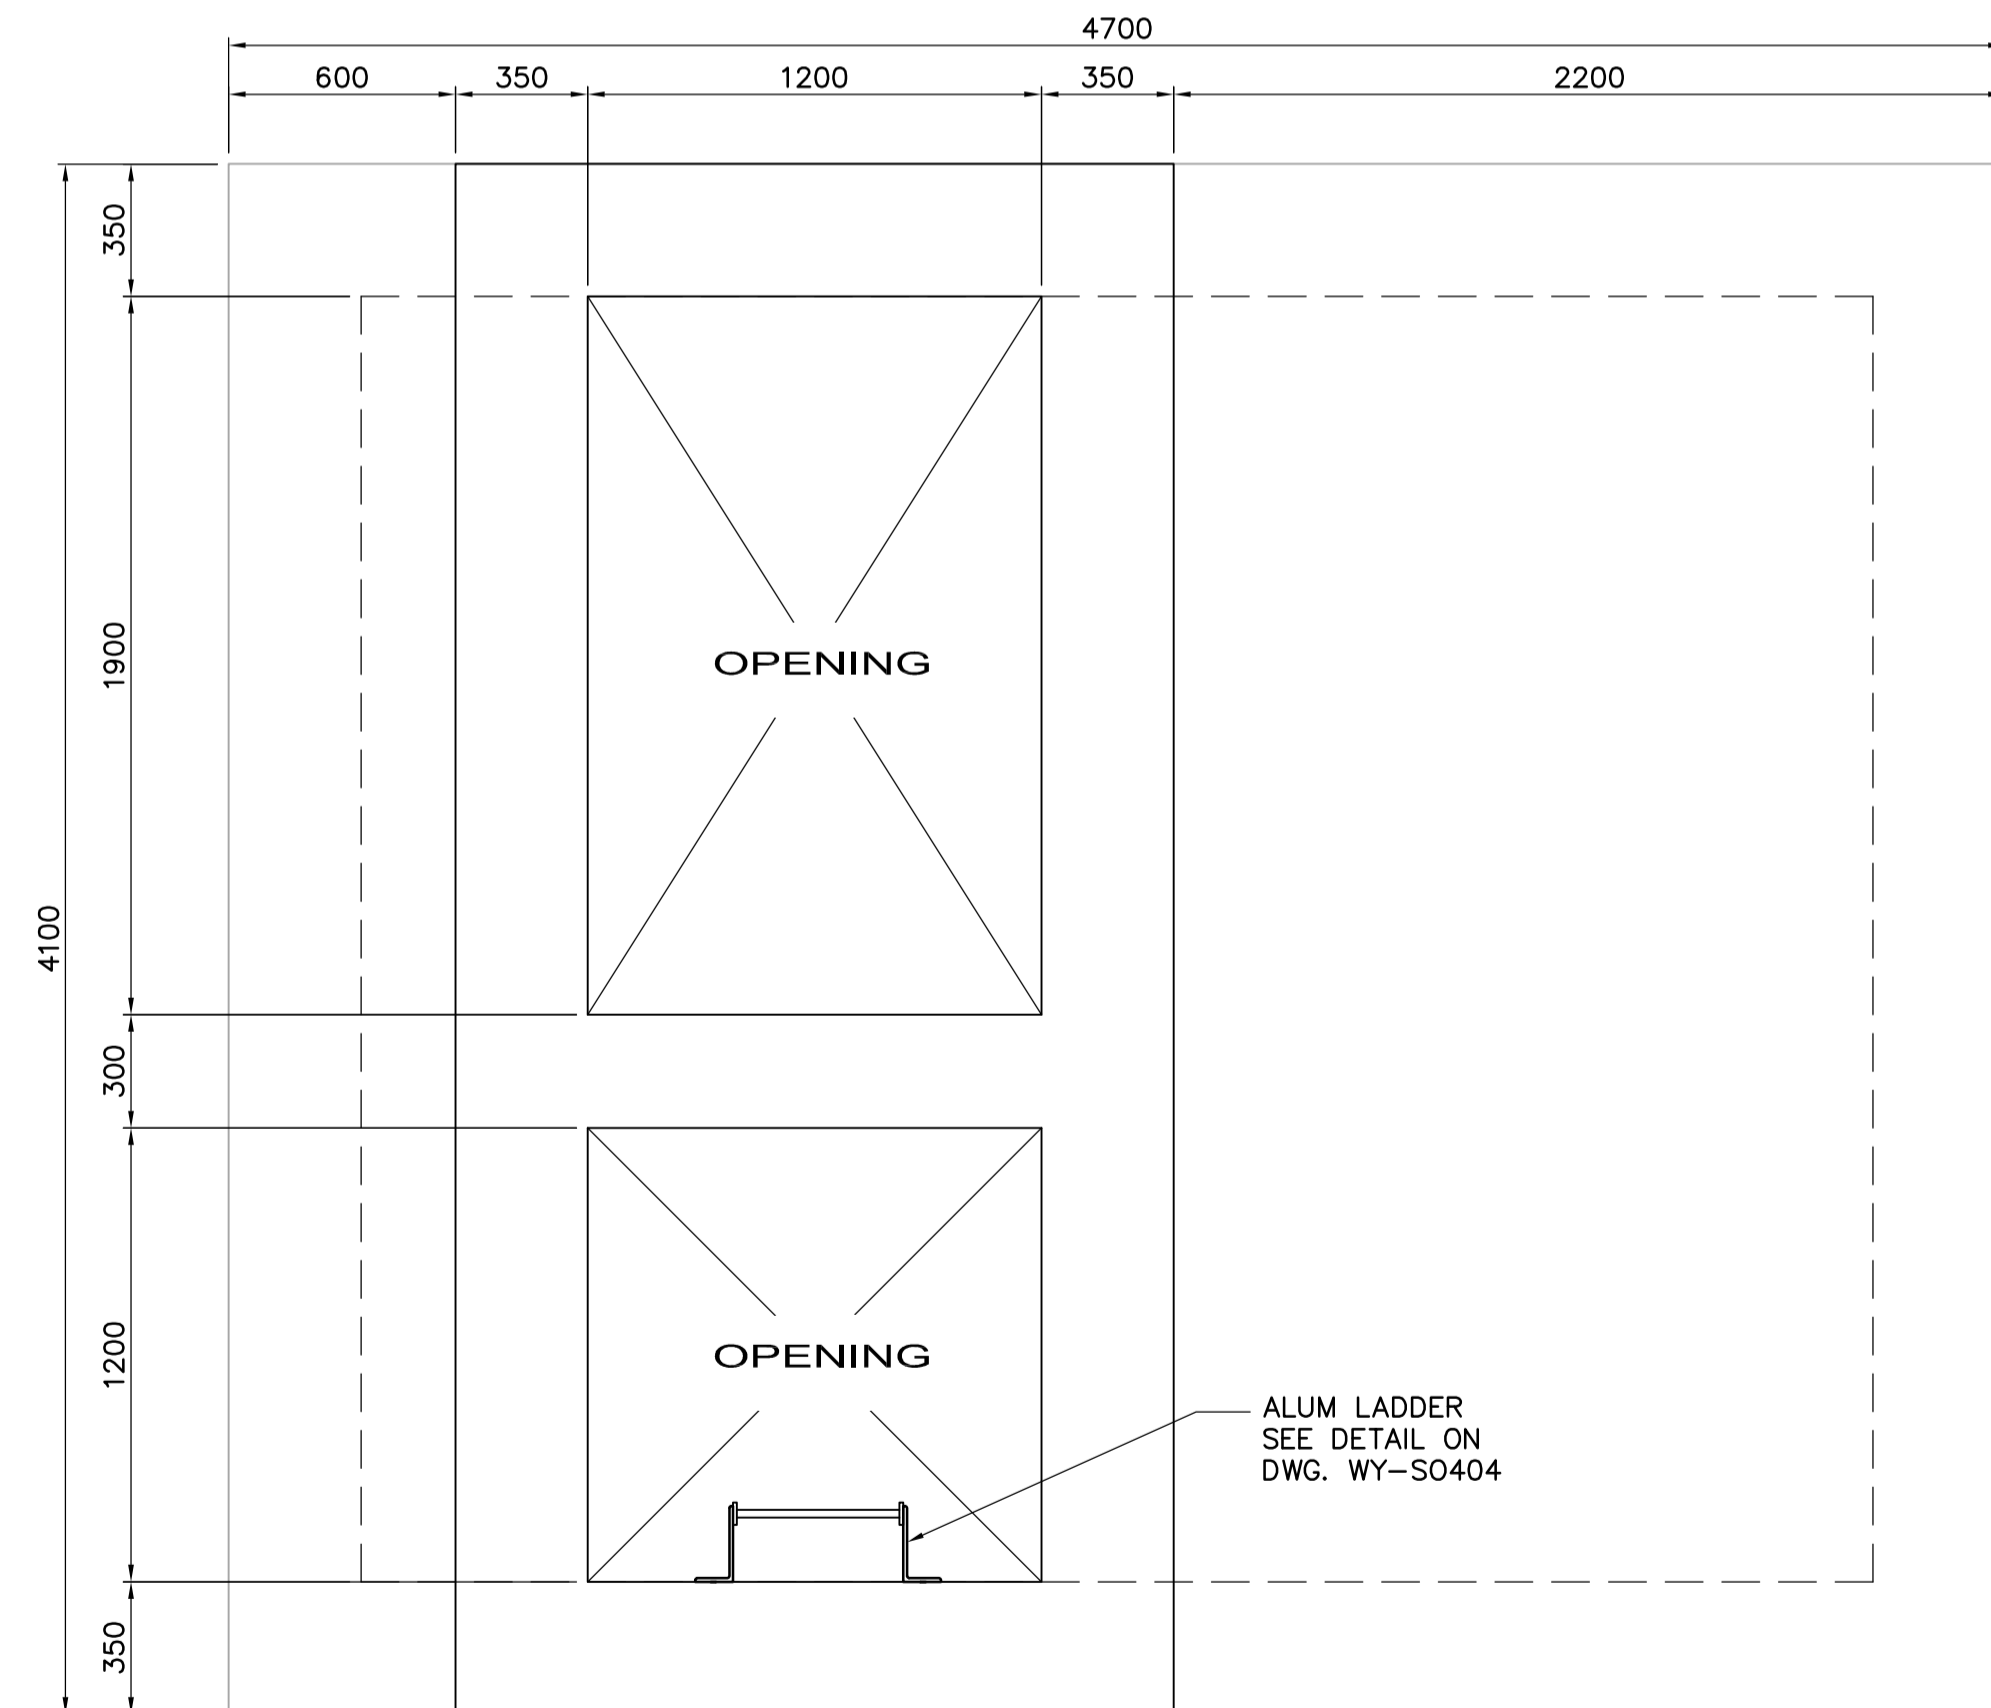

LOWER ROOF - PLAN
1:20

UPPER ROOF - ACCESS HATCH PLAN
1:20

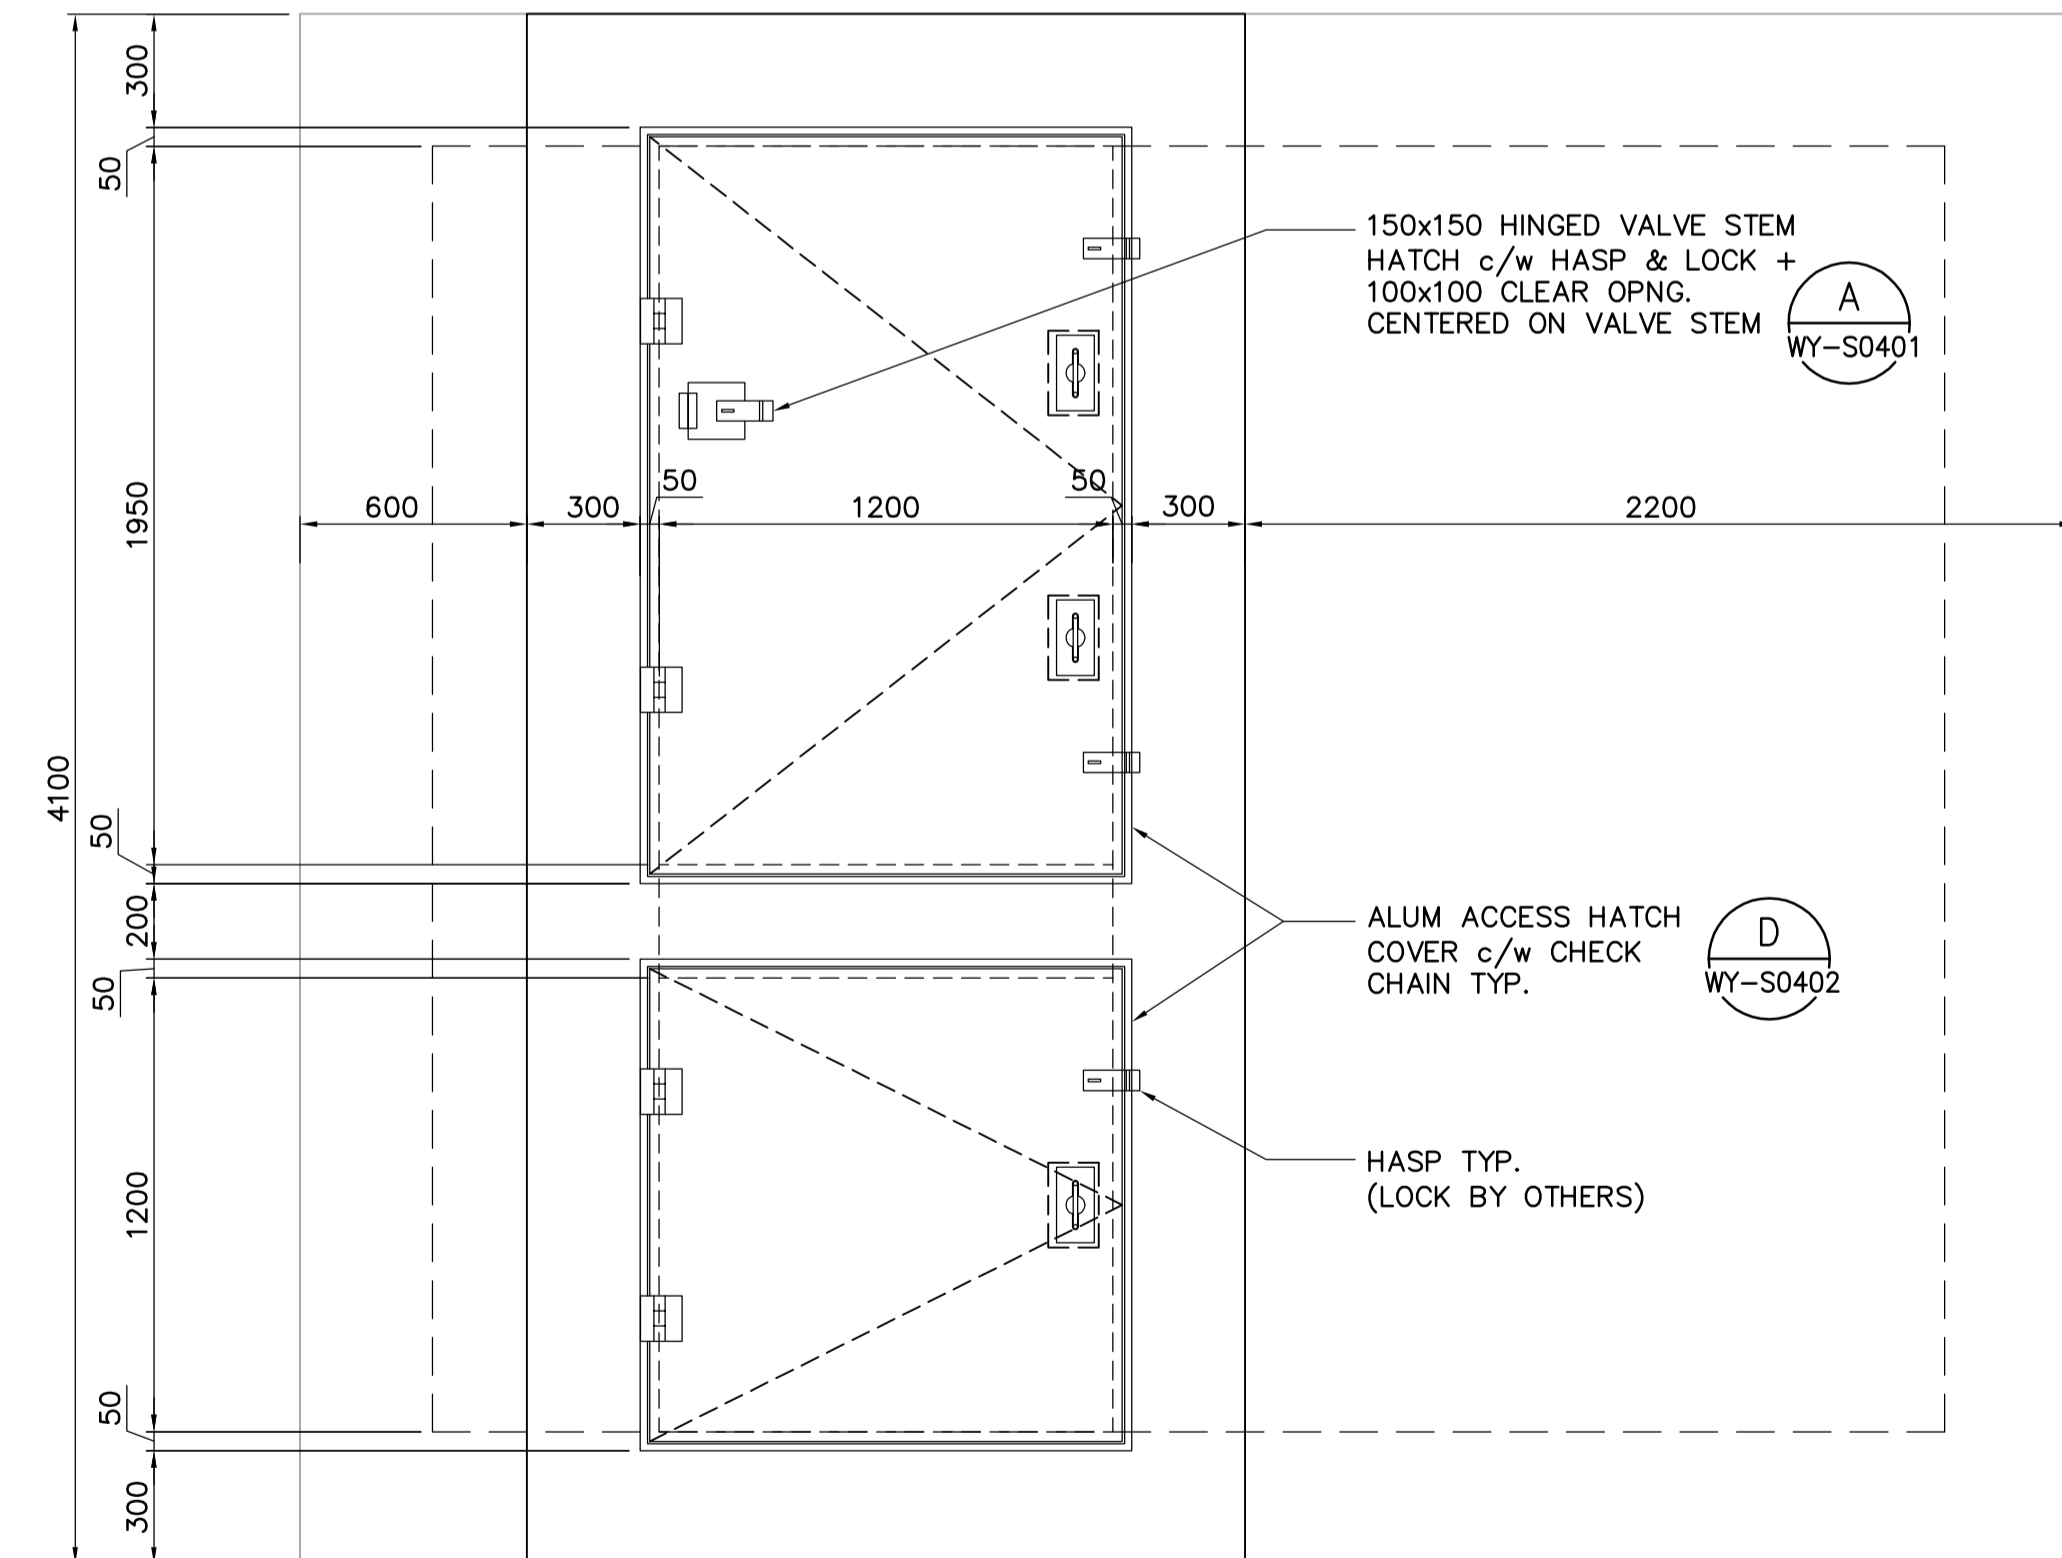

<p>Certificate of Authorization Earth Tech Canada Inc. No. 730 Expiry: April 30, 2007</p>	<p>Frederickson Cooper ARCHITECTS</p>		<p>A Type International Ltd. Company</p>		ENGINEER'S SEAL ORIGINAL SIGNED BY A. POCHANART 2007/01/26		<p>THE CITY OF WINNIPEG WATER AND WASTE DEPARTMENT ENGINEERING DIVISION</p>	
	DESIGNED BY: GGP / AP CHECKED BY: MK		DRAWN BY: CMF APPROVED BY: AHL		SCALE: AS NOTED RELEASED FOR CONSTRUCTION BY: R. SOROKOWSKI		CONSULTANT DRAWING NO. WY-S0403	
	NO. REVISIONS DATE BY		DATE: 2006/11/14		DATE: 2007/01/26		WATER TREATMENT PLANT WTP OVERFLOW SUPERNATANT LINE	
	00 ISSUED FOR TENDER 07/01/26 CMF						STRUCTURAL SUPERNATANT VALVE CHAMBER 2 PLAN VIEWS CITY FILE NUMBER SHEET OF CITY DRAWING NUMBER 1-0601Y-A-S0403-001-000	