


MAIN FLOOR POWER PLAN  
1:75

- DRAWING NOTES**
- 1 CONTROL WIRING FROM OVERHEAD DOOR OPENER TO MOTOR.
  - 2 CONNECT GROUND POINT IN PANEL TO BUILDING GROUND FOLLOWING PROPER METHOD.
  - 3 PROVIDE A #10 INSULATED GROUND WIRE IN 20mm CONDUIT (UNDERGROUND) FROM WALL MOUNTED GROUND BUS TO SOUTH TRACK RAIL. MAKE THERMOWELDED CONNECTION AT RAIL. WALL MOUNTED GROUND BUS TO BE CONNECTED TO MAIN BUILDING GROUND IN ELECTRICAL ROOM.

- GENERAL NOTES**
- 1. COORDINATE WITH OTHER TRADES SO AS TO PREVENT CONFLICTS.

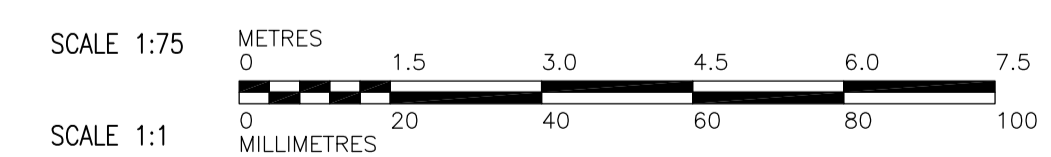

<p><b>APEGM</b> Certificate of Authorization Earth Tech Canada Inc. No. 730 Expiry: April 30, 2007</p>	B.M. ELEV.	ENGINEER'S SEAL		<p><b>THE CITY OF WINNIPEG</b> WATER AND WASTE DEPARTMENT ENGINEERING DIVISION</p> <p>WATER TREATMENT PLANT BULK CHEMICAL STORAGE SODIUM HYPOCHLORITE AND CHEMICAL STORAGE BUILDING</p> <p>ELECTRICAL MAIN FLOOR POWER PLAN</p>
	DESIGNED BY: BLM	CHECKED BY: PS	ORIGINAL SIGNED BY: P. STRYK	
	DRAWN BY: ERC	APPROVED BY: AHL	2007/01/31	
	SCALE: 1:75	RELEASED FOR CONSTRUCTION BY: R. SOROKOWSKI	CONSULTANT DRAWING NO. WS-E0112	
NO. REVISIONS	DATE BY	DATE	DATE	CITY FILE NUMBER
01	792-2006 ADDENDUM 2 07/03/21 ERC	2006/10/02	2007/01/31	SHEET OF
00	ISSUED FOR TENDER 07/01/31 ERC			CITY DRAWING NUMBER
				1-0601S-A-E0112-001-01D