


1 FERRIC CHLORIDE  
1:8

2 SULPHURIC ACID  
1:8


3 SODIUM HYDROXIDE  
1:8

4 AQUA AMMONIA  
1:8


TRUCK UNLOADING STATION PANELS

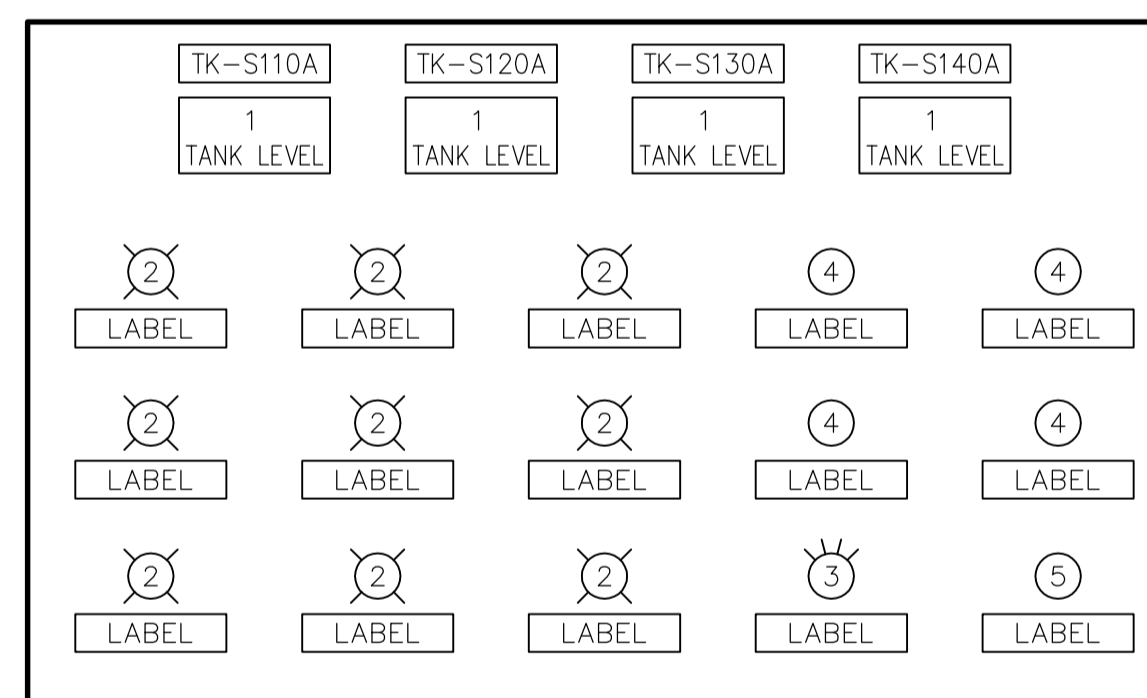

FERRIC CHLORIDE  
NTS

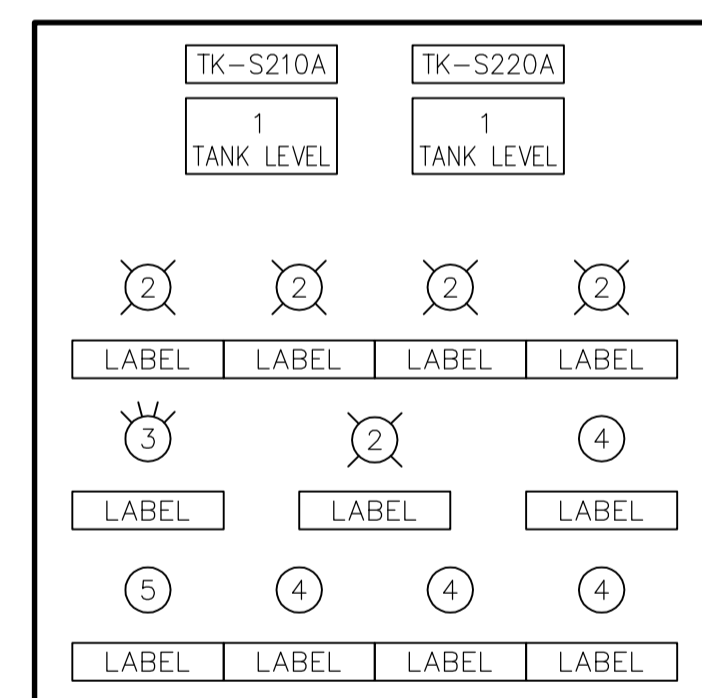

SULPHURIC ACID  
NTS

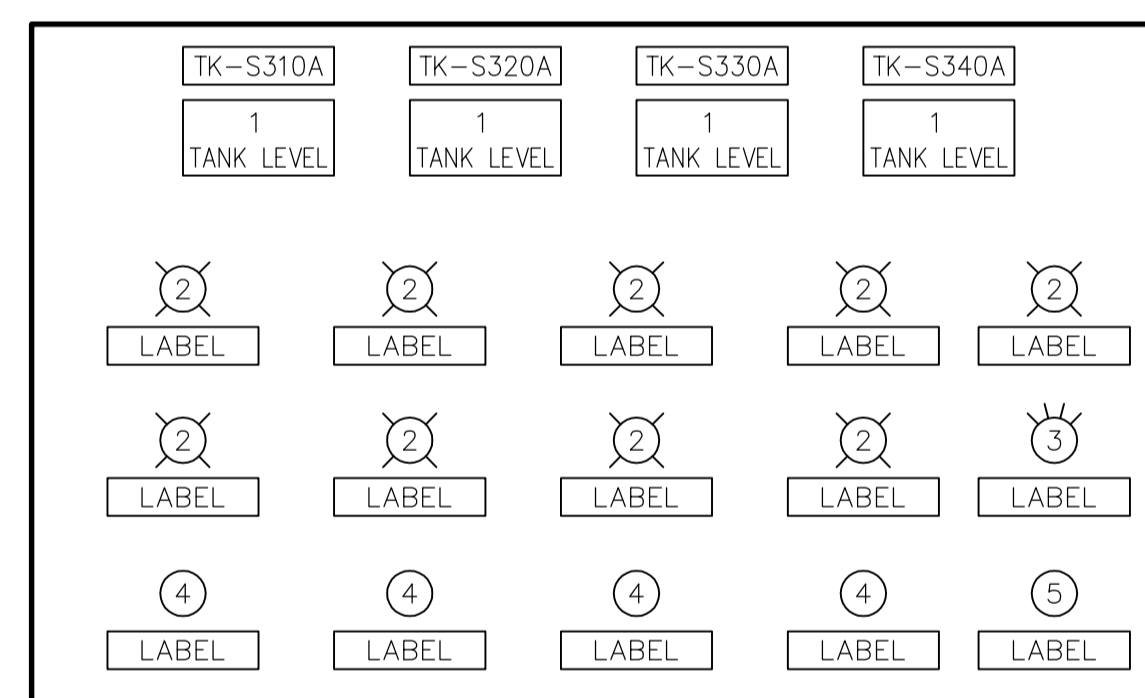

SODIUM HYDROXIDE  
NTS

**LEGEND**

- 1. LOOP POWERED INDICATOR
- 2. INDICATOR LAMP (LED TYPE PUSH TO TEST)
- 3. TANK SELECTOR SWITCH
- 4. PUSHBUTTON
- 5. EMERGENCY STOP PUSH BUTON (MUSHROOM HEAD STAY PUT, TWIST TO RELEASE).

5 RAILCAR UNLOADING STATION PANELS

**NOTES:**

1. FERRIC CHLORIDE AND SODIUM HYDROXIDE CABINETS SHALL BE MADE OF PVC.
2. SEE P&ID'S FOR FUNCTION OF SWITCHES, BUTTONS AND LABEL INFORMATION.

 Certificate of Authorization Earth Tech Canada Inc. No. 730 Expiry: April 30, 2007	B.M. ELEV.	 Frederickson Cooper ARCHITECTS	ENGINEER'S SEAL	 A Tyco International Ltd. Company	ORIGINAL SIGNED BY S.B. WILLIAMSON 2007/01/31	 THE CITY OF WINNIPEG WATER AND WASTE DEPARTMENT ENGINEERING DIVISION		
	DESIGNED BY SBW		CHECKED BY SRB				WATER TREATMENT PLANT BULK CHEMICAL BUILDING SODIUM HYPOCHLORITE AND CHEMICAL STORAGE BUILDING	CITY FILE NUMBER
	DRAWN BY JBC		APPROVED BY AHL					SHEET OF
	SCALE: AS NOTED		RELEASED FOR CONSTRUCTION BY: R. SOROKOWSKI				CONSULTANT DRAWING NO. WS-M0454	CITY DRAWING NUMBER 1-0601S-A-M0454-001-01D