


PILE PLAN
1:20


DESIGN LOADS:
D.L. = STRUCTURAL SELF-WEIGHT
L.L. = 12.0 kPa

PILE CUT OFF:
P1 TO P2 = ELEV. 232.025
P3 TO P4 = ELEV. 232.225
P5 TO P6 = ELEV. 231.850

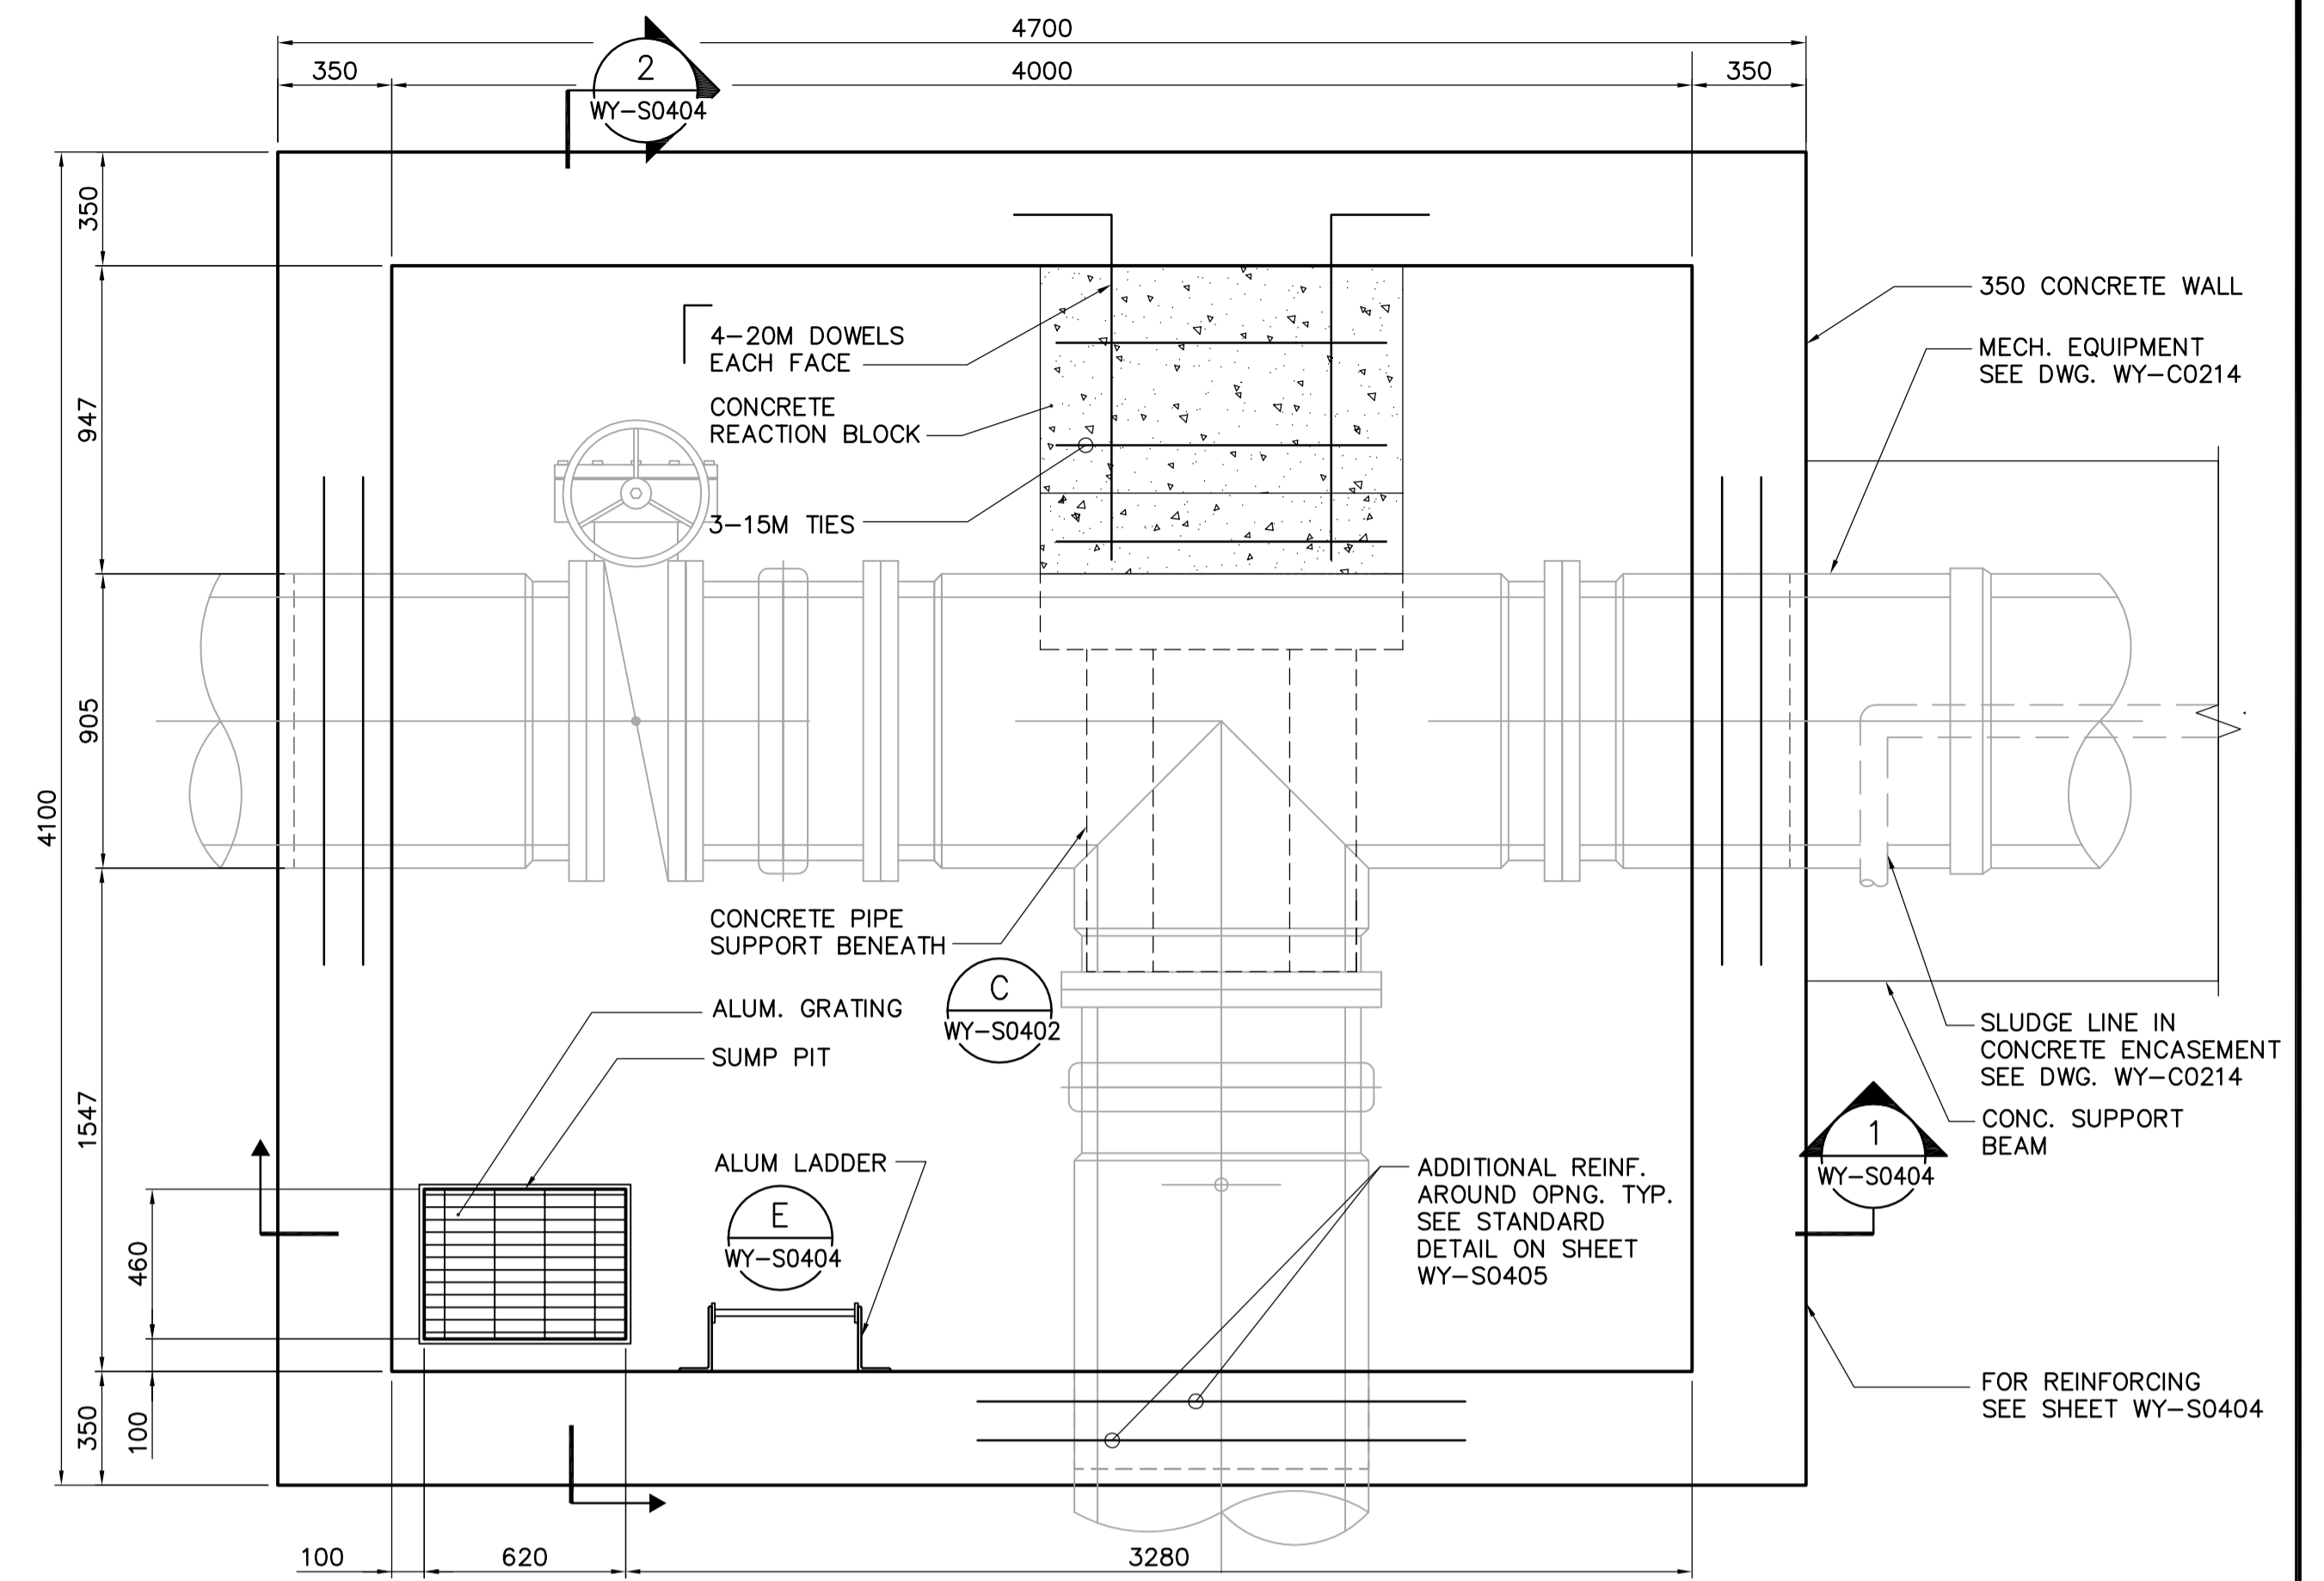


FLOOR PLAN
1:20

DESIGN LOADS:
D.L. = STRUCTURAL SELF-WEIGHT
L.L. = 12.0 kPa
SNOW = 1.56 kPa

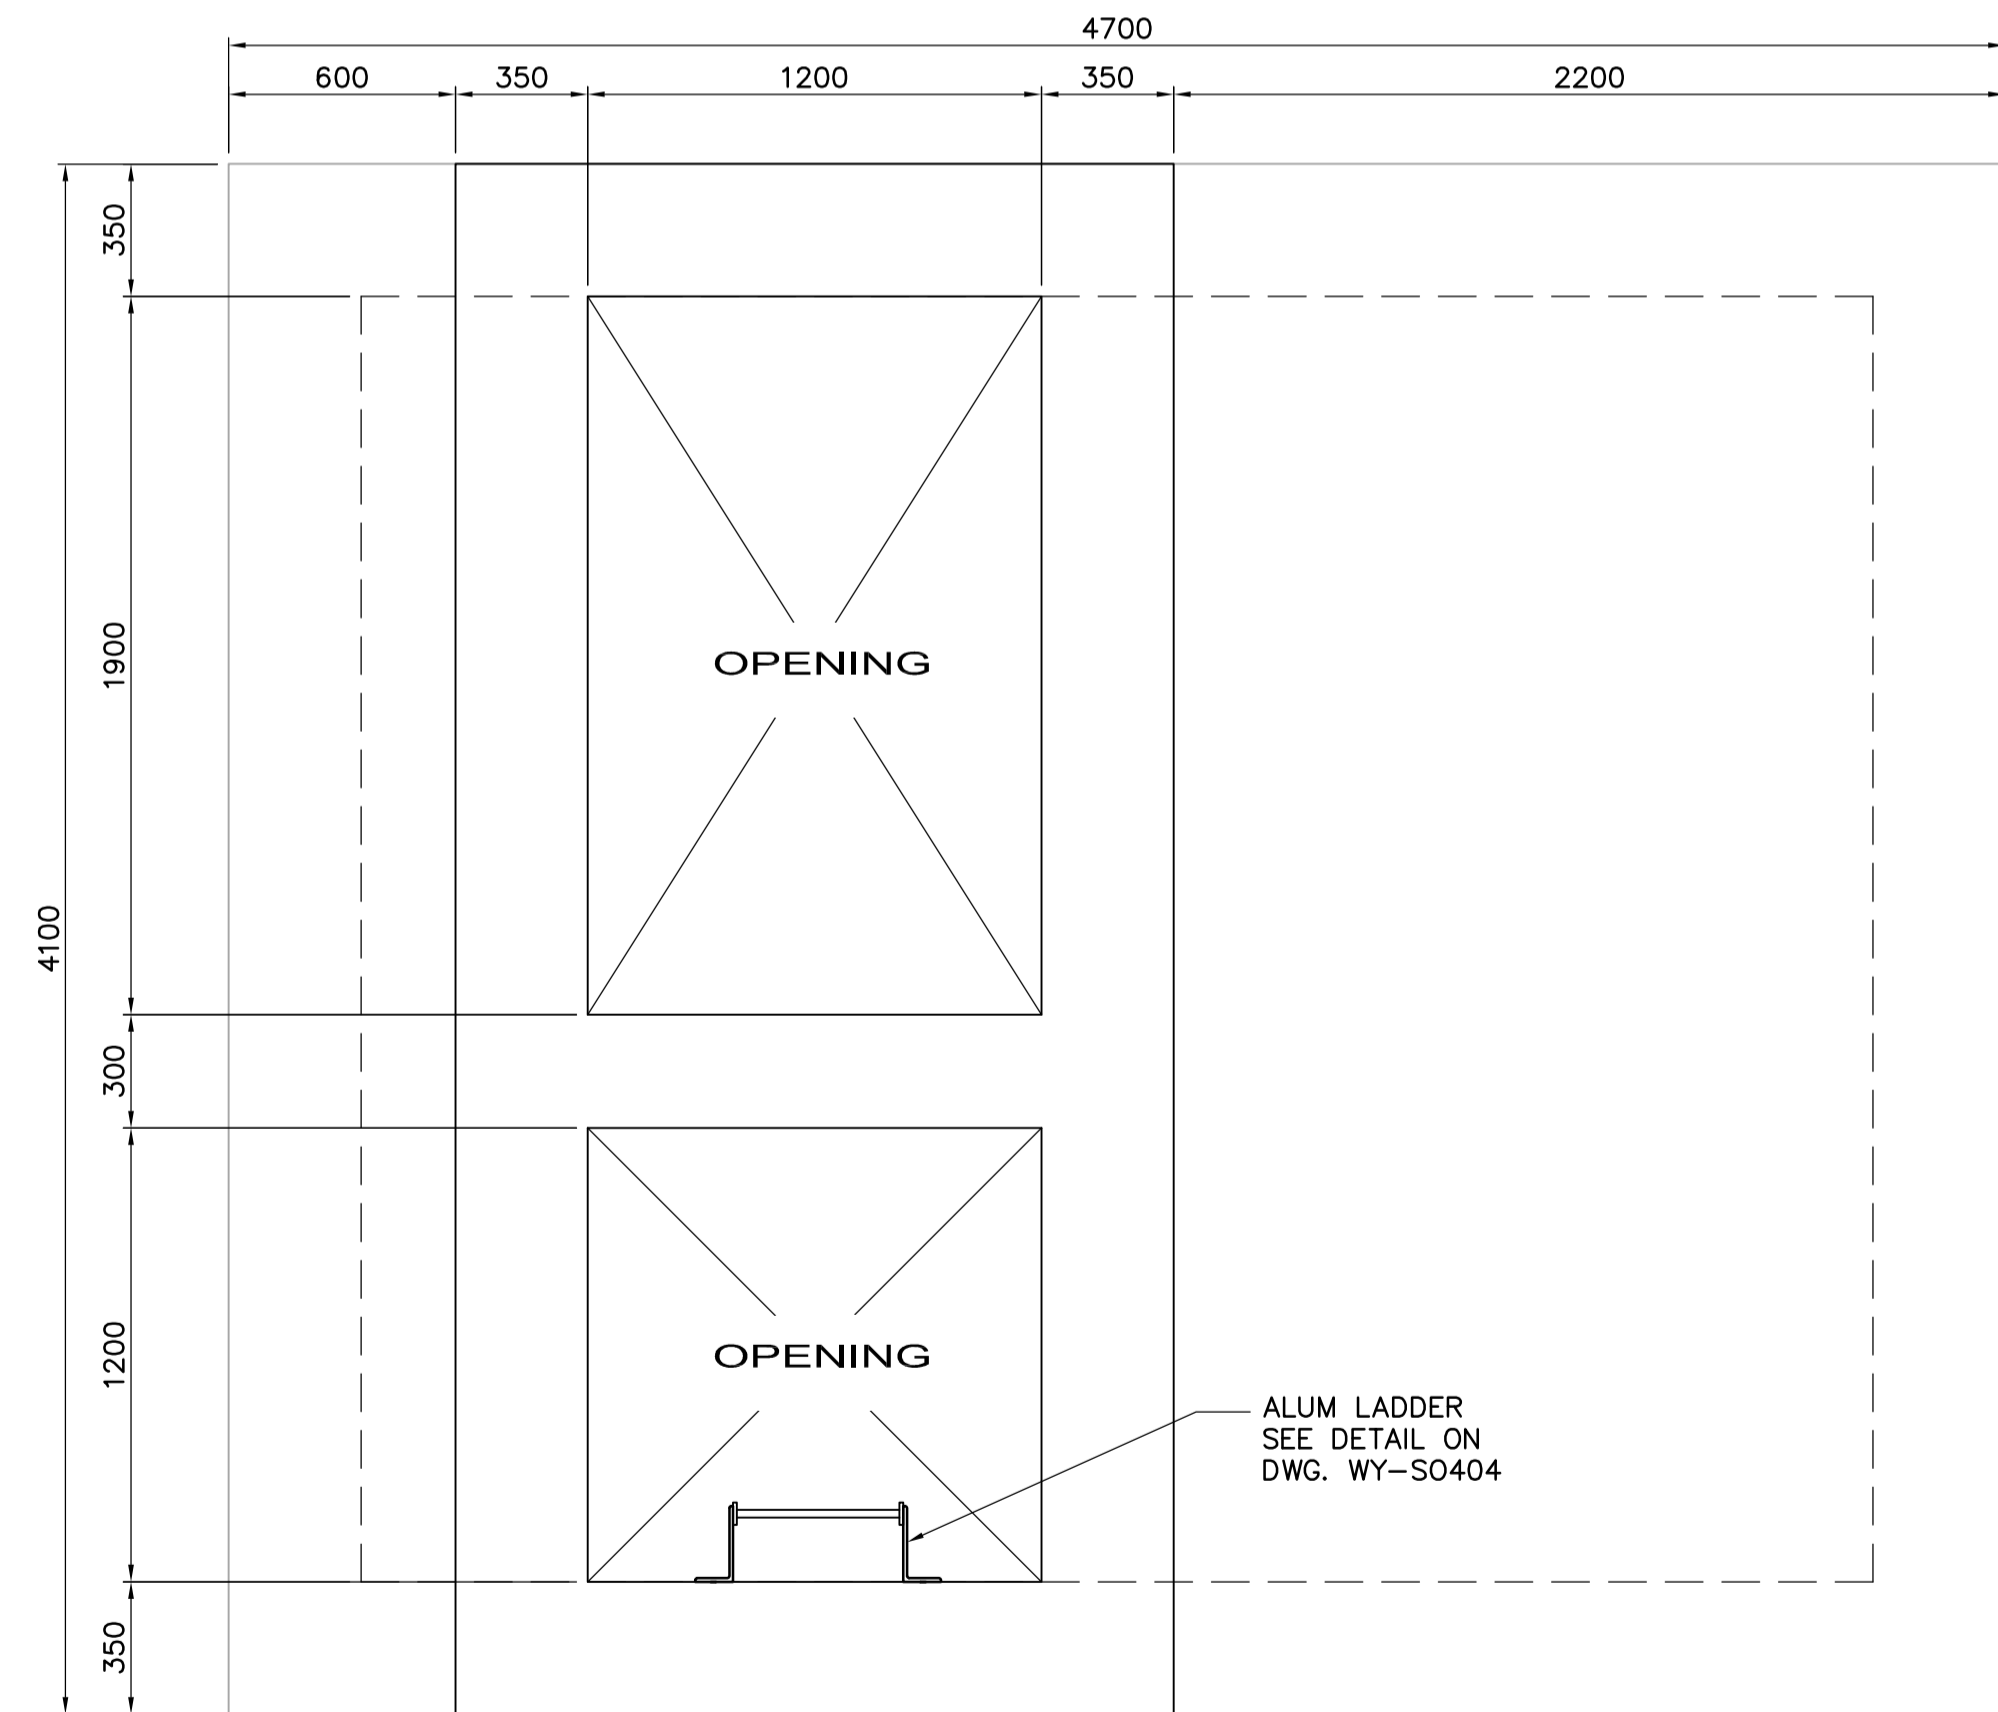

LOWER ROOF - PLAN
1:20

UPPER ROOF - ACCESS HATCH PLAN
1:20

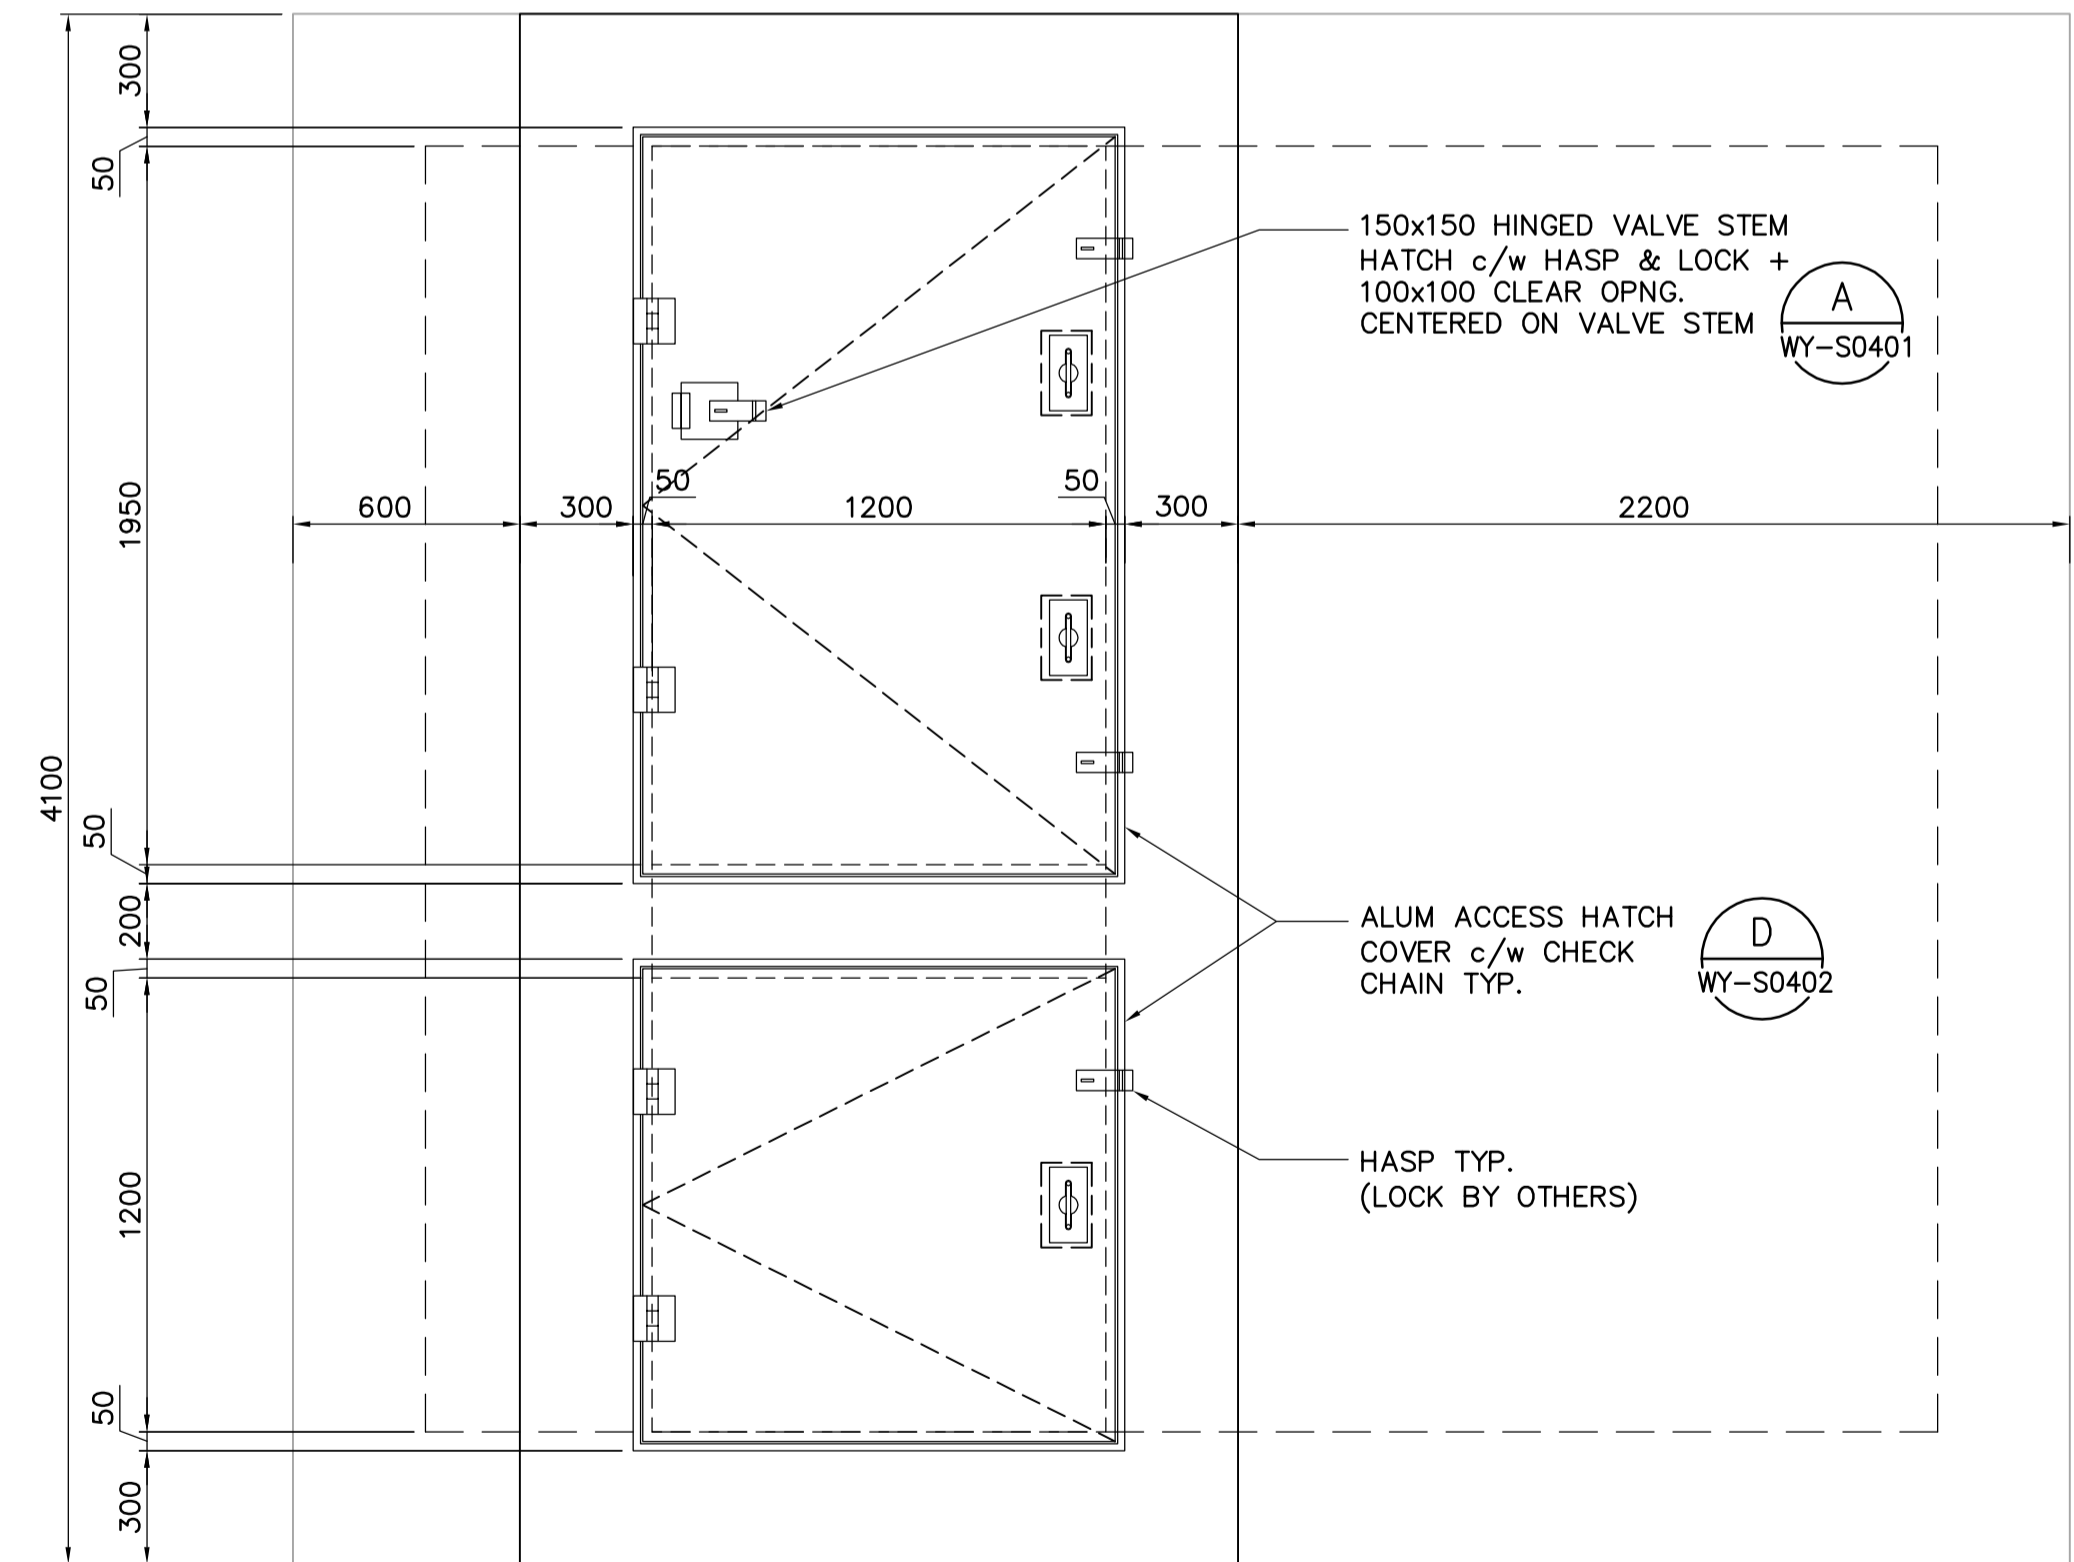

<p>Certificate of Authorization Earth Tech Canada Inc. No. 730 Expiry: April 30, 2007</p>	B.M. ELEV.	<p>Frederickson Cooper ARCHITECTS</p>	<p>A Type International Ltd. Company</p>	ENGINEER'S SEAL	<p>THE CITY OF WINNIPEG WATER AND WASTE DEPARTMENT ENGINEERING DIVISION</p>		
				DESIGNED BY: GGP / AP		CHECKED BY: MK	ORIGINAL SIGNED BY: A. POCHANART
				DRAWN BY: CMF		APPROVED BY: AHL	2007/01/26
				SCALE: AS NOTED		RELEASED FOR CONSTRUCTION BY: R. SOROKOWSKI	CONSULTANT DRAWING NO. WY-S0403
	NO. REVISIONS	DATE	DATE	DATE	<p>WATER TREATMENT PLANT SITE UTILITIES</p> <p>STRUCTURAL SUPERNATANT VALVE CHAMBER 2 PLAN VIEWS</p>	<p>CITY FILE NUMBER</p> <p>SHEET OF</p> <p>CITY DRAWING NUMBER</p> <p>1-0601Y-A-S0403-001-010</p>	