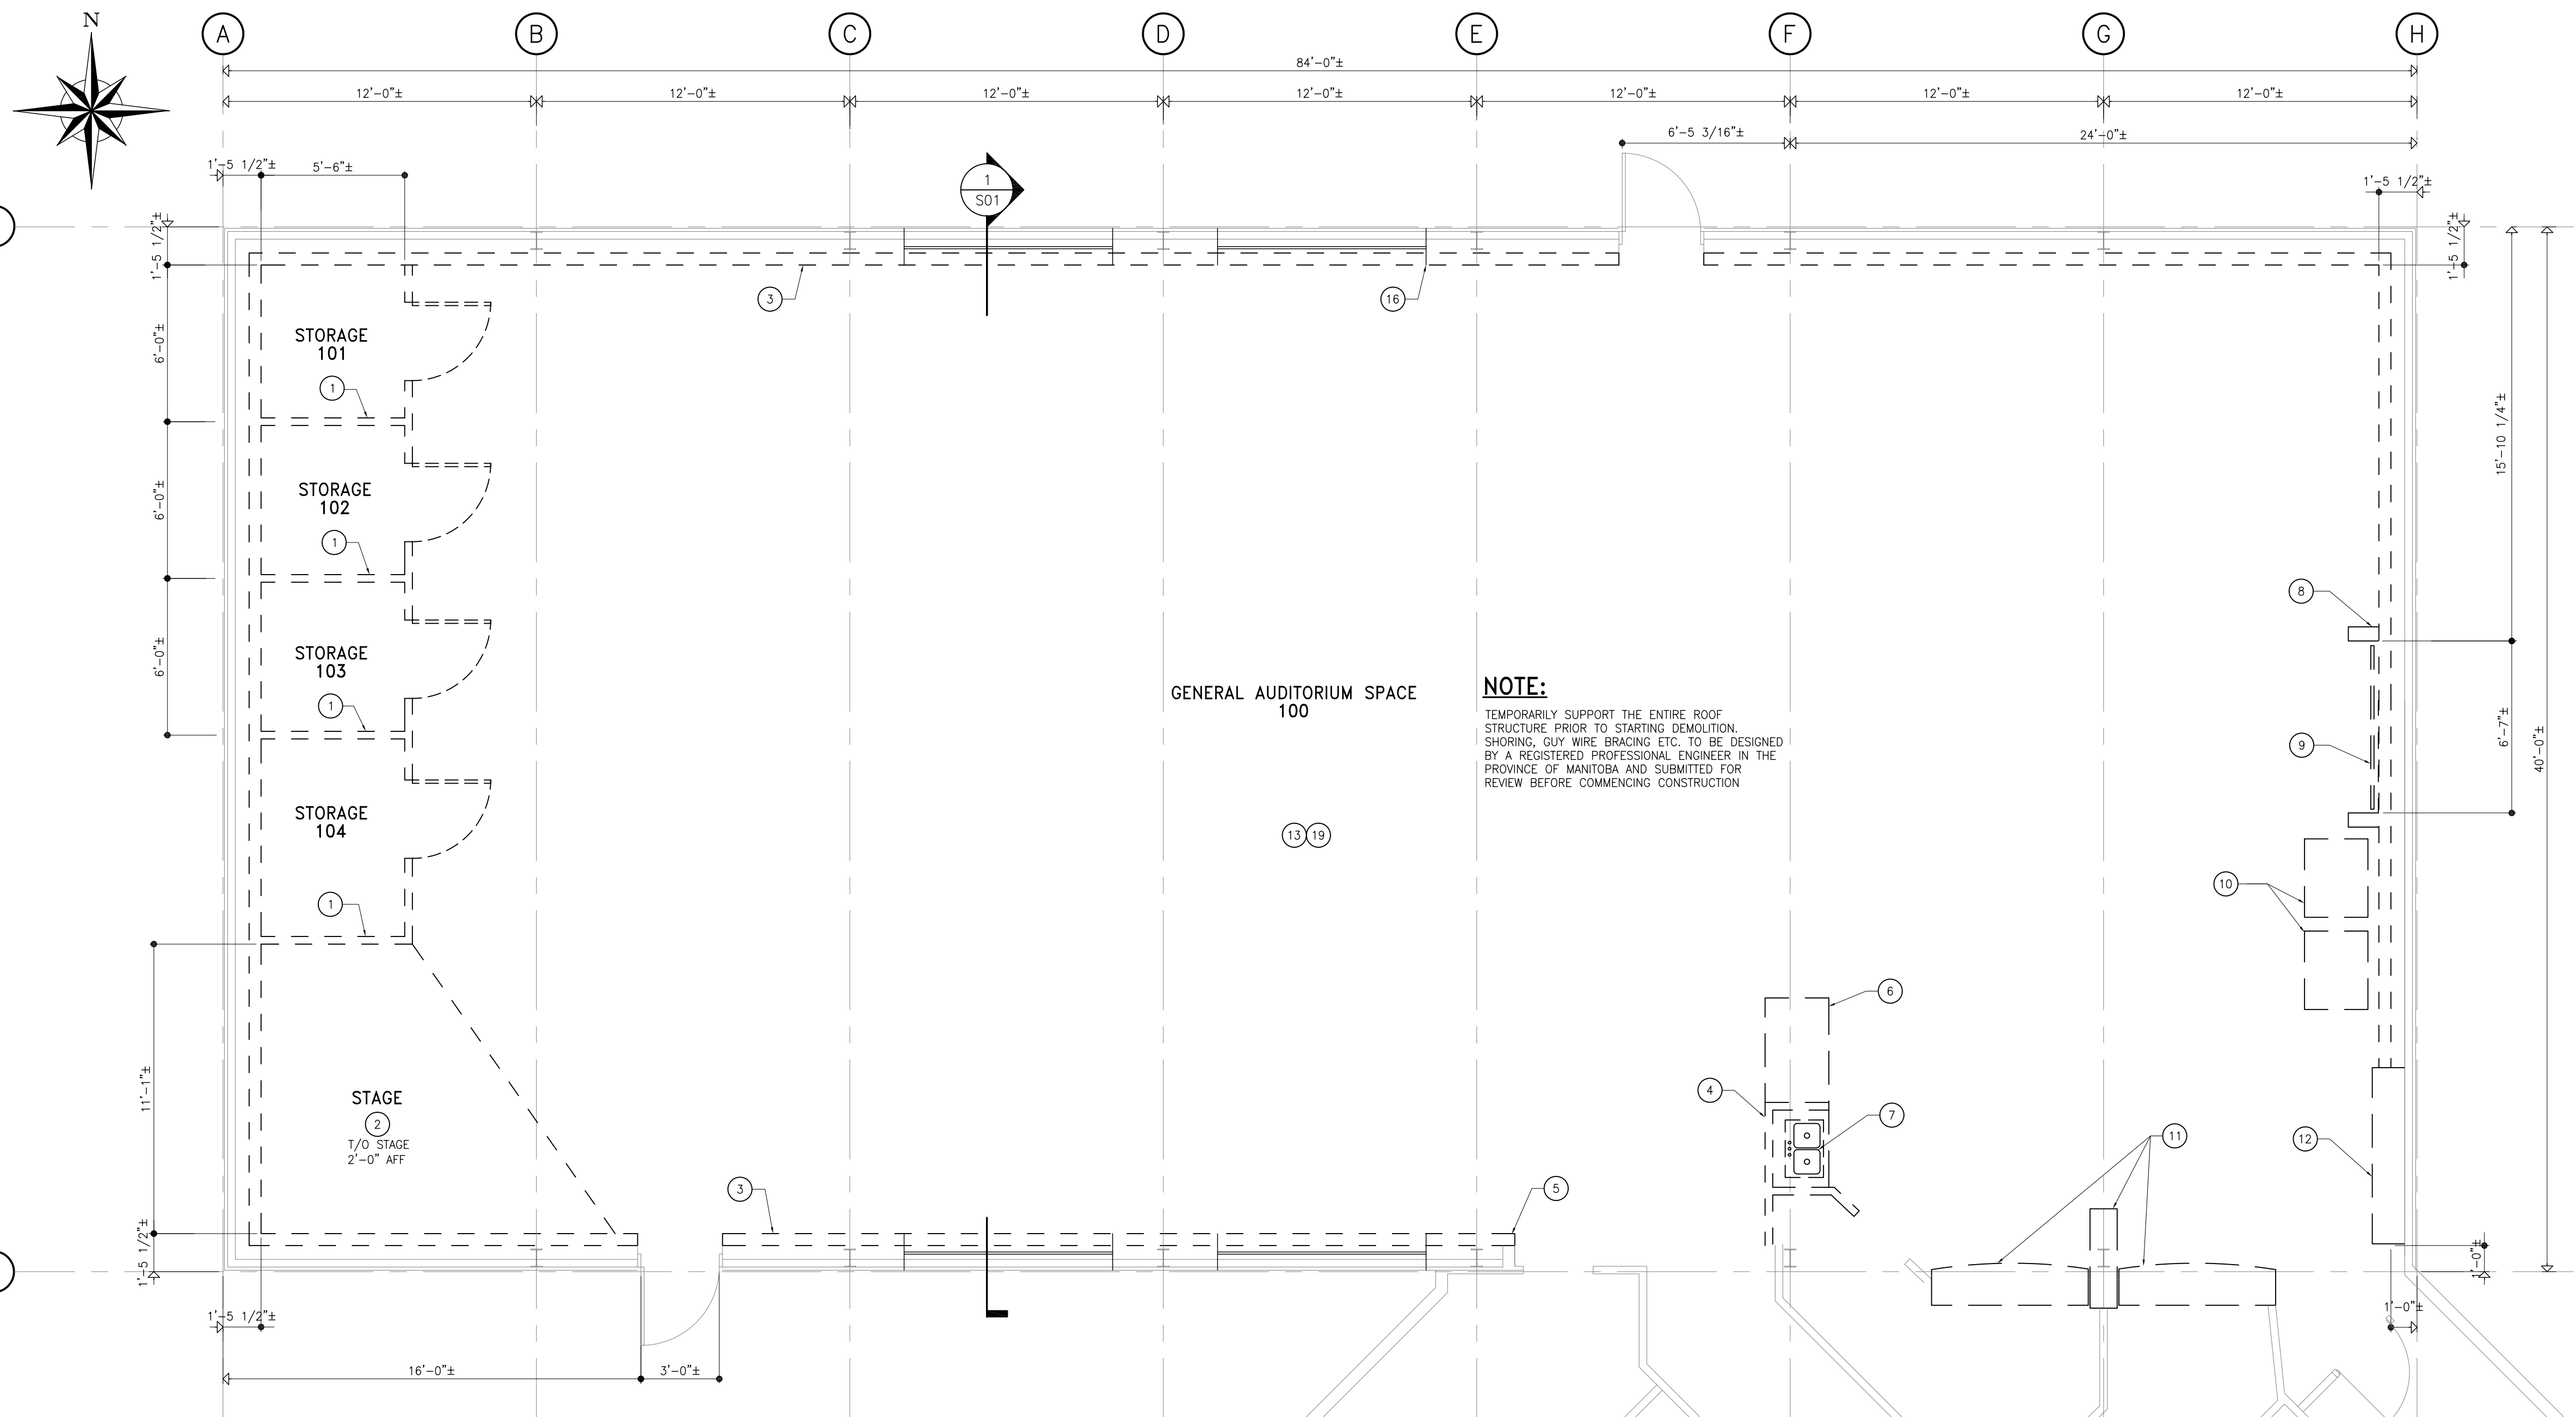


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**NOTE:**  
TEMPORARILY SUPPORT THE ENTIRE ROOF STRUCTURE PRIOR TO STARTING DEMOLITION SHORING, GUY WIRE BRACING ETC. TO BE DESIGNED BY A REGISTERED PROFESSIONAL ENGINEER IN THE PROVINCE OF MANITOBA AND SUBMITTED FOR REVIEW BEFORE COMMENCING CONSTRUCTION

- DEMOLITION KEYNOTES**
- 1 DEMOLISH ALL 4 (FOUR) STORAGE CLOSETS, SALVAGE EXISTING DOORS, FRAMES AND HARDWARE. TO BE RE USED IN NEW CONSTRUCTION
  - 2 DEMOLISH EXISTING ELEVATED WOOD STRUCTURED STAGE.
  - 3 REMOVE EXISTING 4'X8' MDF WALL PANELS, AND RUBBER BASE AROUND THE PERIMETER OF THE ROOM. DEMOLISH THE EXISTING 2X6 STUD WALL SYSTEM TO A HEIGHT OF 2'-0" A.F.F. TEMPORARILY SUPPORT EXISTING WALL DURING CONSTRUCTION. WALL PANELS ARE TO BE NUMBERED AND REINSTALLED ONCE CONSTRUCTION IS COMPLETE. REMOVE ALL WALL MOUNTED SIGNAGE, FIRE EXTINGUISHERS ETC AS REQUIRED TO FACILITATE CONSTRUCTION. REINSTALL ITEMS AFTER CONSTRUCTION IS COMPLETE
  - 4 DEMOLISH EXISTING STEEL STUD AND G.W.B. WALL.
  - 5 DEMOLISH EXISTING STEEL STUD AND G.W.B. WALL AT THIS LOCATION IN ORDER TO FACILITATE NEW CONSTRUCTION.
  - 6 REMOVE EXISTING MDF CABINET AND COUNTER MILLWORK. MILLWORK TO BE STORED AND REINSTALLED AFTER NEW FLOOR SLAB IS IN PLACE
  - 7 REMOVE EXISTING DOUBLE SINK AND COUNTER. TEMPORARILY CAP OFF WATER, PLUMBING, AND DRAINAGE LINES.
  - 8 EXISTING MDF PANEL TO BE REMOVED AND EXISTING BUILT UP STUD COLUMN SUPPORTING MECHANICAL UNIT TO BE DEMOLISHED TO A HEIGHT OF 2'-0" A.F.F.. TEMPORARY BRACING TO BE PROVIDED.
  - 9 EXISTING CONTRIBUTION RECOGNITION PLAQUES TO BE REMOVED AND REINSTALLED AFTER CONSTRUCTION IS COMPLETE
  - 10 EXISTING VENDING MACHINES TO BE REMOVED, STORED, AND RE-INSTALLED AFTER CONSTRUCTION
  - 11 REMOVE EXISTING COUNTER AND MILLWORK AND REINSTALL AFTER NEW FLOOR SLAB IS IN PLACE.
  - 12 DEMOLISH EXISTING PLYWOOD ELECTRICAL CLOSET.
  - 13 DEMOLISH EXISTING CONCRETE SLAB ON GRADE. EXCAVATE AND REMOVE GRANULAR FILL AND EARTH DOWN 2'-0" BELOW BOTTOM OF EXISTING SLAB. ENSURE BUILDING IS TEMPORARILY SUPPORTED BEFORE STARTING DEMOLITION.
  - 14 EXISTING STEEL STRUCTURE TO REMAIN. SUPPORT BUILDING FRAMES AS REQUIRED PRIOR TO DEMOLITION.
  - 15 REMOVE EXISTING 'T'-BAR' CEILING, AS REQUIRED TO COMPLETE WORK
  - 16 REMOVE EXISTING 2 1/4" WOOD WINDOW TRIM. TO BE REINSTALLED AFTER CONSTRUCTION COMPLETE. 4 (FOUR) WINDOWS
  - 17 EXISTING 1'-0" x 2'-0" DEEP CONCRETE GRADE BEAM TO BE DEMOLISHED TYP. ALL AROUND
  - 18 EXCAVATE AROUND EXTERIOR OF BUILDING TO EXPOSE CONCRETE BEAM. ALLOW FOR INSTALLATION OF WEeping TILE
  - 19 EXISTING VCT FLOOR TILES CONTAIN ASBESTOS. REMOVE ASBESTOS FLOOR TILES BEFORE DEMOLISHING THE CONCRETE SLAB. REMOVE THE TILES USING ASBESTOS REMOVAL PROCEDURE ACCEPTABLE TO THE CONTRACT ADMINISTRATOR AND IN ACCORDANCE WITH LOCAL REGULATIONS.

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**Accutech Engineering Inc.**  
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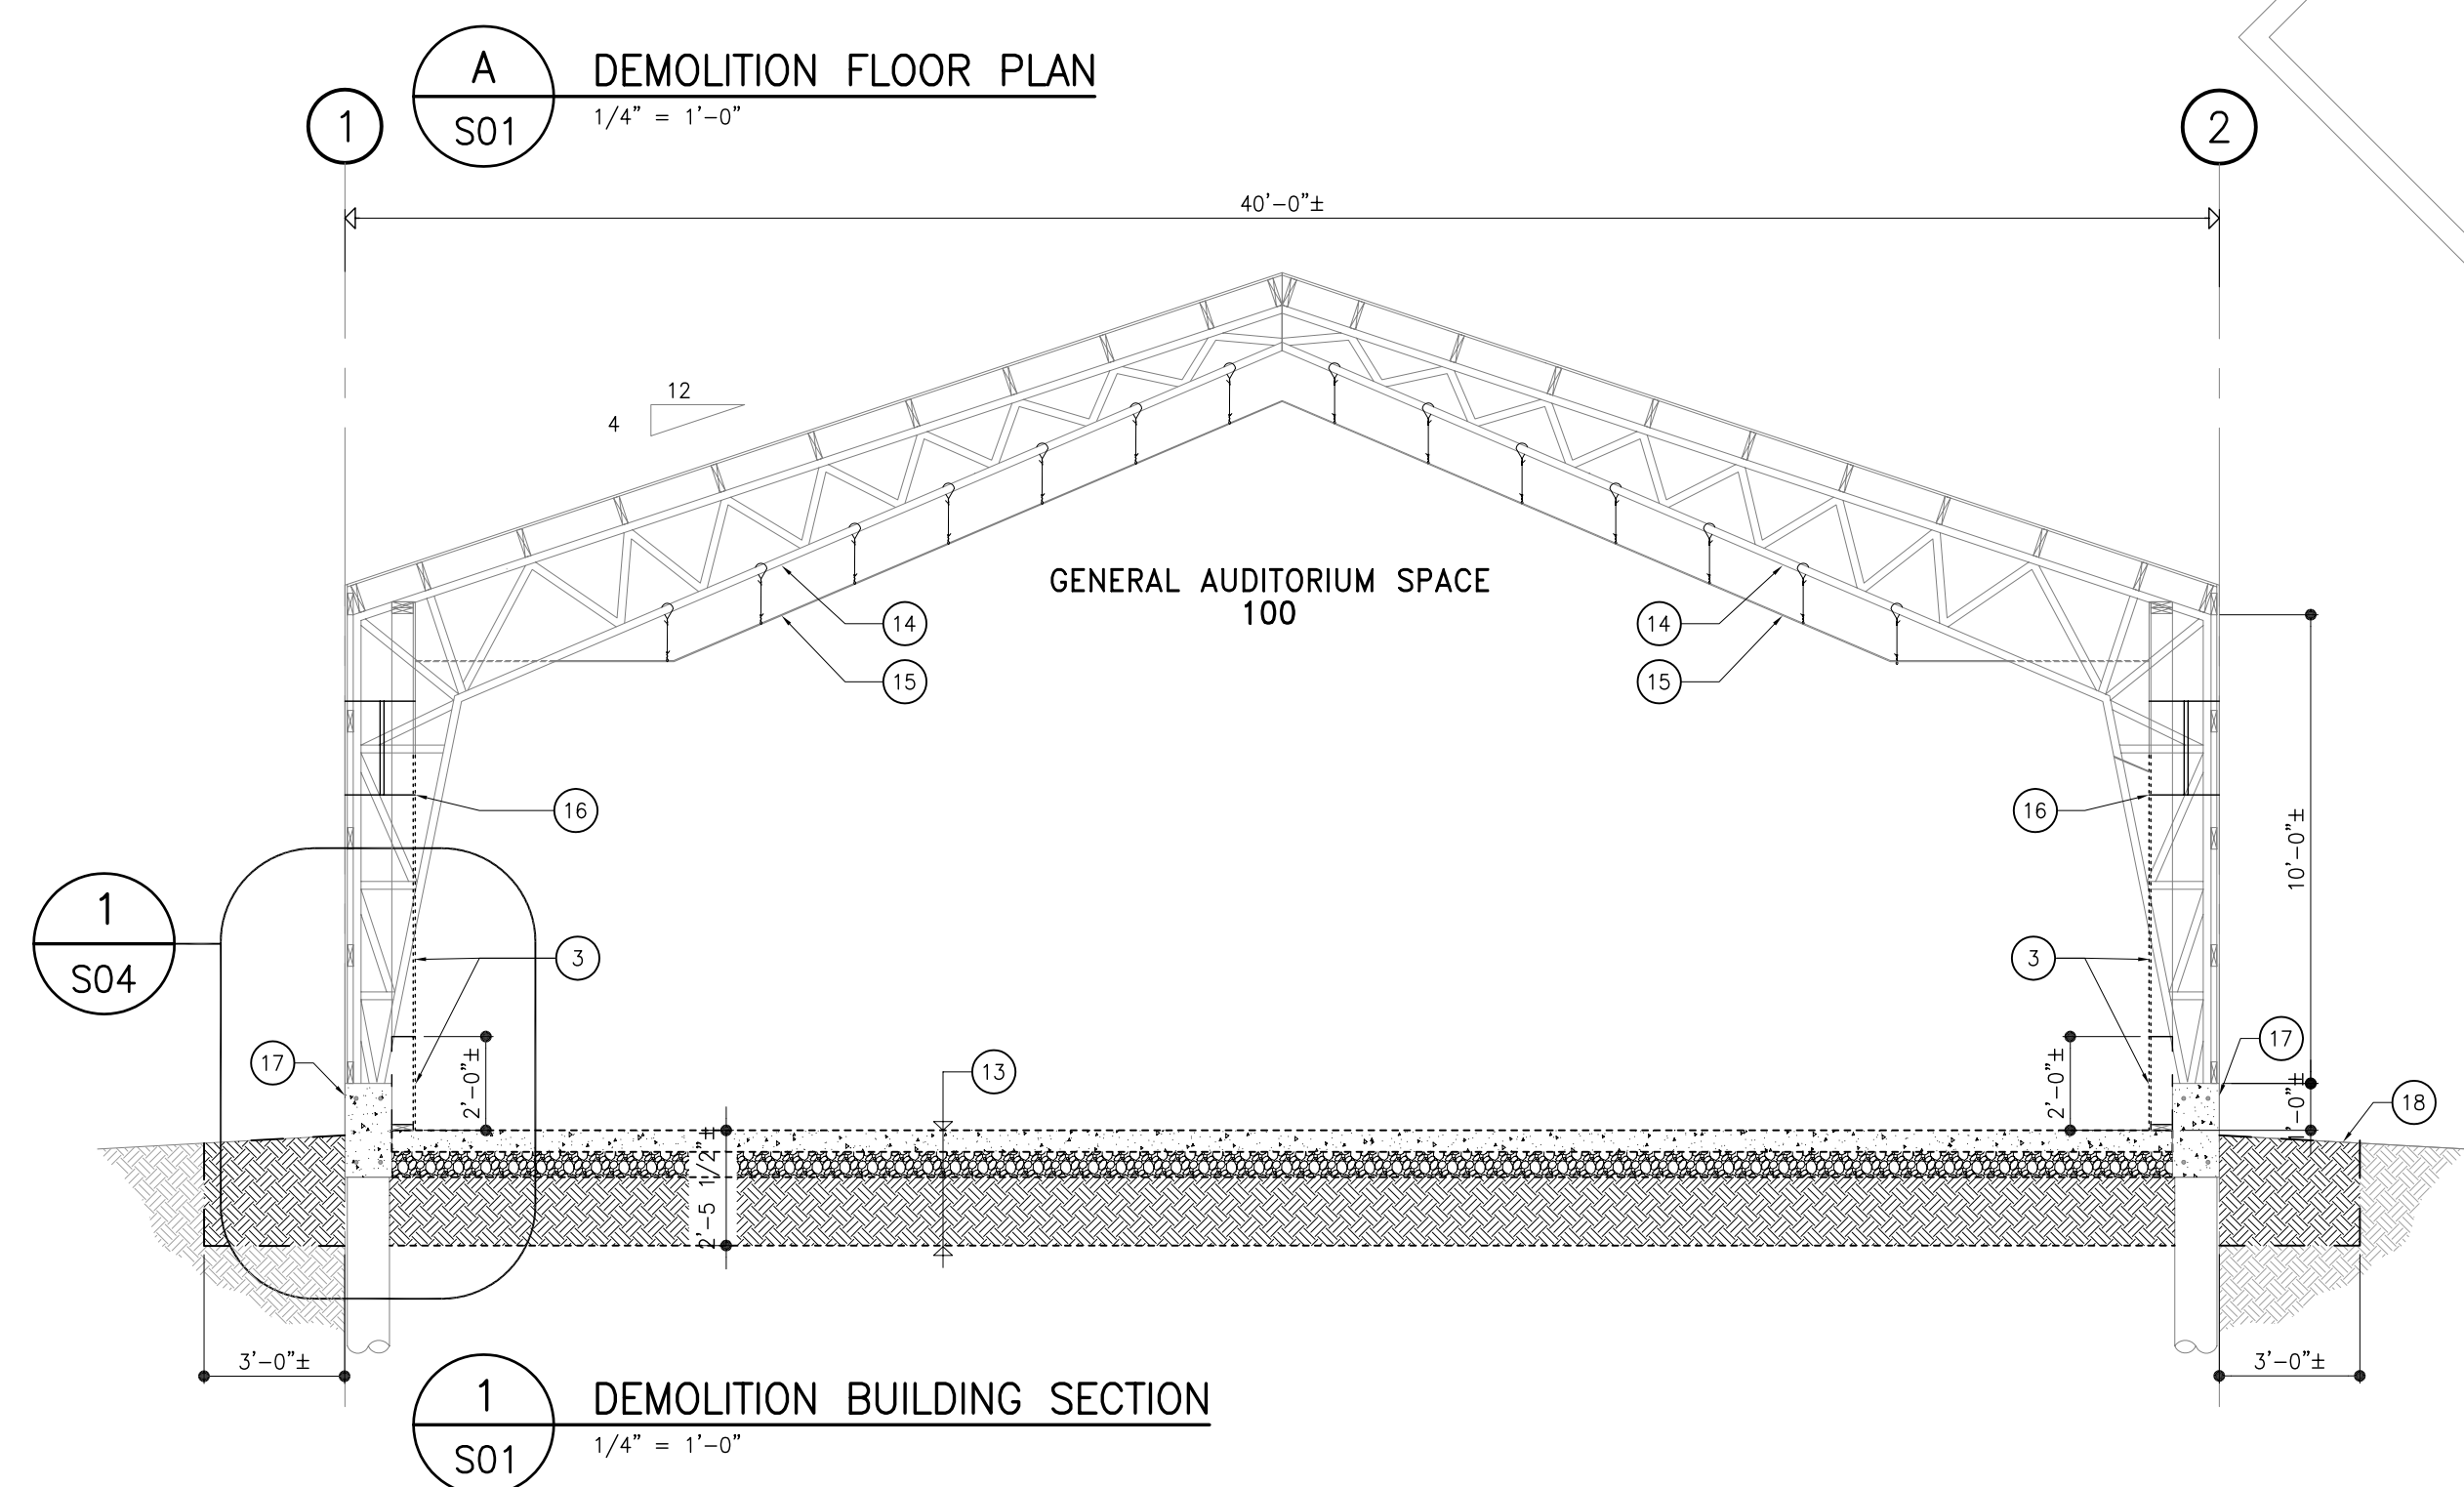
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**ASSINIBOIA WEST COMMUNITY CENTER**

861 BUCHANAN BOULEVARD  
STRUCTURAL REPAIRS  
DEMOLITION PLAN WITH BUILDING SECTION

DRAWN BY	RK	CHECKED BY	PG	DATE	JAN 8 2008	SHEET NO.	<b>S01</b>
DESIGNED BY	PG	CHECKED BY	PG	SCALE	AS SHOWN	REVISION NO.	1

**APEGM**  
Certificate of Authorization  
Accutech Engineering Inc.  
No. 1660 Date:



**A DEMOLITION FLOOR PLAN**  
S01 1/4" = 1'-0"

**1 DEMOLITION BUILDING SECTION**  
S01 1/4" = 1'-0"