
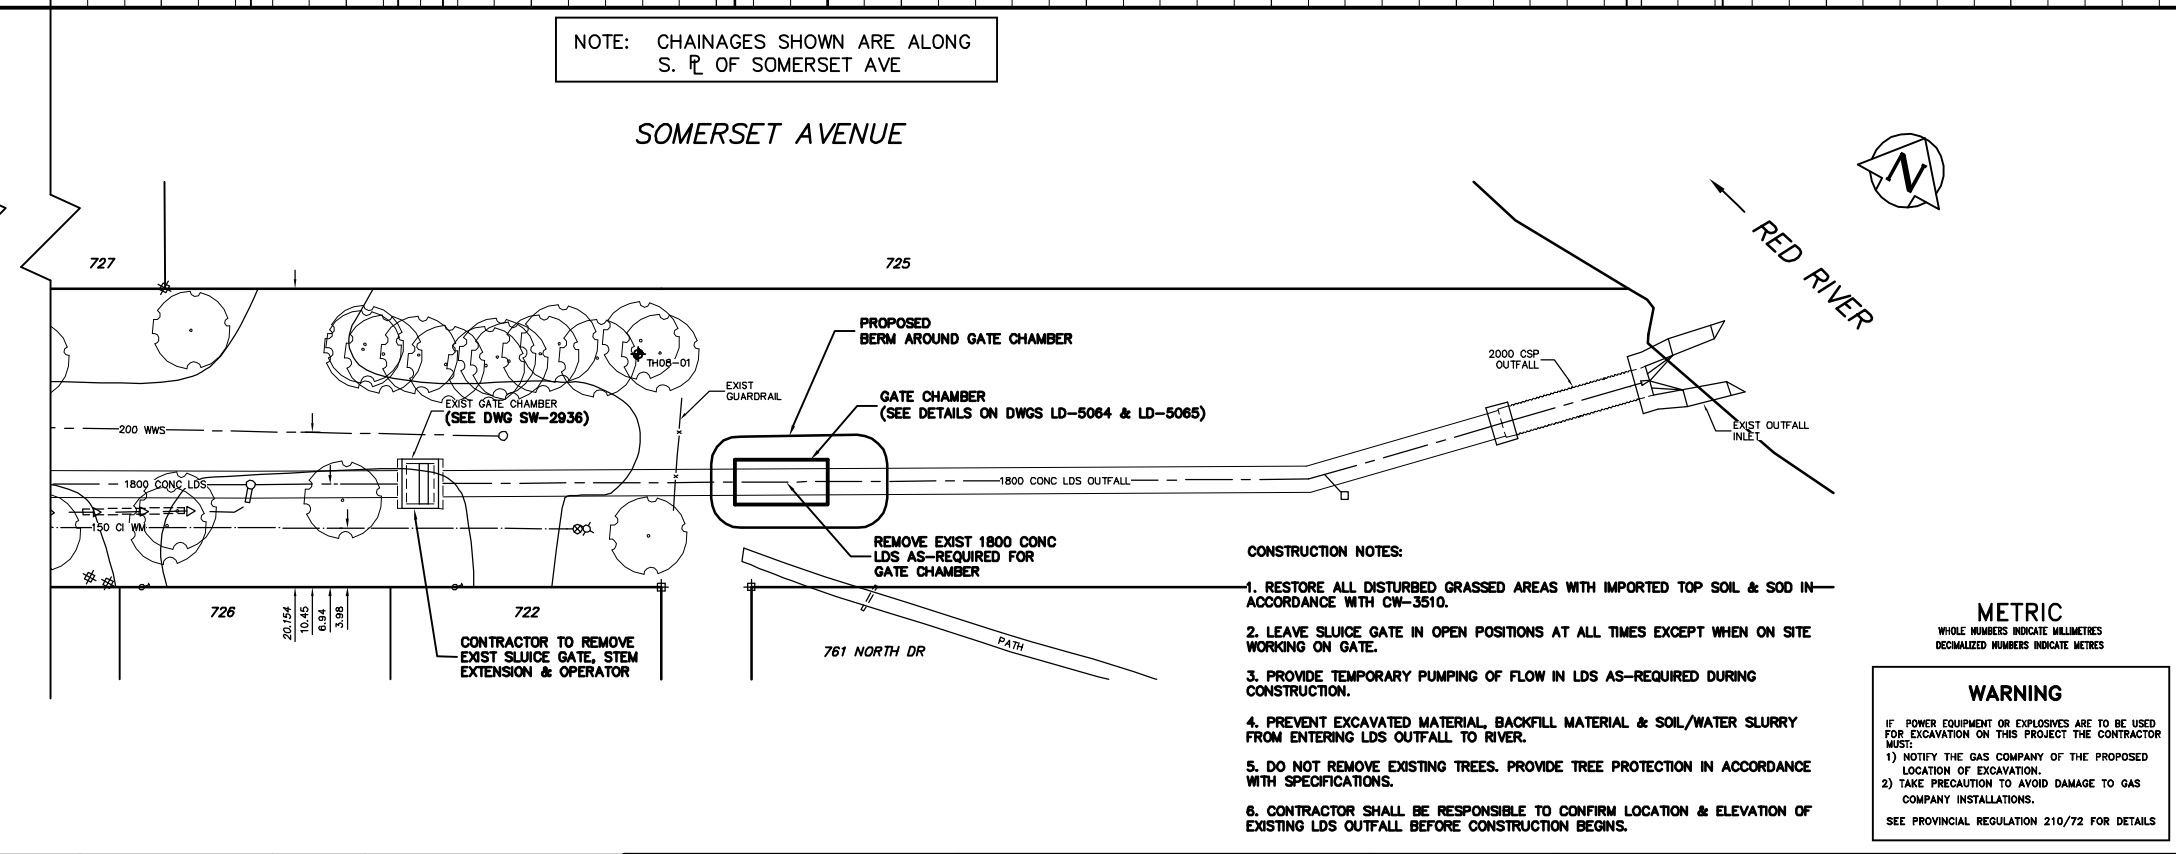


NOTE: CHAINAGES SHOWN ARE ALONG S. P. OF SOMERSET AVE

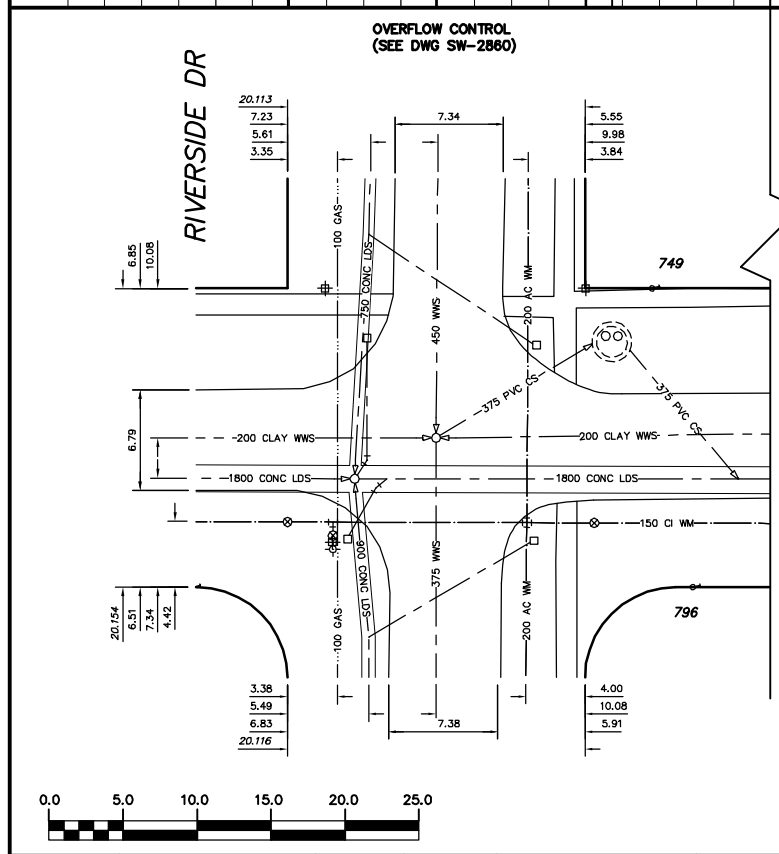

- CONSTRUCTION NOTES:
- RESTORE ALL DISTURBED GRASSED AREAS WITH IMPORTED TOP SOIL & SOD IN ACCORDANCE WITH CW-3510.
 - LEAVE SLUICE GATE IN OPEN POSITIONS AT ALL TIMES EXCEPT WHEN ON SITE WORKING ON GATE.
 - PROVIDE TEMPORARY PUMPING OF FLOW IN LDS AS-REQUIRED DURING CONSTRUCTION.
 - PREVENT EXCAVATED MATERIAL, BACKFILL MATERIAL & SOIL/WATER SLURRY FROM ENTERING LDS OUTFALL TO RIVER.
 - DO NOT REMOVE EXISTING TREES. PROVIDE TREE PROTECTION IN ACCORDANCE WITH SPECIFICATIONS.
 - CONTRACTOR SHALL BE RESPONSIBLE TO CONFIRM LOCATION & ELEVATION OF EXISTING LDS OUTFALL BEFORE CONSTRUCTION BEGINS.

METRIC
WHOLE NUMBERS INDICATE MILLIMETRES
DECIMALIZED NUMBERS INDICATE METRES

WARNING
IF POWER EQUIPMENT OR EXPLOSIVES ARE TO BE USED FOR EXCAVATION ON THIS PROJECT THE CONTRACTOR MUST:
1) NOTIFY THE GAS COMPANY OF THE PROPOSED LOCATION OF EXCAVATION.
2) TAKE PRECAUTION TO AVOID DAMAGE TO GAS COMPANY INSTALLATIONS.
SEE PROVINCIAL REGULATION 210/72 FOR DETAILS

200 WM	WATERMAIN	200 WM	SL, HYDRO	150 WM	WATERMAIN	150 WM
⊕	HYDRANT	⊕	MTS	+	HYDRANT	+
⊙	VALVE	⊙	TRAFFIC SIGNALS	⊗	VALVE	⊗
525 LDS	LAND DRAINAGE SEWER	525 LDS	GAS	50 GAS	300 LDS	LAND DRAINAGE SEWER
375 WWS	WASTEWATER SEWER	375 WWS	SURVEY BAR	250 WWS	250 WWS	WASTEWATER SEWER
○	MANHOLE	●	FENCE	⊖	⊖	PROFILE
□	CATCH BASIN	■	POLE - HYDRO, MTS	=====	=====	GROUND ABOVE PIPE
▽	CURB INLET	◊	CURB STOP	△	△	? DITCH (NORTH & WEST)
+	JUNCTIONS	+	GUY ANCHOR	▽	▽	? DITCH (SOUTH & EAST)
—	CULVERT	—	LIGHT STANDARD	□	□	GUTTER (NORTH & WEST)
⊖	ANODE	⊖	TREE	○	○	GUTTER (SOUTH & EAST)
EXISTING	LEGEND-PLAN	PROPOSED	EXISTING	LEGEND-PLAN	PROPOSED	EXISTING
EXISTING	LEGEND-PROFILE	PROPOSED	EXISTING	LEGEND-PROFILE	PROPOSED	EXISTING

LOCATION APPROVED
UNDERGROUND STRUCTURES

SUPV. U/G STRUCTURES COMMITTEE DATE

NOTE:
LOCATION OF UNDERGROUND STRUCTURES AS SHOWN ARE BASED ON THE BEST INFORMATION AVAILABLE BUT NO GUARANTEE IS GIVEN THAT ALL EXISTING UTILITIES ARE SHOWN OR THAT THE GIVEN LOCATIONS ARE EXACT. CONFIRMATION OF EXISTENCE AND EXACT LOCATION OF ALL SERVICES MUST BE OBTAINED FROM THE INDIVIDUAL UTILITIES BEFORE PROCEEDING WITH CONSTRUCTION.

B.M. ELEV. FIELD BOOK #:

POSTED TO LISB

NO. REVISIONS DATE BY

CITY OF WINNIPEG
WATER AND WASTE
ENGINEERING DIVISION

DESIGNED BY DGS CHECKED BY SC
DRAWN BY C.J.H. APPROVED BY SC

HOR. SCALE 1:250
VERTICAL 1:50

RELEASED FOR CONSTRUCTION

DATE 2008 08 26

ENGINEER'S SEAL
ORIGINAL SIGNED BY S.R.J. COURNOYER 08/08/26

FILENAME: LD-5063.dwg
PLOT DATE: 2008 08 26

THE CITY OF WINNIPEG
WATER AND WASTE DEPARTMENT

2008 OUTFALL GATE CHAMBER
CONSTRUCTION AND UPGRADES
SOMERSET AVENUE
LDS OUTFALL GATE CHAMBER
SITE PLAN

SHEET 1 OF 11
CITY DRAWING NUMBER
LD-5063