


- CONSTRUCTION NOTES:**
1. RESTORE ALL DISTURBED GRASS AREAS & BERM WITH IMPORTED TOP SOIL AND SOO IN ACCORDANCE WITH CW 3510.
  2. LEAVE SLUICE VALVE IN OPEN POSITION AT ALL TIMES EXCEPT WHEN ON-SITE WORKING ON GATE.
  3. PROVIDE TEMPORARY PUMPING OF FLOW IN CS AS REQUIRED DURING CONSTRUCTION.
  4. PREVENT EXCAVATED MATERIAL, BACKFILL MATERIAL AND SOIL / WATER SLURRY FROM ENTERING LDS OUTFALL TO THE RIVER.
  5. DO NOT REMOVE EXISTING TREES. PROVIDE TREE PROTECTION IN ACCORDANCE WITH SPECIFICATIONS.
  6. CONFIRM LOCATION AND ELEVATION OF EXISTING CS BEFORE EXCAVATING FOR GATE CHAMBER.


NOTE: CHAINAGES SHOWN ARE ALONG E. P. OF CONWAY ST

CONWAY STREET

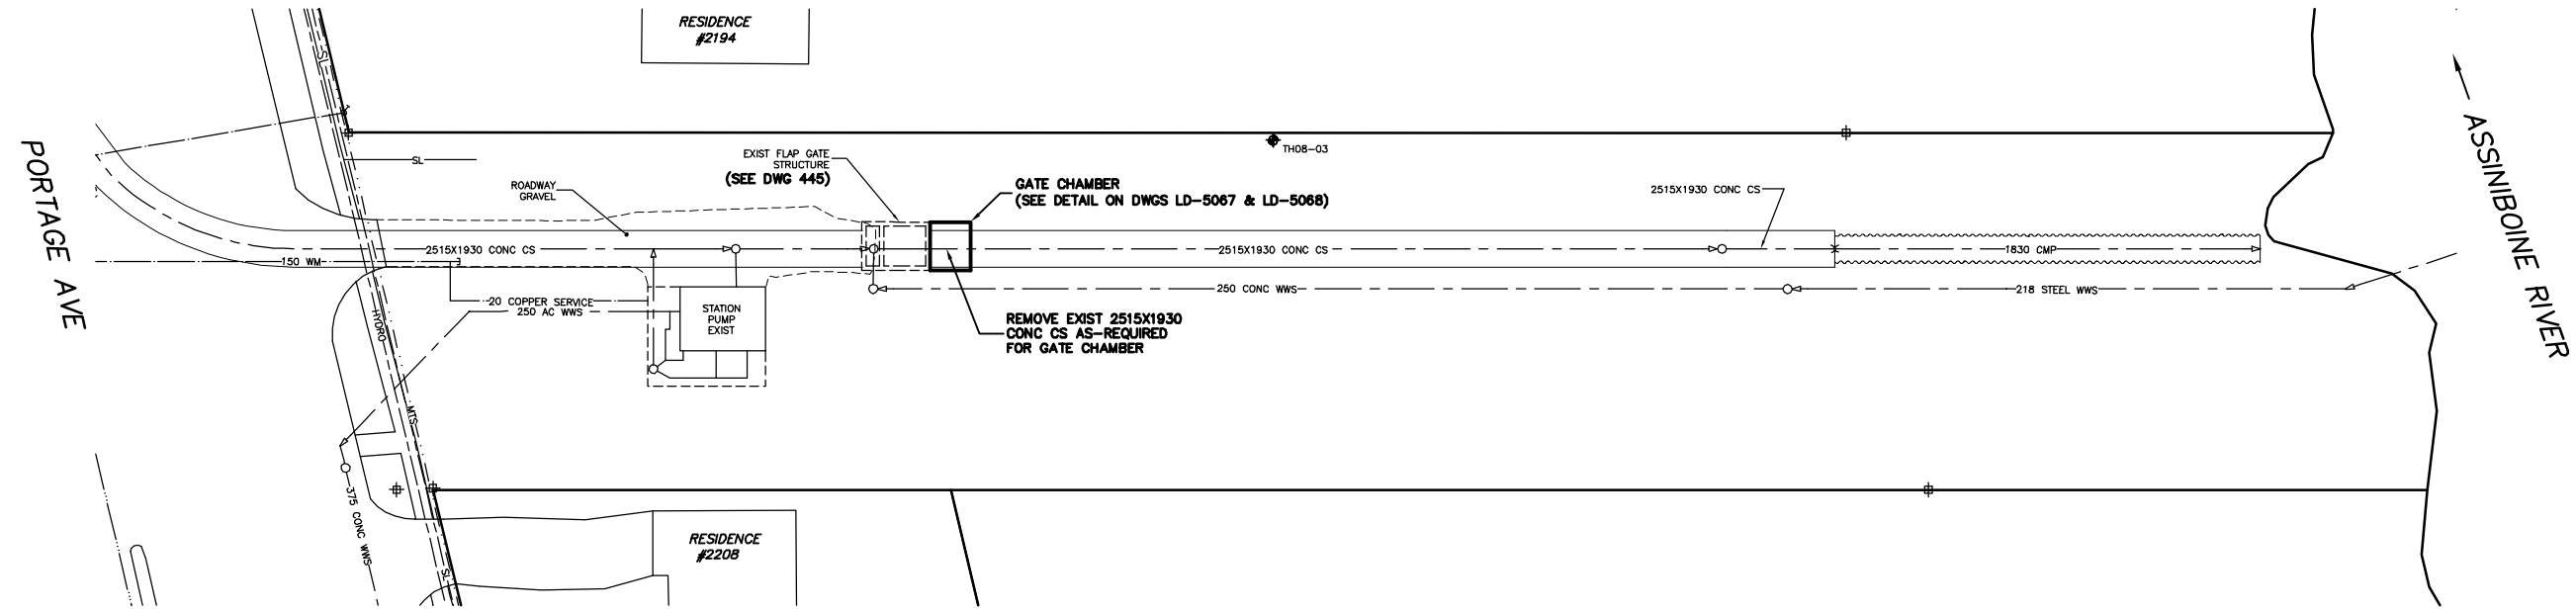

**METRIC**  
WHOLE NUMBERS INDICATE MILLIMETRES  
DECIMALIZED NUMBERS INDICATE METRES

**WARNING**  
IF POWER EQUIPMENT OR EXPLOSIVES ARE TO BE USED FOR EXCAVATION ON THIS PROJECT THE CONTRACTOR MUST:  
1) NOTIFY THE GAS COMPANY OF THE PROPOSED LOCATION OF EXCAVATION.  
2) TAKE PRECAUTION TO AVOID DAMAGE TO GAS COMPANY INSTALLATIONS.  
SEE PROVINCIAL REGULATION 210/72 FOR DETAILS

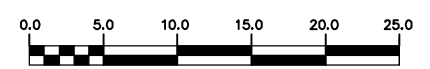

200 WM	WATERMAIN	200 WM	SL, HYDRO	150 WM	WATERMAIN	150 WM
⊕	HYDRANT	⊕	MTS	⊕	HYDRANT	⊕
⊙	VALVE	⊙	TRAFFIC SIGNALS	⊙	VALVE	⊙
525 LDS	LAND DRAINAGE SEWER	525 LDS	GAS	50 GAS	300 LDS	LAND DRAINAGE SEWER
375 WWS	WASTEWATER SEWER	375 WWS	SURVEY BAR	250 WWS	250 WWS	WASTEWATER SEWER
○	MANHOLE	●	FENCE	⊗	⊗	PROFILE
□	CATCH BASIN	■	POLE - HYDRO, MTS	⊘	⊘	GROUND ABOVE PIPE
▽	CURB INLET	◊	CURB STOP	⊙	⊙	? DITCH (NORTH & WEST)
⊕	JUNCTIONS	⊕	GUY ANCHOR	⊕	⊕	? DITCH (SOUTH & EAST)
⊕	CULVERT	⊕	LIGHT STANDARD	⊕	⊕	GUTTER (NORTH & WEST)
⊕	ANODE	⊕	TREE	⊕	⊕	GUTTER (SOUTH & EAST)
EXISTING	LEGEND-PLAN	PROPOSED	EXISTING	LEGEND-PLAN	PROPOSED	EXISTING
EXISTING	LEGEND-PROFILE	PROPOSED	EXISTING	LEGEND-PROFILE	PROPOSED	EXISTING

LOCATION APPROVED  
UNDERGROUND STRUCTURES

SUPV. U/G STRUCTURES COMMITTEE DATE

NOTE:  
LOCATION OF UNDERGROUND STRUCTURES AS SHOWN ARE BASED ON THE BEST INFORMATION AVAILABLE BUT NO GUARANTEE IS GIVEN THAT ALL EXISTING UTILITIES ARE SHOWN OR THAT THE GIVEN LOCATIONS ARE EXACT. CONFIRMATION OF EXISTENCE AND EXACT LOCATION OF ALL SERVICES MUST BE OBTAINED FROM THE INDIVIDUAL UTILITIES BEFORE PROCEEDING WITH CONSTRUCTION.

B.M. ELEV. FIELD BOOK #

POSTED TO LBS

NO. REVISIONS DATE BY

**CITY OF WINNIPEG**  
**WATER AND WASTE**  
**ENGINEERING DIVISION**

DESIGNED BY: DGS  
CHECKED BY: SC

DRAWN BY: WKT/CJH  
APPROVED BY: SC

HOR. SCALE: 1:250  
VERTICAL: 1:50

DATE: 2008 08 26

ENGINEER'S SEAL

ORIGINAL SIGNED  
BY S.R.J.  
COURNOYER  
08/08/26

BID OPPORTUNITY: 629-2008  
FILENAME: LD-5066.dwg  
PLOT DATE: 2008 08 26

**THE CITY OF WINNIPEG**  
WATER AND WASTE DEPARTMENT

2008 OUTFALL GATE CHAMBER  
CONSTRUCTION AND UPGRADES  
**CONWAY STREET**  
CS OUTFALL GATE CHAMBER  
SITE PLAN

SHEET 4 OF 11  
CITY DRAWING NUMBER  
LD-5066