


KENASTON BOULEVARD

CONSTRUCT EMBANKMENTS FOR FUTURE OVERPASS

AREA TO BE CONSTRUCTED PRIOR TO BEGINNING A2 ROAD WORKS AND SWITCH TRAFFIC ONTO NEW DETOUR

AREA A

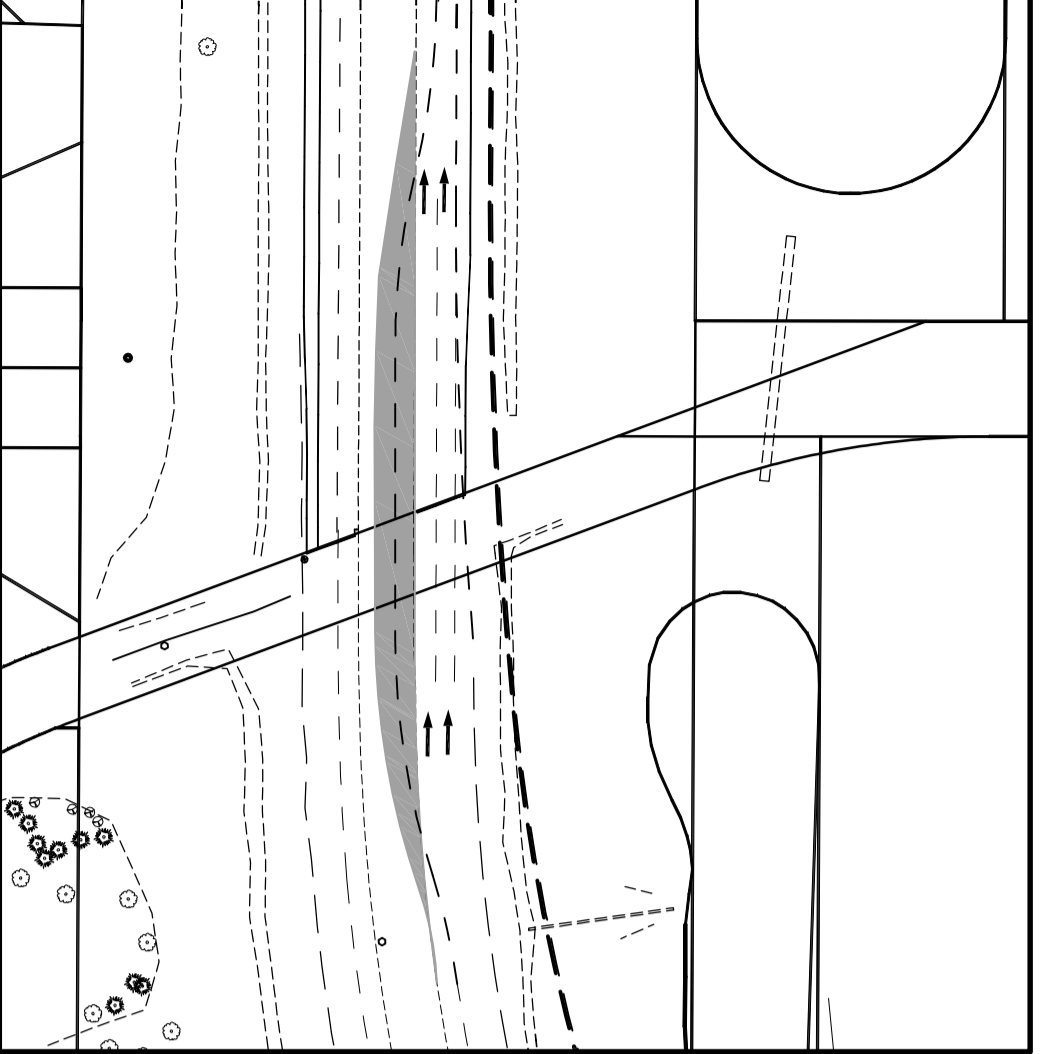

PHASE 1A TO BE CONSTRUCTED PRIOR TO PHASE 1

AREA A

TRAFFIC IS ON THIS CONFIGURATION UNTIL BEGINING CONSTRUCTION OF BOX CULVERT

LEGEND

- ← TRAFFIC FLOW DIRECTION
- CONSTRUCTION AREA
- ▨ TEMPORARY CONSTRUCTION AREA
- TEMPORARY TRAFFIC CONES

KENASTON BOULEVARD

BISHOP GRANDIN BOULEVARD

WARNING

IF POWER EQUIPMENT OR EXPLOSIVES ARE TO BE USED FOR EXCAVATION ON THIS PROJECT THE CONTRACTOR MUST:


- 1) NOTIFY THE GAS COMPANY OF THE PROPOSED LOCATION OF EXCAVATION.
- 2) TAKE PRECAUTION TO AVOID DAMAGE TO GAS COMPANY INSTALLATIONS.

SEE PROVINCIAL REGULATION 140/92 FOR DETAILS

METRIC

WHOLE NUMBERS INDICATE MILLIMETRES  
DECIMALIZED NUMBERS INDICATE METRES

PERFORM OVER-BURDEN EXCAVATION AND ALLOW FOR A PERIOD TO MONITOR REBOUND

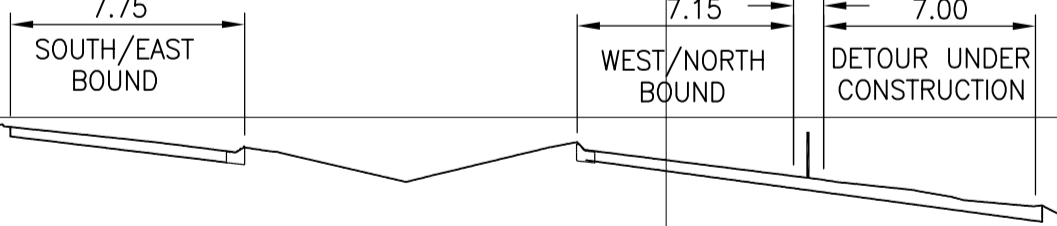

SECTION 1:250H 1:125V



**APEGM**  
Certificate of Authorization  
Stantec Consulting Ltd.  
No. 1301 Date: \_\_\_\_\_

84R635 - Lake Crest Rd. & Waverley St.,  
Tbt on top of 0.05m dia. x 2.4m iron pipe, 14.2m N. of S.L. of Lake Crest Rd. & 0.6m E. of E.L. of Waverley St.

150 WM	WATERMAIN	150 WM	HYDRO	150 WM	WATERMAIN	150 WM
+	HYDRANT	+	M.T.S.	+	HYDRANT, VALVE	+
+	VALVE	+	CONCRETE	+	LAND DRAINAGE SEWER	+
300 LDS	LAND DRAINAGE SEWER	300 LDS	ASPHALT	250 WWS	WASTE WATER SEWER	250 WWS
250 WWS	WASTE WATER SEWER	250 WWS	SIDEWALK	×	PROFILE	×
○	MANHOLE	○	PROPERTY LINE	□	NORTH OR WEST GUTTER	□
□	CATCH BASIN	□	SURVEY BAR	○	SOUTH OR EAST GUTTER	○
▽	CURB INLET	▽	GEODETIC BENCHMARK	◇	NORTH OR WEST DITCH	◇
→	JUNCTIONS	→	DITCH	○	SOUTH OR EAST DITCH	○
—	CULVERT	(31.334)	ELEVATION	△	NORTH OR WEST DITCH	△
—	GAS	—	SIDEWALK RAMP	▽	SOUTH OR EAST DITCH	▽
EXISTING	LEGEND-PLAN	PROPOSED	EXISTING	LEGEND-PLAN	PROPOSED	EXISTING

LOCATION APPROVED UNDERGROUND STRUCTURES

SUPV. U/G STRUCTURES COMMITTEE DATE

NOTE:  
LOCATION OF UNDERGROUND STRUCTURES AS SHOWN ARE BASED ON THE BEST INFORMATION AVAILABLE BUT NO GUARANTEE IS GIVEN THAT ALL EXISTING UTILITIES ARE SHOWN OR THAT THE GIVEN LOCATIONS ARE EXACT. CONFIRMATION OF EXISTENCE AND EXACT LOCATION OF ALL SERVICES MUST BE OBTAINED FROM THE INDIVIDUAL UTILITIES BEFORE PROCEEDING WITH CONSTRUCTION.

B.M. 84R635	ELEV. 232.457m		
0	ISSUED FOR TENDER	11.07.15	V.M.M.
NO.	REVISIONS	DATE	BY

**Stantec Consulting Ltd.**  
905 Waverley Street, Winnipeg, Manitoba  
Tel 204-489-5900 Fax 204-453-9012

DESIGNED BY: R.P.K., S.R.S. CHECKED BY: V.M.M.  
DRAWN BY: T.G. APPROVED BY: \_\_\_\_\_  
HOR. SCALE: 1:1500 RELEASED FOR CONSTRUCTION: \_\_\_\_\_  
VERTICAL: \_\_\_\_\_ DATE: 11.04.28

ENGINEER'S SEAL  
PROVINCE OF MANITOBA  
REGISTERED PROFESSIONAL ENGINEER  
V.M. MAROTI  
MEMBER 30809  
CONSULTANT DRAWING NO. C-130

**THE CITY OF WINNIPEG**  
PUBLIC WORKS DEPARTMENT  
ENGINEERING DIVISION

**WWARP PART I**  
KENASTON BOULEVARD EXTENSION - N.B. LANES  
NORTH TOWN ROAD TO BISHOP GRANDIN BOULEVARD  
SITE PLAN  
CONSTRUCTION PHASING - PHASE I

SHEET 8 OF 65  
CAD FILE DRAWING NUMBER 04840c-130-XXX.dwg  
CITY DRAWING NUMBER P-3316-08

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