


DEMOLITION NOTES:

- (A) DEMOLISH EXISTING STOP SWITCHES AND ASSOCIATED CABLING AND CONDUIT.
- (B) PROVIDE DEMOLITION OF EXISTING RECEPTACLES INCLUDING CABLING, CONDUIT, JUNCTION BOXES AND SUPPORTS. REMOVE CABLING AND CONDUIT BACK TO SOURCE PANEL.
- (C) DEMOLISH EXISTING FLOAT SWITCH AND WIRING. MAINTAIN OPERATION UNTIL L533-LSH IS IN SERVICE.


CONSTRUCTION NOTES:

- (1) INSTALL NEW EMERGENCY STOP SWITCHES.
- (2) INSTALL A NEW FLYGT BALL FLOOD SENSOR.
- (3) INSTALL NEW GFI RECEPTACLES.

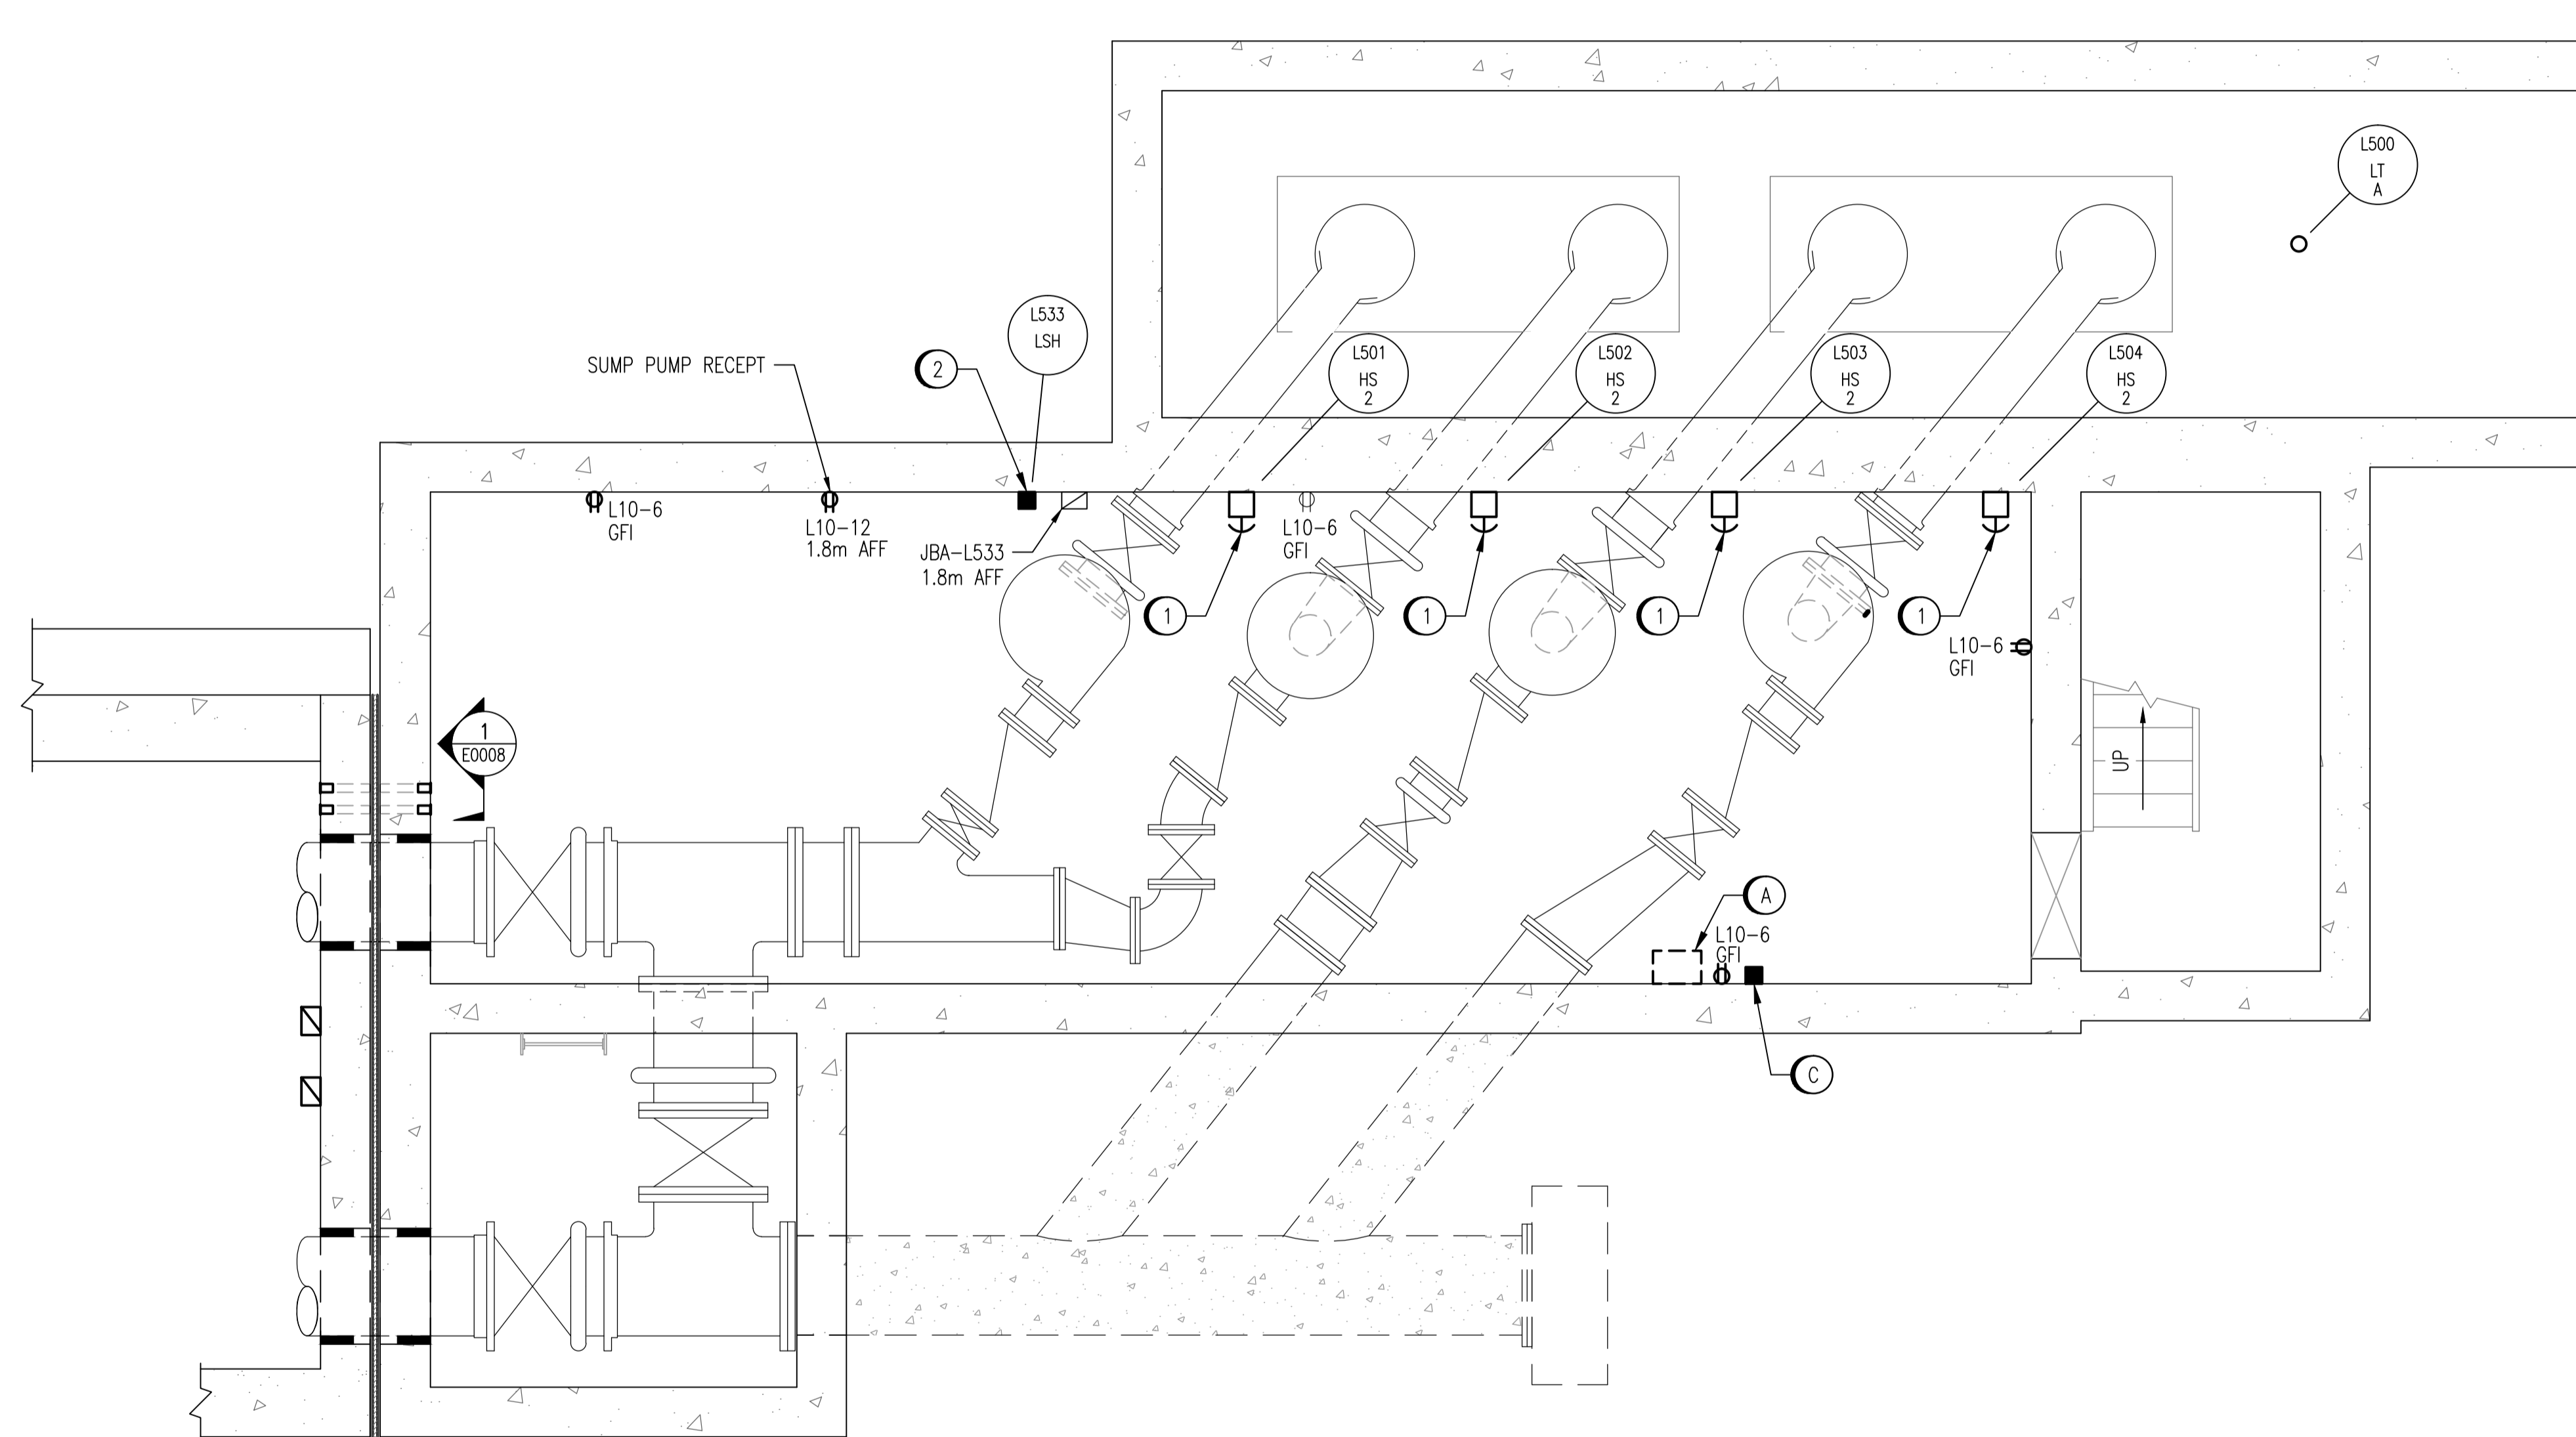

PUMP ROOM PLAN - ELEV. 220.443  
SCALE: 1 : 30

1-0164L-E0016	ELECTRICAL SCHEDULES
DRAWING NUMBER	REFERENCE DRAWINGS

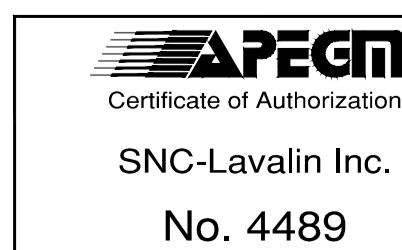

NO.	REVISIONS	DATE	DESIGN	CHECK
00	ISSUED FOR TENDER, BID OPP. 907-2011	2012/02/09	VE	CJR

SNC-LAVALIN INC. 148 Nature Park Way Winnipeg, MB, Canada R3P 0X7 204-796-8080	
DESIGNED BY: V. ELIMBAN	CHECKED BY: C. REIMER
DRAWN BY: M.J. PERSSON	APPROVED BY: C. REIMER
SCALE: 1:30	RELEASED FOR CONSTRUCTION BY: K. R. ZUREK DATE: 2012/02/23
DATE: 2011/09/22	DATE: 2012/02/23
CONSULTANT NO.: 508042-0000-47DD-0007	

ENGINEER'S SEAL
ORIGINAL DRAWING SEALED BY: C. J. REIMER SNC-LAVALIN MEMBER #21968 2012/02/23 REV. 00

THE CITY OF WINNIPEG WATER AND WASTE DEPARTMENT			
MONTCALM WASTEWATER PUMPING STATION 2011 UPGRADES ELECTRICAL EQUIPMENT PLAN PUMP ROOM			
CITY DRAWING NUMBER	SHEET	REV.	SIZE
1-0164L-E0007	001	00	A1