

## **GENERAL NOTES:**

- 1. THIS DRAWING IS DIAGRAMMATICAL ONLY, DO NOT SCALE DRAWING, CONTRACTOR TO DETERMINE EXACT LOCATIONS AND SIZES ON SITE PRIOR TO DIS SITE PRIOR TO BID.
- 2. ALL NEW WORK TO BE COORDINATED WITH EXISTING AND NEW STRUCTURAL, MECHANICAL,
- 3. MINIMUM RAIN WATER LEADER SLOPE TO BE
- 4. EXISTING DDC CONTROL SYSTEM CONSISTS OF A JOHNSON CONTROL SYSTEM WITH DX9100 CONTROLLER. APPROXIMATE CONTROLLER LOCATION IS WITHIN THE BASEMENT ELECTRICAL ROOM. CONTRACTOR TO SITE CONFIRM EXACT EQUIPMENT TYPE AND LOCATION ON SITE PRIOR

## **DRAWING NOTES:**

- 1) NEW ESP-1 (ELEVATOR SUMP PUMP) LOCATED IN ELEVATOR SUMP PIT. REFER TO STRUCTURAL AND TO DETAIL 2/M1.0.
- (2) NEW OIL INTERCEPTOR PIT BY OTHERS. REFER TO ARCHITECTURAL AND STRUCTURAL AND REFER TO DETAIL 2/M1.0
- 3 NEW ANGLE DRAIN IN BOTTOM OF ELEVATOR SHAFT. COORDINATE WITH ELEVATOR SUBCONTRACTOR, REFER TO ARCHITECTURAL.
- 4 NEW SUMP PIT VENT LINE TO RISE AND RUN AT HIGH LEVEL TO NEAREST ADEQUATELY SIZED VENT RISER. DETERMINE EXACT LOCATION ON SITE PRIOR TO BID. SIZE VENT AS PER CODE BASED ON
- 5 500 SUMP PIT DISCHARGE LINE TO RUN AT HIGH LEVEL AND CONNECT INTO NEAREST ADEQUATELY SIZED SANITARY DRAIN LINE WITHIN EXISTING ICE PLANT. COORDINATE EXACT ROUTING ON SITE WITH ALL NEW AND EXISTING SYSTEMS.
- (6) NEW 5LB ABC FIRE EXTINGUISHER COMPLETE WITH MOUNTING BRACKET.
- (7) RWL TO SPLASH PAD. REFER TO ARCHITECTURAL.
- 8 SUMP PIT DISCHARGE PIPE TO RISE UP TO HIGH LEVEL. 9 NEW BASEBOARD HEATER. BY ELECTRICAL.
- 10 NEW 250X300 TRANSFER AIR DUCT AT LOW LEVEL, SUPPLY COMPLETE WITH GRILLE AND FIRE DAMPER. COORDINATE WITH ARCHITECTURAL AND ELEVATOR SUBCONTRACTOR.
- 11) WTSPP-1 (WEEPING TILE SUMP PUMP) LOCATED IN WEEPING TILE SUMP PIT. REFER TO STRUCTURAL, ARCHITECTURAL AND TO DETAIL 3/M1.0.
- 12 HIGH LEVEL SWITCH TO BE MAGNETROL MODEL T10-5104-020 OR FFYGT DRY CONTACT SWITCH MECHANISM WITH CABLE FLOATS AND CLAMPS MAGNETROL MODEL T10-5104-020, RUN AN APPROPRIATE CABLE TO THE NEAREST DDC CONTROL PANEL WITH AVAILABLE POINT. CONTRACTOR TO DETERMINE ALARM REQUIREMENTS WITH THE CONTRACT ADMINISTRATOR.
- (13) NEW HEATER BY ELECTRICAL.
- WEEPING TILE PIT DISCHARGE LINE TO CONNECT INTO THE TOP OF RAIN WATER LEADER PRIOR TO PENETRATING WALL.
- 15 NEW ACOUSTICALLY LINED TRANSFER AIR DUCT ABOVE DOOR COMPLETE WITH FIRE DAMPERS.
- 16) NEW CLEAN OUT FOR ELEVATOR SUMP PIT DISCHARGE LINE. ACCESS HATCH BY ARCHITECTURAL.

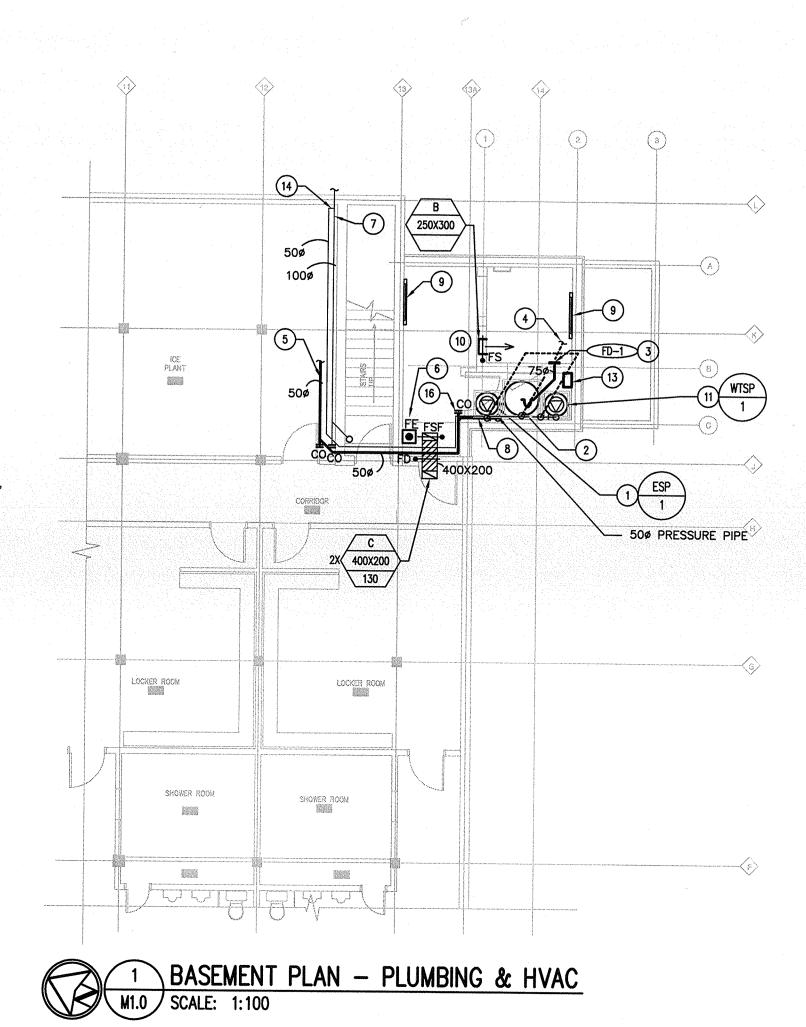


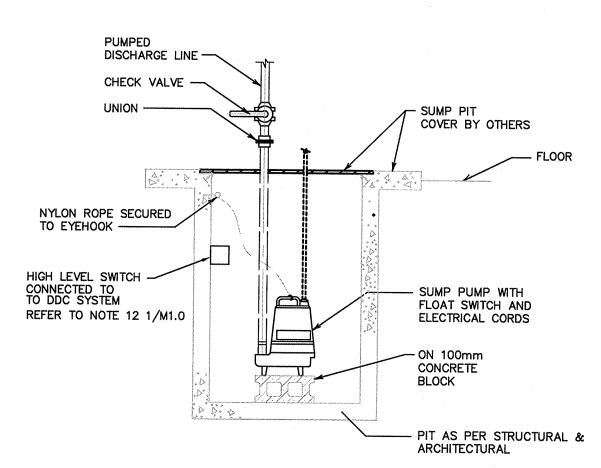


## WEEPING TILE SUMP PIT DETAIL M1.0 SCALE: NTS


## PUMP SCHEDULE


	LOCATION	MAKE	MODEL	PUMP SERVICE	PUMP TYPE	FLOW GPM (I/s)	FLUID TYPE	HEAD FT (PSI)	SPEED RPM	CONTR	TROLS			MCA		REMARKS
NO.										INTERLOCK		HP (kw)	FLA		МОСР	
	The second secon	Market Carlotte (Market								SUPPLY INSTALL	WITH			noni () () () () () () () () () () () () ()		
ESPP-1	ELEVATOR SUMP PIT	BELL & GOSSETT	2DES	ELEVATOR SUMP	SUBMERSIBLE/ EFFLUENT	50 (3.15)	SANITARY	35 (15)	3450			3/4 (0.56)	***************************************	***************************************		SUPPLY COMPLETE WITH FLOAT SWITCH, HIGH LEVEL SWITCH, AND ELECTRICAL CORD.  REFER TO 2/M1.0
WTSPP-1	WEEPING TILE SUMP PIT	BARNES	SPX-33	WEEPING TILE SUMP	SUBMERSIBLE/ EFFLUENT	13 (0.82)	DOMESTIC WATER	25 (11)	3450		——————————————————————————————————————	1/3 (0.25)				SUPPLY COMPLETE WITH FLOAT SWITCH, HIGH LEVEL SWITCH, AND ELECTRICAL CORD.  REFER TO 3/M1.0

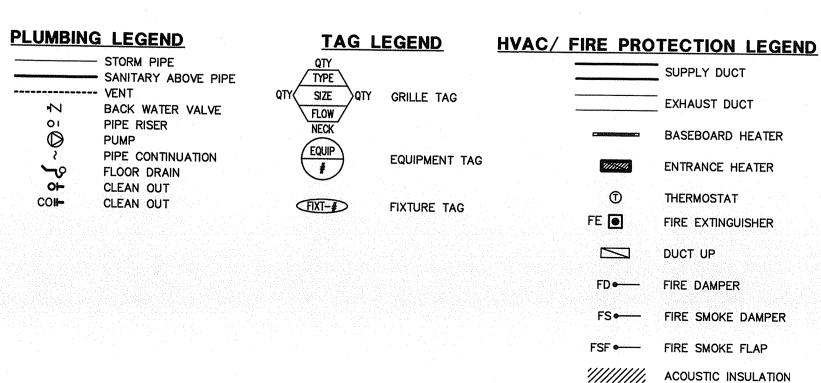


— — BALANCING DAMPER

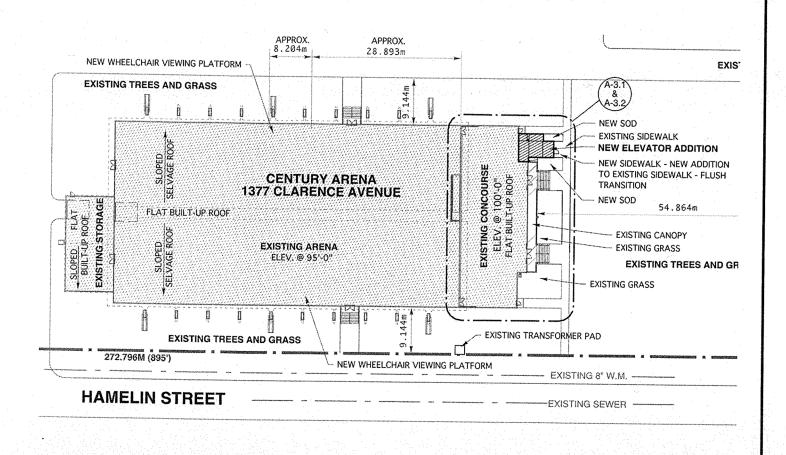

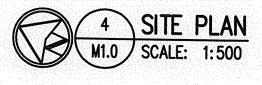

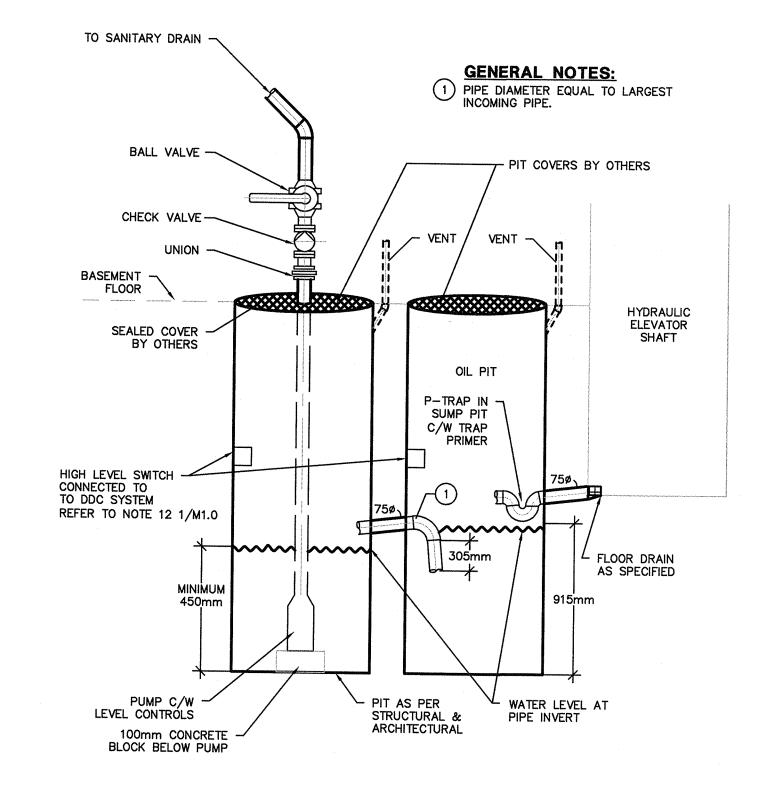

YELEVATOR SUMP PIT DETAIL M1.0 SCALE: NTS

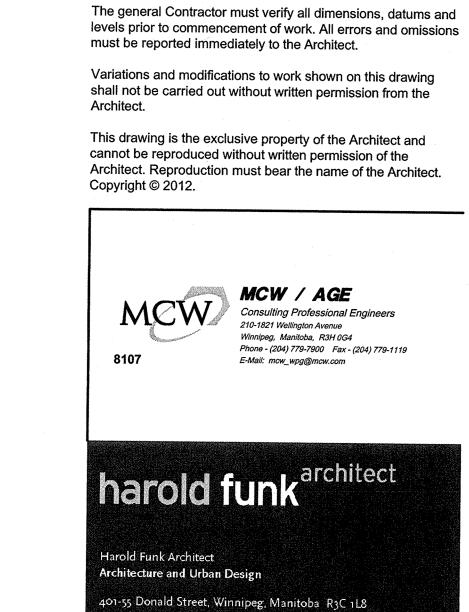

0. ISSUED FOR BID

This drawing must not be scaled.

2012-11-09

project

**ELEVATOR ADDITION AND** ACCESSIBILITY UPGRADES OF CENTURY ARENA Winnipeg, Manitoba Bid Opportunity No. 579-2012

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sheet title

**BASEMENT FLOOR** PLUMBING & HVAC RENOVATION

project number: 12-003 drawing number: M1.0C.DEB. drawn by: approved by: J.F. 2012-11-09

APEGII Certificate of Authorization MCW/AGE Consulting Professional Engineers No. 589 Expiry: April 30, 2013