


FILE NAME: 60280355-01-M-101-ROX.dwg
 DATE: 2012.12.14
 PROJECT No: 60280355
 SHEET TITLE: SITE PLAN
 ADDRESS: 219 PROVENCHER BOULEVARD

RUE DUMOULIN

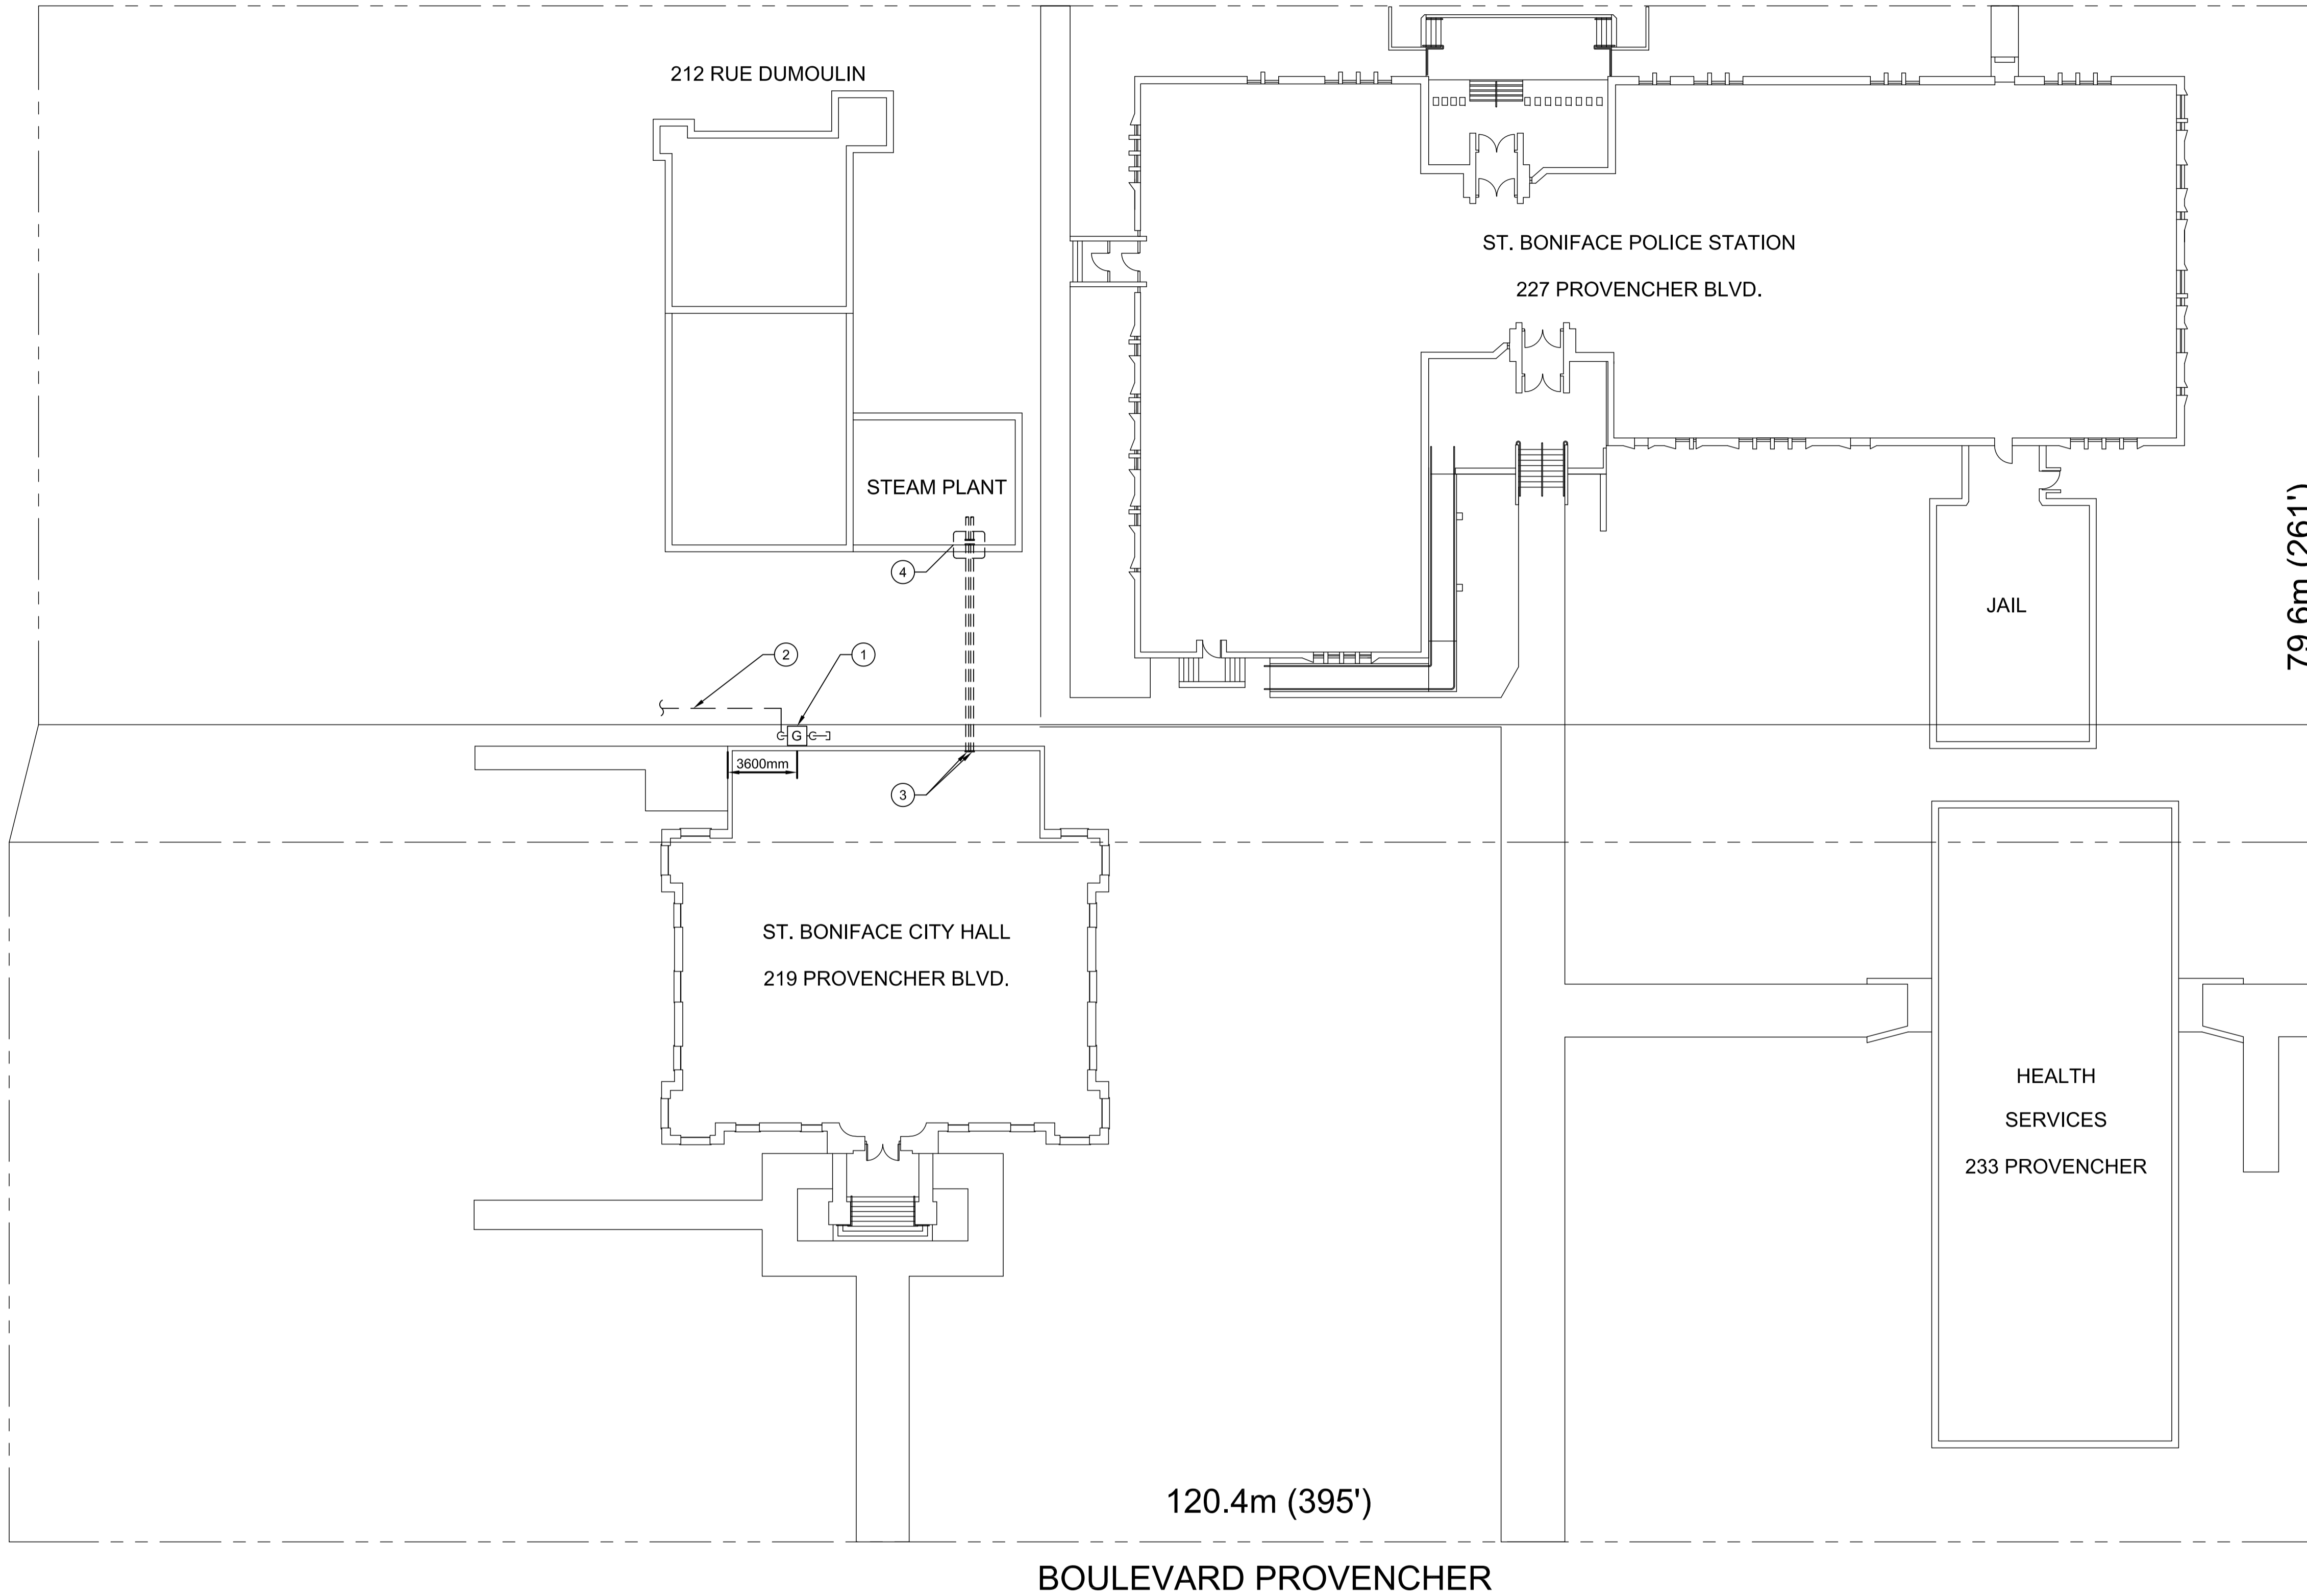



- NOTES:
- DRAWING NOTES**
- ① NEW LOW PRESSURE (1.74 kPa) GAS METER INSTALLED BY MANITOBA HYDRO GAS DIVISION. CAPPED ON THE EXTERIOR.
 - ② EXISTING GAS PIPING.
 - ③ CAP (c/w WELDED FLANGE, BLANKING PLATE AND GASKET) EXISTING STEAM SUPPLY AND CONDENSATE LINES AT WALL IN MECHANICAL ROOM.
 - ④ CAP (c/w WELDED FLANGE, BLANKING PLATE AND GASKET) BOTH ENDS OF EXISTING STEAM SUPPLY AND CONDENSATE LINES AT WALL IN STEAM PLANT LOCATED AT 212 RUE DUMOULIN.

AECOM

This drawing has been prepared for the use of AECOM's client and may not be used, reproduced or relied upon by third parties, except as agreed by AECOM and its client, as required by law or for use by governmental reviewing agencies. AECOM accepts no responsibility, and denies any liability whatsoever, to any party that modifies this drawing without AECOM's express written consent. Do not scale this document. All measurements must be obtained from stated dimensions.

0	ISSUED FOR TENDER	DL	2012.12.14
No.	REVISION/DESCRIPTION	BY	DATE

SEAL

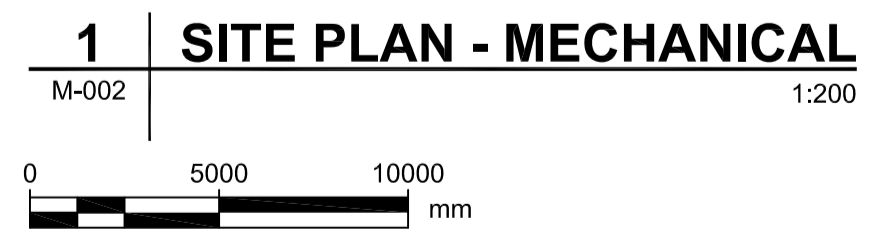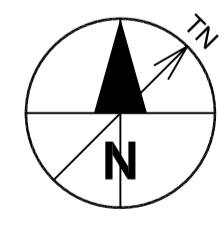

NATURAL GAS DATA

TOTAL CONNECTED GAS LOAD: 234 kW (800 MBH)

LONGEST RUN: 14m

GAS PRESSURE REQUIRED AT OUTLET GAS METER:
1.7 kPa (7" w.c.)

GAS PRESSURE REQUIRED AT INLET TO BOILER:
1.2 kPa (5" w.c.)

DRAWN	DL	CHECKED	PVL	DESIGNED	DC	APPROVED
DATE	2012.11.02	USER	APPROVAL			

Winnipeg THE CITY OF WINNIPEG
 PLANNING, PROPERTY AND
 DEVELOPMENT DEPARTMENT
 MUNICIPAL ACCOMMODATIONS DIVISION
 3-65 GARRY STREET, R3C 4K4

PROJECT
CIVIC OFFICES
NEW BOILER INSTALLATION
 CITY BID OPP. NO: 886-2012
 219 PROVENCHER BOULEVARD, WINNIPEG, MANITOBA

SHEET TITLE
MECHANICAL
SITE PLAN, NOTES

SCALE AS SHOWN PROJECT No: 60280355 SHEET No: **M-101**

DRAWING SHEET SIZE: A1 (841mm x 594mm) PLOT 1:1