


1 SINGLE LINE DIAGRAM
Scale N.T.S.

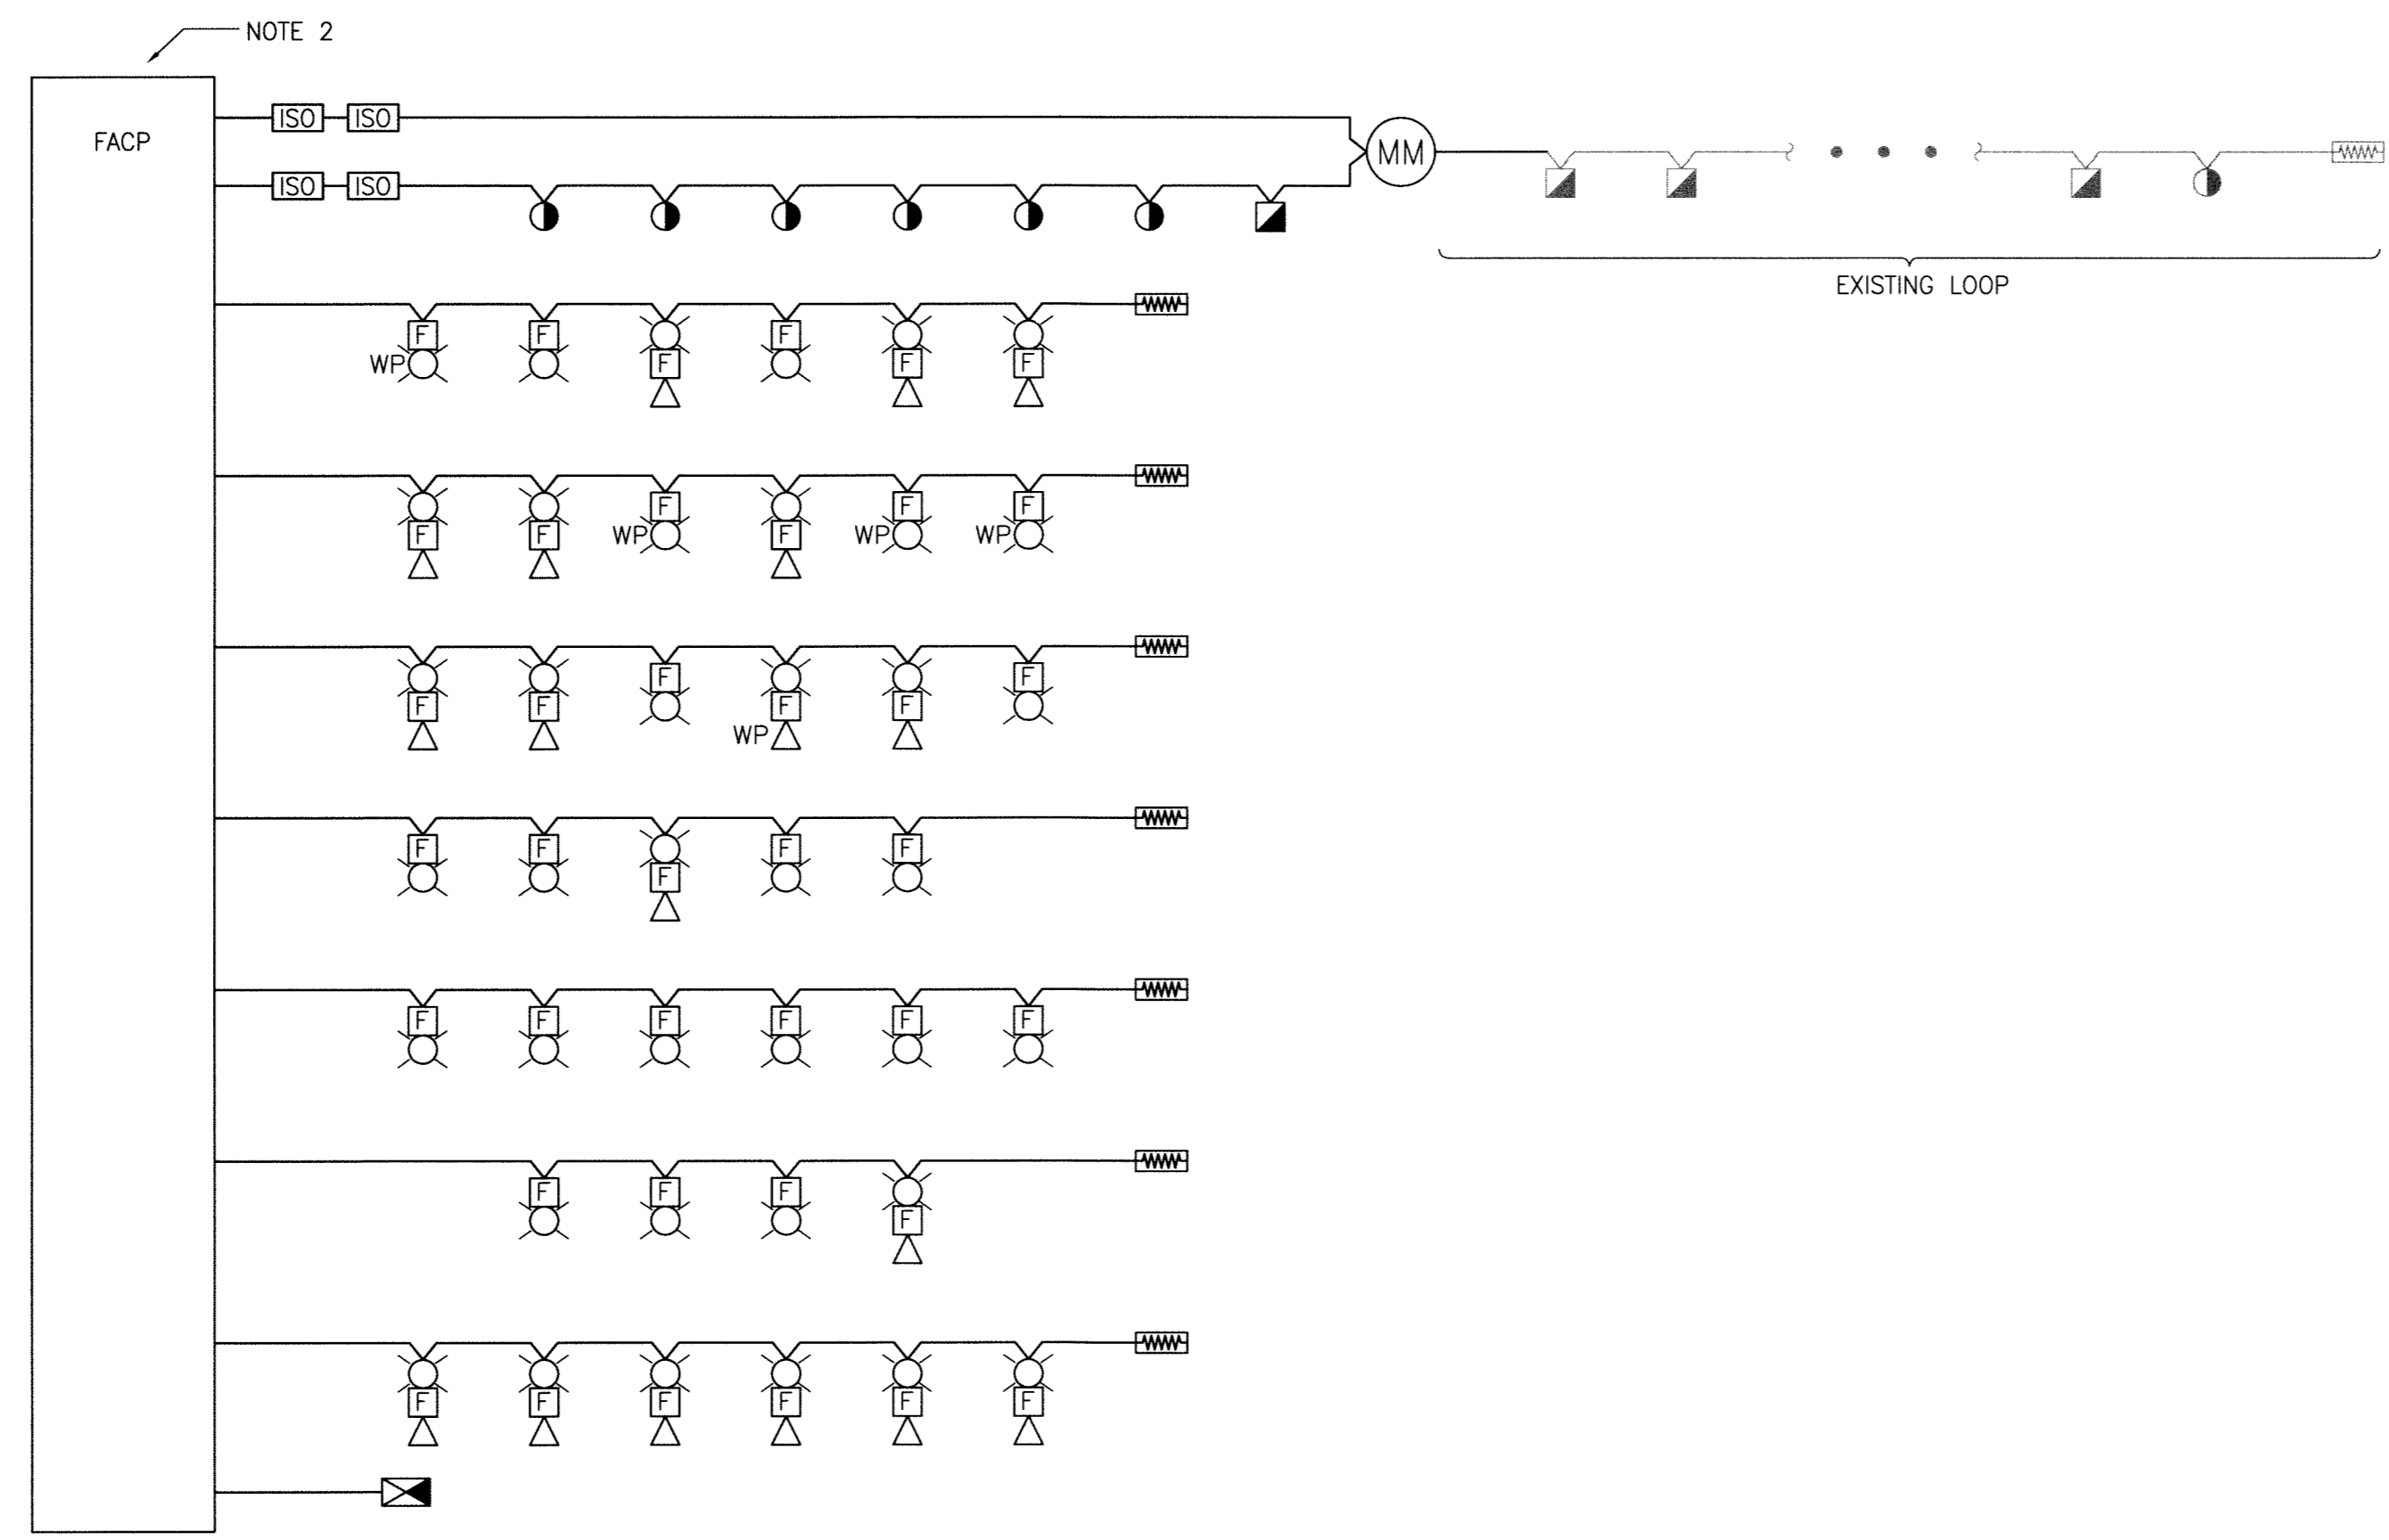

2 FIRE ALARM RISER DIAGRAM
Scale N.T.S.

NOTES:


1. DISCONNECT AND REMOVE EXISTING 100A-3 PHASE FEEDER TO PANEL A AND PROVIDE A NEW 200A 208V-3 PHASE FEEDER.
2. TIE THE EXISTING FIRE ALARM LOOPS INTO THE NEW FIRE ALARM CONTROL PANEL (FACP).
3. GRAY SCALE LINE WORK DENOTES EXISTING EQUIPMENT.

LEGEND:

- REMOTE FIRE ALARM ANNUNCIATOR
- FIRE ALARM PULL STATION
- HEAT DETECTOR
- FIRE ALARM HORN/STROBE
- FIRE ALARM STROBE
- END OF LINE RESISTOR
- 3 ϕ MOTOR
- ISOLATION MODULE
- MONITORING MODULE

Ownership of Documents:
Drawings and specifications as instruments of service are and shall remain the property of the Architect whether the project for which they are made is executed or not. They are not to be used by the owner on other projects or extensions to this project except by agreement in writing and with appropriate compensation to the Architect.

This drawing shall not be scaled. Follow given dimensions only.

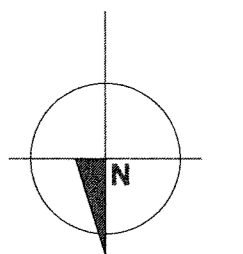

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PROJECT TITLE

**MARGARET GRANT POOL
INTERIOR RENOVATIONS
BID OPPORTUNITY NO.
12-2013**

685 DALHOUSIE DRIVE , Winnipeg , MB

DRAWING TITLE

**ELECTRICAL
SINGLE LINE DIAGRAM
AND FIRE ALARM RISER**

DESIGNED BY AP

DRAWN BY BGO

ISSUE DATE 13/02/06

REVISION No. 0

PROJECT No. 87611

DRAWING No. **E04**