
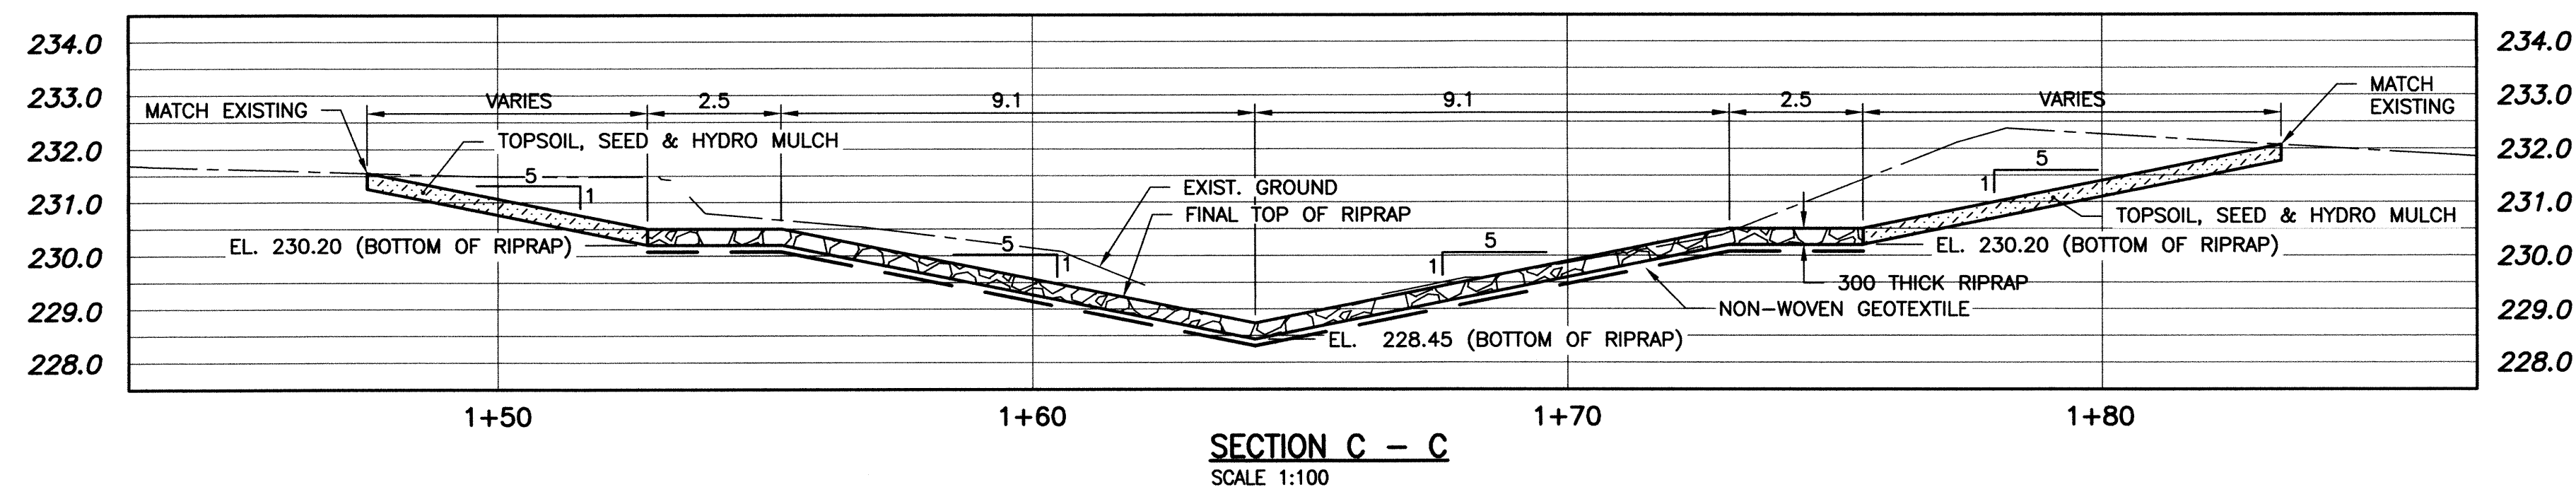
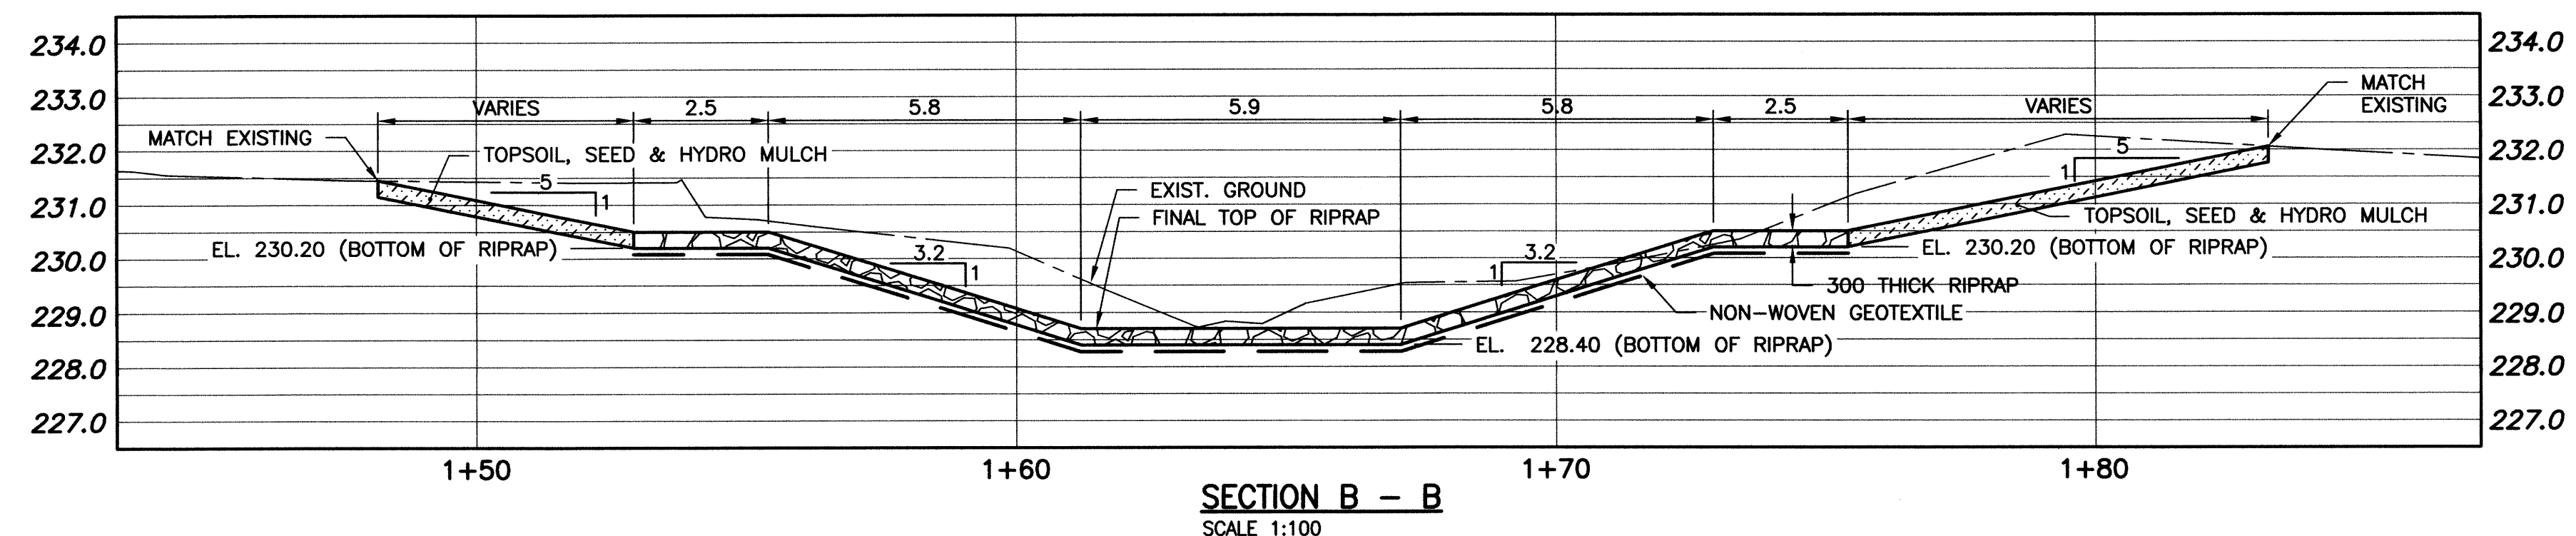


**SITE PLAN**  
SCALE: NTS

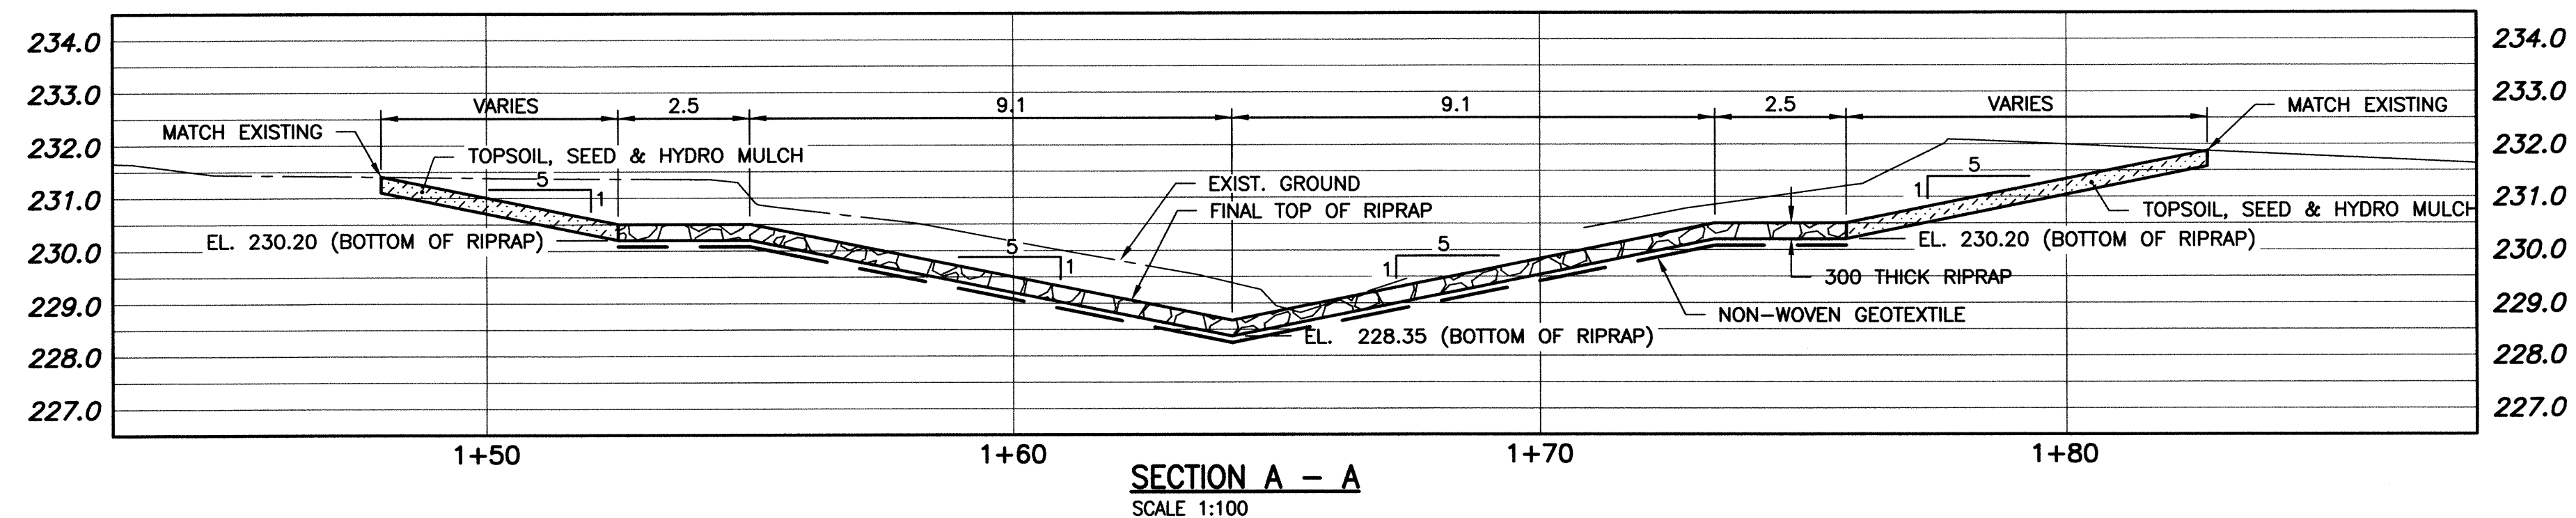

**WARNING**



1. NOTIFY THE GAS COMPANY OF THE PROPOSED LOCATION OF EXCAVATION.
2. TAKE PRECAUTION TO AVOID DAMAGE TO GAS COMPANY INSTALLATIONS.
3. SEE PROVINCIAL REGULATION 210/72 FOR DETAILS.

**PROPERTY LIMITS DELINEATION**

DELINEATION OF PROPERTY LIMITS AS SHOWN ON THIS DWG DOES NOT REPRESENT A "LEGAL SURVEY". KGS GROUP MAKES NO REPRESENTATION OR WARRANTY AS TO THE ACCURACY OF PROPERTY LIMITS DELINEATED ON THIS DWG, NOR ON THE DIMENSIONAL ACCURACY OF DWG FEATURES RELATIVE TO THOSE PROPERTY LIMITS.

**METRIC**

WHOLE NUMBERS INDICATE MILLIMETRES  
DECIMALIZED NUMBERS INDICATE METRES

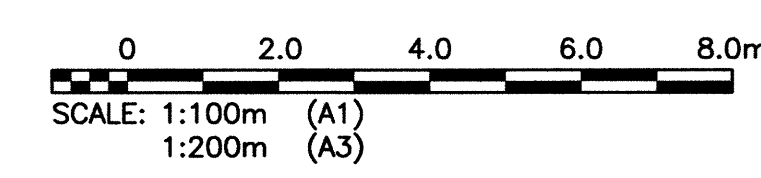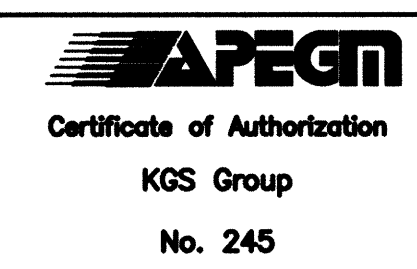

P:\Projects\2012\12-0107-005\Doc\Drawings\12-0107-005\_002-Rev. 0.dwg - Tab: 002 Plotted By: Dbercchi 01/18/2013 [Fr: 11:48am]  
 C:\LEGEND

150 WM	WATERMAIN	150 WM	HYDRO	150 WM	WATERMAIN	150 WM	LOCATION APPROVED UNDERGROUND STRUCTURES
Hydrant symbol	HYDRANT	Hydrant symbol	M.T.S.	Hydrant symbol	HYDRANT, VALVE	Hydrant symbol	
300 LDS	LAND DRAINAGE SEWER	300 LDS	ASPHALT	300 LDS	LAND DRAINAGE SEWER	300 LDS	
250 WWS	WASTE WATER SEWER	250 WWS	GRAPV	250 WWS	WASTE WATER SEWER	250 WWS	
Manhole symbol	MANHOLE	Manhole symbol	SOD	Manhole symbol	Q PROFILE	Manhole symbol	
Catch basin symbol	CATCH BASIN	Catch basin symbol	SEED	Catch basin symbol	NORTH/WEST GUTTER	Catch basin symbol	
Curb inlet symbol	CURB INLET	Curb inlet symbol	KGS TEST HOLE	Curb inlet symbol	SOUTH/EAST GUTTER	Curb inlet symbol	
Bollard symbol	BOLLARD	Bollard symbol	PROPERTY LINE	Bollard symbol	N/W, S/E R'S	Bollard symbol	
Culvert symbol	CULVERT	Culvert symbol	DITCH	Culvert symbol	N/W, S/E TOP/CURB	Culvert symbol	
Gas symbol	GAS	Gas symbol	ELEVATION	Gas symbol	SOUTH/EAST DITCH	Gas symbol	
Existing symbol	EXISTING	Proposed symbol	LEGEND-PLAN	Existing symbol	LEGEND-PROFILE	Proposed symbol	

**LOCATION APPROVED UNDERGROUND STRUCTURES**

SUPV. U/G STRUCTURES DATE COMMITTEE

**NOTE:**  
LOCATION OF UNDERGROUND STRUCTURES AS SHOWN ARE BASED ON THE BEST INFORMATION AVAILABLE BUT NO GUARANTEE IS GIVEN THAT ALL EXISTING UTILITIES ARE SHOWN OR THAT THE GIVEN LOCATIONS ARE EXACT. CONFIRMATION OF EXISTENCE AND EXACT LOCATION OF ALL SERVICES MUST BE OBTAINED FROM THE INDIVIDUAL UTILITIES BEFORE PROCEEDING WITH CONSTRUCTION.

B.M. 55-056	81804 - N.W. COR. BEAVERHILL BLVD. & C.P.R. EMERSON LINE. T.B.T. ON TOP OF 0.025m DIA x 2.4m IRON PIPE, 10.68m W. OF W. RAIL OF RAILWAY TRACKS & 6.76m W. OF C.L. CONC. PAV'T. BEAVERHILL BLVD. OR 3.8m E. OF W.L. OF C.P.R. EMERSON R.O.W. & 8.4m S. OF N.L. OF BEAVERHILL BLVD.
ELEV. 232.913m	
ISSUED FOR TENDER	13/01/18
NO. REVISIONS	DATE BY

**KGS GROUP CONSULTING ENGINEERS**

**SCATLIFF+MILLER+MURRAY INC.**

DESIGNED BY AKW CHECKED BY [Signature]

DRAWN BY GEL APPROVED BY [Signature]

HOR. SCALE: AS SHOWN  
VERTICAL: [Signature]

RELEASED FOR CONSTRUCTION: [Signature]

DATE 12/06/11

ENGINEER'S SEAL

**AD PRIESEN**  
Member 23875

CONSULTANT DRAWING NO. 12-0107-005

**THE CITY OF WINNIPEG PUBLIC WORKS DEPARTMENT**

PROJECT TITLE: MULTI-USE PATH AND NAVIN DRAIN C.I.P. CONCRETE CULVERT

BISHOP GRADIN BLVD/SHOREHILL DR TO BEAVERHILL BLVD BANK STABILIZATION SECTIONS

SHEET 09 OF 10

COMPUTER FILE NAME: 12-0107-005

CITY DRAWING NUMBER: G-02