


MAIN FLOOR PLAN - NEW PLUMBING
SCALE: 1/8" = 1'-0"

PLUMBING DRAWING NOTES:

- 1 CONNECT NEW 2" DCW SERVICE TO EXISTING DCW SERVICE UNDER GROUND, PUSH UNDER BUILDING SLAB AND RISE UP TO NEW RELOCATED WATER METER. MINIMIZE SLAB CUTTING.
- 2 MC TO CORE THROUGH THE EXISTING GRADE BEAM.
- 3 CONNECT RELOCATED WATER METER TO NEW 2" DCW SERVICE FROM UNDER SLAB.
- 4 CONNECT NEW 2" DCW TO THE TWO EXISTING DCW CUT OFF POINTS IN CEILING SPACE.
- 5 CONNECT RELOCATED VALVE, HOSE FITTING AND VACUUM BREAKER AT LOW LEVEL ON WALL.
- 6 CONNECT RELOCATED HOSE REEL AT LOW LEVEL ON WALL.
- 7 CONNECT NEW SANITARY TO EXISTING SANITARY UNDER SLAB.
- 8 CONNECT NEW OWNER SUPPLIED SINK TO EXISTING PLUMBING AS REQUIRED. PROVIDE ALL REQUIRED HARDWARE.
- 9 CONNECT RELOCATED DISHWASHER TO SINK PLUMBING AS REQUIRED. RELOCATE AND CONNECT EXISTING DISHWASHER HARDWARE, TUBING, CHEMICALS AND BACKFLOW PREVENTION ETC. IN MILLWORK UNDER SINK.
- 10 CONNECT NEW DCW & DHW TO EXISTING DCW & DHW.
- 11 CONNECT NEW 1"Ø7"WC GAS LINE TO EXISTING GAS METER AS REQUIRED.
- 12 INSTALL NEW 1"Ø7"WC GAS PIPING ON ROOF C/W CPORST STANDS AND UNISTRUT HARDWARE.
- 13 CONNECT NEW 1"Ø7"WC GAS FROM ROOF TO NEW OWNER SUPPLIED GAS RANGE.

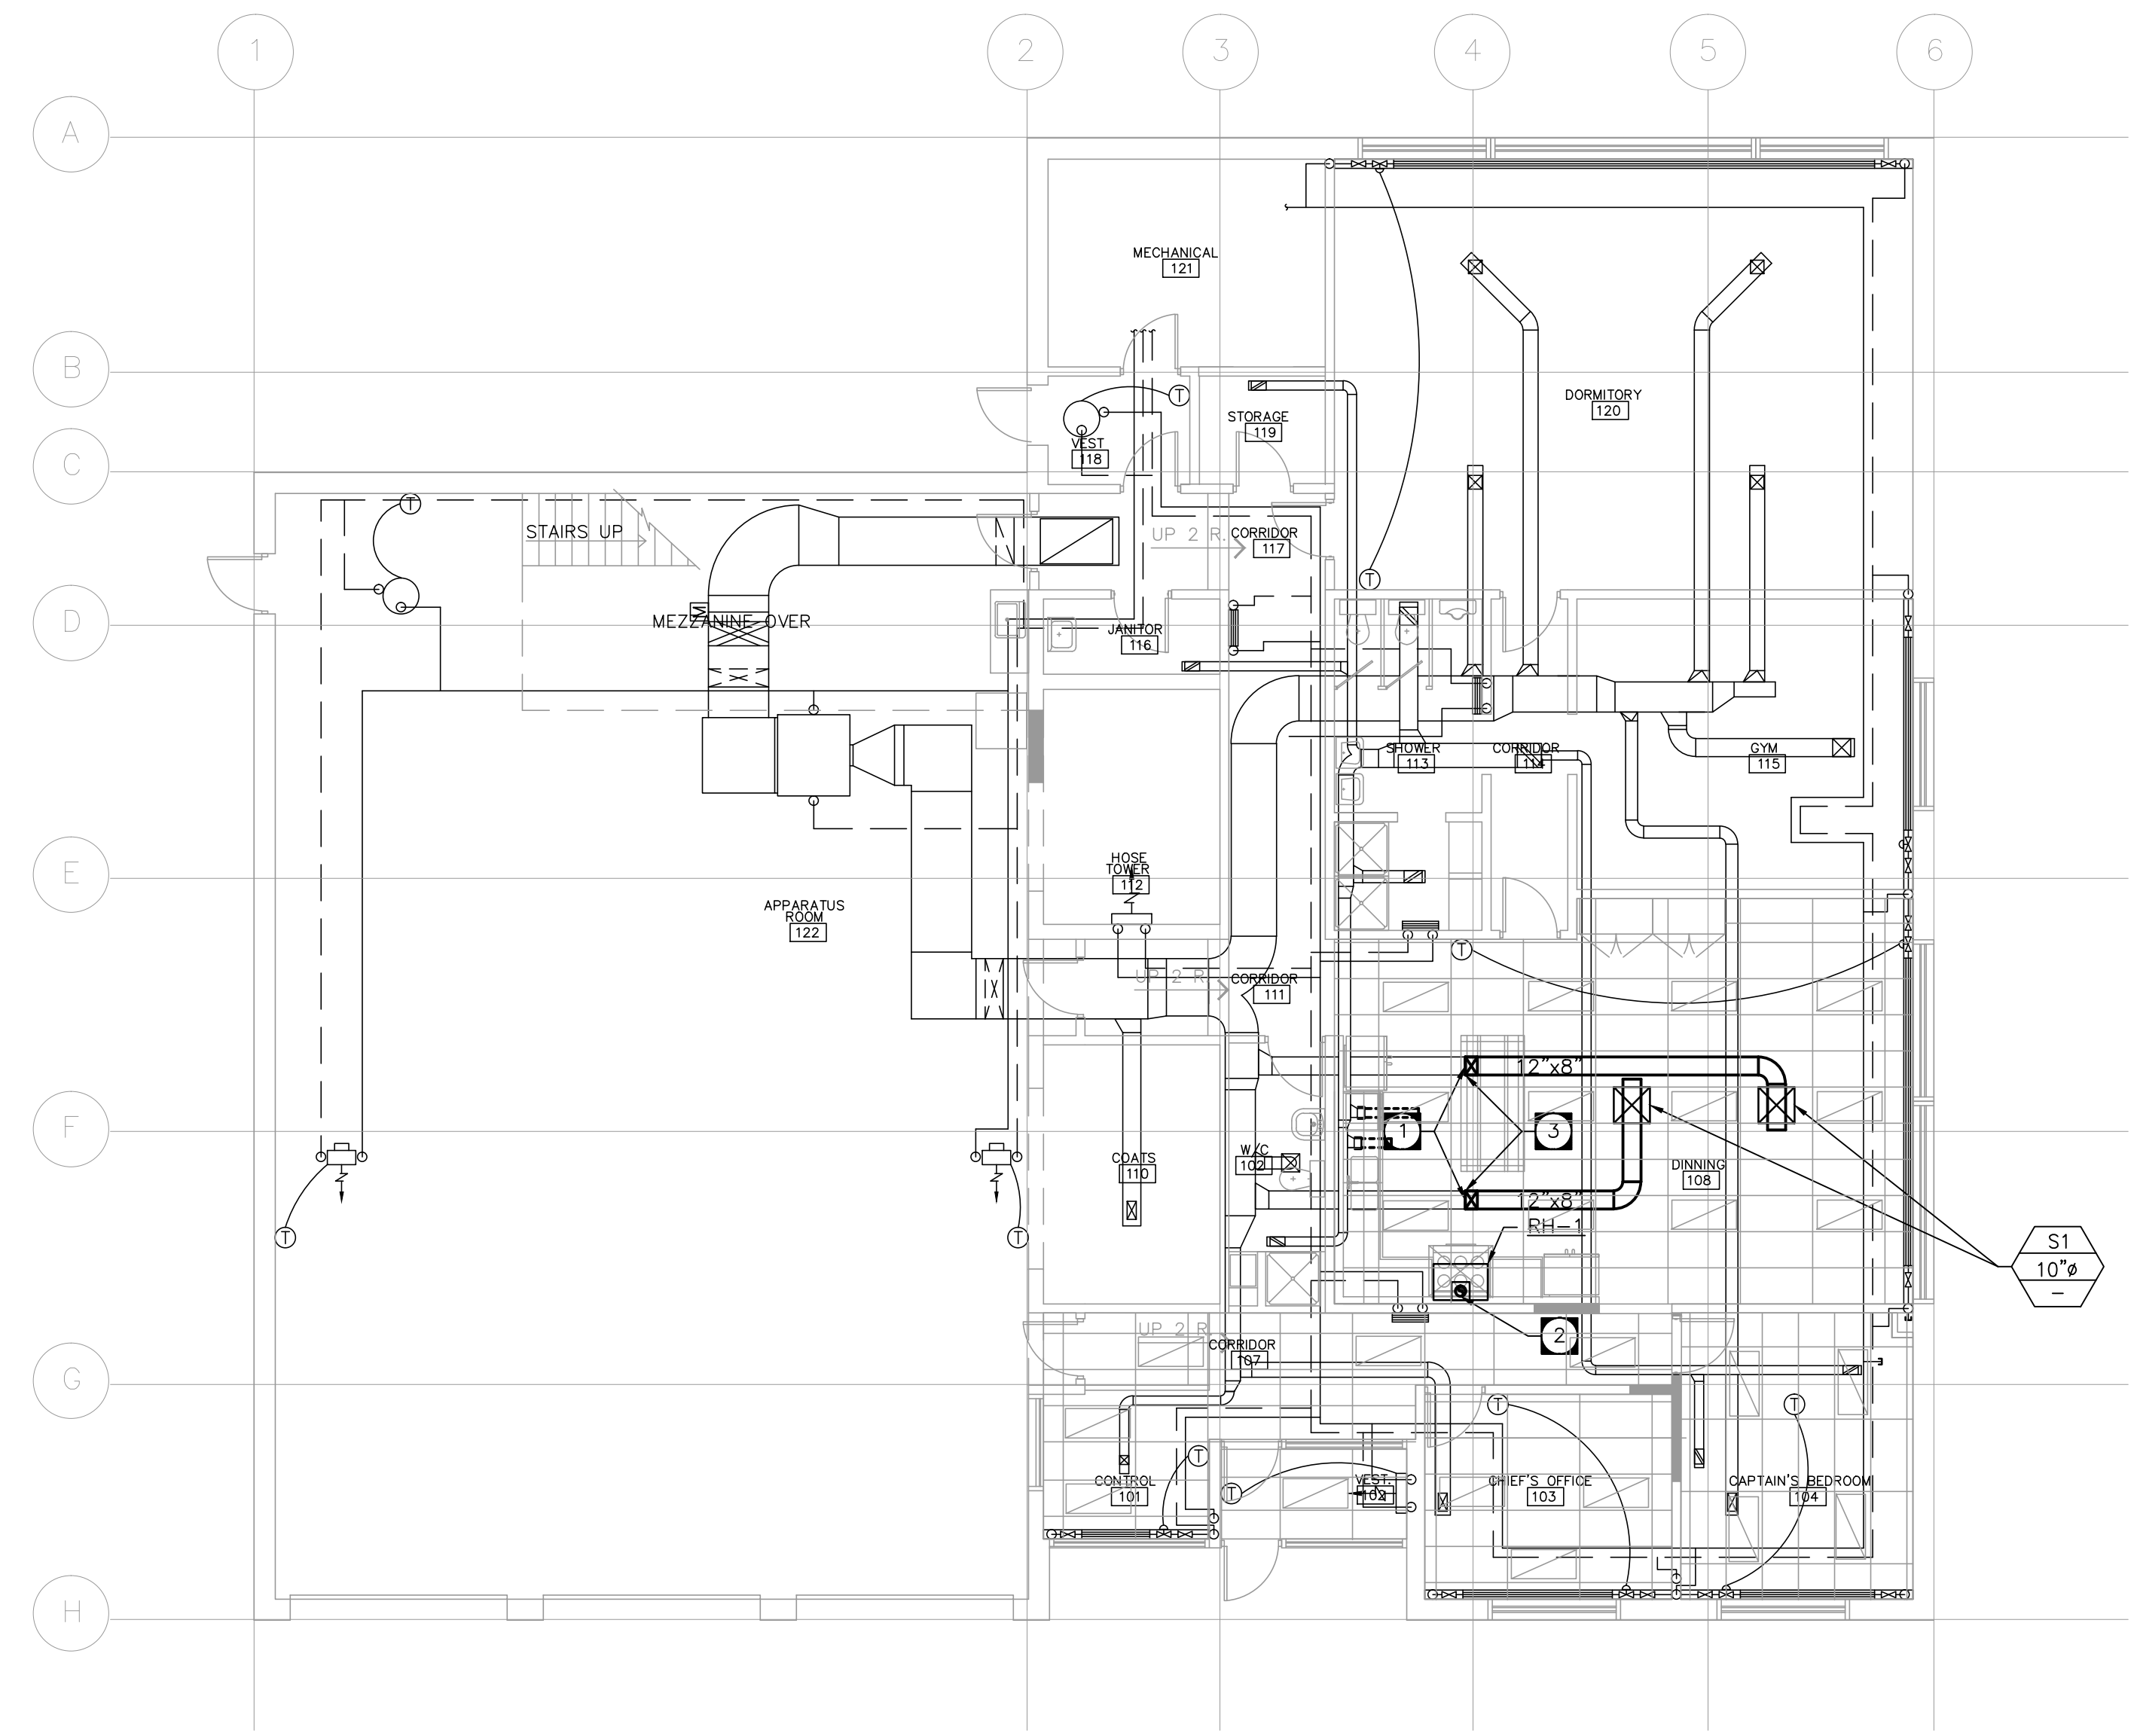

MAIN FLOOR PLAN - NEW HVAC
SCALE: 1/8" = 1'-0"

HVAC DRAWING NOTES:

- 1 RISE NEW DUCTWORK TO NEW CEILING HEIGHT LEVEL REQUIREMENTS AS REQUIRED.
- 2 NEW 7"Ø E/A DUCT FROM RANGE HOOD UP THROUGH ROOF AND TERMINATE TO ROOF CAP OR GOOSENECK.
- 3 EXTEND NEW S/A DUCTS TO NEW DIFFUSERS FROM EXISTING S/A DUCTS.

TOWER PROJECT NUMBER: 12431

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NO.	DATE	DESCRIPTION	BY
6	NOV 27, 2015	ISSUED FOR REVIEW	MH
5	FEB 18, 2015	ISSUED FOR REVIEW	LJR
4	FEB 2, 2015	ISSUED FOR REVIEW	LJR
3	JAN 9, 2015	ISSUED FOR REVIEW	LJR
2	APRIL 9, 2013	ISSUED FOR REVIEW	LJR
1	APRIL 3, 2013	ISSUED FOR REVIEW	LJR

DRAWN BY LJR
PRINTING DATE MARCH 2013

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DATE MARCH 2013 **SCALE** AS NOTED **REVISIONS** 1
DRAWN BY LJR **CHECKED BY** LJR

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CITY OF WINNIPEG

AUTOCAD NUMBER **DWG.** M3.0

1119-2014-MECHANICAL PLUMBING & HVAC NEW PLANS M3.0-R1