


| 9 | com | RW | Rec lain | ned Water | | MET | Metallic | | | | CC | |
|---|-----------|--------------|------------------|-------------------------|---------------------|----------------------------|-------------------------|------------------|--------------------|---|--------|--|
| | Cable | SL | Street I | Light | | CP | Clay Pipe | | | h ssu ssu 7 4 | PL | |
| | | TS | Traffic | Signal | | AC | Asbestos | Cement | (Trans | site) | CD | |
| | | EXP | Explora | tory | | CP | Copper Pi | be | | | | |
| | | UNK | Unknov | vn | | | | | | PL ansite) CC ansite) CC this section of the sectio | | |
| | | | | | | | | | | | | |
| | | | | | 5 | Surface T | ype | | | | | |
| | | С | Concre | te | | I | Interlock | | | | NG | |
| | Drawing # | Utility Type | Utility Material | Jtility Width (Nom.) | Ref. Point Elev. | Bottom of Utility Elev. | Top of Utility Elev. | Manual From (| | os s al View | N ≜ | |
| | Draw | Itility | L.A. | | Re | B B | 5 | Bottom | Тор | tion C | | |
| | | | 5 | mm. | m | m | m | m | m | Sec | Ļ | |
| | 18 | W | PL | 200 | 231.47 | 2 | 229.20 | - | 2.27 | 0 | \$ | |
| | 18 | W | PL | 200 | 231.36 | - | 229.12 | ÷ | 2.24 | 0 | \$ | |
| | 18 | FM | MET | 300 | 231.50 | - | 227.70 | - | 3. <mark>80</mark> | \bigcirc | 1 | |

| V V | | | | TE | ST HOL | E INFC | ORMATIC | <u>NC</u> | | | | | | | | | | | | TE | EST HO | LE INFO | ORMATI | ON | | | | | | | | | | | | Ţ | EST HO | DLE INF | FORMA | TION | | | | | |
|---|
| B | | Utility T | ype | | | | | | Utility I | Materi | al | | | | 19* | 6/25/14 | 11 | W | MET | 50 | 231.20 | - 1 | 228.09 | - | 3.11 | 0 | 1 | | NG | _ | 44* | 7/2/14 | 19 | EXP | - | - | NOT | SURVE | YED | 6.00 - | - | - | | NG | - |
| in an and base in the serie in the | ALC IN TRANSPORTATION AND A DESCRIPTION | | | | | COLOR DE COLOR | | | e | | | | | 1 | | | | 1.2.1 | | | | | | | | ~ | * | | | | | | | | | | | 1 | | | | | Dod 9 | | |
| N + | | | | | | | | | | | | - | | | 20* | 6/25/14 | 11 | RAS | PL | 250 | 231.20 | - | 228.42 | - | 2.78 | $O \mid$ | Ŧ | | NG | - | 45 | 7/4/14 | 13 | W | PL | 150 | 231.40 | - | 229.20 | - 2.20 | | | | NG | - |
| N N N N N N N N N N N N N | | | | | | CP | | | | | | | a ciuji cup | <u> </u> | 21* | 6/25/14 | 11 | WAS | PL | 200 | 230.98 | - | 227.65 | - | 3.33 | \cap | + | | NG | - | 46 | 7/4/14 | 13 | BT | PL | 50x2 | 231.48 | - | 230.28 | - 1.20 | 00 | ~ | | NG | - |
| | W Water | TS | Traffic | Signal | | AC | Asbestos | Cement | (Transite) | | CD | Concrete | Duct | | | | | | 1.1127120 | | Contraction of the | | | | | | * | | | | | | | | | | | | | | - | \square | Rod & | | |
| V motor V motor <t< td=""><td></td><td></td><td></td><td></td><td></td><td>CP</td><td>Copper Pip</td><td>pe</td><td></td><td></td><td></td><td></td><td></td><td></td><td>22</td><td>6/25/14</td><td>11</td><td>SL</td><td>DBC</td><td>40</td><td>230.95</td><td>e -</td><td>229.75</td><td>÷</td><td>1.20</td><td>0</td><td>~</td><td></td><td>NG</td><td>-</td><td>47</td><td>7/4/14</td><td>20</td><td>W</td><td>PL</td><td>150</td><td>231.12</td><td>-</td><td>228.17</td><td>- 2.98</td><td></td><td> ↓</td><td></td><td>NG</td><td>-</td></t<> | | | | | | CP | Copper Pip | pe | | | | | | | 22 | 6/25/14 | 11 | SL | DBC | 40 | 230.95 | e - | 229.75 | ÷ | 1.20 | 0 | ~ | | NG | - | 47 | 7/4/14 | 20 | W | PL | 150 | 231.12 | - | 228.17 | - 2.98 | | ↓ | | NG | - |
| k + k + k + k + k + k + k + k + k + k + | SIM Storm | UNK | Unknov | vn | | | | | | | | | | | 23 | 6/26/14 | 11 | RAS | PL | 250 | 230.94 | - | 227.76 | - | 3.18 | \cap | + | | NG | - | 48* | 7/4/14 | 13 | FOC | CC | - | 231.00 | - | 230.30 | - 0.70 | | i 🕇 🖞 | | NG | - |
| A mart C Virtual Cond Virtual Cond Virtual Cond Vi | | | | | | Surface 1 | Гуре | | | | | | | | | | | | | | | | | | | $\frac{1}{2}$ | * | 100000 | | - | | 7/7/4 | | 100 | NET | | 0.04.00 | | 000 74 | 0.50 | | | Dod 8 | 10 | |
| | A A sphalt | С | Concre | te | - | 1 | | | | 1 | NG | Natural (| Ground | | | | 11 | WAS | PL | 200 | 230.93 | - | 227.69 | - | 3.24 | \bigcirc | + | Cap | NG | - | 49 | ////14 | 14 | VV | MET | 38 | 231.32 | - | 228.74 | - 2.58 | 5 0 | | Сар | NG | - |
| v | a 26 1 | ype g # | Iterial | Width () | Point ev. | Elev | o of Elev | | | View | N | Ŋ | Type | thes s | 25* | 6/26/14 | 17 | EXP | | - | 231.19 | 228.19 | н | 3.00 | - | ~ | - | | NG | - | 50 | 7/7/14 | 5 | BE | CD | 2750 | 231.43 | 230.18 | 230.97 | 1.25 0.46 | 6 | ** | | NG | - |
| v | HL H | | Ŋ Ma | (Nc | Ref. | Utility | Tol Utility | | | ional | 1 I | | lace | Thick | 26 | 6/26/14 | 17 | BE/BT | CC | 1200 | 231.41 | 14 | 229.73 | - | 1.68 | | Î | | NG | | 51 | 7/7/14 | 5 | BE | CC | 1100 | 231.22 | - | 230.14 | - 1.08 | 3 | 11 | | NG | - |
| 1 2 2 2 2 <th< td=""><td></td><td>5 5</td><td>Ctill</td><td>mm.</td><td>m</td><td></td><td>m</td><td></td><td></td><td>Sect</td><td>T</td><td></td><td></td><td></td><td>27</td><td>6/26/14</td><td>11</td><td>BE/BT</td><td>CON</td><td>2100</td><td>NO</td><td></td><td>EYED</td><td>-</td><td>1 09</td><td></td><td>Ť</td><td>Rod &</td><td>NG</td><td>_</td><td>52</td><td>7/7/14</td><td>5</td><td>BE</td><td>MET</td><td>50</td><td>231 22</td><td>-</td><td>230.36</td><td>- 0.86</td><td>5 0</td><td>Ť</td><td>Rod &</td><td>NG</td><td></td></th<> | | 5 5 | Ctill | mm. | m | | m | | | Sect | T | | | | 27 | 6/26/14 | 11 | BE/BT | CON | 2100 | NO | | EYED | - | 1 09 | | Ť | Rod & | NG | _ | 52 | 7/7/14 | 5 | BE | MET | 50 | 231 22 | - | 230.36 | - 0.86 | 5 0 | Ť | Rod & | NG | |
| 0 0 0 0 0 0 < | 1 6/24/14 1 | 18 W | PL | 200 | 231.47 | 0 | 229.20 | -2 | 2.27 (| $\overline{\Omega}$ | 1 | | NG | 20 | | | | | | 2.721 | | | | | | | * | | | | | | | | | | | | | | | + | Cap Rod & | | |
| 0 0 0 0 0 0 0 0 0 </td <td>0 00000</td> <td></td> <td>- DI</td> <td>000</td> <td>004.00</td> <td></td> <td>000 40</td> <td></td> <td>0.04</td> <td>ž</td> <td>*</td> <td></td> <td>NO</td> <td></td> <td>28</td> <td>6/26/14</td> <td>11</td> <td>BT</td> <td>DBC</td> <td>25</td> <td>231.10</td> <td>-</td> <td>230.50</td> <td>-</td> <td>0.60</td> <td>0</td> <td></td> <td>Сар</td> <td>NG</td> <td>-</td> <td>53</td> <td>////14</td> <td>6</td> <td>BE</td> <td>DBC</td> <td>40</td> <td>231.16</td> <td>-</td> <td>230.48</td> <td>- 0.68</td> <td>3 0</td> <td></td> <td>Cap</td> <td>NG</td> <td>_</td> | 0 00000 | | - DI | 000 | 004.00 | | 000 40 | | 0.04 | ž | * | | NO | | 28 | 6/26/14 | 11 | BT | DBC | 25 | 231.10 | - | 230.50 | - | 0.60 | 0 | | Сар | NG | - | 53 | ////14 | 6 | BE | DBC | 40 | 231.16 | - | 230.48 | - 0.68 | 3 0 | | Cap | NG | _ |
| | 2 6/24/14 1 | 18 W | PL | 200 | 231.36 | - | 229.12 | - | 2.24 | \Box | + | | NG | - | 29* | 6/26/14 | 12 | TUN | CON | - | 231.07 | - 14 | 230.49 | 4 | 0.58 | \Box | N | | NG | | 54 | 7/7/14 | 19 | FM | MET | 350 | 231.55 | - | 229.31 | - 2.24 | | ↔ | | NG | - |
| 4 6 </td <td>3 6/24/14 1</td> <td>I8 FM</td> <td>MET</td> <td>300</td> <td>231.50</td> <td>5</td> <td>227.70</td> <td>5</td> <td>3.<mark>80</mark> {</td> <td>\circ</td> <td>2</td> <td></td> <td>NG</td> <td></td> <td>30*</td> <td>6/26/14</td> <td>12</td> <td>TUN</td> <td>CON</td> <td>-</td> <td>231.12</td> <td>227.12</td> <td>230.51</td> <td>4.00</td> <td>0.61</td> <td>τ</td> <td>**</td> <td>Rod &</td> <td>NG</td> <td>-</td> <td>55*</td> <td>7/7/14</td> <td>19</td> <td>EXP</td> <td>-</td> <td>н (</td> <td>231.55</td> <td>225.45</td> <td>-</td> <td>6.10 -</td> <td>-</td> <td>-</td> <td></td> <td>NG</td> <td>-</td> | 3 6/24/14 1 | I8 FM | MET | 300 | 231.50 | 5 | 227.70 | 5 | 3. <mark>80</mark> { | $\circ $ | 2 | | NG | | 30* | 6/26/14 | 12 | TUN | CON | - | 231.12 | 227.12 | 230.51 | 4.00 | 0.61 | τ | ** | Rod & | NG | - | 55* | 7/7/14 | 19 | EXP | - | н (| 231.55 | 225.45 | - | 6.10 - | - | - | | NG | - |
| S </td <td>4 6/24/14 1</td> <td>18 FM</td> <td>MET</td> <td>300</td> <td>231.00</td> <td>н</td> <td>227.51</td> <td>-</td> <td>3.49 (</td> <td>0</td> <td>¢</td> <td></td> <td>NG</td> <td>~</td> <td>31</td> <td>6/27/14</td> <td>13</td> <td>BT</td> <td>DBC</td> <td></td> <td>231.33</td> <td></td> <td>230.93</td> <td>-</td> <td>0.40</td> <td>00</td> <td>97</td> <td>Rod &</td> <td>NG</td> <td>-</td> <td>56</td> <td>7/7/14</td> <td>19</td> <td>FM</td> <td>MET</td> <td>200</td> <td>231.49</td> <td>-</td> <td>228.91</td> <td>- 2.58</td> <td>30</td> <td>++</td> <td>Rod &</td> <td>NG</td> <td>4</td> | 4 6/24/14 1 | 18 FM | MET | 300 | 231.00 | н | 227.51 | - | 3.49 (| 0 | ¢ | | NG | ~ | 31 | 6/27/14 | 13 | BT | DBC | | 231.33 | | 230.93 | - | 0.40 | 00 | 97 | Rod & | NG | - | 56 | 7/7/14 | 19 | FM | MET | 200 | 231.49 | - | 228.91 | - 2.58 | 30 | ++ | Rod & | NG | 4 |
| 6 8 | 5 6/24/14 1 | 18 FO | D PL | 50 | 230.91 | - | 230.06 | - | 0.85 | 0 | Î | | NG | -1 | | | | | | | | | | - | 0.27 | | | | | - | 57* | 7/8/14 | 19 | EXP | - | - | 231.45 | 227.20 | - | 4.25 - | - | - | Rod & | NG | - |
| < | 6 6/24/14 1 | IT FM | MET | 300 | 231.32 | _ | 227.56 | - | 3.76 { | $\overline{\mathbf{n}}$ | ▼ | Rod & | NG | - | 32 | 6/27/14 | 13 | BT | DBC | | NO | TSURVE | EYED | | | 0 o | + | | NG | - | 58* | 7/8/14 | 6 | EFFL | CD | - 1 | 231.10 | - | 227.80 | - 3.30 | | ++ | Rod & | NG | - |
| P P <th< td=""><td></td><td>BE</td><td>CON</td><td>1180</td><td></td><td>-</td><td>229.88</td><td></td><td>1 60</td><td></td><td>ä</td><td></td><td></td><td></td><td></td><td></td><td></td><td></td><td></td><td></td><td></td><td></td><td>230 68</td><td>-</td><td></td><td></td><td>1</td><td></td><td></td><td>_</td><td>59*</td><td>7/8/14</td><td>6</td><td>EFFL</td><td>CD</td><td>- 1</td><td>231.12</td><td>-</td><td>227.80</td><td>- 3.32</td><td></td><td>**</td><td>Rod &</td><td>NG</td><td></td></th<> | | BE | CON | 1180 | | - | 229.88 | | 1 60 | | ä | | | | | | | | | | | | 230 68 | - | | | 1 | | | _ | 59* | 7/8/14 | 6 | EFFL | CD | - 1 | 231.12 | - | 227.80 | - 3.32 | | ** | Rod & | NG | |
| N N N N N N N </td <td>7* 6/24/14 1</td> <td>7</td> <td></td> <td></td> <td>231.48</td> <td></td> <td>-</td> <td></td> <td></td> <td>000</td> <td>1</td> <td></td> <td>NG</td> <td>-</td> <td>33</td> <td>6/26/14</td> <td>12</td> <td>BT</td> <td>DBC</td> <td>and the second s</td> <td>231 21</td> <td></td> <td></td> <td></td> <td>0.70</td> <td></td> <td>*</td> <td></td> <td>NG</td> <td></td> <td>60*</td> <td>7/8/14</td> <td>6</td> <td>EFFL</td> <td>CD</td> <td>-</td> <td>231.08</td> <td>225.28</td> <td>227.78</td> <td>5.80 3.30</td> <td></td> <td>++</td> <td>Rod &</td> <td>NG</td> <td>-</td> | 7 * 6/24/14 1 | 7 | | | 231.48 | | - | | | 000 | 1 | | NG | - | 33 | 6/26/14 | 12 | BT | DBC | and the second s | 231 21 | | | | 0.70 | | * | | NG | | 60* | 7/8/14 | 6 | EFFL | CD | - | 231.08 | 225.28 | 227.78 | 5.80 3.30 | | ++ | Rod & | NG | - |
| 0 0.0 0.0 0.0 0.0 0.0 0.0 0.0 0.0 0.0 0.0 < | 9 * C/05/4 4 | | | 1200 | 001.00 | | | | | | * | Rod & | NC | | | 0/20/14 | 12 | 5. | 000 | | 201.21 | - | | | F | ното | * | Cap | | | 61* | 7/8/14 | 6 | EFFL | CD | - | 231.08 | - | 227.80 | - 3.28 | | ** | Rod & | NG | |
| | | | | - | | | | | | \exists | + | | | - | 24 | C/07/44 | 10 | OTM. | MET | | 001 44 | - | | - | | | | Rod & | NC | | | - | | | | | | | | | - | | Rod & | | - |
| n | | | | | | 0 | | | | \bigcirc | + | Cap | | -21 | | 2.2.2.1 | | | | | | | | | | $\frac{\circ}{\circ}$ | * | | | - | - | and a sec | 12 | S.EFF | | | | | | | | | Rod & | | |
| 1 62/4 1 w c 45 22.1 . 22.4 . 22.4 . 22.4 . 2 0 . 0 <th0< th=""> 0</th0<> | 10 6/25/14 1 | I7 SAI | N PL | 100 | 232.12 | - | 229.62 | - | 2.50 | 0 | Ţ | Cap | NG | - | | | | | | 200 | | | | | | $\frac{\circ}{=}$ | | Сар | | -1 | | | 6 | | | - | | | | | <u> </u> | - | Rod & | | |
| 12 625/14 17 EAP 2 2 10 0 10 0 0 0 | 11 6/25/14 1 | 17 W | CP | 45 | 232.13 | 5 | 229.46 | | 2.67 | 0 | ţ | Cap | NG | - | | Sec. of the sec. | 18 | TUN | CON | - | 231.42 | 226.97 | 230.22 | 4.45 | 1.20 | | Ţ | Сар | NG | <u>_</u> | | 1000000000000 | | | | 200 | | | | | | | Rod & | | |
| 13 625/14 17 W MET 50 231.0 - 282.0 - 280.0 - Res Res <th< td=""><td>12* 6/25/14 1</td><td>I7 EX</td><td>2 -</td><td>-</td><td>231.00</td><td>229.10</td><td>r =</td><td>1.90</td><td>-</td><td>-</td><td>-</td><td></td><td>NG</td><td></td><td>37</td><td>6/27/14</td><td>18</td><td>LDS</td><td></td><td>375</td><td>231.38</td><td>-</td><td>229.28</td><td>-</td><td>2.10</td><td>0</td><td>~</td><td>Сар</td><td>NG</td><td>-</td><td></td><td></td><td></td><td></td><td></td><td></td><td>231 45</td><td>-</td><td>225 75</td><td></td><td>\sim</td><td></td><td>Rod &</td><td></td><td></td></th<> | 12 * 6/25/14 1 | I7 EX | 2 - | - | 231.00 | 229.10 | r = | 1.90 | - | - | - | | NG | | 37 | 6/27/14 | 18 | LDS | | 375 | 231.38 | - | 229.28 | - | 2.10 | 0 | ~ | Сар | NG | - | | | | | | | 231 45 | - | 225 75 | | \sim | | Rod & | | |
| 1 1 R P 2 | 13 6/25/14 1 | 17 W | MET | 50 | 231.01 | - | 228.21 | = | 2.80 | 0 | ↔ | | NG | - | 38 | 6/27/14 | 12 | CEN | - | 350 | 231.23 | - | 229. <mark>4</mark> 3 | | 1.80 | 0 | ţ. | Сар | NG | | | | | | | | | | | | | | Rod & | | |
| A A A B A B A B C | 14 6/25/14 1 | I7 RAS | S PL | 250 | 231.02 | 2 | 228.32 | - | 2.70 | 0 | \leftrightarrow | | NG | - | 39* | 6/27/14 | 12 | TUN | CON | 1800 | 231.16 | - | 230.16 | - | 1.00 | | 1 | | NG | 21 | | | | | | | | | | | | ★ | Rod & | | |
| A | 15 6/25/14 1 | 17 WA | S PL | 200 | 231.01 | - | 228.24 | ÷ | 2.77 | 0 | \leftrightarrow | | NG | - | 40* | 6/27/14 | 12 | TUN | CON | 1800 | 231.17 | - | 230.17 | - | 1.00 | | \$ | | NG | - | | | 1.273 | | | | | | | | | | Rod & | | |
| 1 1 1 0 2 2 2 2 0 | 16 6/25/14 1 | I <mark>7</mark> FM | MET | 300 | 231,11 | | 227.80 | - | 3.31 (| \overline{o} | \leftrightarrow | Rod & | NG | | 41 | 7/2/14 | 19 | TUN | CON | 3750 | 231.42 |) | 230.47 | | 0.95 | | 1 | | NG | - | | | . 22 | | | | | | | | | | Rod & | | |
| | 17 * 6/25/14 1 | I7 EX | - | - | 231.74 | 229.48 | - | 2.26 | - | - | - | Rod & | NG | -1 | 42 | 7/2/14 | 19 | TUN | CON | 3750 | 231.42 | | 230.47 | - | 0.95 | | Ì | Rod & | NG | - | | | | | | | | | | | | | Rod & | | - |
| | | 11 W | - | 200 | 230.89 | - | 227.68 | _ | 3.21 (| \overline{o} | \leftrightarrow | Rod & | NG | - | 43* | 7/2/14 | 19 | EXP | - | - | 231.41 | 225.41 | - | 6.00 | - | - | - | Rod & | NG | - | | | | | | _ | | | | | | | Rod & | | |
| | | | | | | ASE SE | | PAGE | | ~ | | Udp | | | * | | | | | | | | ENOTES | | : | | | Udp | | \dashv | | | | | | OPMATH | | | | | | | Сар | | |


| | 150 WM | WATERMAIN | 150 WM | ¢` | CURB STOP | • | INF | INFLUENT | | LOCATION APPROVED | | | | | | | | PROFESSIONAL |
|---|------------|---------------------|----------|----------|---------------|--------------|----------|----------------|-----|--|-----------------------------------|----------|-----|--------------------|-------------|------------------------------|---------|----------------------|
| - | -0- | HYDRANT | + | | REDUCER | | EFF | EFFLUENT | | UNDERGROUND STRUCTURES | | | | (↓ 🥒 | utility | | | |
| 0 | ⊗ | VALVE | ۲ | X | COUPLING | x | PS | PRIMARY SLUDGE | | | | | | | | AEC | | |
| 0 | 300 LDS | LAND DRAINAGE SEWER | 300 LDS | ۶ | ANODE | ~ | RS | RAW SEWAGE | | SUPR. U/G STRUCTURES DATE | | | | | ineers | | | |
| | 250 WWS | WASTE WATER SEWER | 250 WWS | • • | LAMP STANDARD | | | | | | | | | 1-855-222-T2UE W | WW.T2UE.COM | | | Original Sta |
| | 0 | MANHOLE | | \odot | TREE | | | | | NOTE: LOCATION OF UNDERGROUND STRUCTURES | | | | | | CHECKED | RG , JB | L.E. AR(Jan. 19, |
| Ĺ | | CATCH BASIN | | Онр | HYDRO POLE | | | | | AS SHOWN ARE BASED ON THE BEST | 5 ISSUED FOR CITY OF WINNIPEG USE | 15/01/19 | AJW | | | | | Jan. 19, |
| L | | CURB INLET | | <u>+</u> | BENCH MARK | | | | | INFORMATION AVAILABLE. BUT NO GUARANTEE IS GIVEN THAT ALL EXISTING | 4 FINAL REVIEW | 14/08/25 | AJW | DRAWN BY | AJW | APPROVED BY | LEA | |
| | | CULVERT | | INV | INVERT | | | | | UTILITIES ARE SHOWN OR THAT THE GIVEN | 3 REVISED TENDER | 14/06/13 | AJW | | | | | _ |
| L | | PIPE ABANDONMENTS | _ | OBV | OBVERT | | | | | LOCATIONS ARE EXACT. CONFIRMATION OF EXISTENCE AND EXACT LOCATION OF ALL | 2 ISSUED FOR TENDER | 14/04/03 | AJW | HOR. SCALE | NTS | RELEASED FOR CONSTRUCTION | | CONSULTANT |
| Ē | + ste | SURVEY BAR | | | | | | | | SERVICES MUST BE OBTAINED FROM THE INDIVIDUAL UTILITIES BEFORE PROCEEDING | 1 PRELIMINARY REVIEW | 14/03/04 | AJW | VERT. SCALE | | | | 6031 <i>°</i> |
| Ċ | DNITSIXA G | LEGEND - PLAN | NEW | EXISTING | LEGEND - PLAN | NEW | EXISTING | LEGEND - PLAN | NEW | | NO. REVISIONS | YY/MM/DD | BY | DATE | 28-OCT-14 | DATE | | T2UE DRAV 61000 |

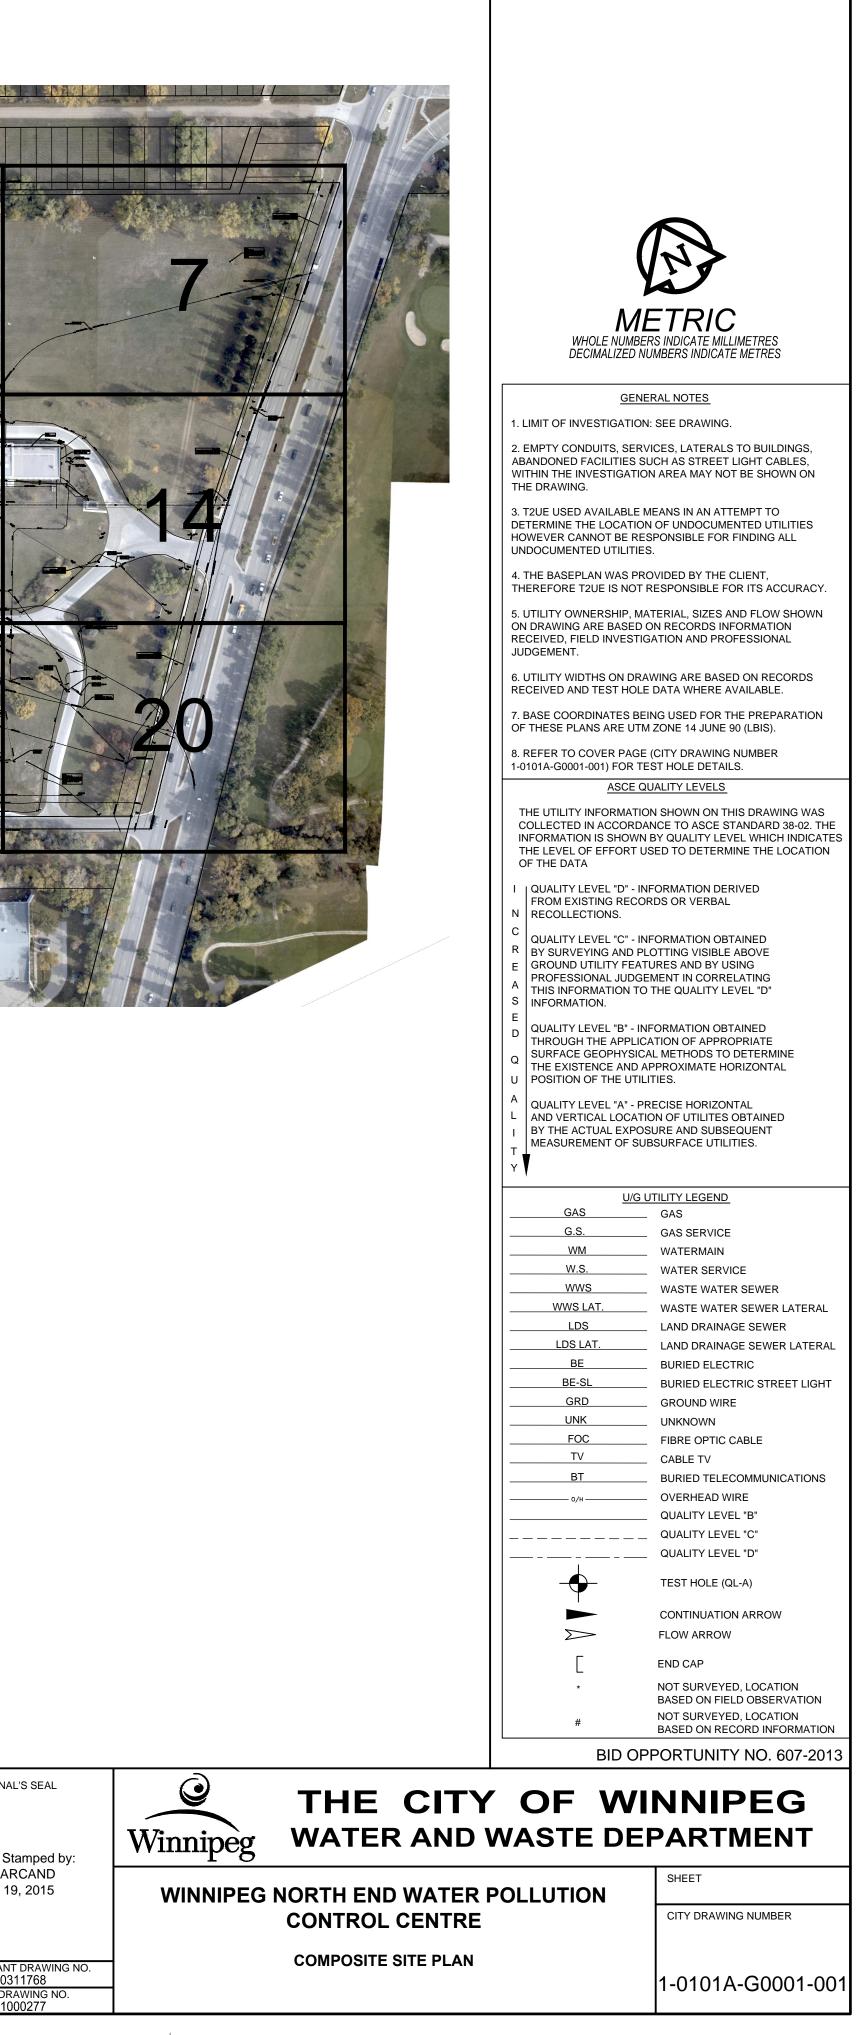








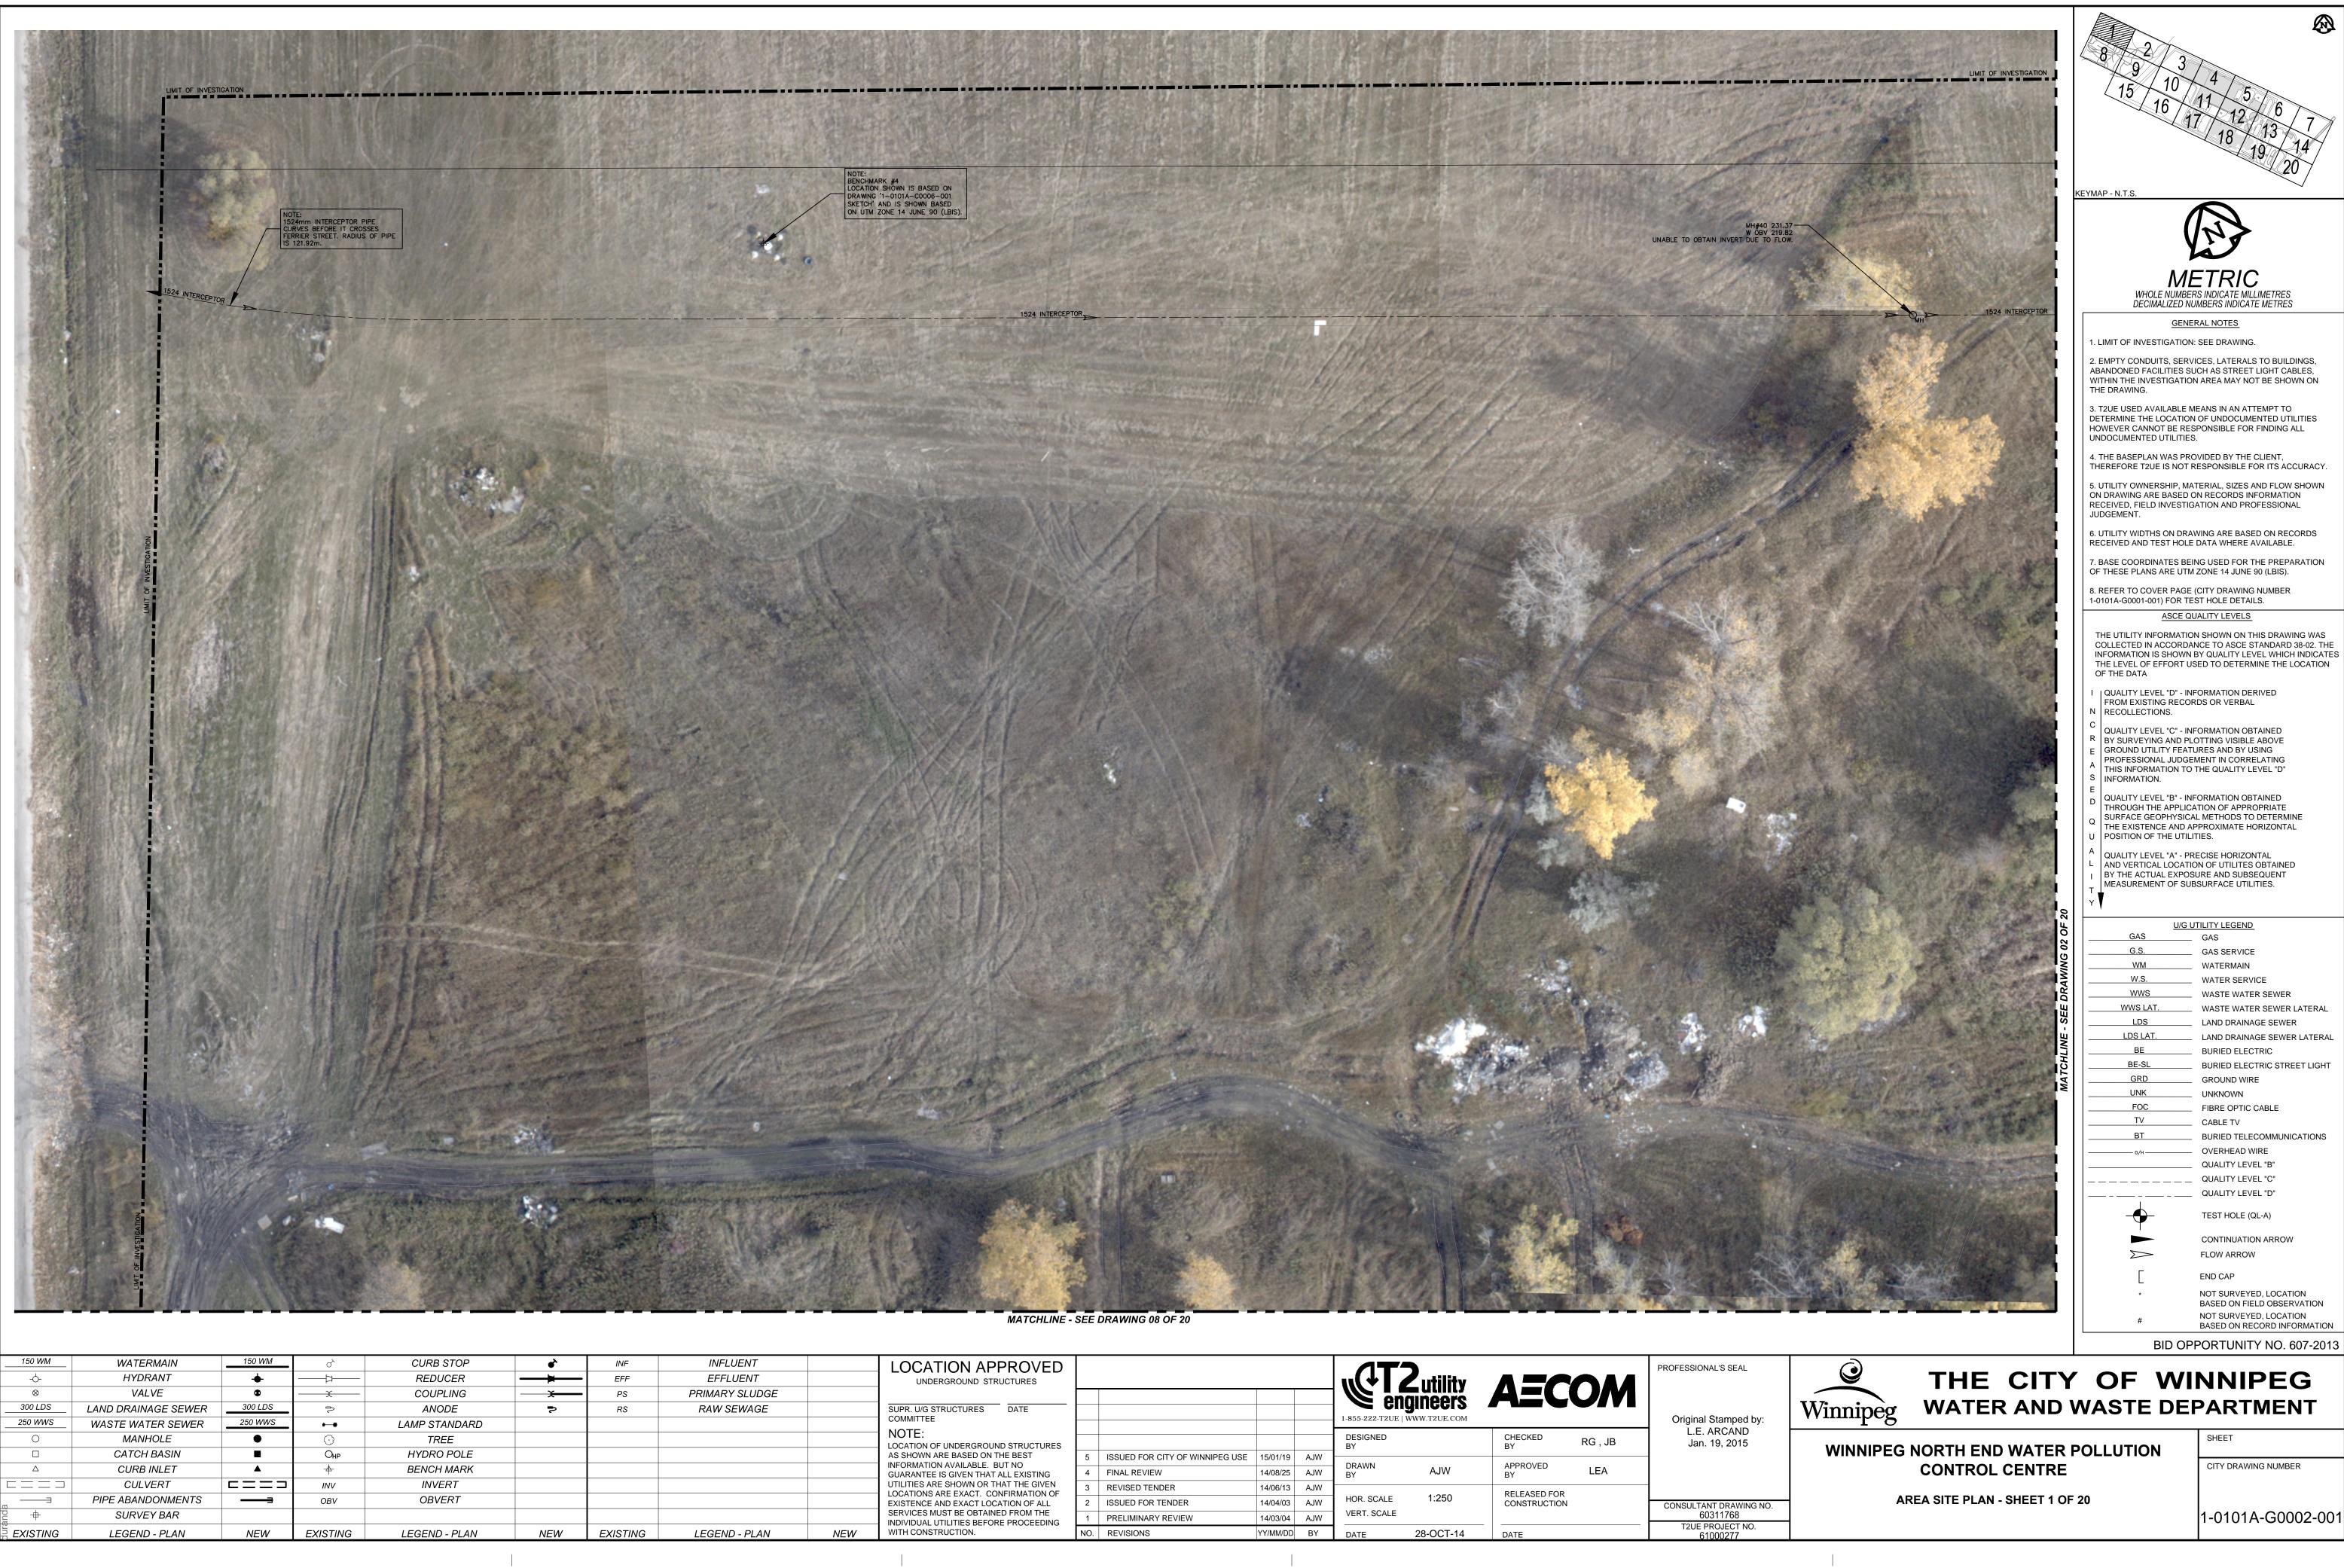

| 150 WM | WATERMAIN | 150 WM | o ^ک | CURB STOP | • | INF | INFLUENT | |
|----------|---------------------|---------|----------------|---------------|--------------|----------|----------------|--|
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| ⊗ | VALVE | 0 | —X | COUPLING | — X — | PS | PRIMARY SLUDGE | |
| 300 LDS | LAND DRAINAGE SEWER | 300 LDS | ĥ | ANODE | • | RS | RAW SEWAGE | |
| 250 WWS | WASTE WATER SEWER | 250 WWS | ** | LAMP STANDARD | | | | |
| 0 | MANHOLE | • | \odot | TREE | | | | |
| | CATCH BASIN | | Онр | HYDRO POLE | | | | |
| | CURB INLET | | + | BENCH MARK | | | | |
| | CULVERT | | INV | INVERT | | | | |
| | PIPE ABANDONMENTS | | OBV | OBVERT | | | | |
| | SURVEY BAR | | | | | | | |
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| | LOCATION APPROVED UNDERGROUND STRUCTURES SUPR. U/G STRUCTURES COMMITTEE | | | | | | Zutility gineers www.t2ue.com | AEC | OM | PROFESSIONAL'S |
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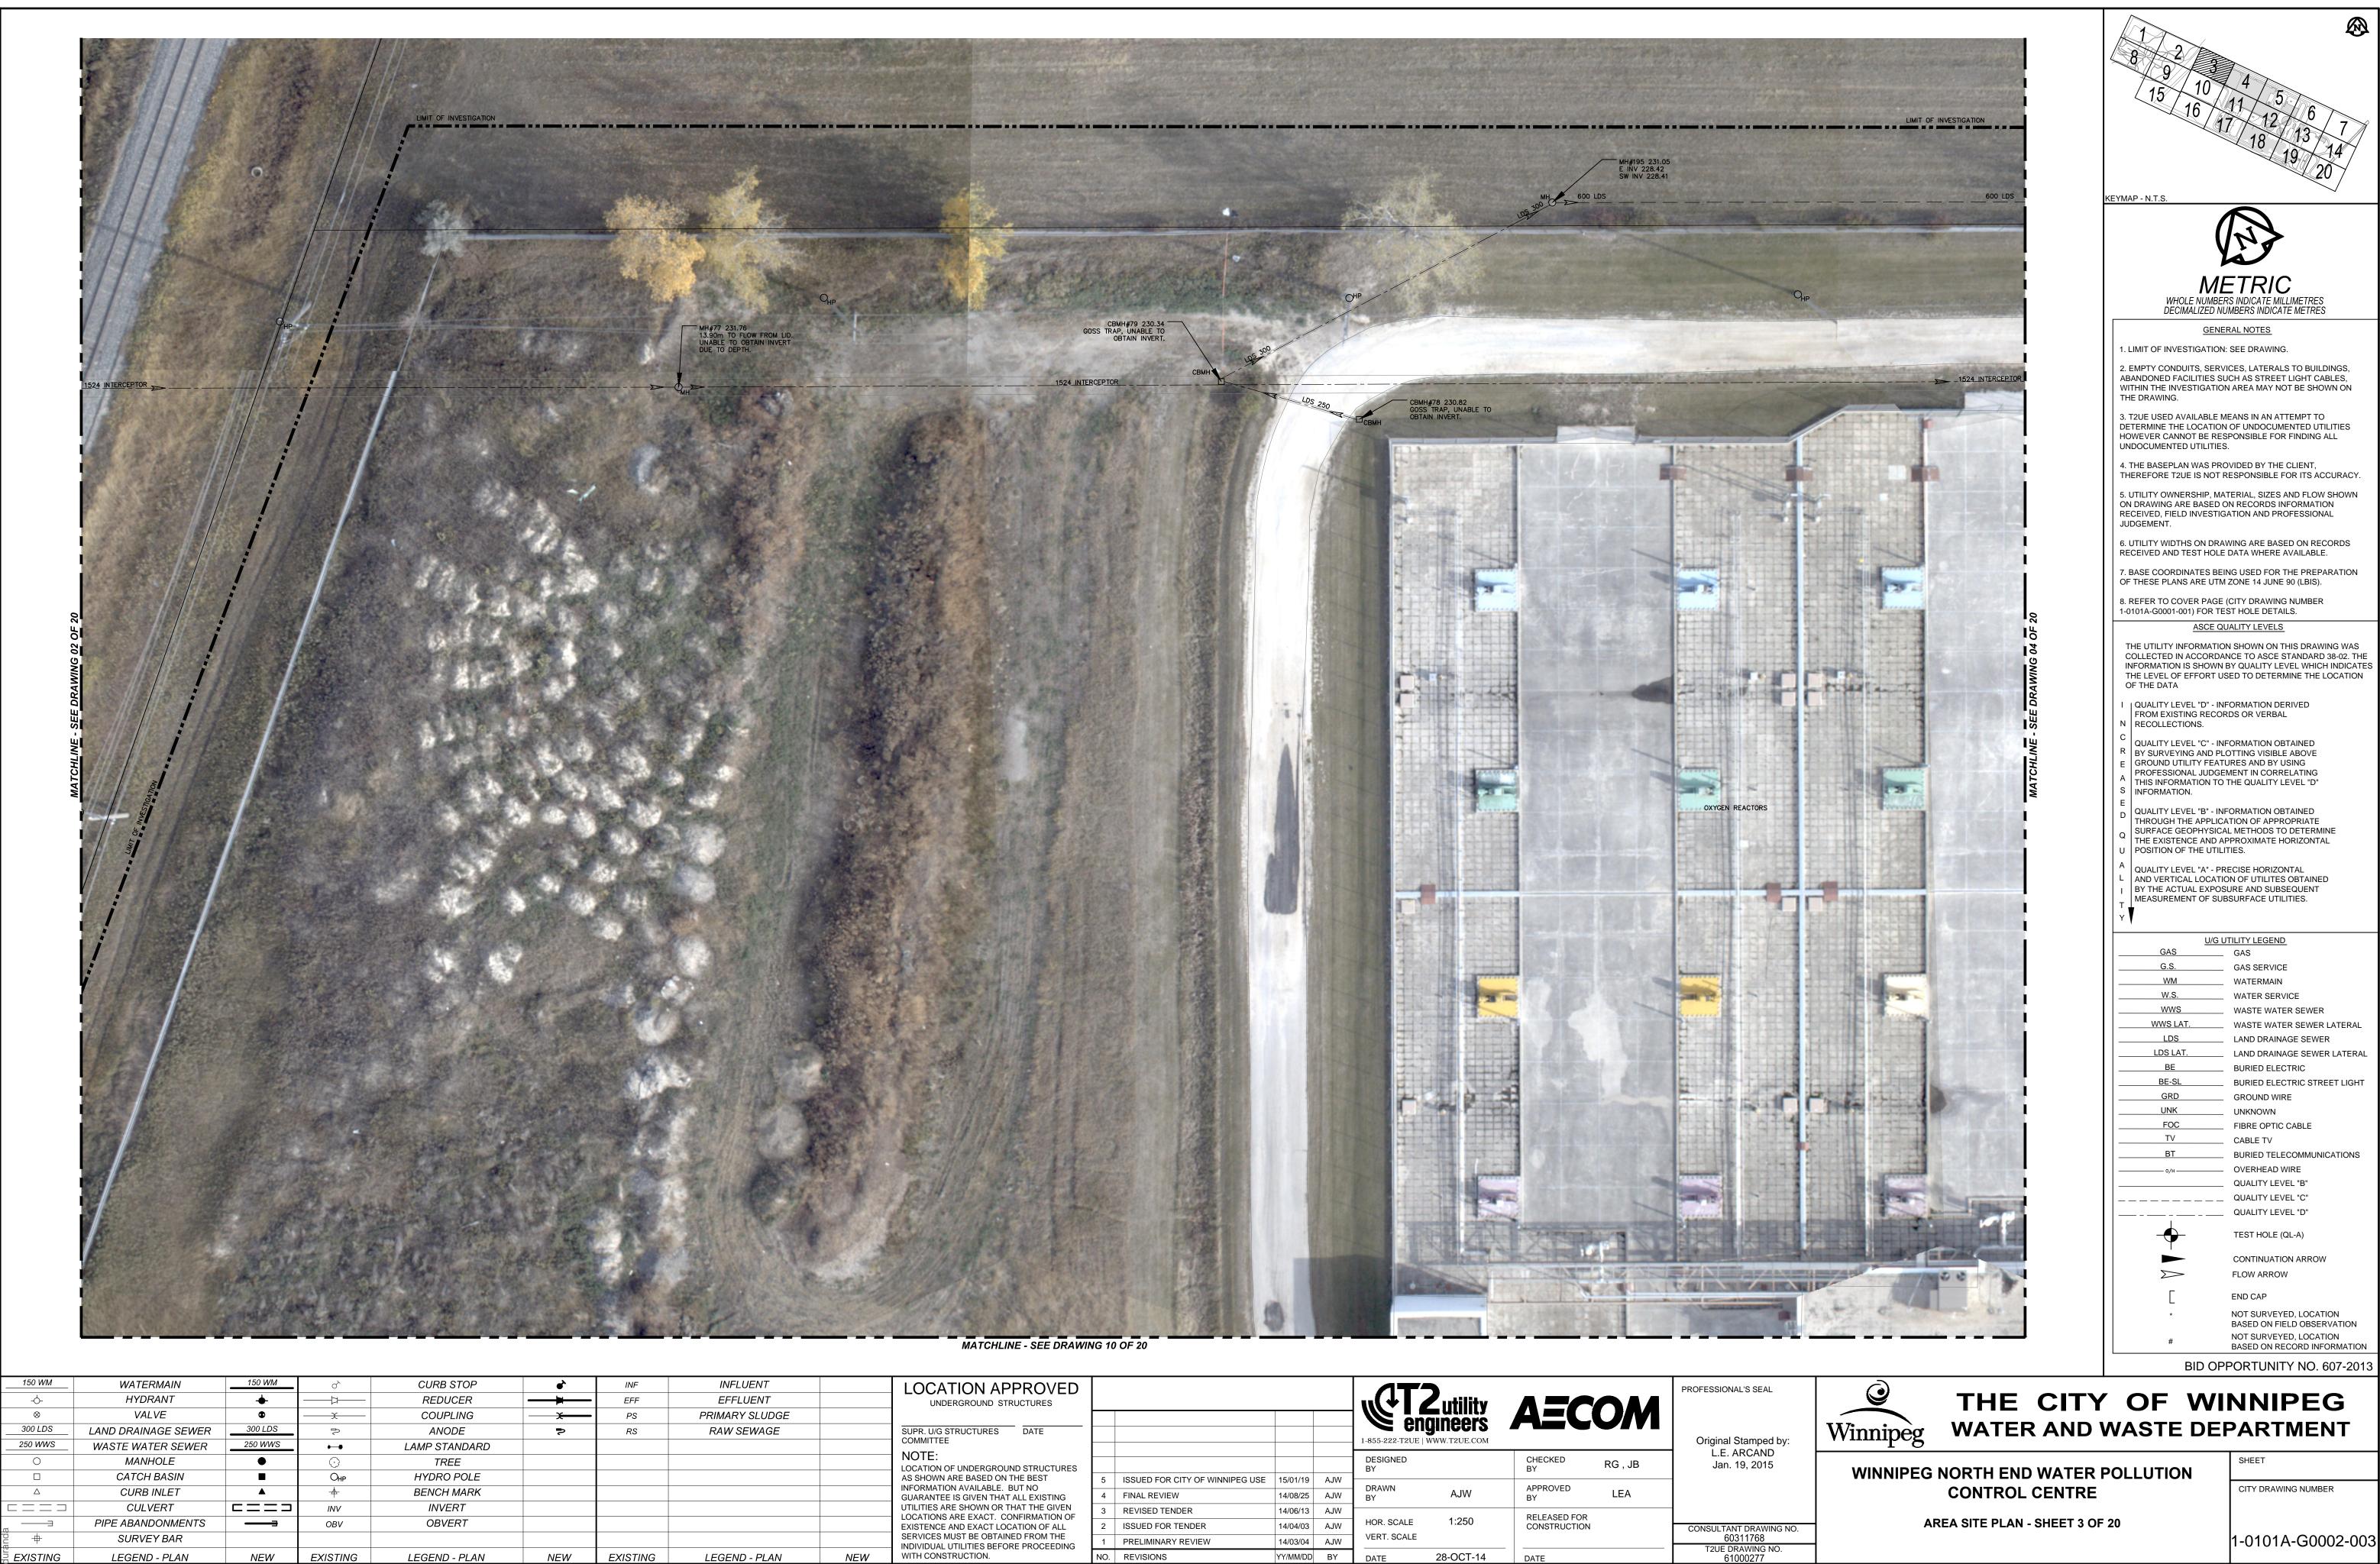




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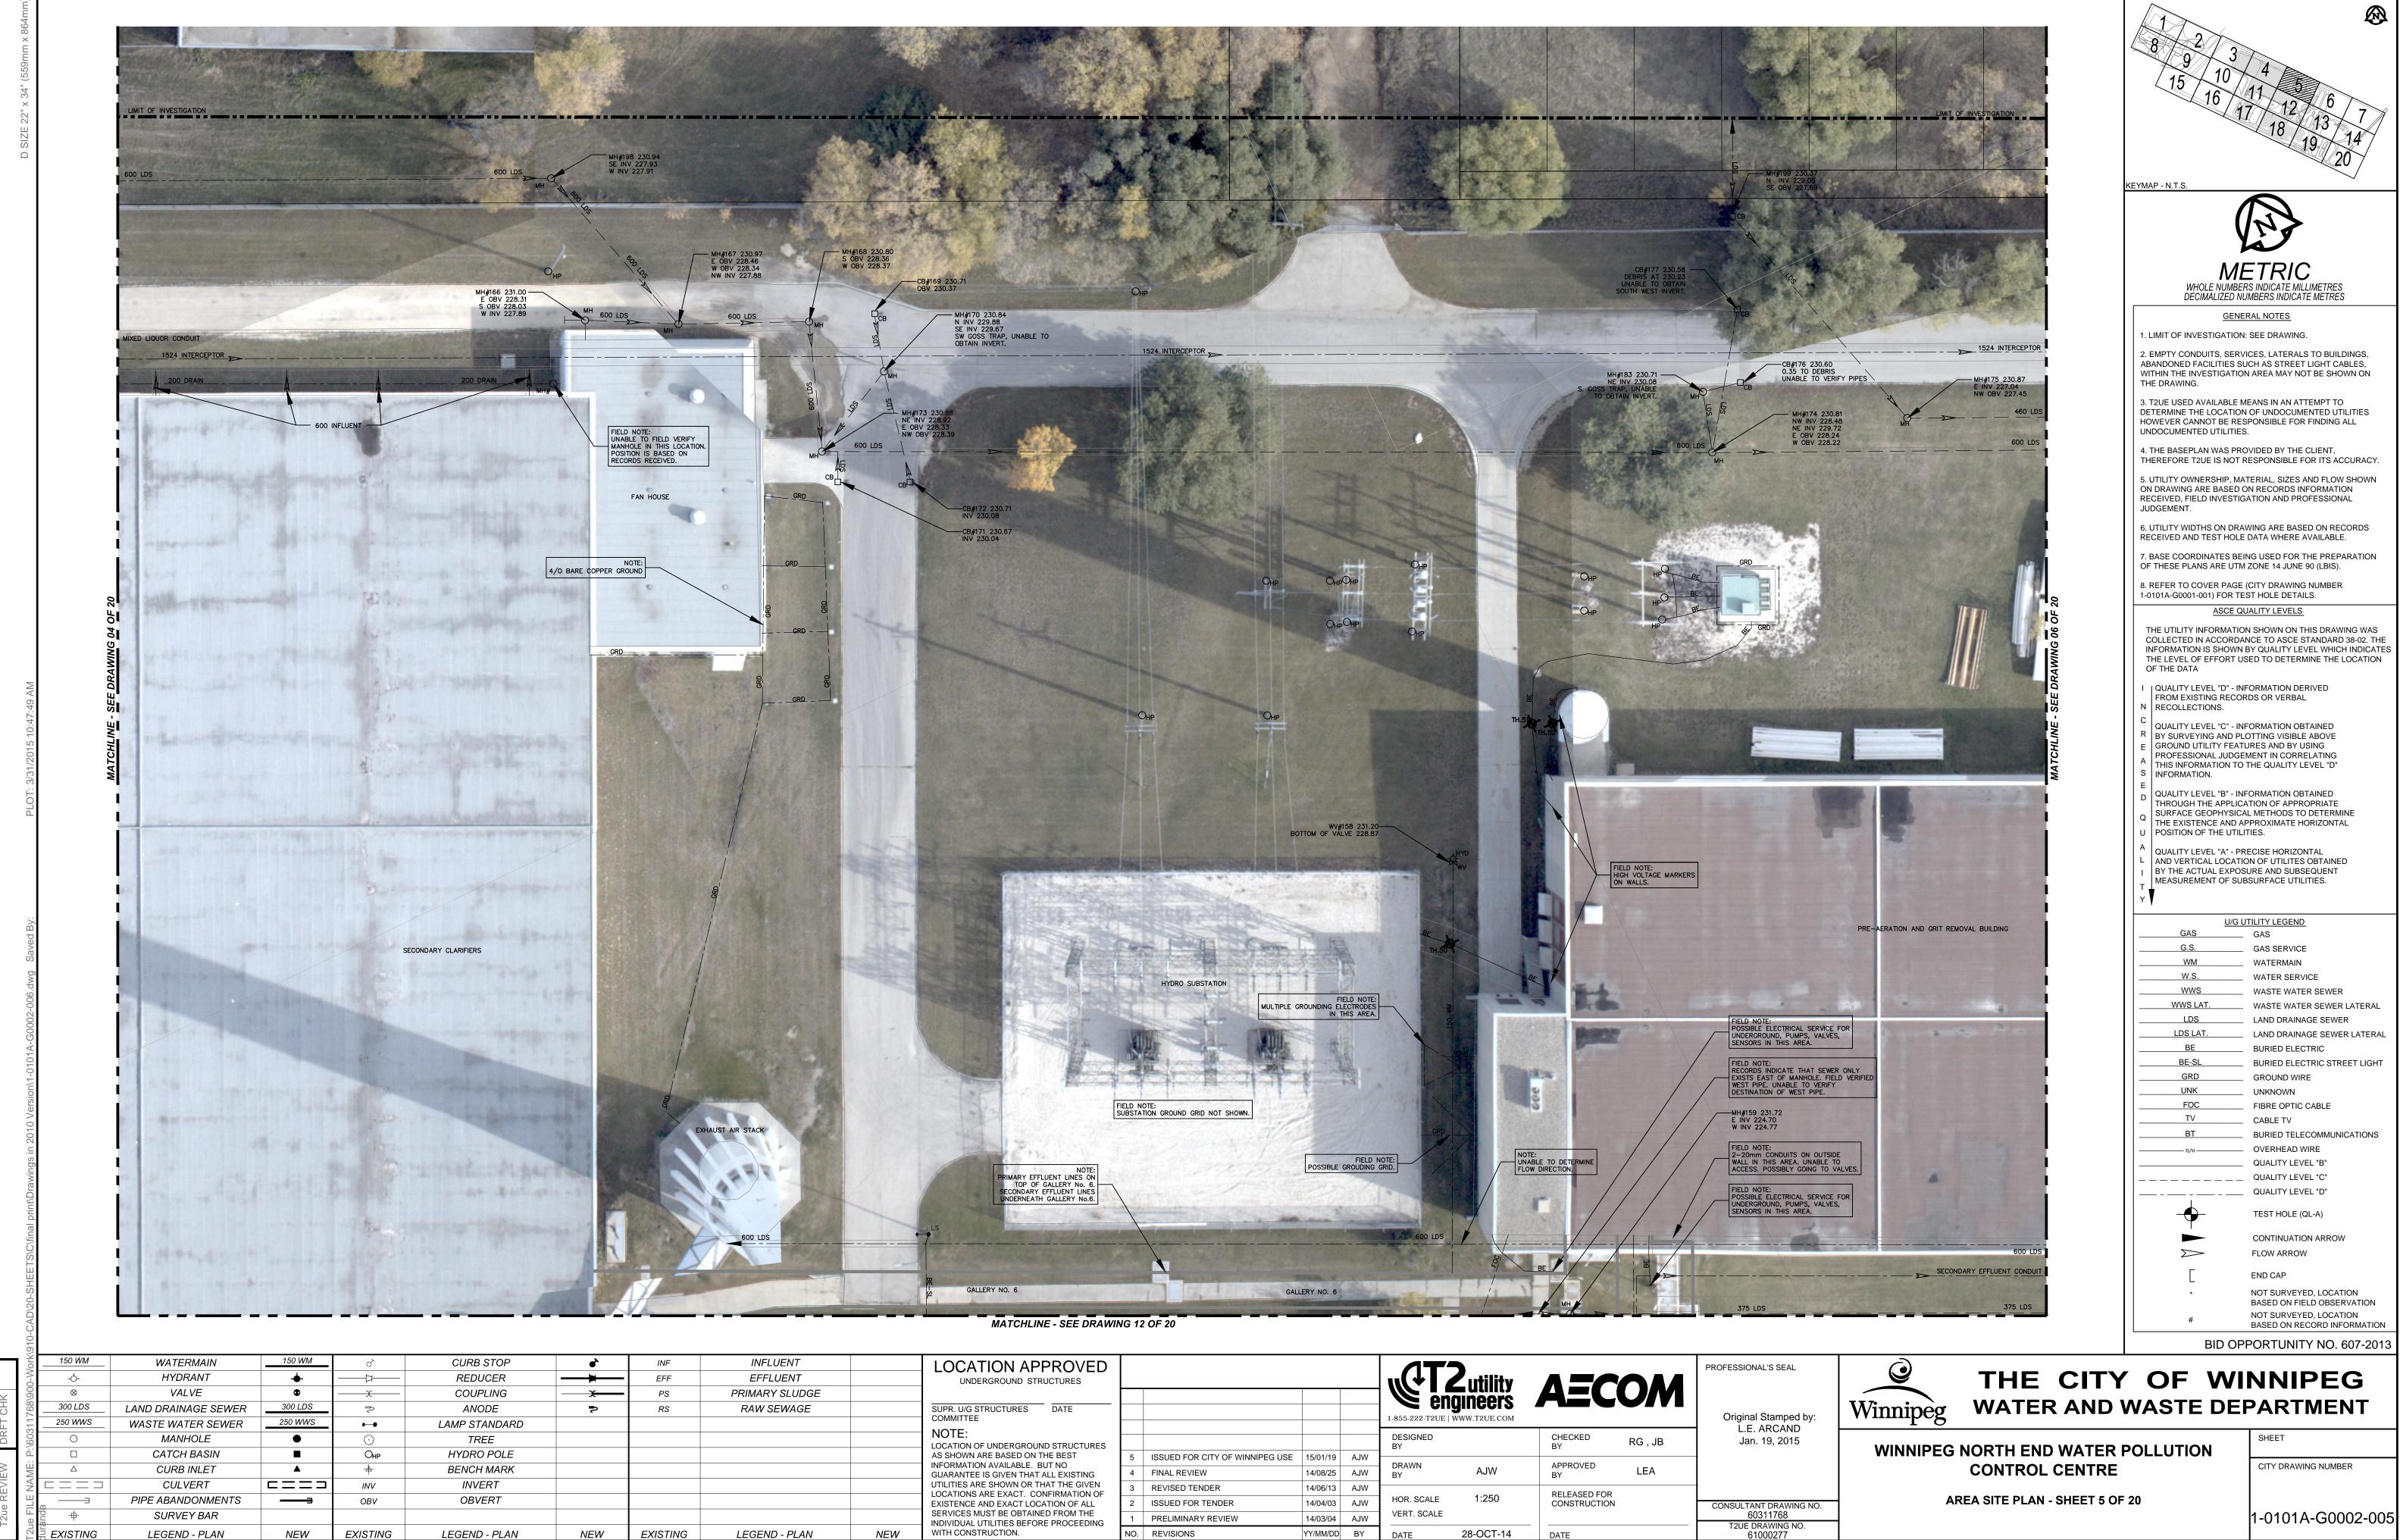
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| | SUPR. U/G STRUCTURES DATE COMMITTEE | | | | | 1-855-222-T2UE | - | AEC | | Original Star |
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SURVEY BAR EXISTING LEGEND - PLAN
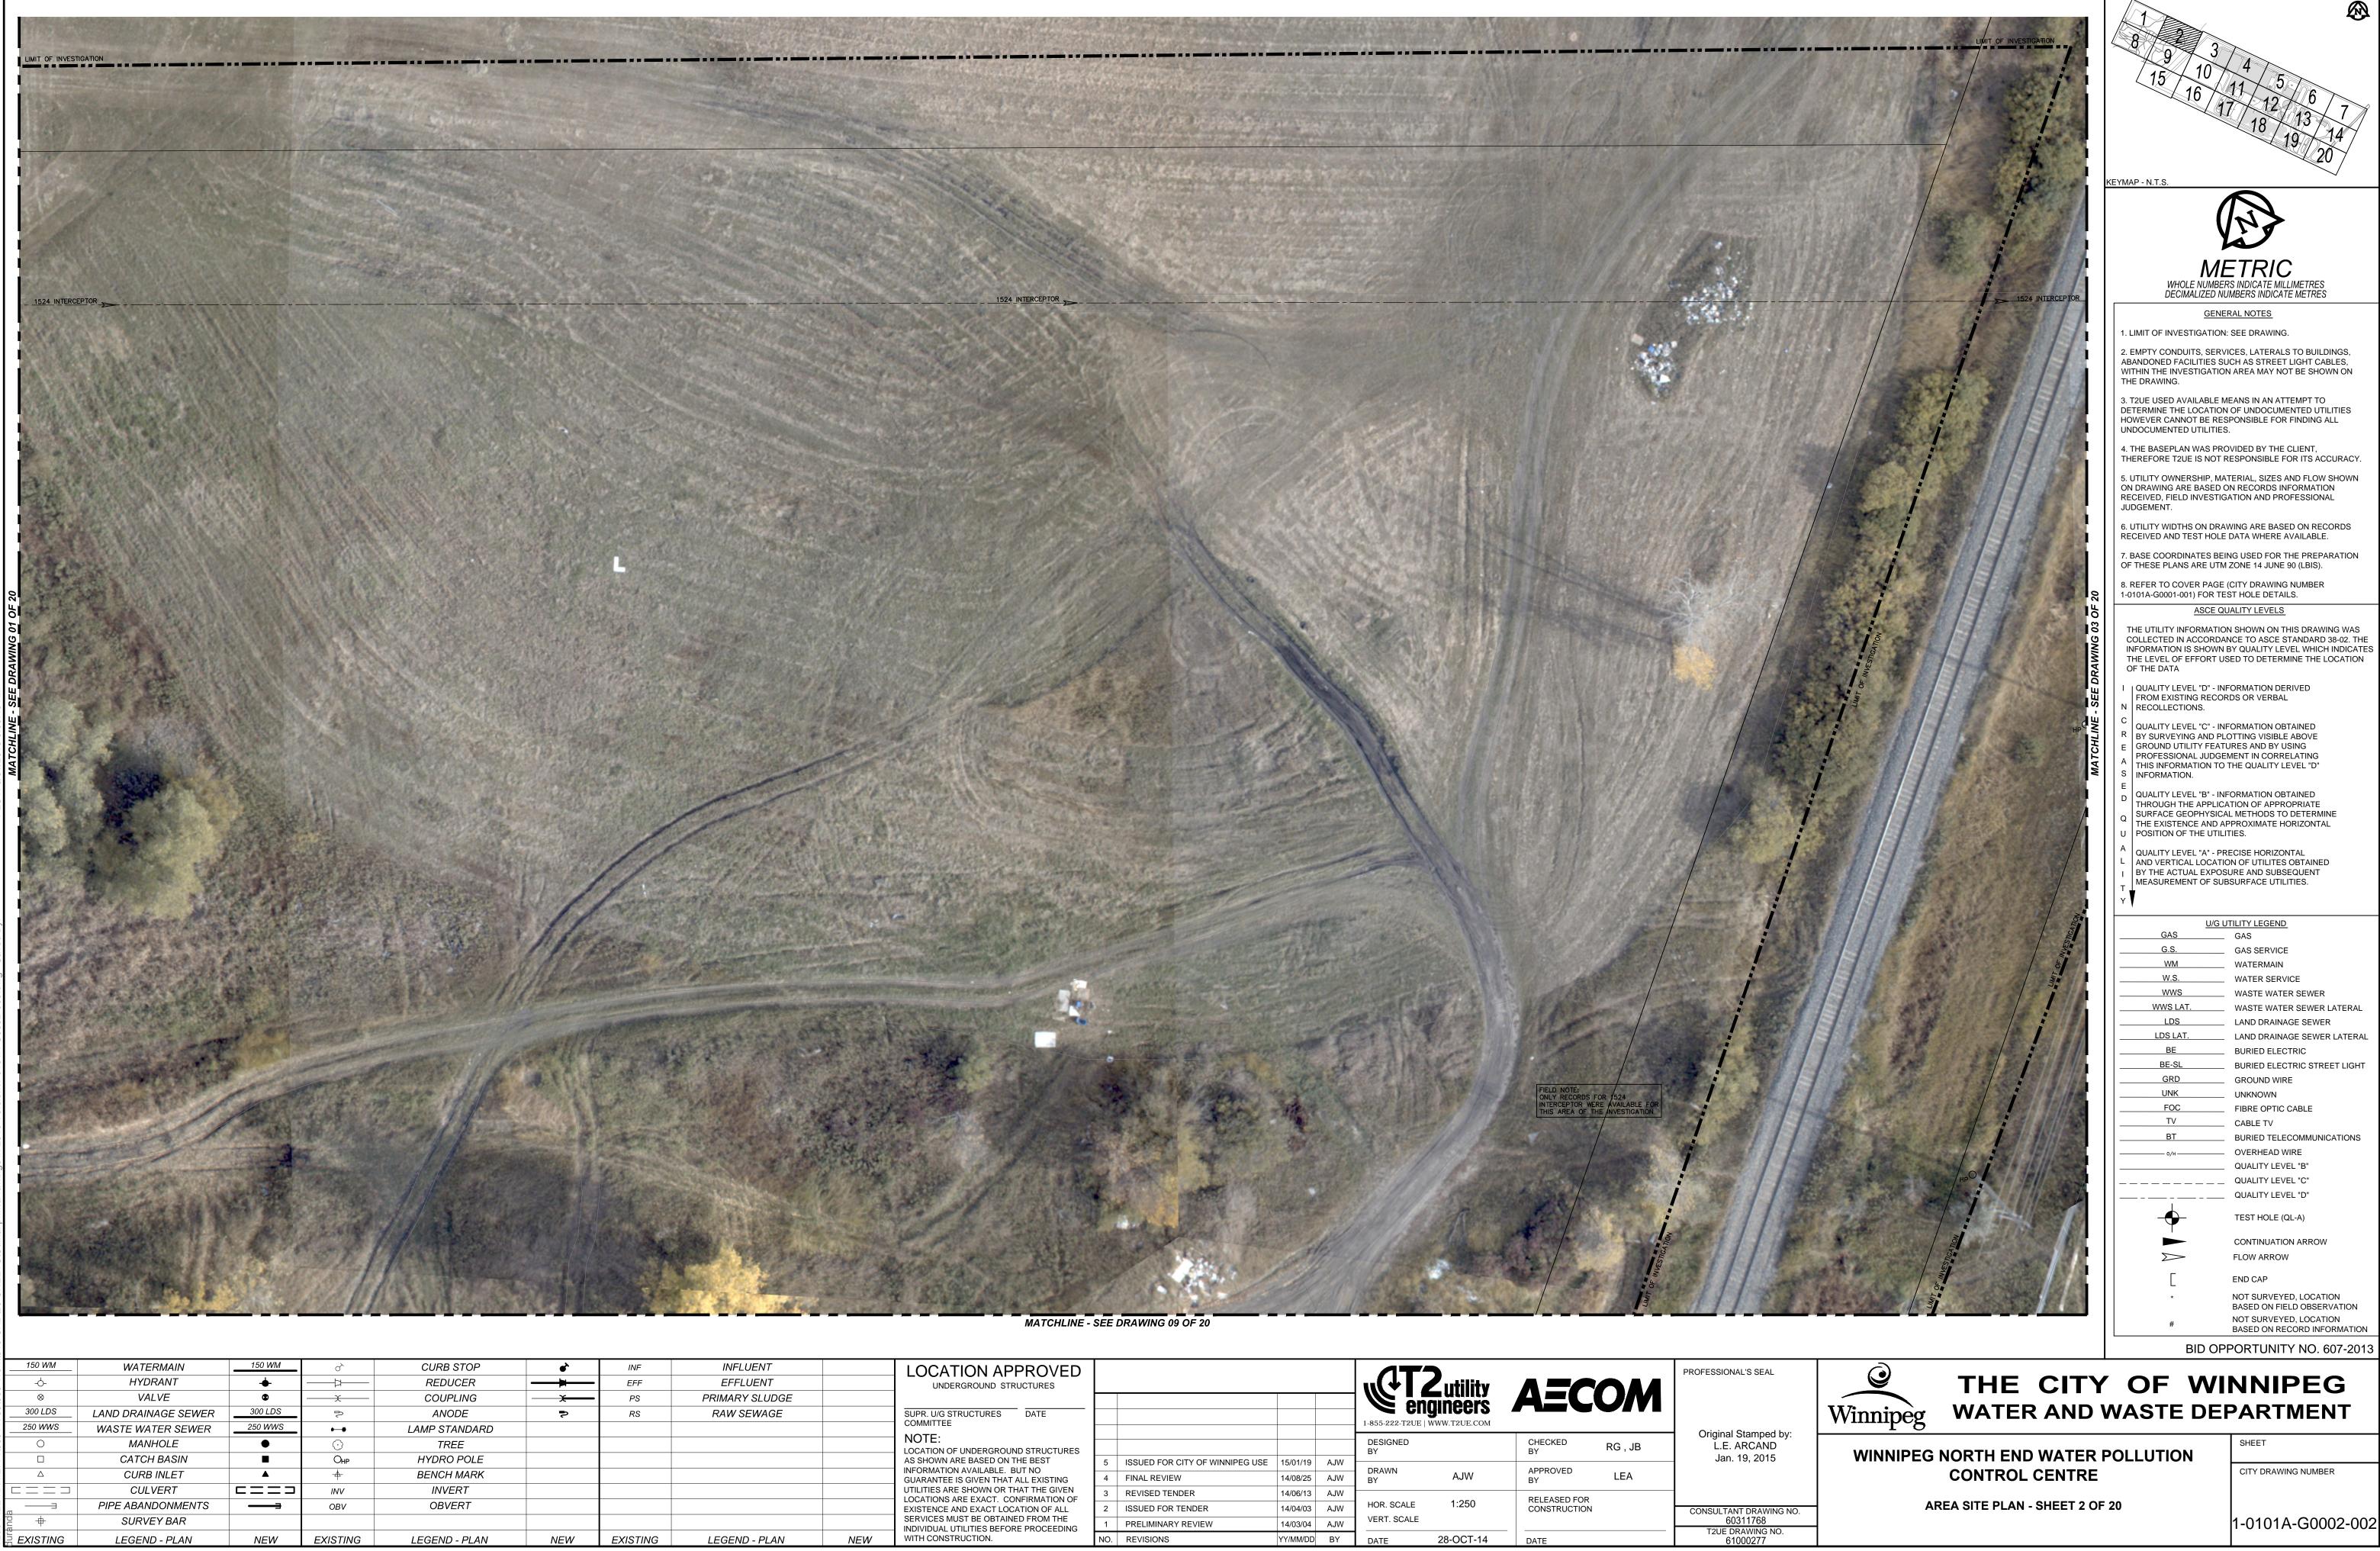
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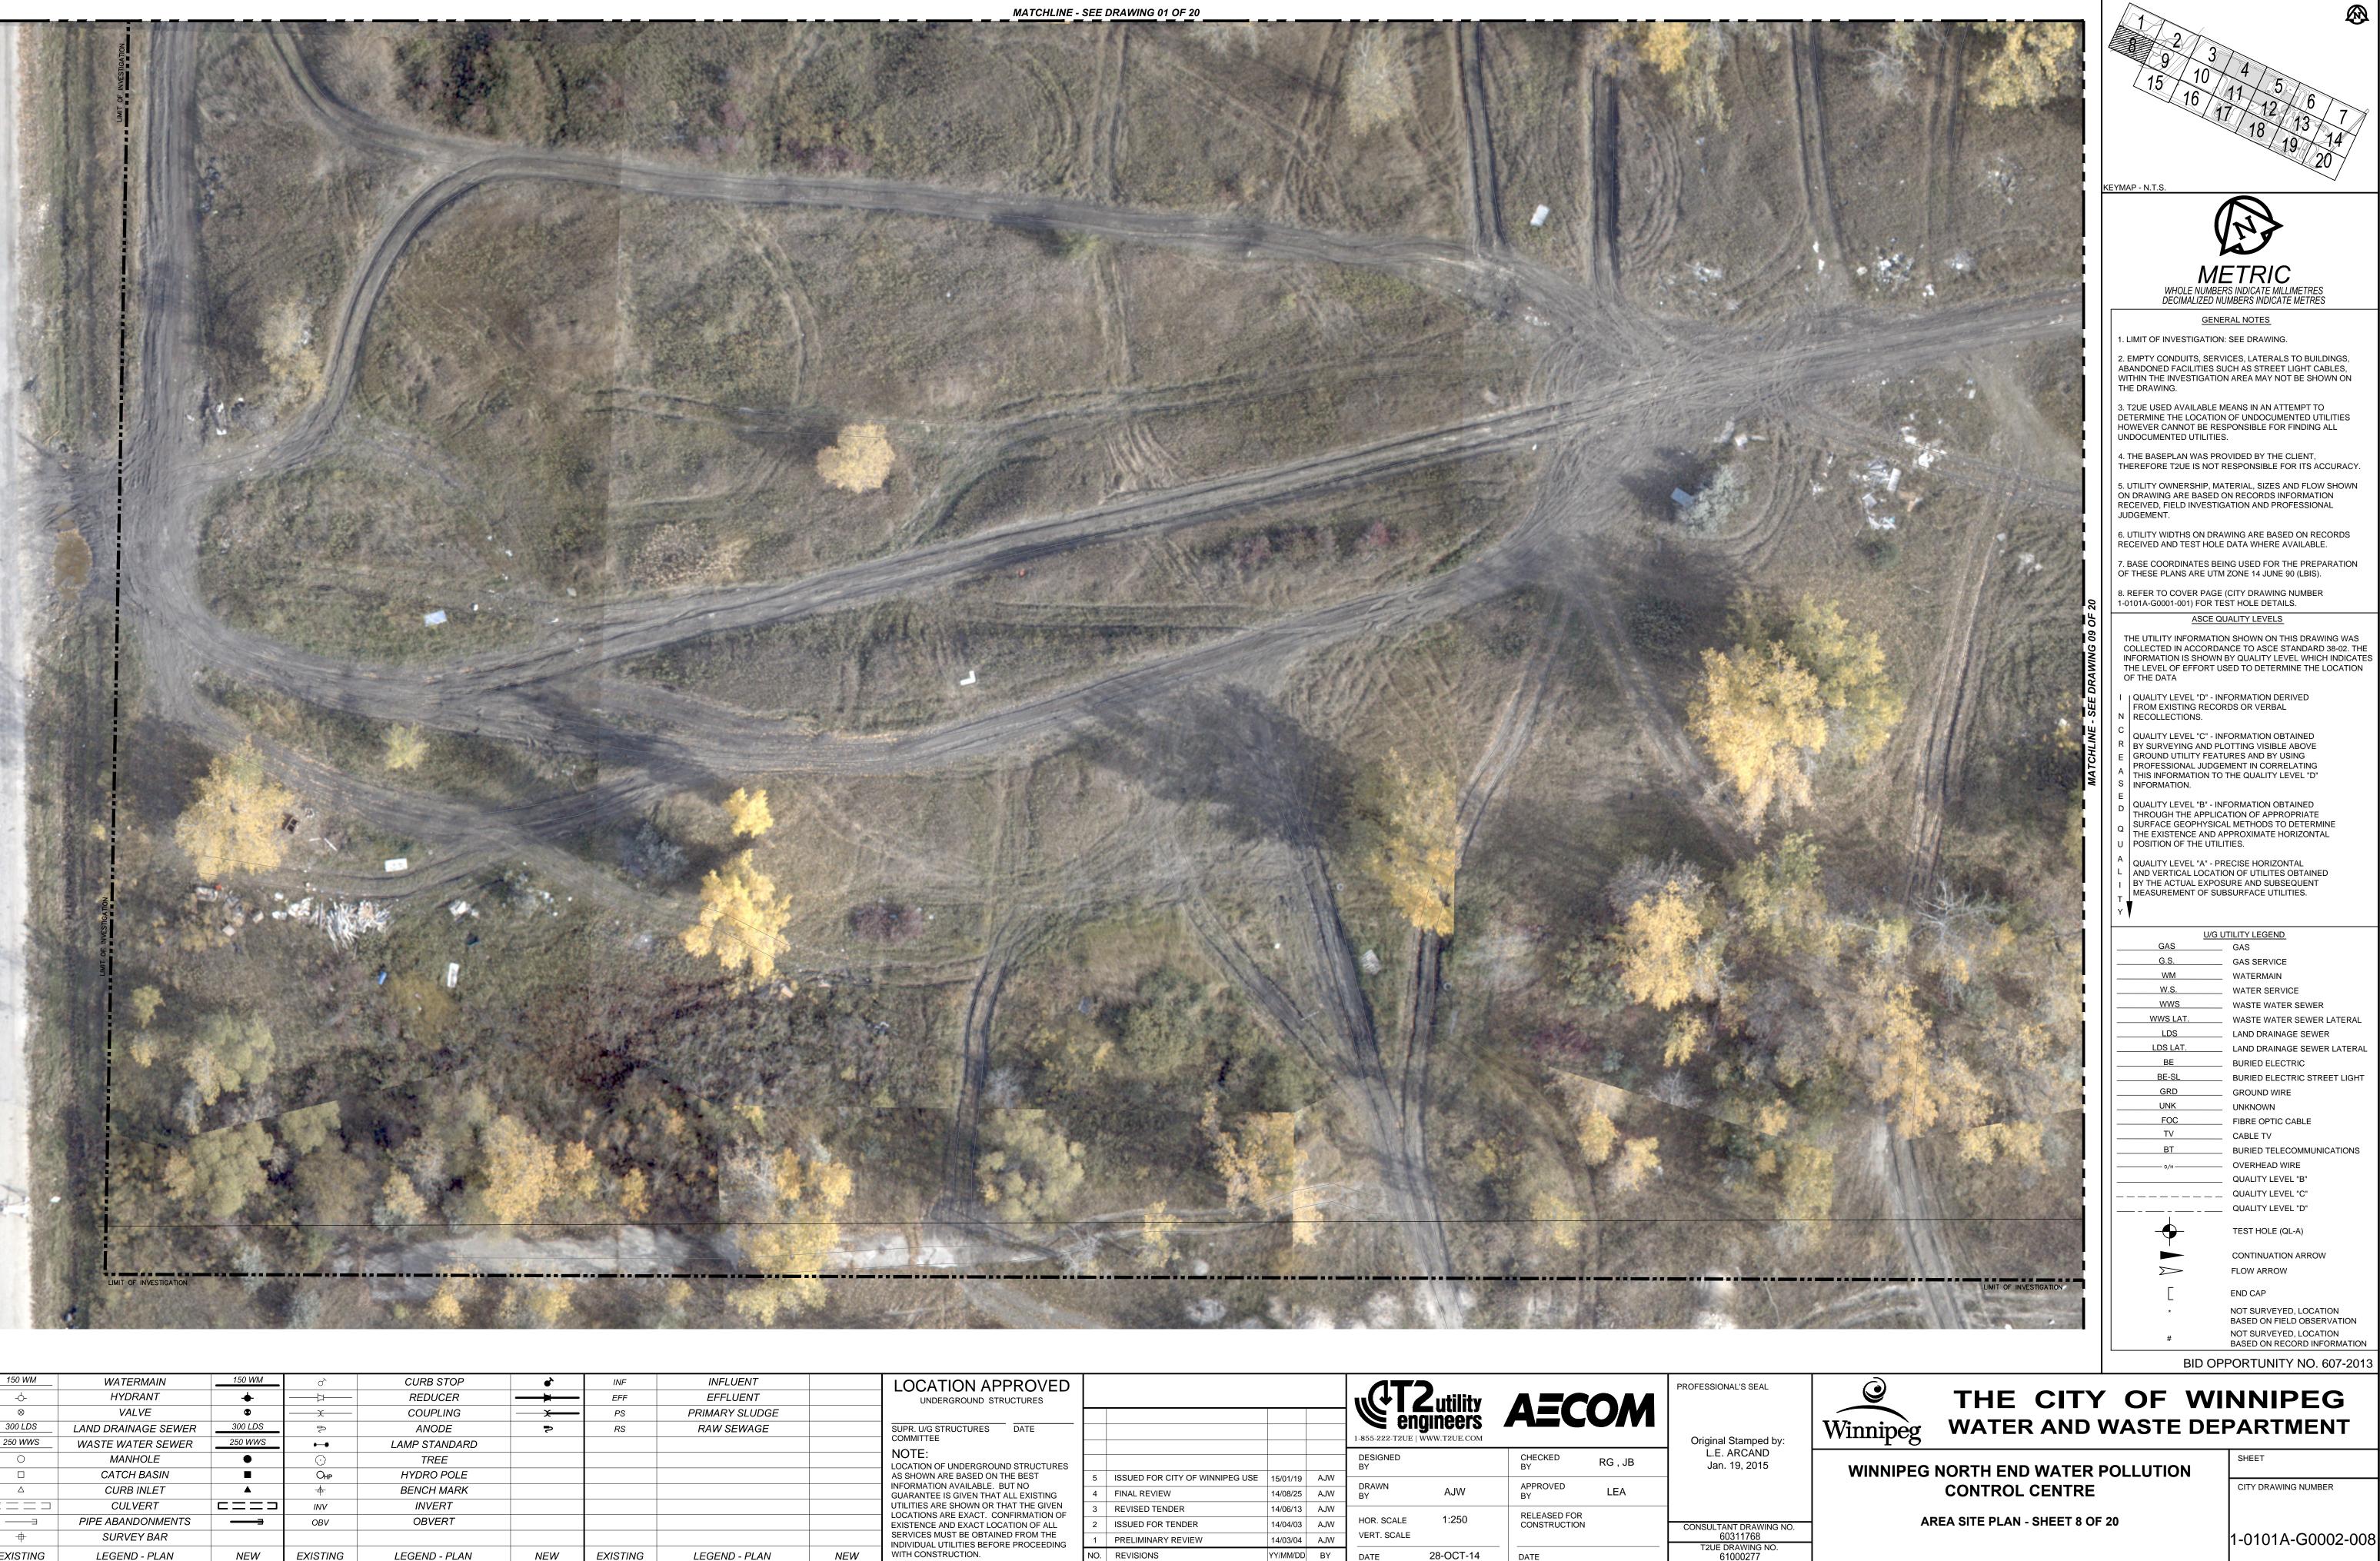
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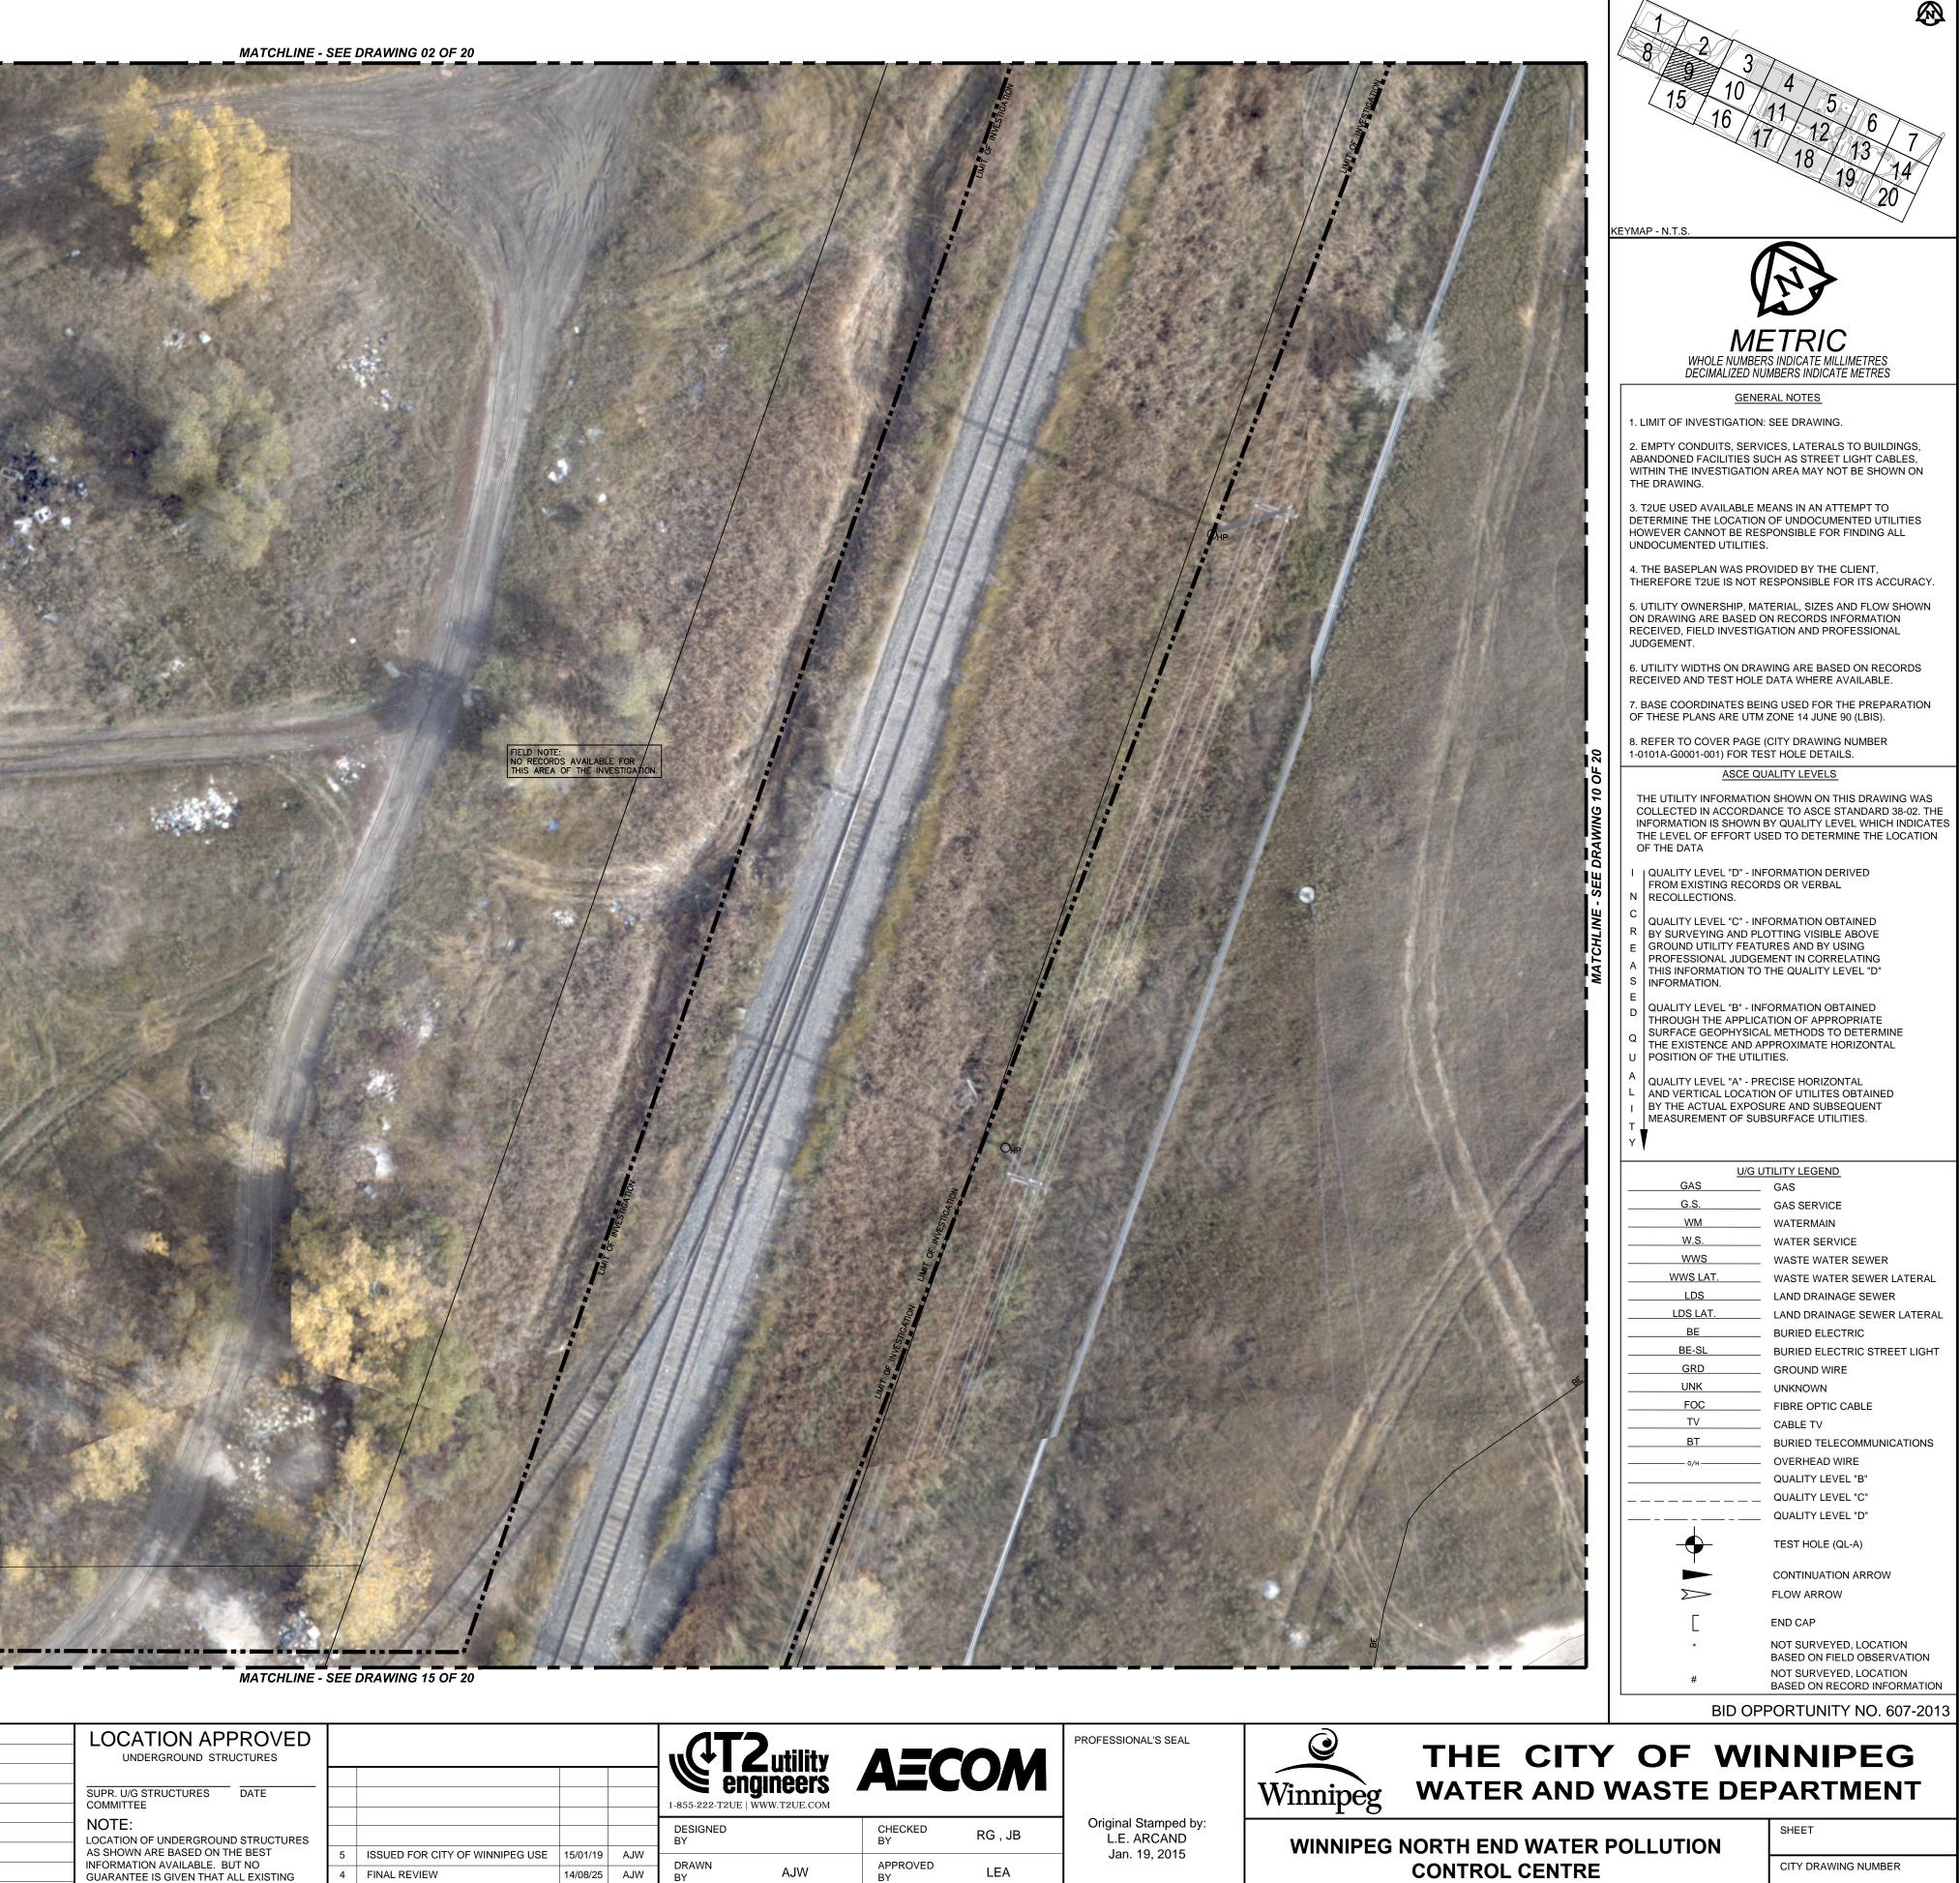


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| LOCATION APPROVED UNDERGROUND STRUCTURES SUPR. U/G STRUCTURES COMMITTEE | | | | | 1-855-222-T2UE | 3 | AEC | OM | PROFESSIONAL'S Original Stan |
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| SERVICES MUST BE OBTAINED FROM THE | 1 | PRELIMINARY REVIEW | 14/03/04 | AJW | VERT. SCALE | | | | 603117 |
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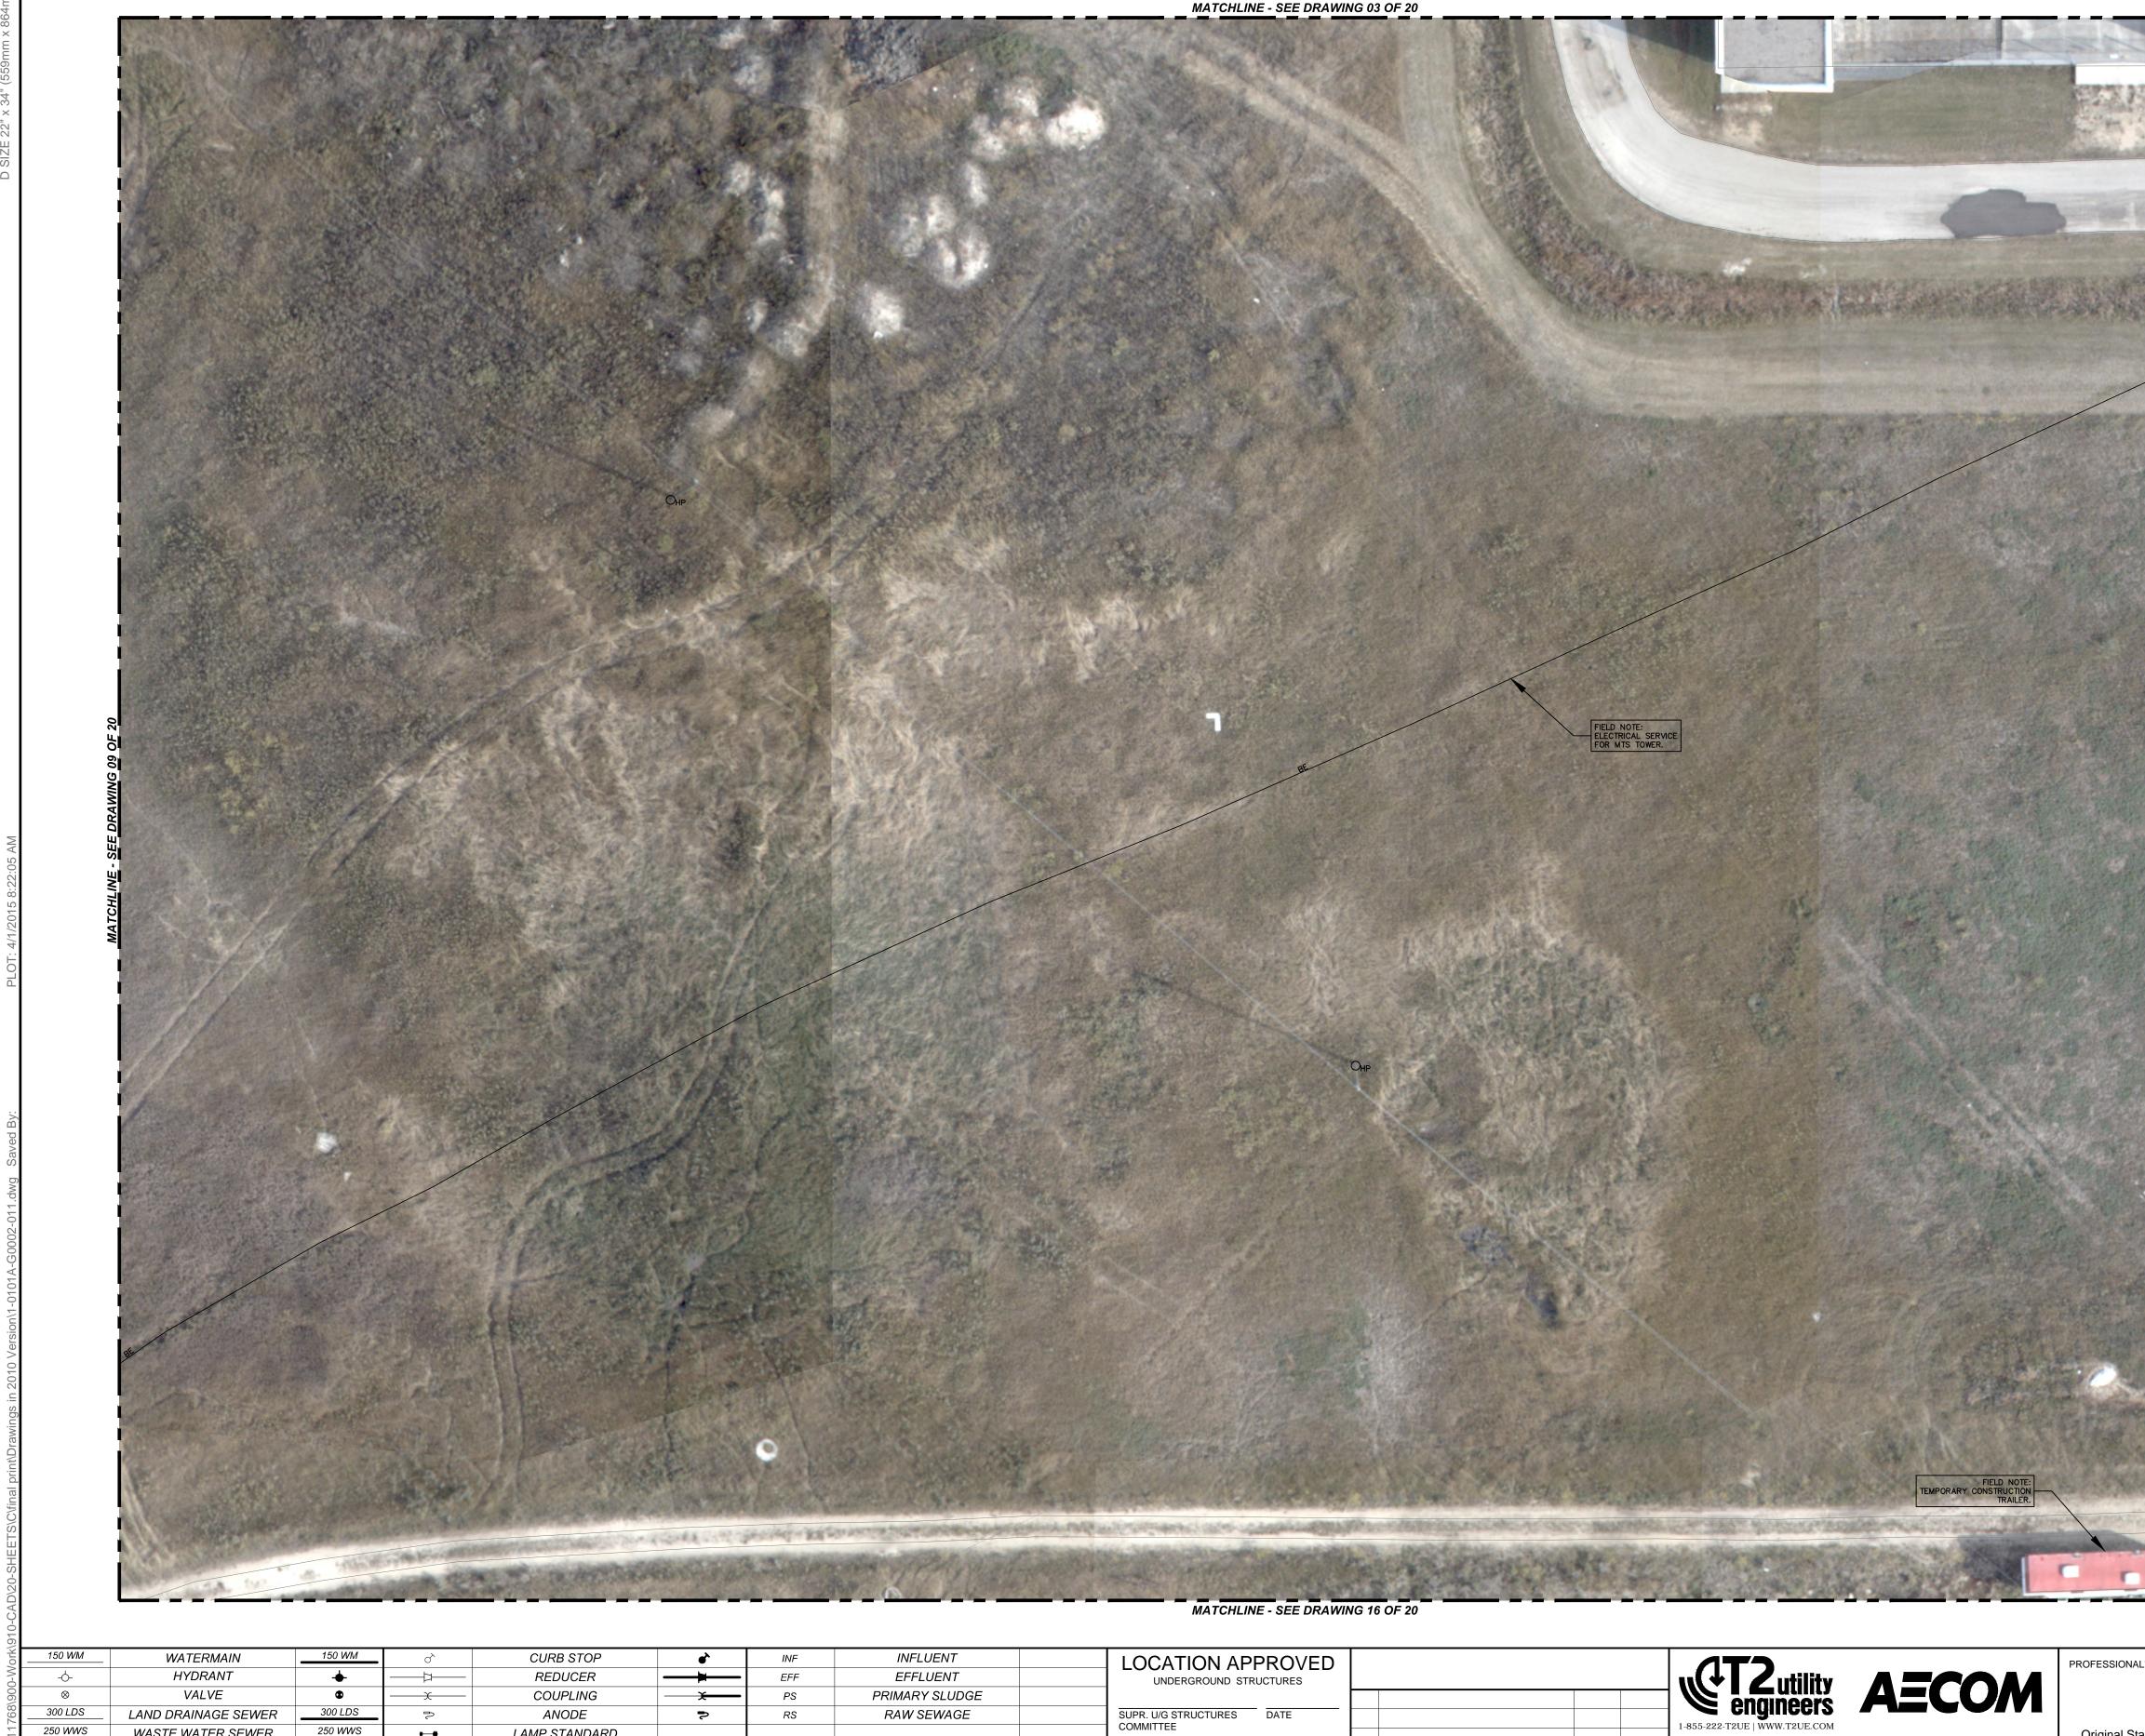


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| | WATERMAIN HYDRANT VALVE LAND DRAINAGE SEWER WASTE WATER SEWER MANHOLE CATCH BASIN | | → → → → · → · | REDUCER COUPLING ANODE LAMP STANDARD TREE HYDRO POLE | — ► — X | EFF PS | EFFLUE PRIMARY S |
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| | LOCATION APPROVED UNDERGROUND STRUCTURES | | | | | CT | 2 utility gineers | AEC | OM | PROFESSIONAL'S SEAL |
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| | SUPR. U/G STRUCTURES DATE COMMITTEE | | | | | 1-855-222-T2UE 1 | 3 | | • ••• | |
| | NOTE: LOCATION OF UNDERGROUND STRUCTURES | | | | | DESIGNED BY | | CHECKED BY | RG , JB | Original Stamped by: L.E. ARCAND |
| | AS SHOWN ARE BASED ON THE BEST | 5 | ISSUED FOR CITY OF WINNIPEG USE | 15/01/19 | AJW | | | | | Jan. 19, 2015 |
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| | UTILITIES ARE SHOWN OR THAT THE GIVEN LOCATIONS ARE EXACT. CONFIRMATION OF | 3 | REVISED TENDER | 14/06/13 | AJW | | | RELEASED FOR | | |
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| | SERVICES MUST BE OBTAINED FROM THE INDIVIDUAL UTILITIES BEFORE PROCEEDING | 1 | PRELIMINARY REVIEW | 14/03/04 | AJW | VERT. SCALE | | | | 60311768 |
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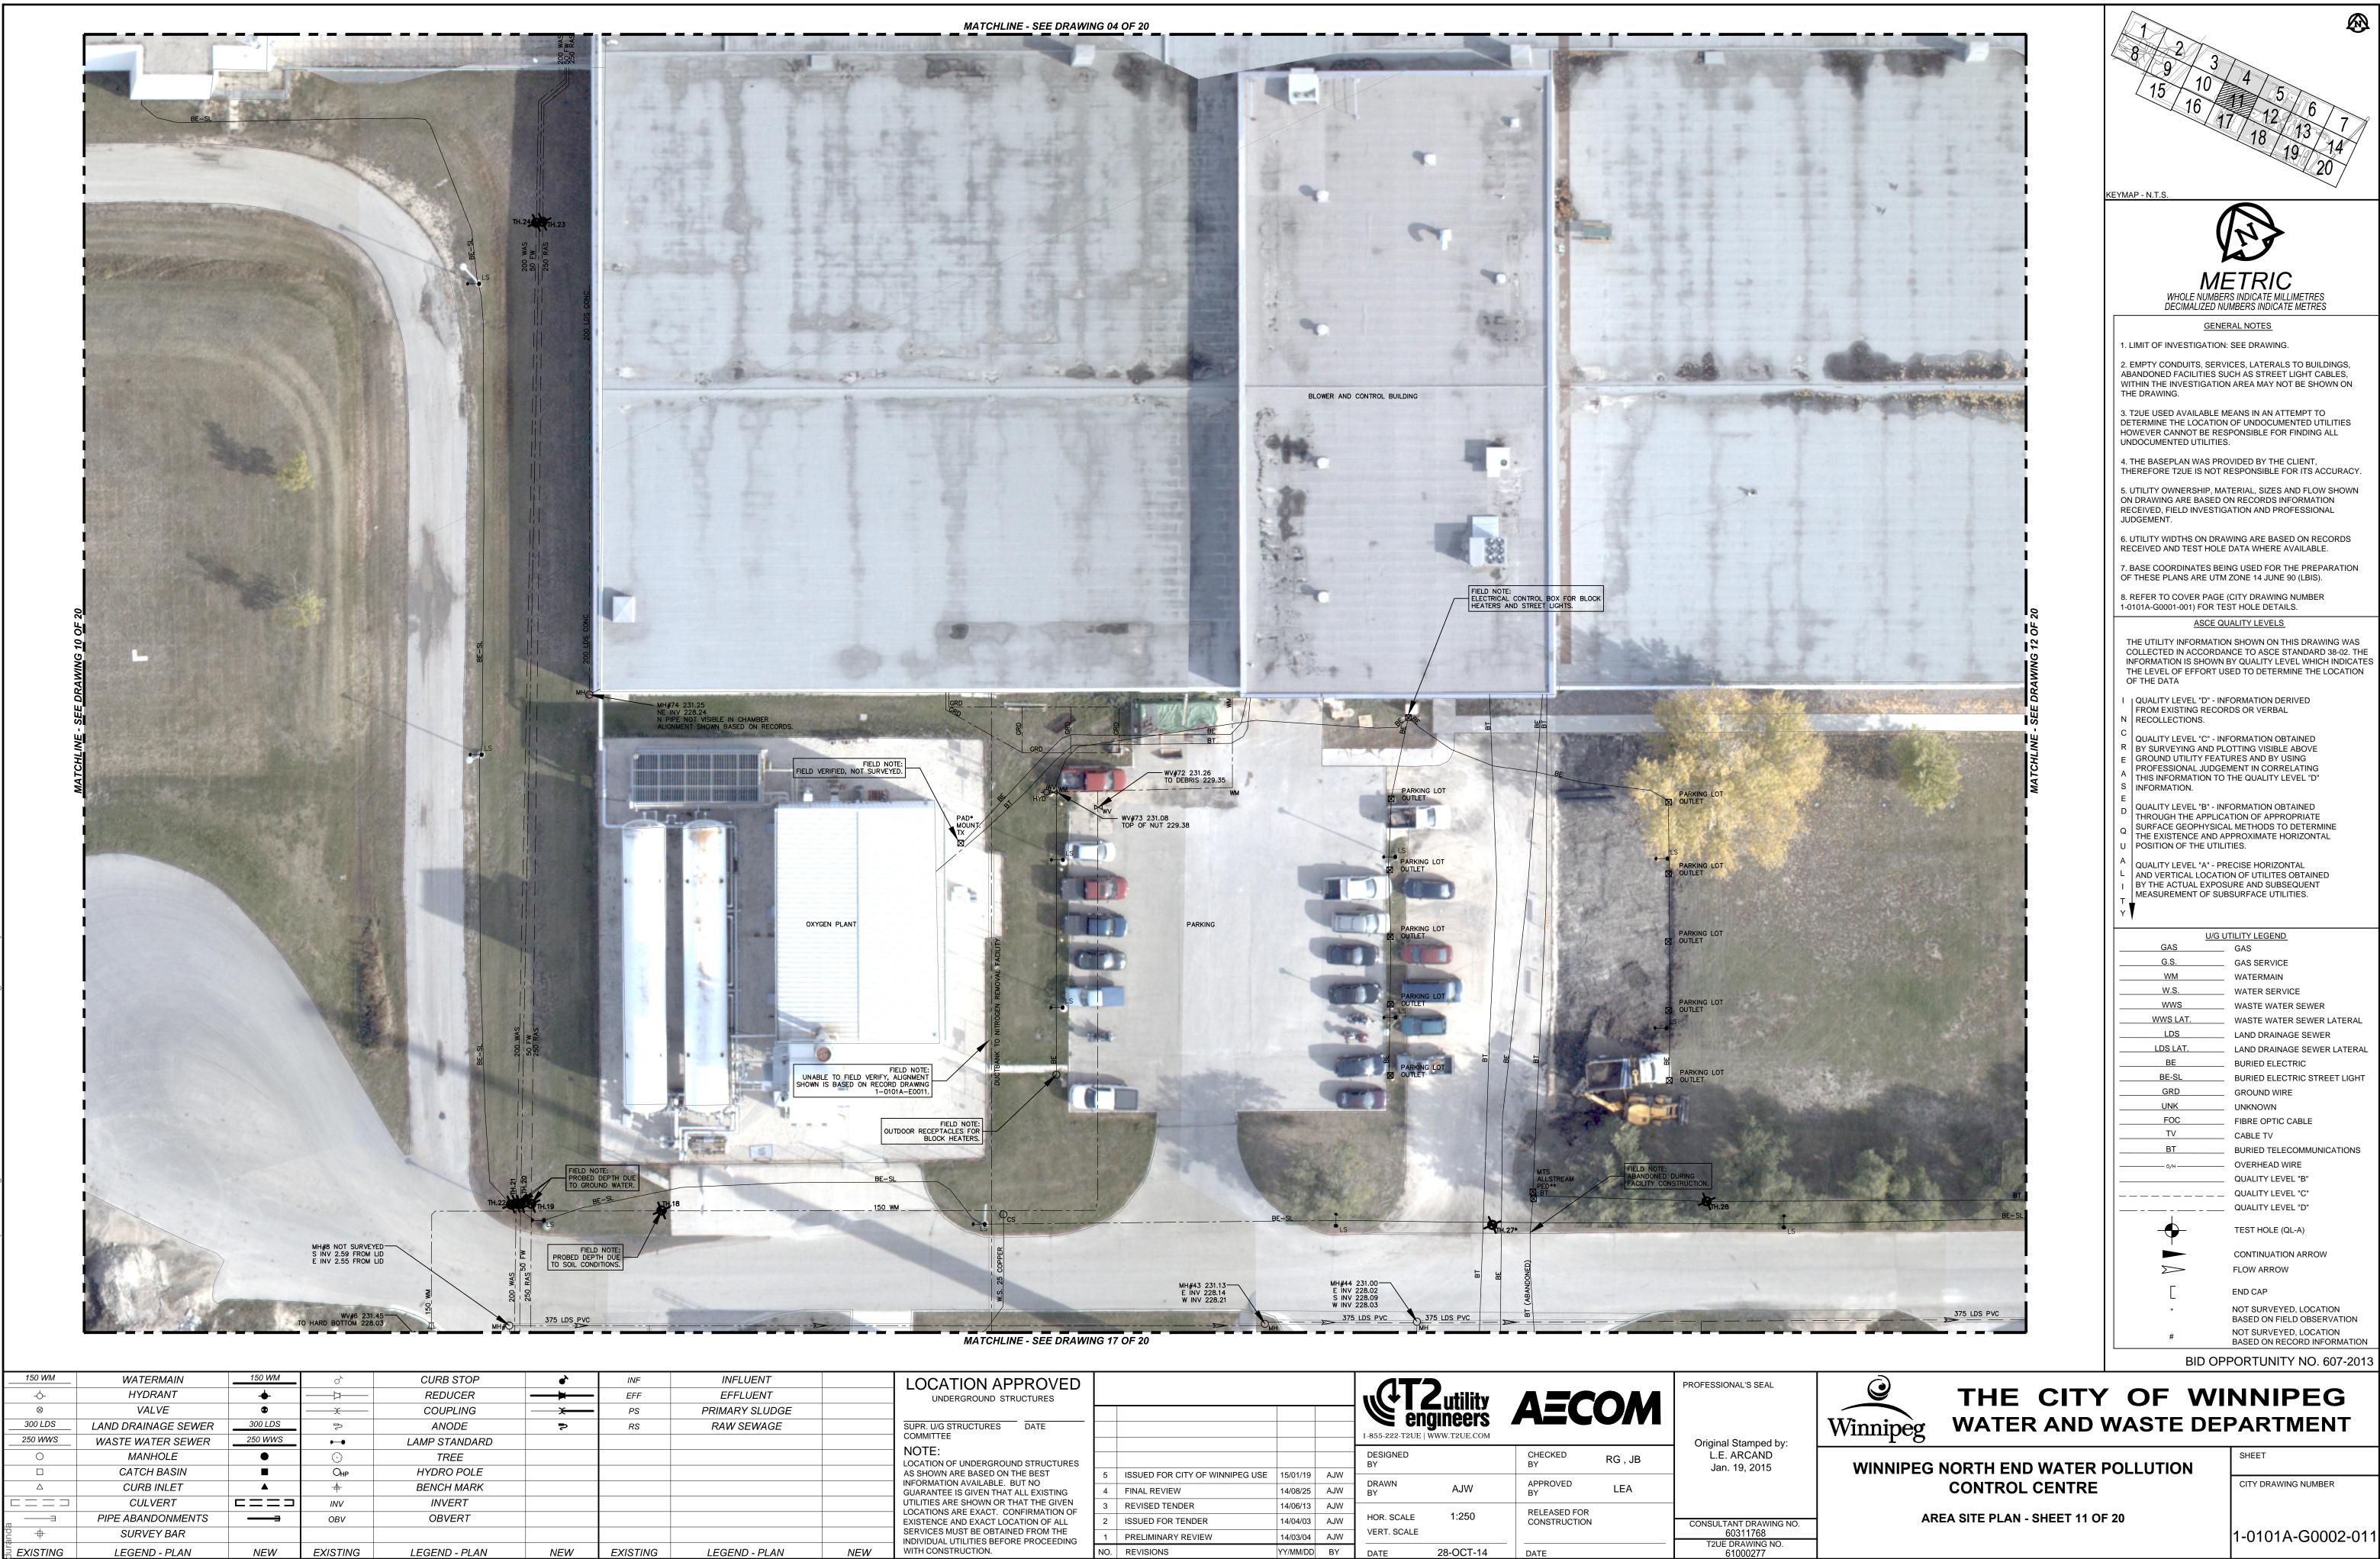
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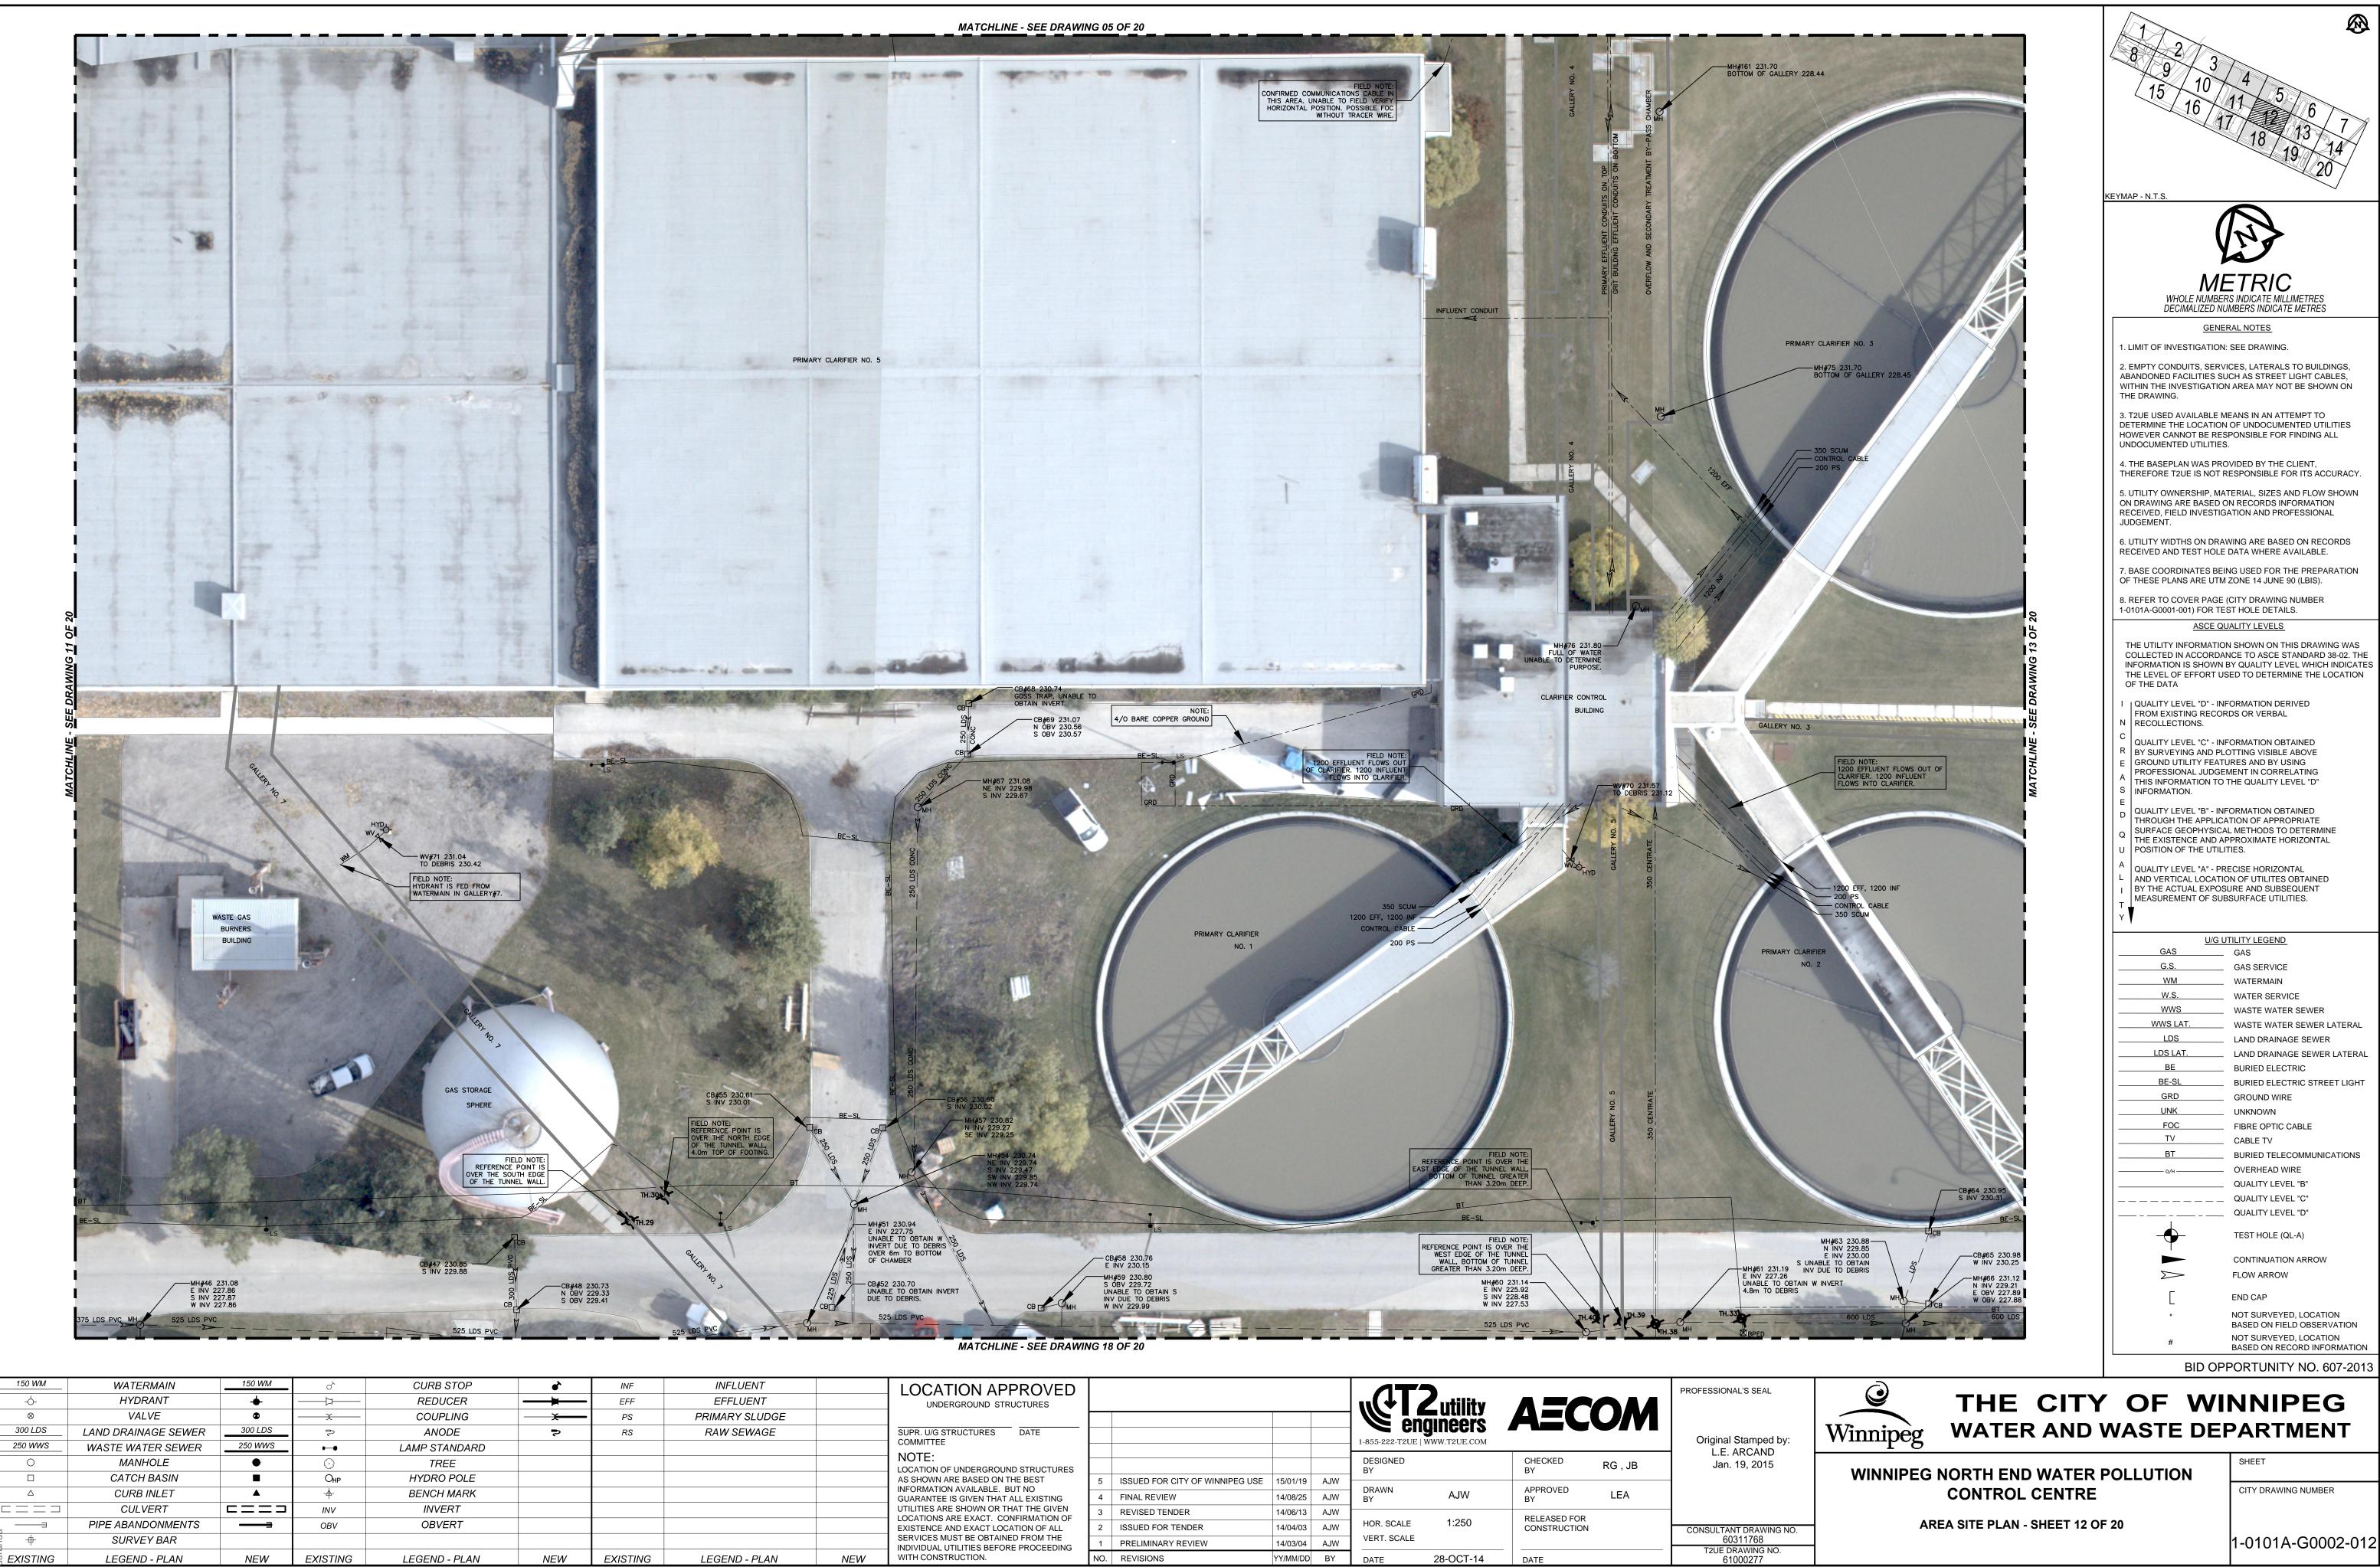
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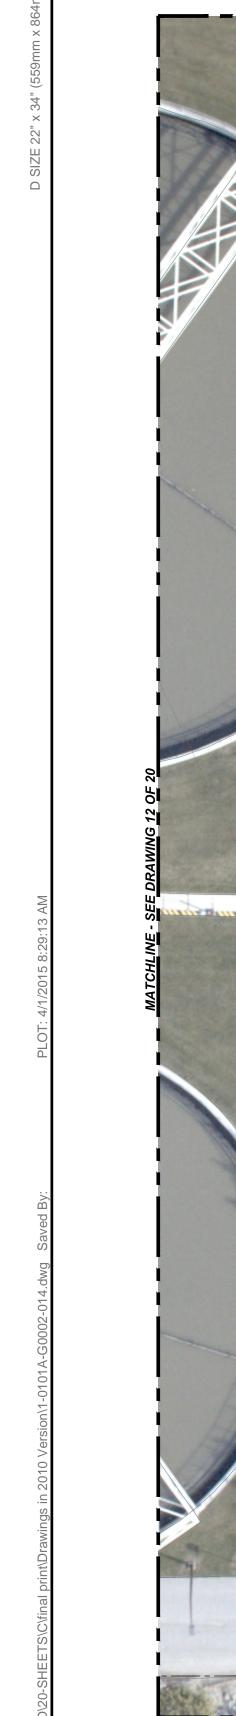
| MATCHLINE - SEE DRAWI | NG 03 OF 20 | | | | FIELD NOTE: 2 PVC CONDUITS ON BUILDING WALL FOR GROUNDING GRID. | | 4 5 |
|---|--|---|--|--|--|---|--|
| | | | | | FIELD NOTE: ELECTRICAL SERVICE FOR MTS TOWER. | кеумар - N.T.S. | $ \begin{array}{c ccccccccccccccccccccccccccccccccccc$ |
| | | C.H. M. W. M. K. | | H | The second second second | ME | ETRIC RS INDICATE MILLIMETRES IMBERS INDICATE METRES |
| | | | | | | GENE 1. LIMIT OF INVESTIGATION 2. EMPTY CONDUITS, SERV ABANDONED FACILITIES SL WITHIN THE INVESTIGATION THE DRAWING. | RAL NOTES : SEE DRAWING. ICES, LATERALS TO BUILDINGS, JCH AS STREET LIGHT CABLES, N AREA MAY NOT BE SHOWN ON |
| | | | | | | HOWEVER CANNOT BE RES UNDOCUMENTED UTILITIES 4. THE BASEPLAN WAS PRO THEREFORE T2UE IS NOT F 5. UTILITY OWNERSHIP, MA ON DRAWING ARE BASED O RECEIVED, FIELD INVESTIG | I OF UNDOCUMENTED UTILITIES SPONSIBLE FOR FINDING ALL S. DVIDED BY THE CLIENT, RESPONSIBLE FOR ITS ACCURACY. TERIAL, SIZES AND FLOW SHOWN DN RECORDS INFORMATION |
| | FELD NOTE: | | | | 20 | RECEIVED AND TEST HOLE 7. BASE COORDINATES BEI OF THESE PLANS ARE UTM 8. REFER TO COVER PAGE 1-0101A-G0001-001) FOR TE | NG USED FOR THE PREPARATION ZONE 14 JUNE 90 (LBIS). (CITY DRAWING NUMBER ST HOLE DETAILS. |
| BE | FIELD NOTE: ELECTRICAL SERV FOR MTS TOWER. | ICE | | | SEE DRAWING 11 OF | THE UTILITY INFORMATIO COLLECTED IN ACCORDA INFORMATION IS SHOWN | |
| | | | | | MATCHLINE - | SURFACE GEOPHYSICA | OTTING VISIBLE ABOVE URES AND BY USING MENT IN CORRELATING THE QUALITY LEVEL "D" FORMATION OBTAINED ATION OF APPROPRIATE |
| | CHP | | | | | U POSITION OF THE UTILI A QUALITY LEVEL "A" - PR L AND VERTICAL LOCATIO I BY THE ACTUAL EXPOS MEASUREMENT OF SUE T | ECISE HORIZONTAL DN OF UTILITES OBTAINED URE AND SUBSEQUENT |
| | | | | | | GAS G.S. WM W.S. WWS WWS LAT. LDS | GAS GAS SERVICE WATERMAIN WATER SERVICE WASTE WATER SEWER WASTE WATER SEWER LATERAL LAND DRAINAGE SEWER |
| | | | | | | LDS LAT. BE BE-SL GRD UNK FOC TV BT | LAND DRAINAGE SEWER LATERAL BURIED ELECTRIC BURIED ELECTRIC STREET LIGHT GROUND WIRE UNKNOWN FIBRE OPTIC CABLE CABLE TV BURIED TELECOMMUNICATIONS |
| | | | FIELD NOTE: TEMPORARY CONSTRUCTION TRAILER. | | | | OVERHEAD WIRE QUALITY LEVEL "B" QUALITY LEVEL "C" QUALITY LEVEL "D" TEST HOLE (QL-A) CONTINUATION ARROW |
| MATCHLINE - SEE DRAWI | NG 16 OF 20 | | | | | E # BID OP | FLOW ARROW END CAP NOT SURVEYED, LOCATION BASED ON FIELD OBSERVATION NOT SURVEYED, LOCATION BASED ON RECORD INFORMATION PORTUNITY NO. 607-2013 |
| LOCATION APPROVED UNDERGROUND STRUCTURES SUPR. U/G STRUCTURES DATE COMMITTEE | | 1-855-222-T2UE WWW.T2UE.COM | AECOM | PROFESSIONAL'S SEAL | Winnipeg WATER AND | OF WI | NNIPEG |
| NOTE: LOCATION OF UNDERGROUND STRUCTURES AS SHOWN ARE BASED ON THE BEST INFORMATION AVAILABLE. BUT NO GUARANTEE IS GIVEN THAT ALL EXISTING UTILITIES ARE SHOWN OR THAT THE GIVEN | Image: Second system Image: Second system 5 ISSUED FOR CITY OF WINNIPEG USE 15/01/19 4 FINAL REVIEW 14/08/25 3 REVISED TENDER 14/06/13 | DESIGNED BY DRAWN BY AJW | CHECKED BY RG , JB APPROVED BY LEA | Original Stamped by: L.E. ARCAND Jan. 19, 2015 | WINNIPEG NORTH END WATER CONTROL CENTRE | | SHEET CITY DRAWING NUMBER |
| LOCATIONS ARE EXACT. CONFIRMATION OF EXISTENCE AND EXACT LOCATION OF ALL SERVICES MUST BE OBTAINED FROM THE INDIVIDUAL UTILITIES BEFORE PROCEEDING WITH CONSTRUCTION. | 2ISSUED FOR TENDER14/04/03AJW1PRELIMINARY REVIEW14/03/04AJWNO.REVISIONSYY/MM/DDBY | HOR. SCALE 1:250 VERT. SCALE DATE 28-OCT-14 | RELEASED FOR CONSTRUCTION | CONSULTANT DRAWING NO. 60311768 T2UE DRAWING NO. 61000277 | AREA SITE PLAN - SHEET 10 C | DF 20 | 1-0101A-G0002-010 |



| ork/ | 150 WM | WATERMAIN | 150 WM | o ^ک | CURB STOP | • | INF | INFLUENT | | LOCATION APPROVED | | | | | | | | | PROFESSIONAL'S SE |
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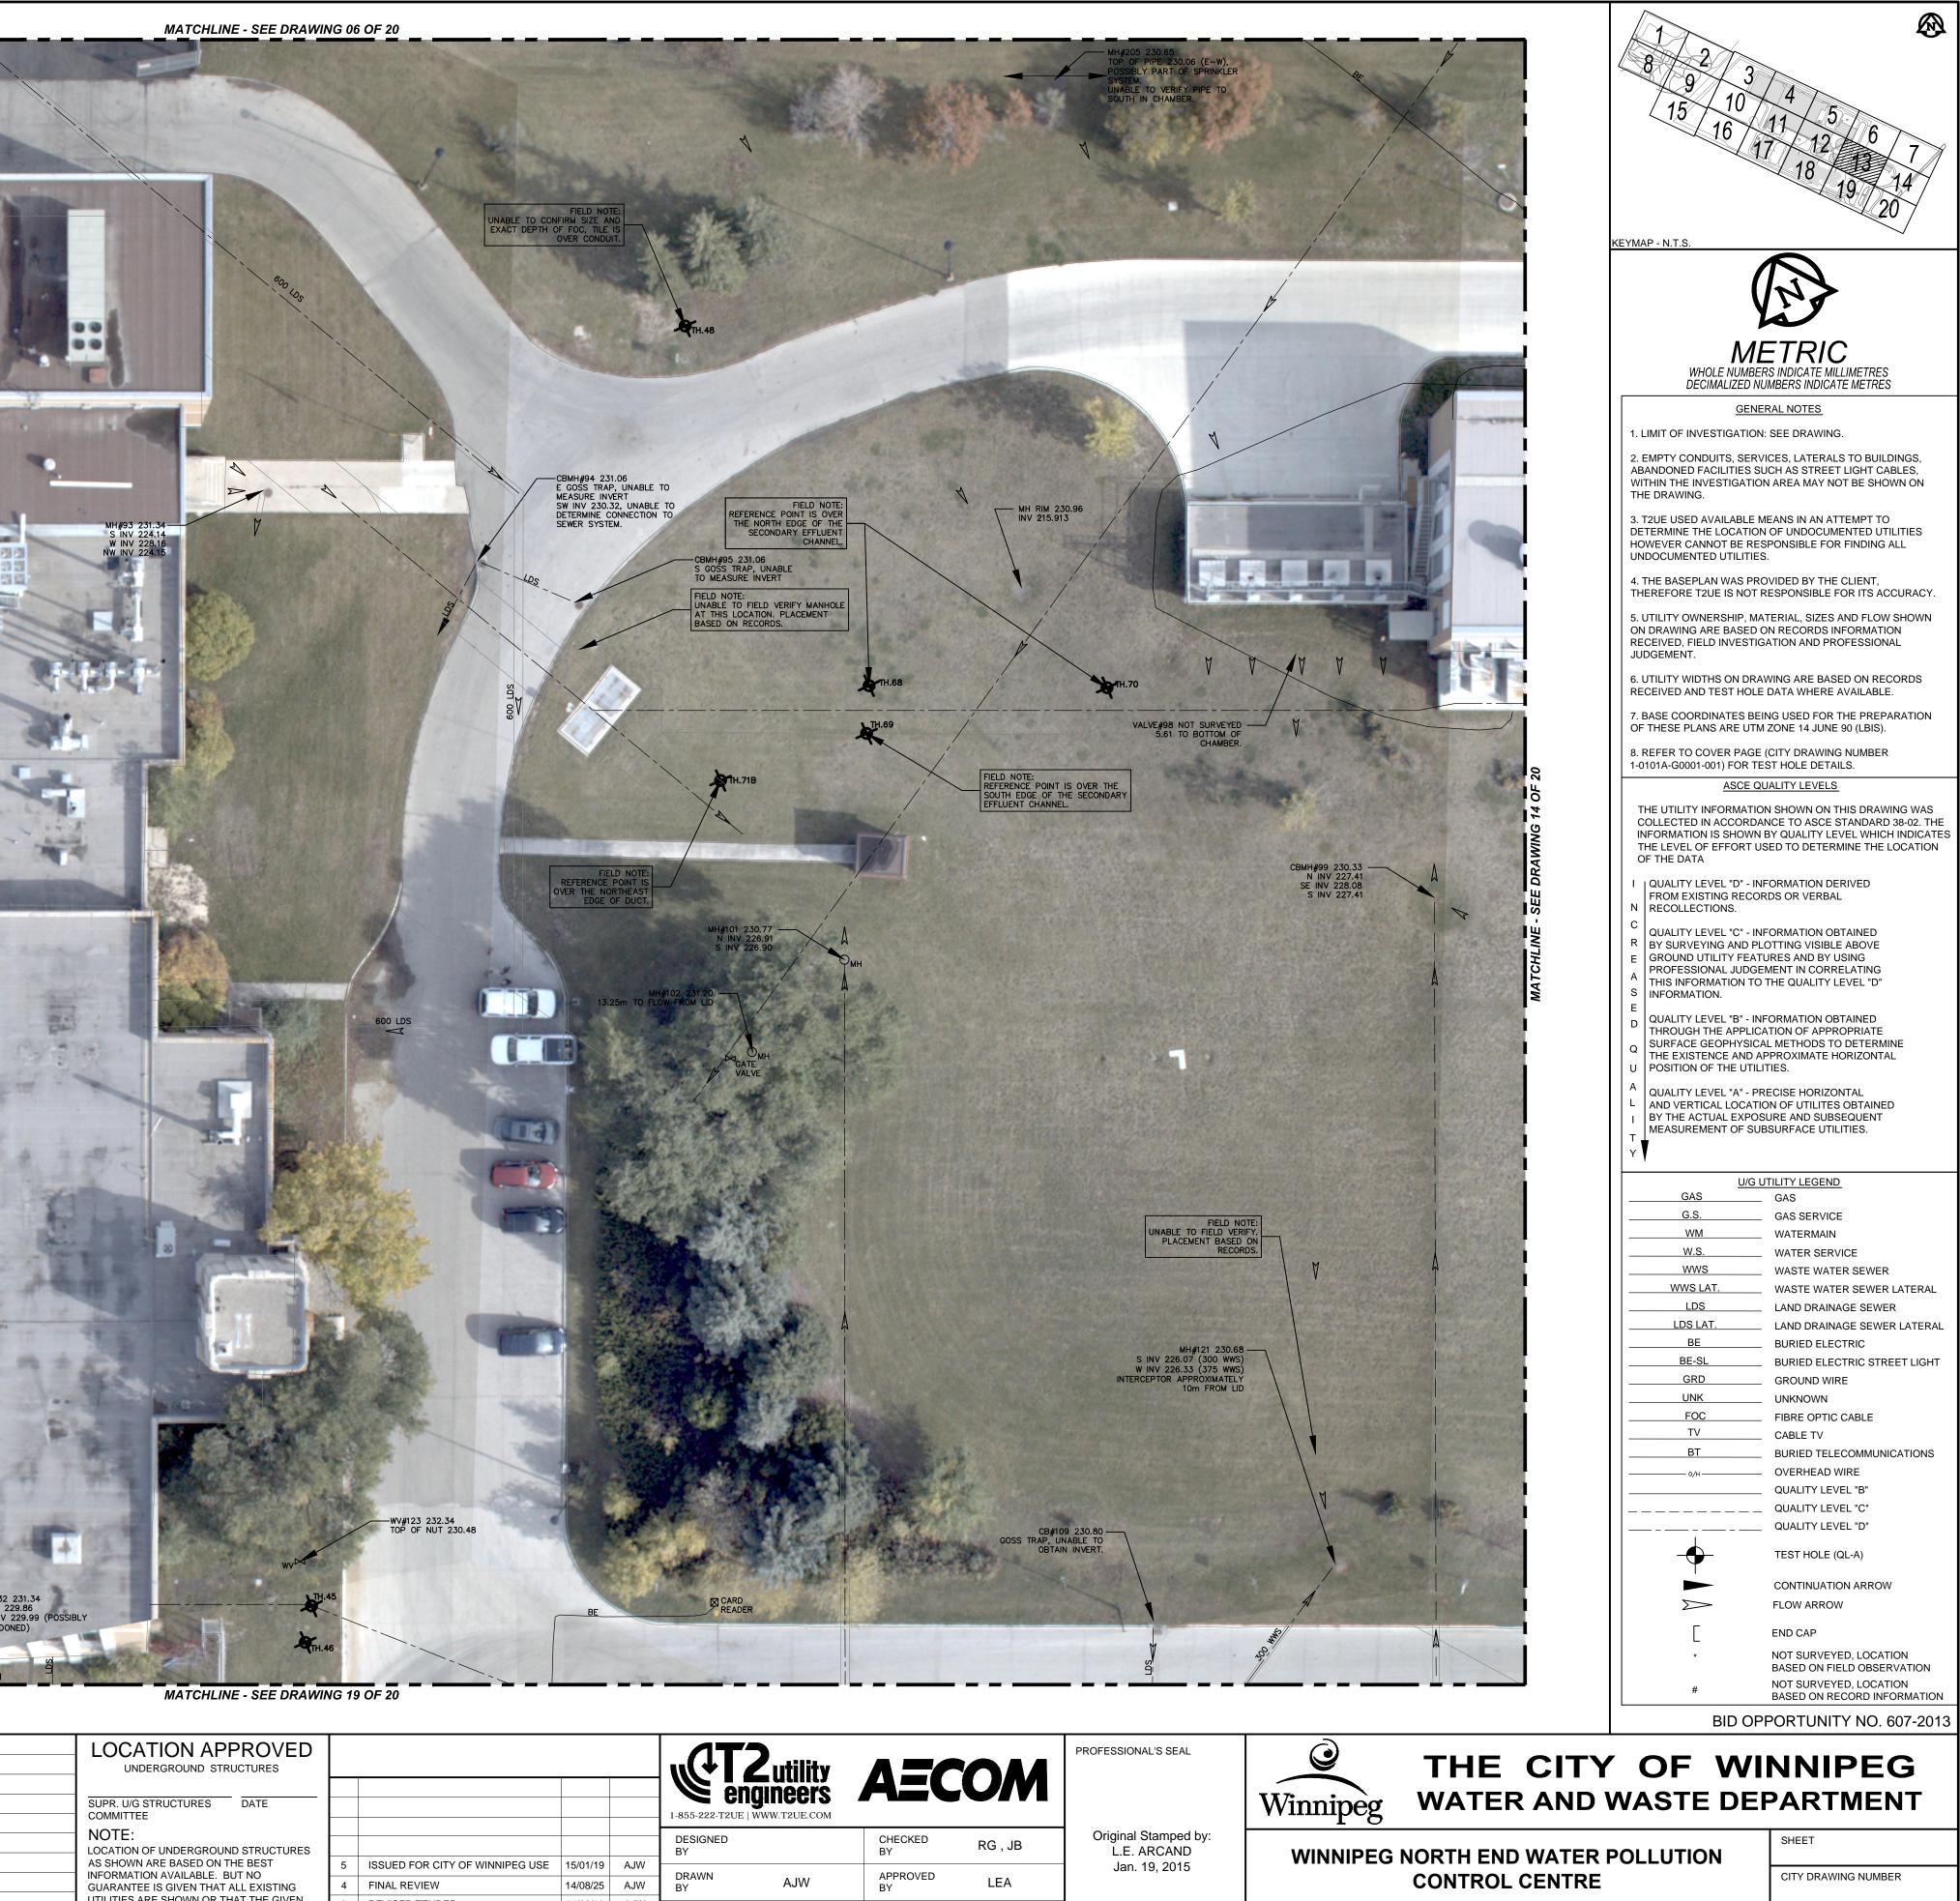


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| | 0 | MANHOLE | • | \odot | TREE | | | | | NOTE: LOCATION OF UNDERGROUND STRUCTURES | | | | | | | CHECKED | RG , JB | Jan. 19, 2 |
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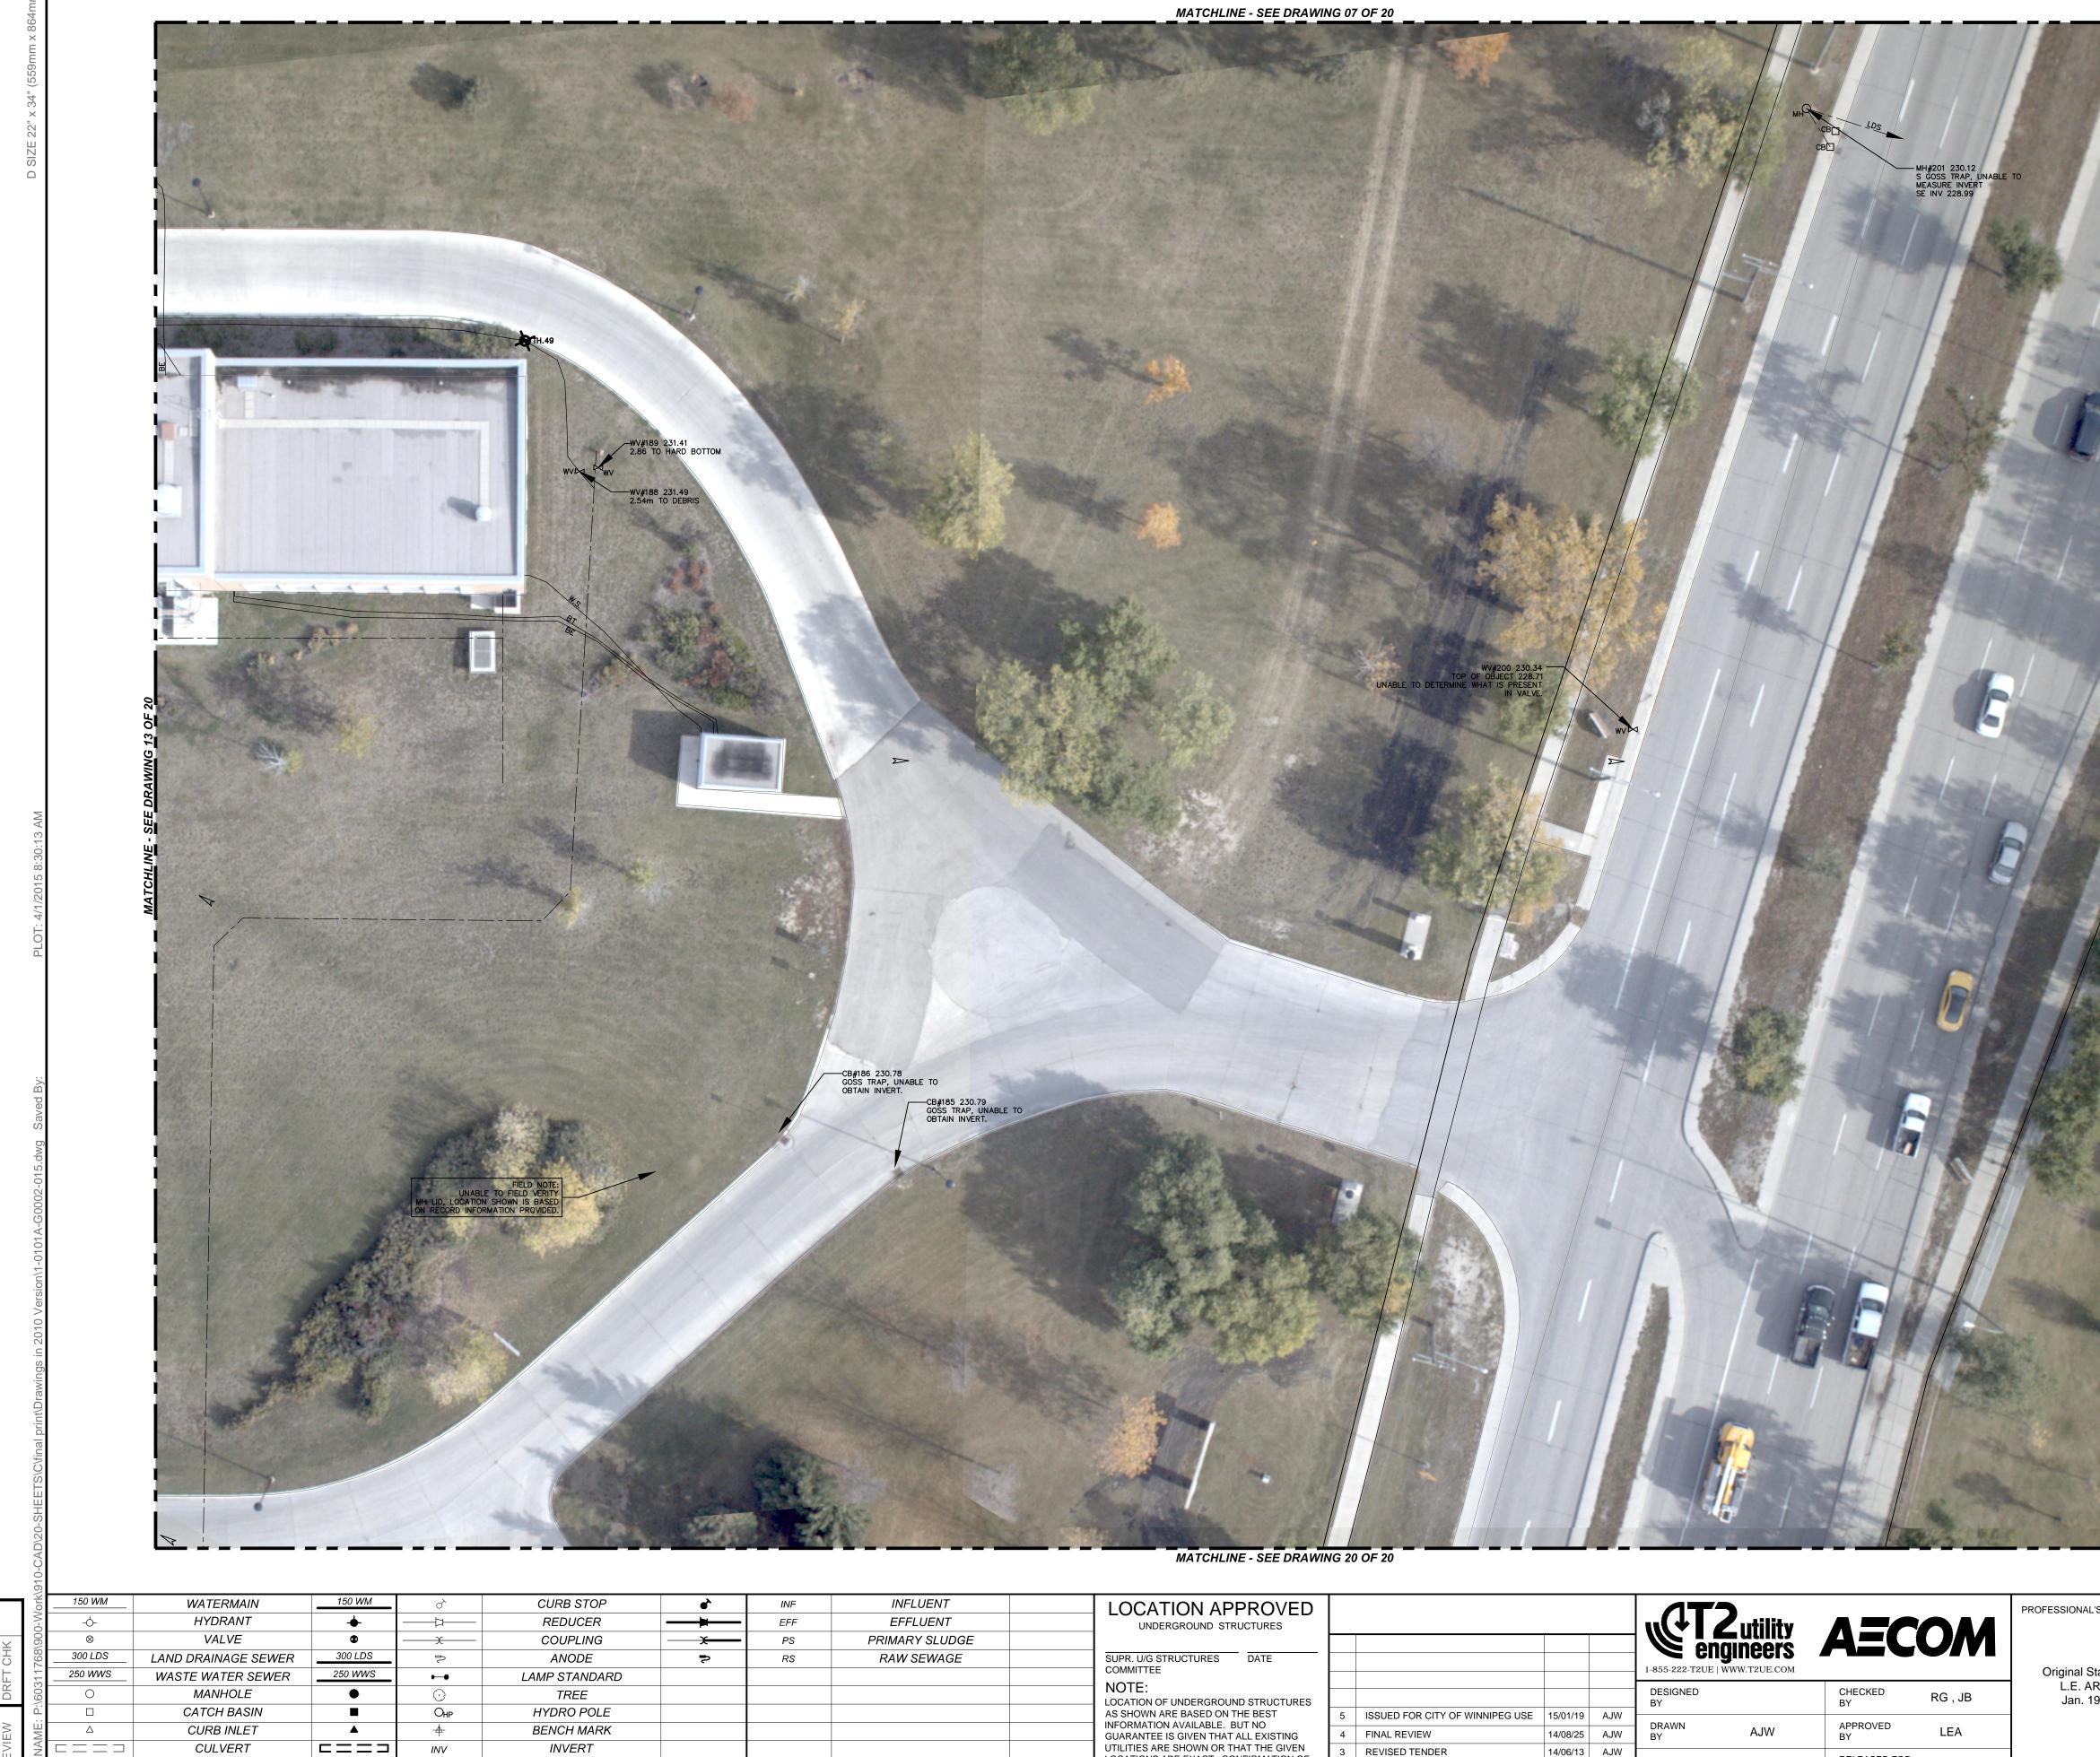


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| CBMH#142 231.06 E INV TO #140 229.97 E INV TO #141 230.08 NW GOSS TRAP, UNABLE TO MEASURE INVERT. CB#144 231.21 N INV 226.78 UNABLE TO OBTAIN INV OF, EAST PIPE S INV 226.76 | |
| MH#137 231.23 W INV 229 02 | |
| MH#137 231.23 W INV 229.02 UNABLE TO VERIFY EAST PIPE DUE TO DEBRIS. ALIGNMENT BASED ON RECORDS. | |
| MH#138 231.30 N INV 226.96 E INV 228.67 W INV 226.94 W OBV 227.45 | |
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| MATCHLINE - SEE DRAWING 12 OF 20 | |
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| /ork/ | 150 WM | WATERMAIN | 150 WM | o^` | CURB STOP | • | INF | INFLUENT | LOCATION APPROVED | | | | | | | PROFESSIONAL'S SEAL |
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| ∽-0 | -0- | HYDRANT | - | Z | REDUCER | | EFF | EFFLUENT | UNDERGROUND STRUCTURES | | | uu(↓ ⊿ | Intility | ΔΞ | | |
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| 11 | 250 WWS | WASTE WATER SEWER | 250 WWS | • • | LAMP STANDARD | | | | COMMITTEE | | | _ 1-855-222-T2UE ' | WWW.T2UE.COM | | | |
| 09 | 0 | MANHOLE | • | \odot | TREE | | | | NOTE: LOCATION OF UNDERGROUND STRUCTURES | | | | | | RG , JB | Original Stamped by: L.E. ARCAND |
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| e Fl | + | SURVEY BAR | | | | | | | SERVICES MUST BE OBTAINED FROM THE | 1 PRELIMINARY REVIEW | 14/03/04 AJW | VERT. SCALE | | | | 60311768 |
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AREA SITE PLAN - SHEET 13 OF 20



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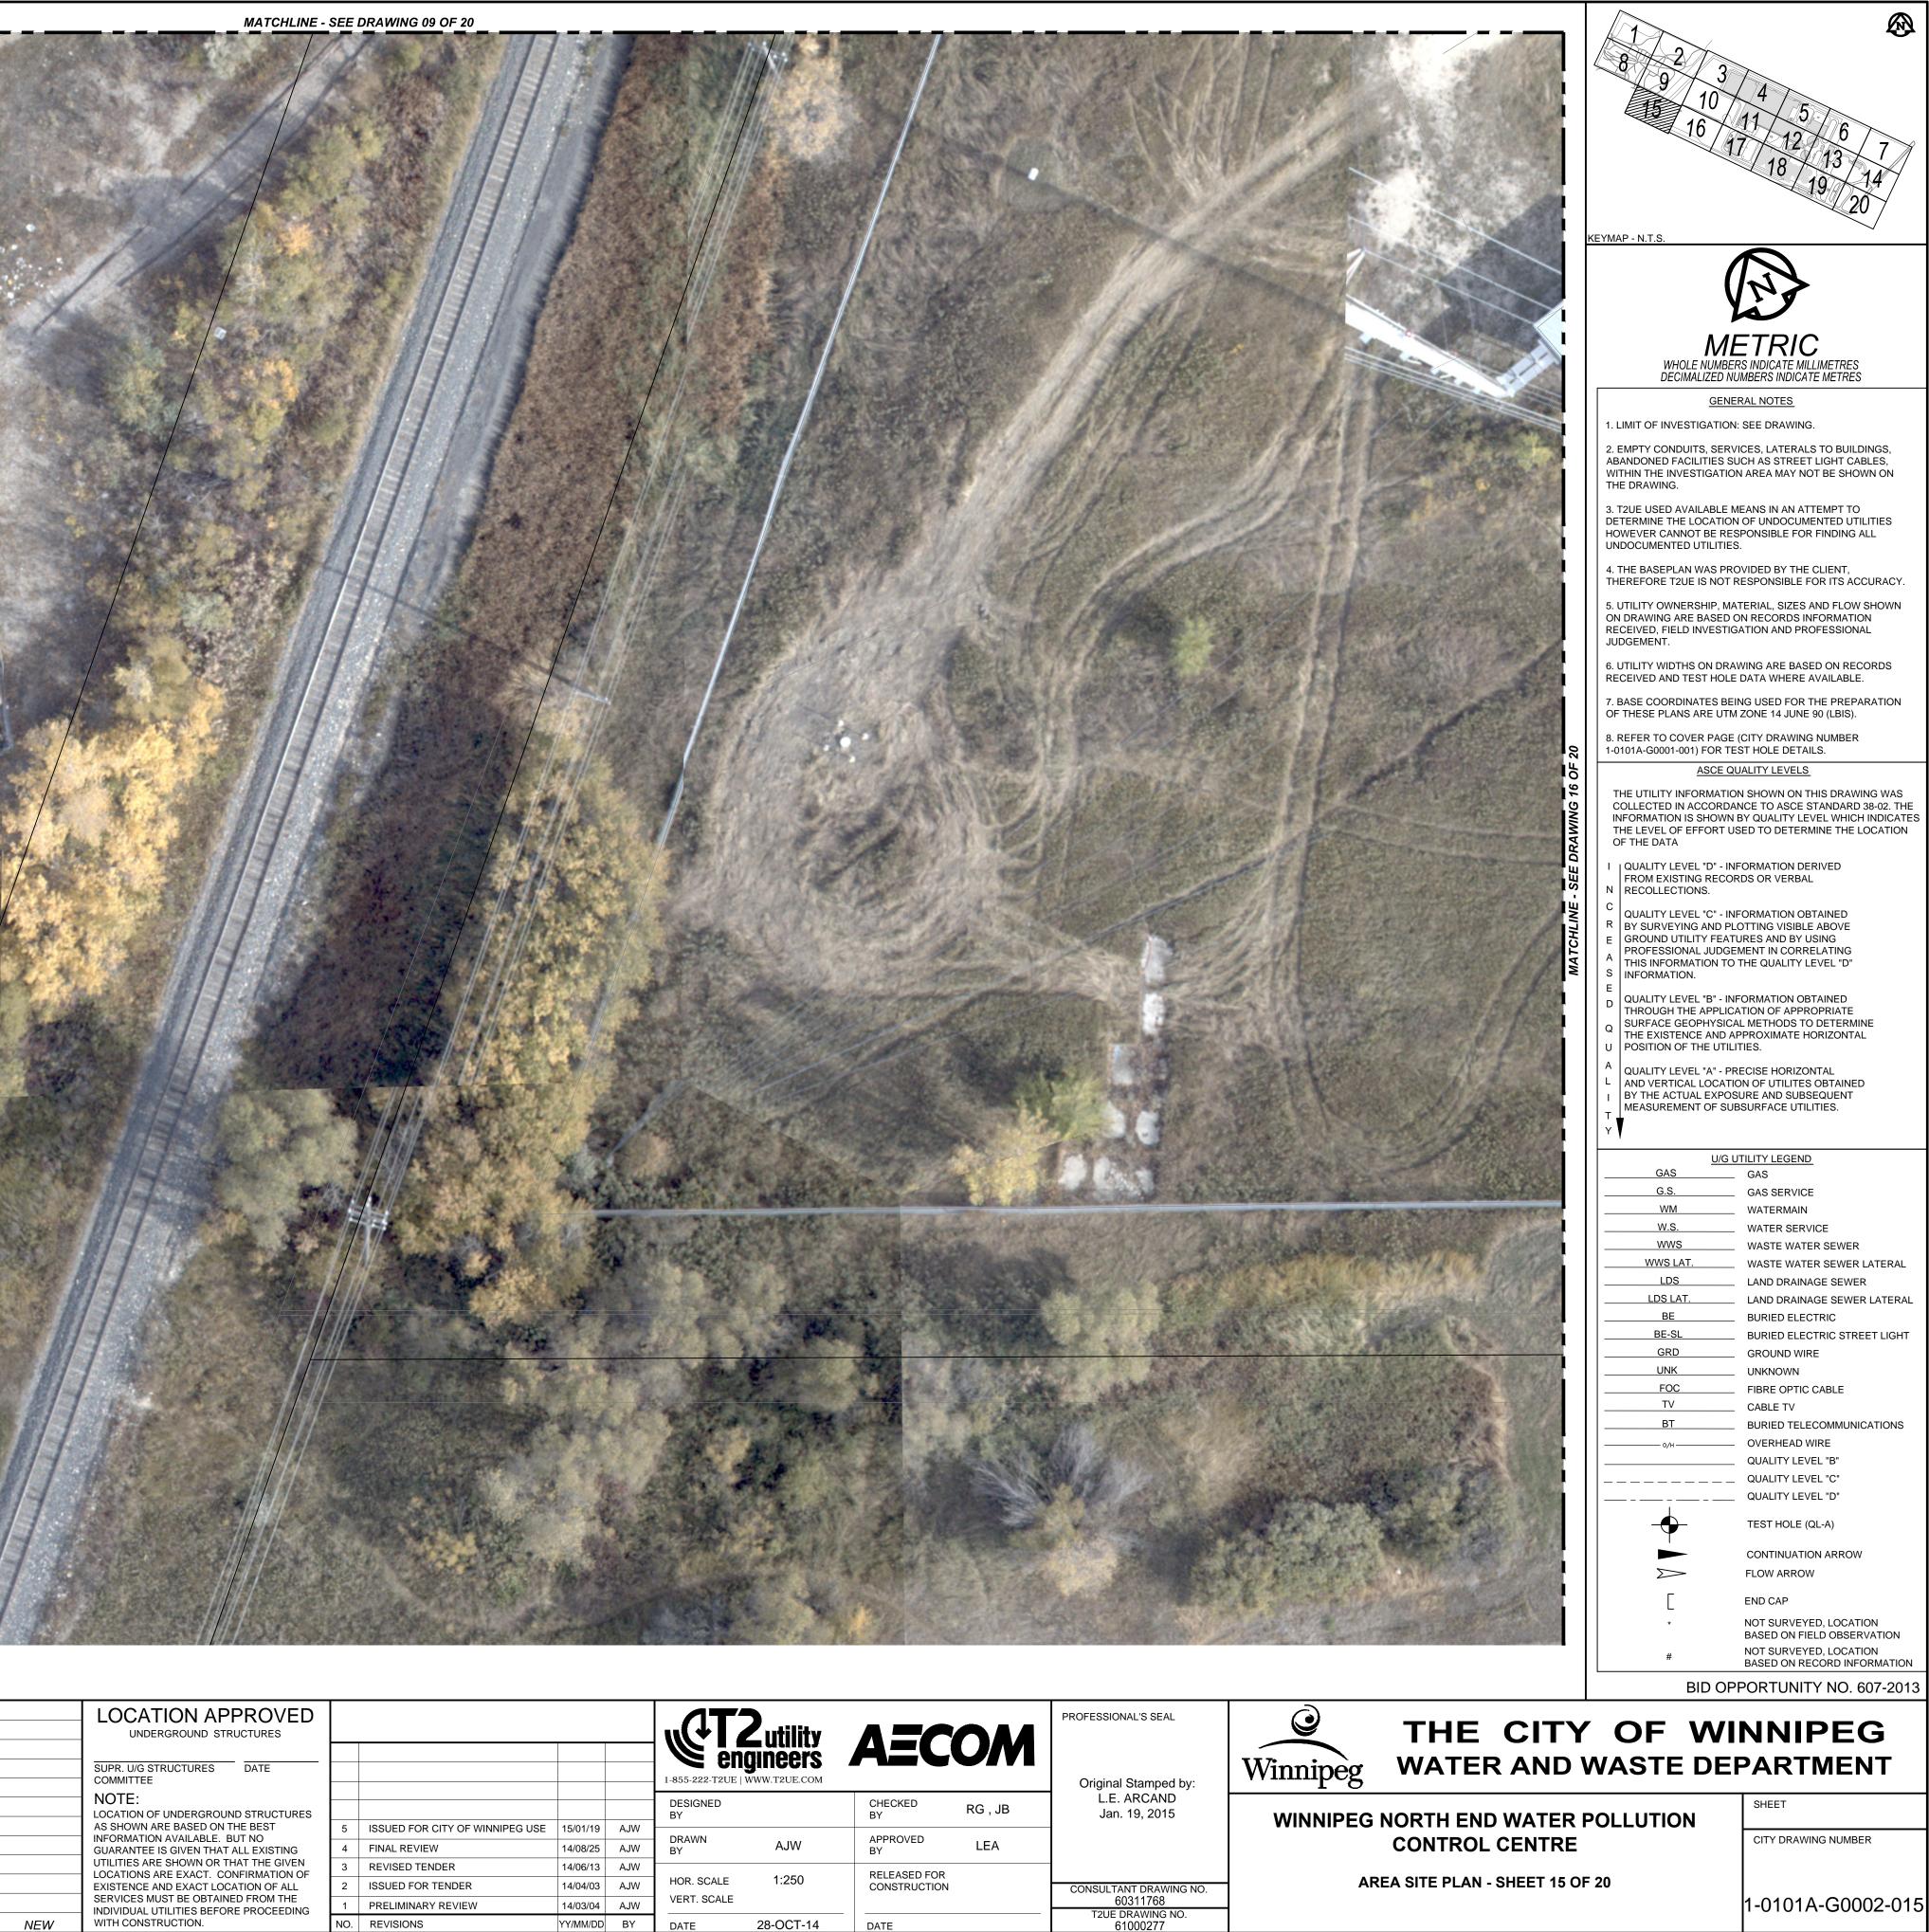
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| | NOTE: LOCATION OF UNDERGROUND STRUCTURES | | | | | DESIGNED BY | | CHECKED BY | RG , JB | L.E. ARC/ Jan. 19, 2 |
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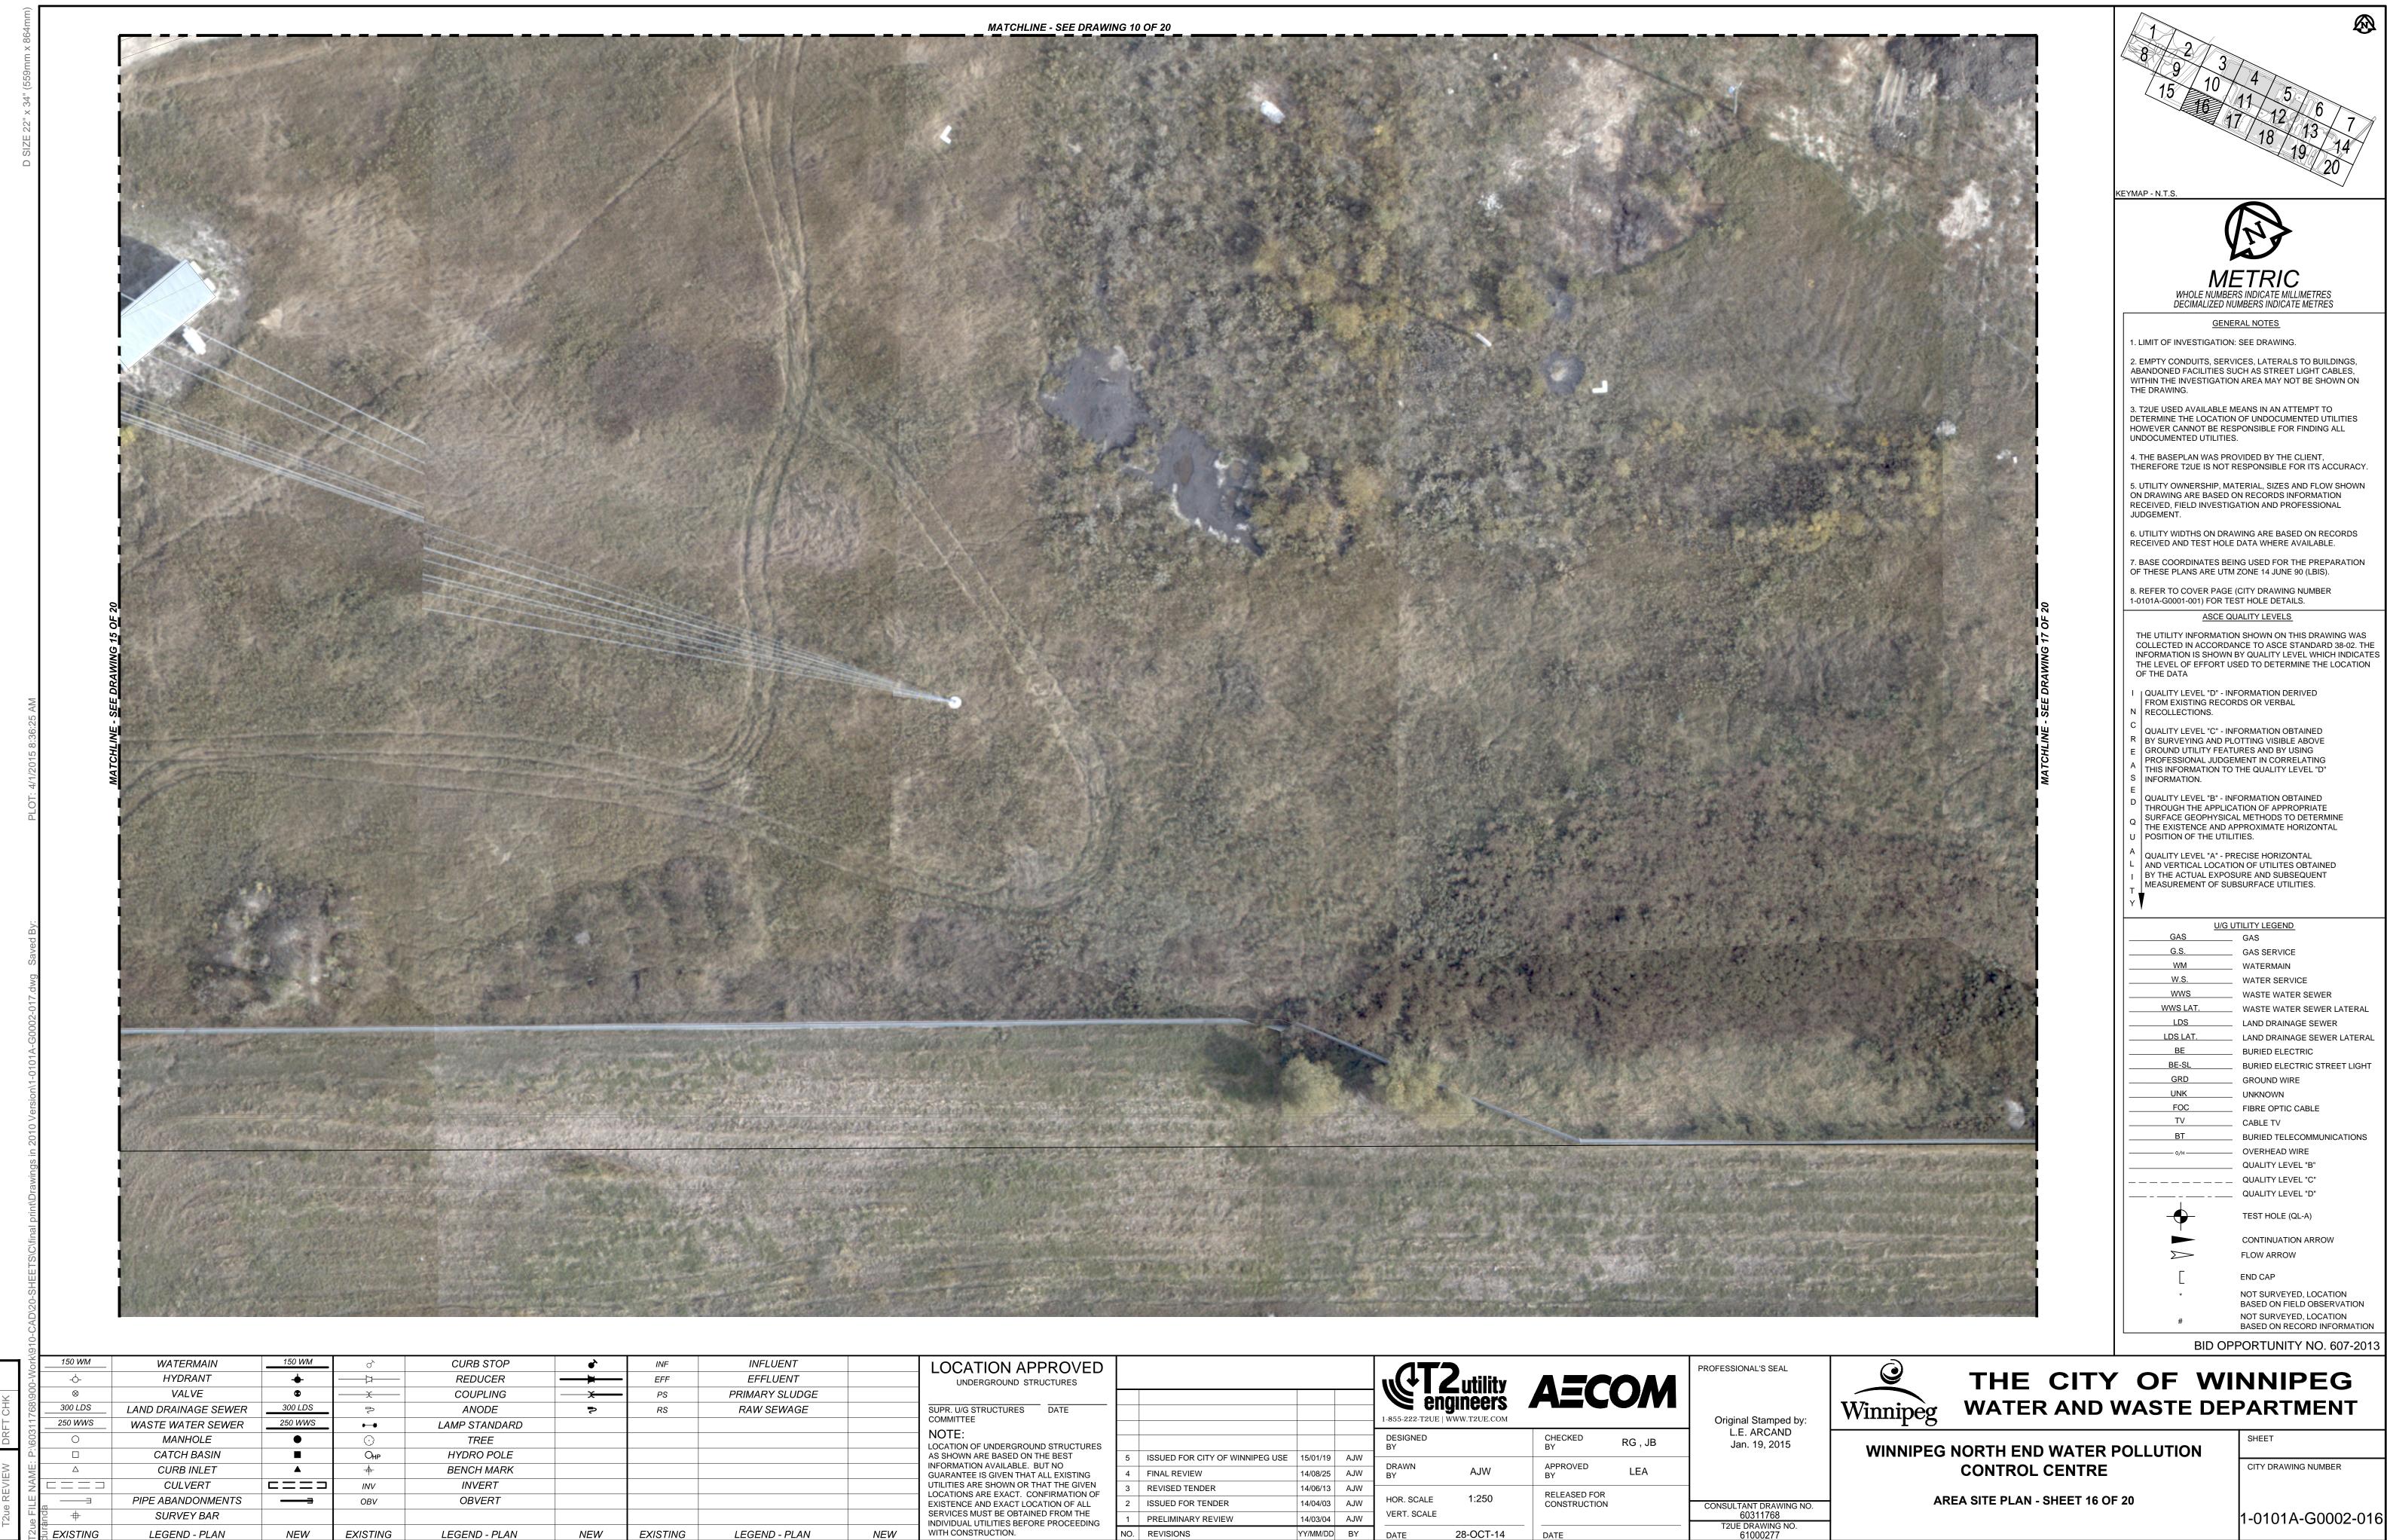
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| amped by: CAND 9, 2015 | WINNIPEG NORTH END WATER | | SHEET CITY DRAWING NUMBER |
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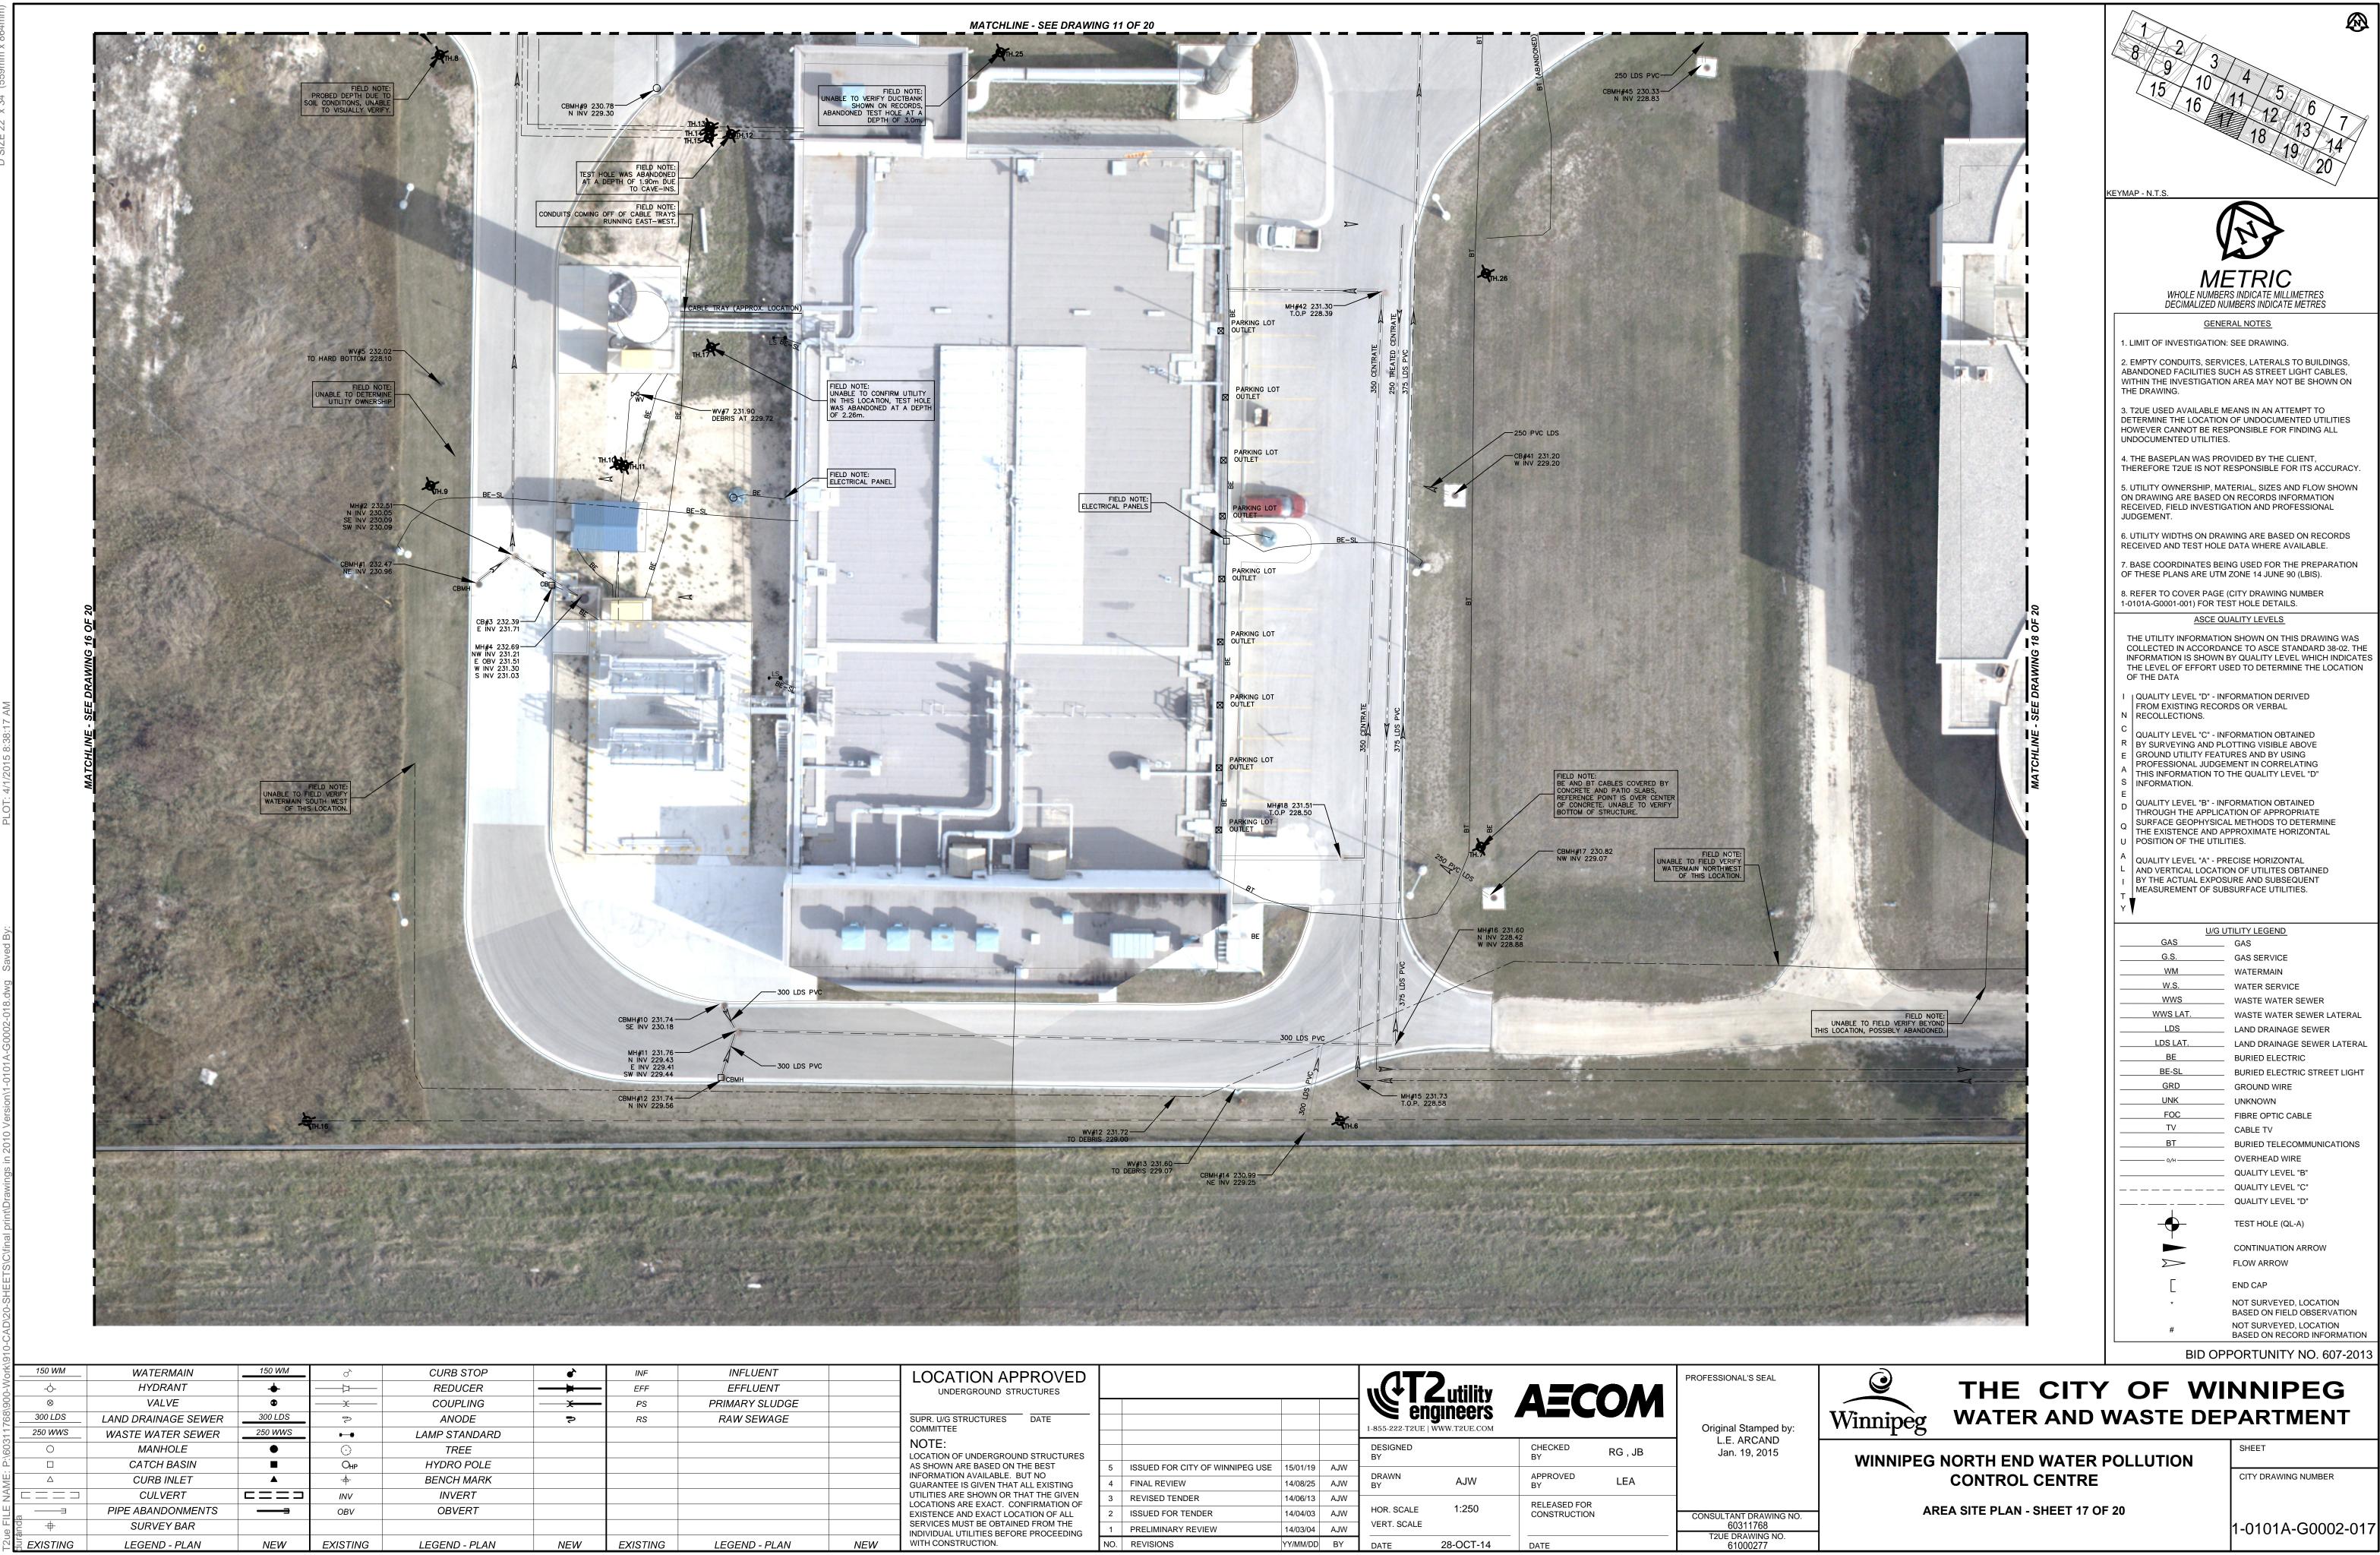


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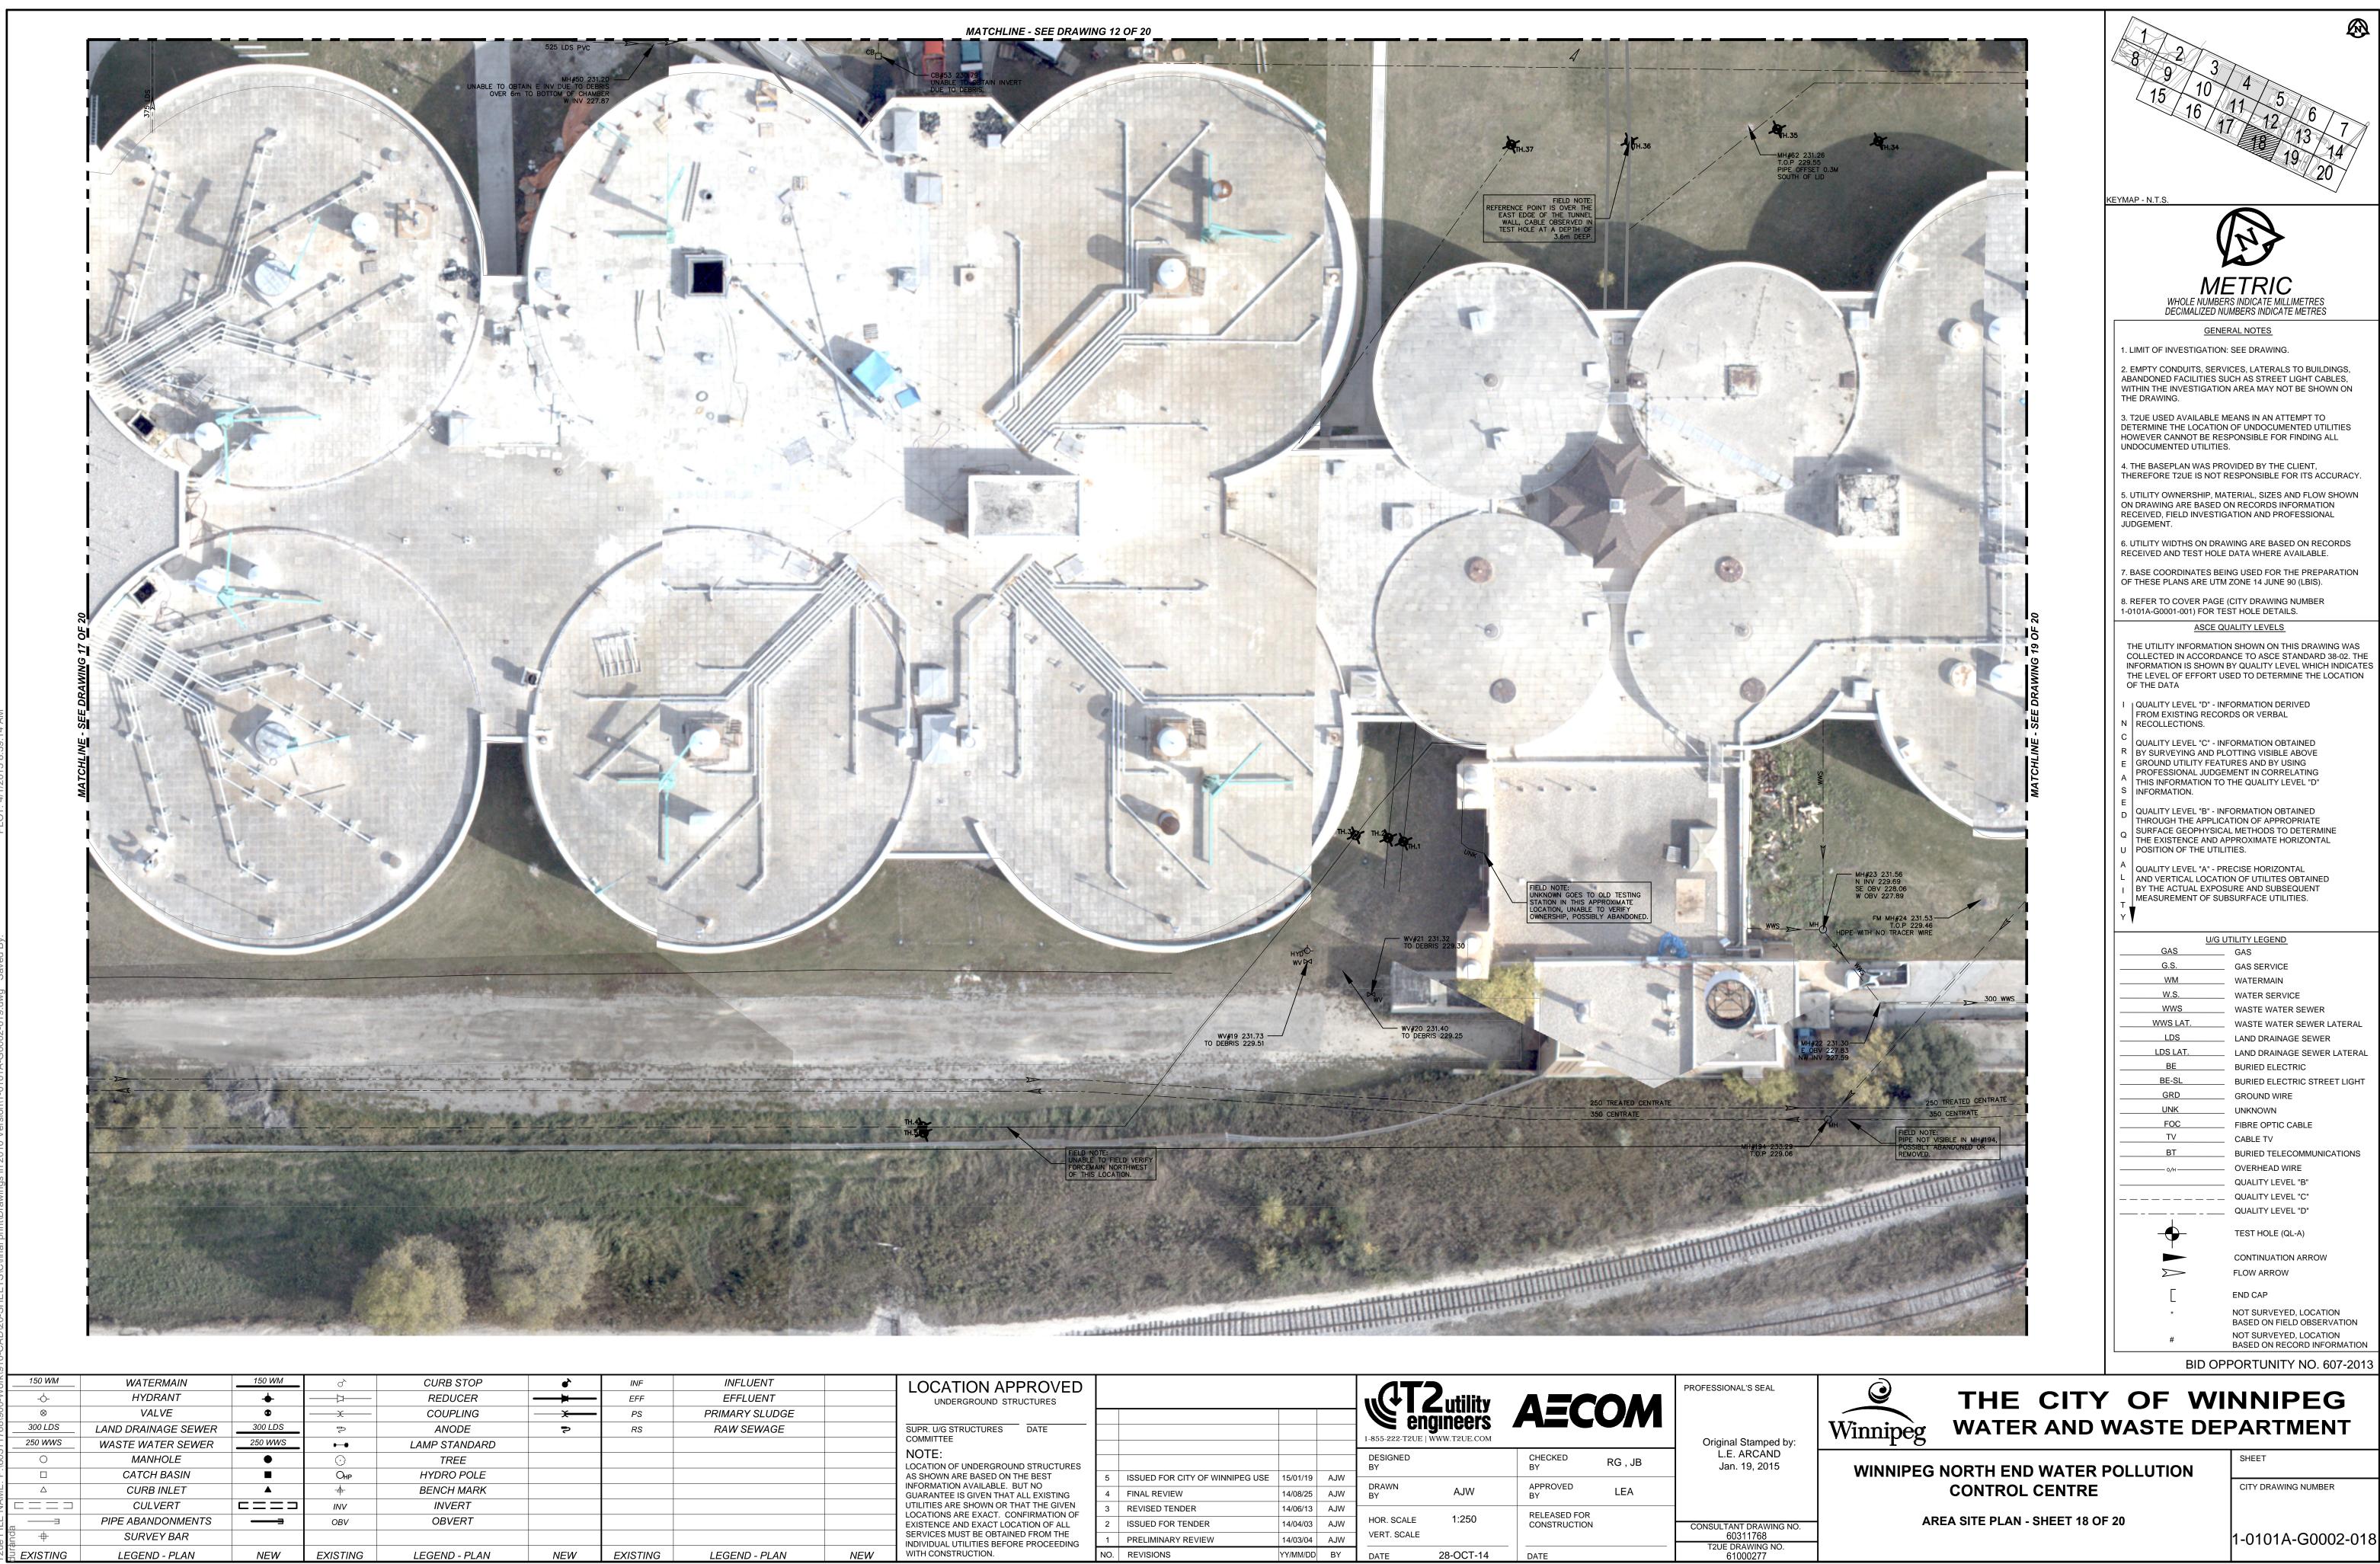
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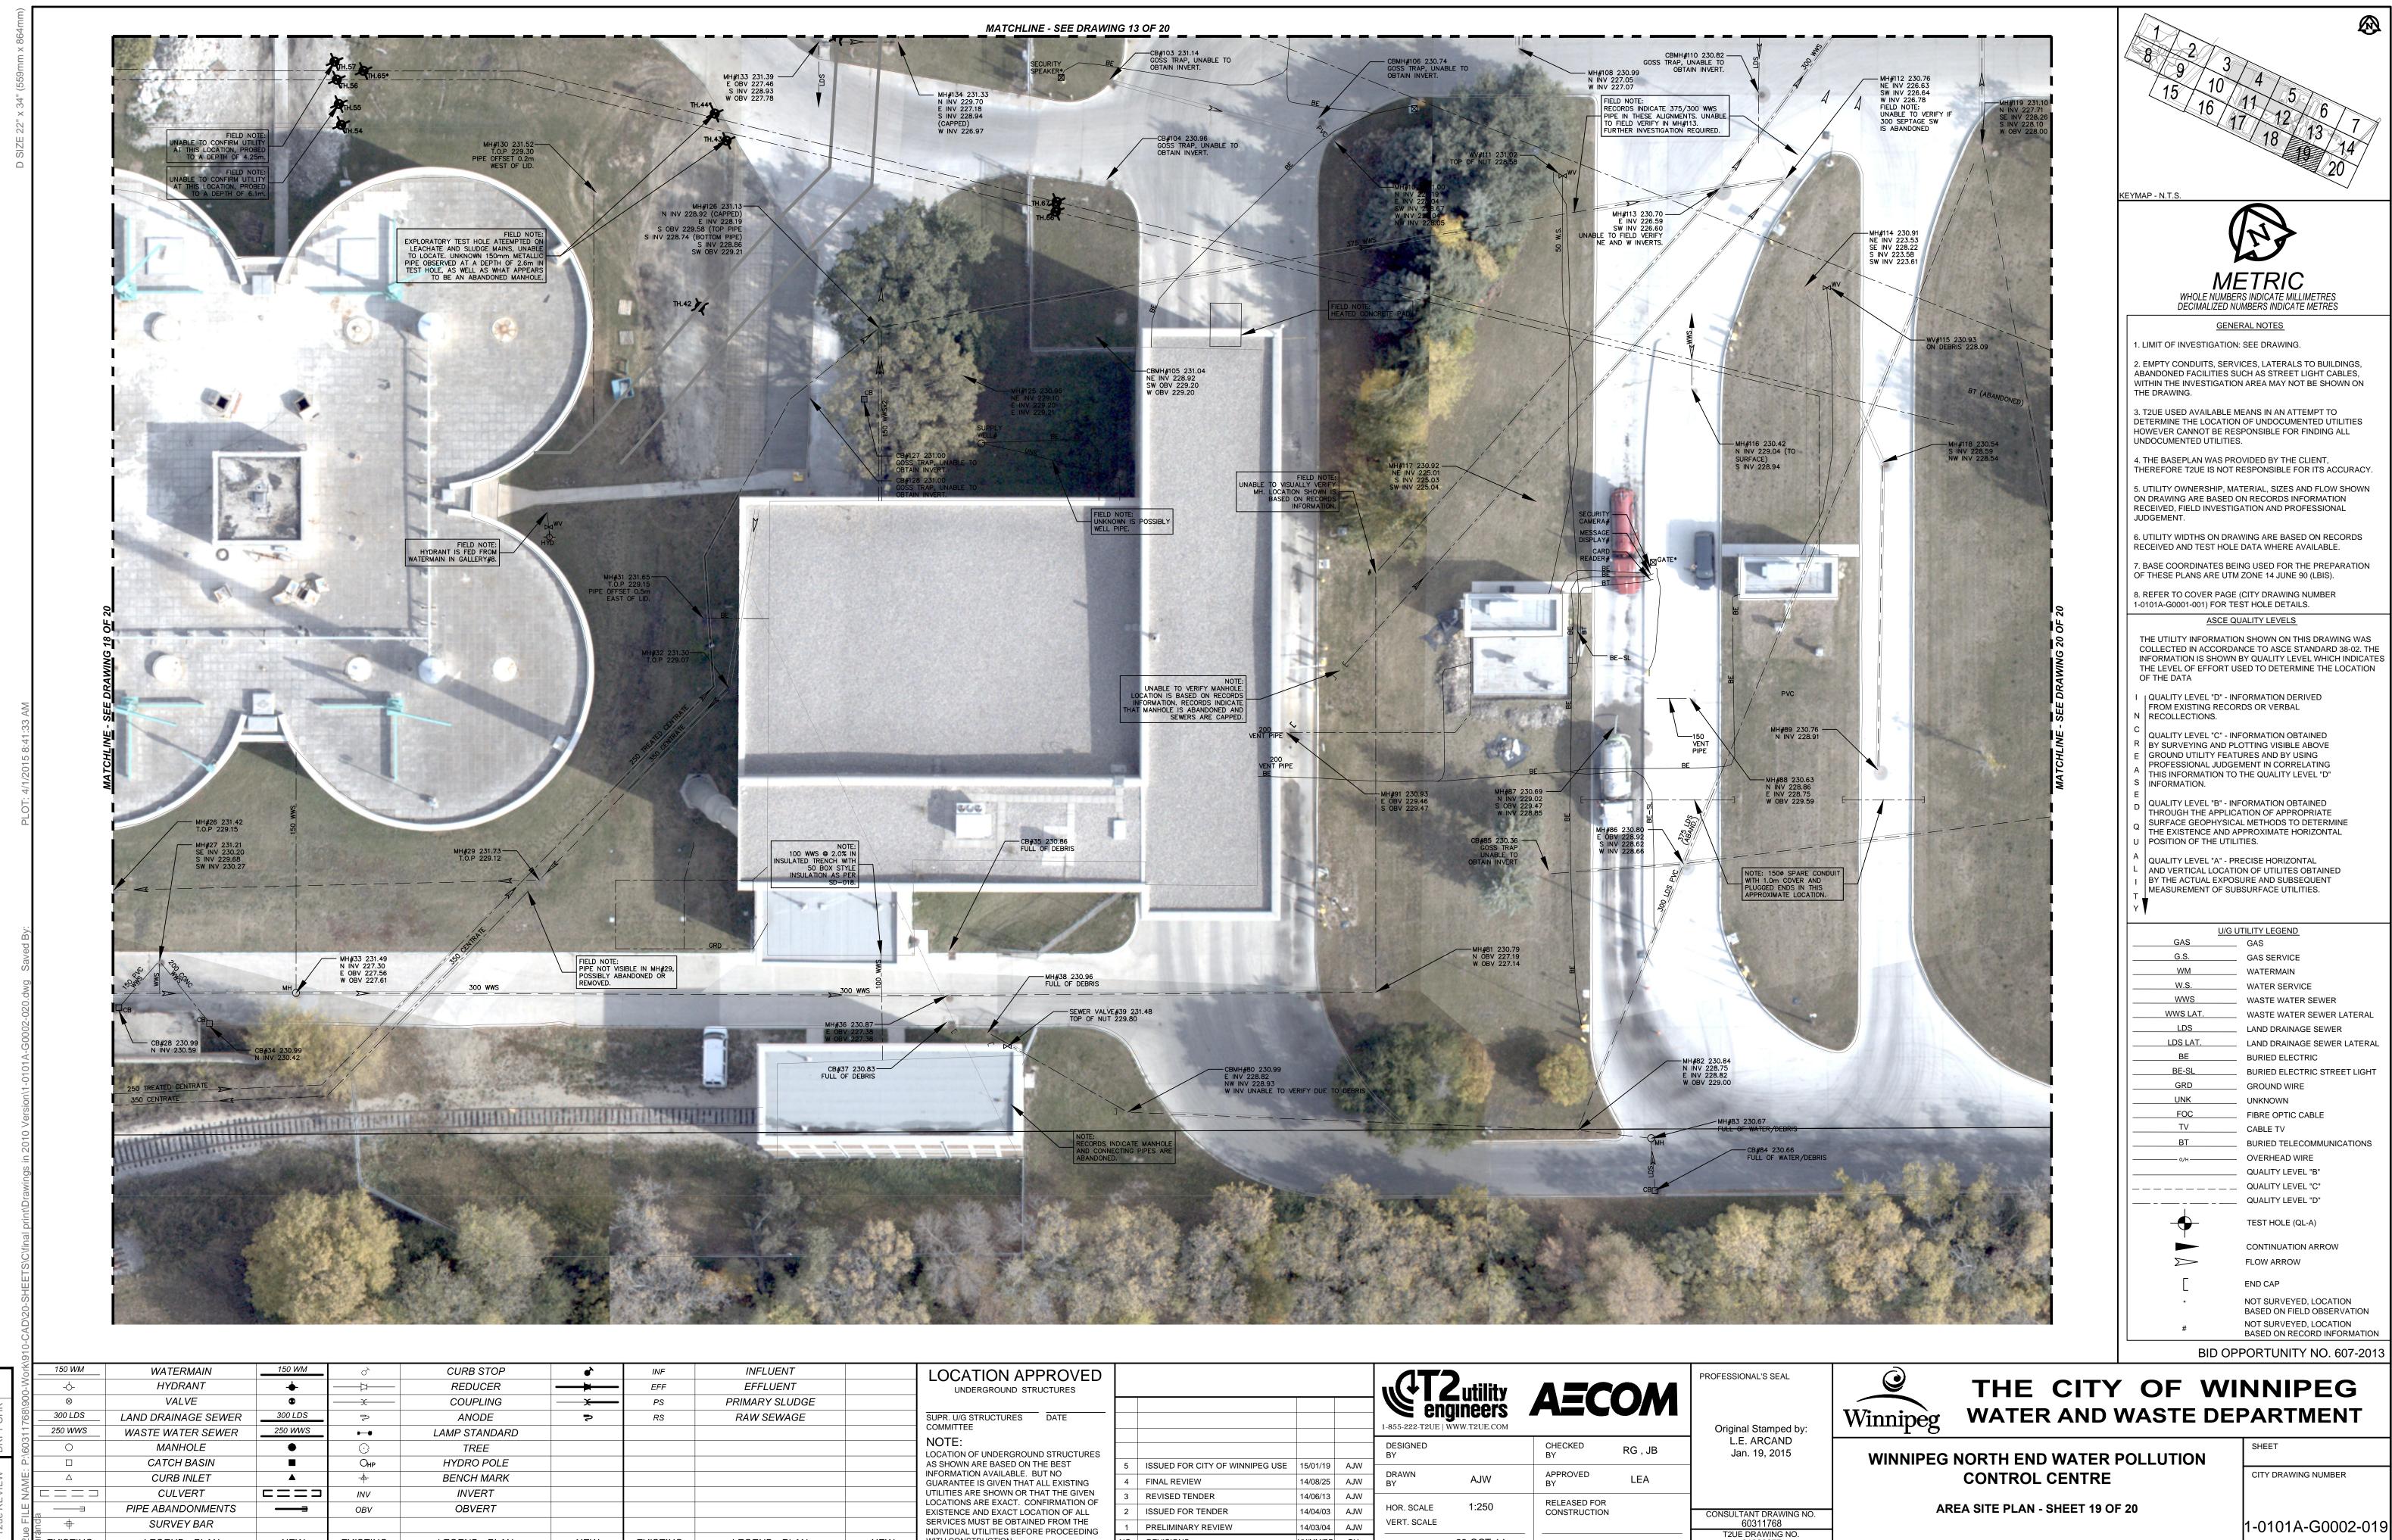
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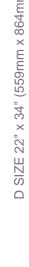
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