



**CHANNEL LEVEL PLAN**

1:100

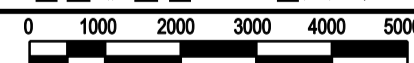


**NOTES:**

- DESIGN LIVE LOAD FOR INLET CHANNEL ROOF IS 5 kPa.
- \*-DENOTES LOCATION OF TYPE 1 DAVIT CRANE BASE INSERT.

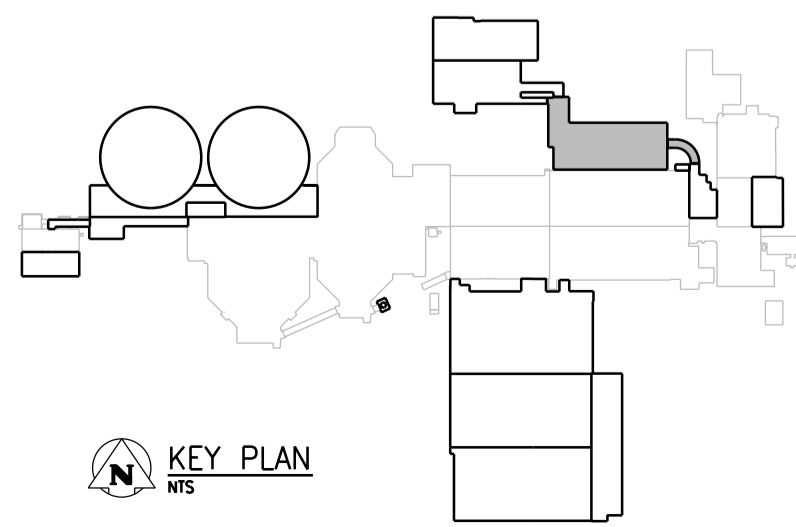


KEY PLAN

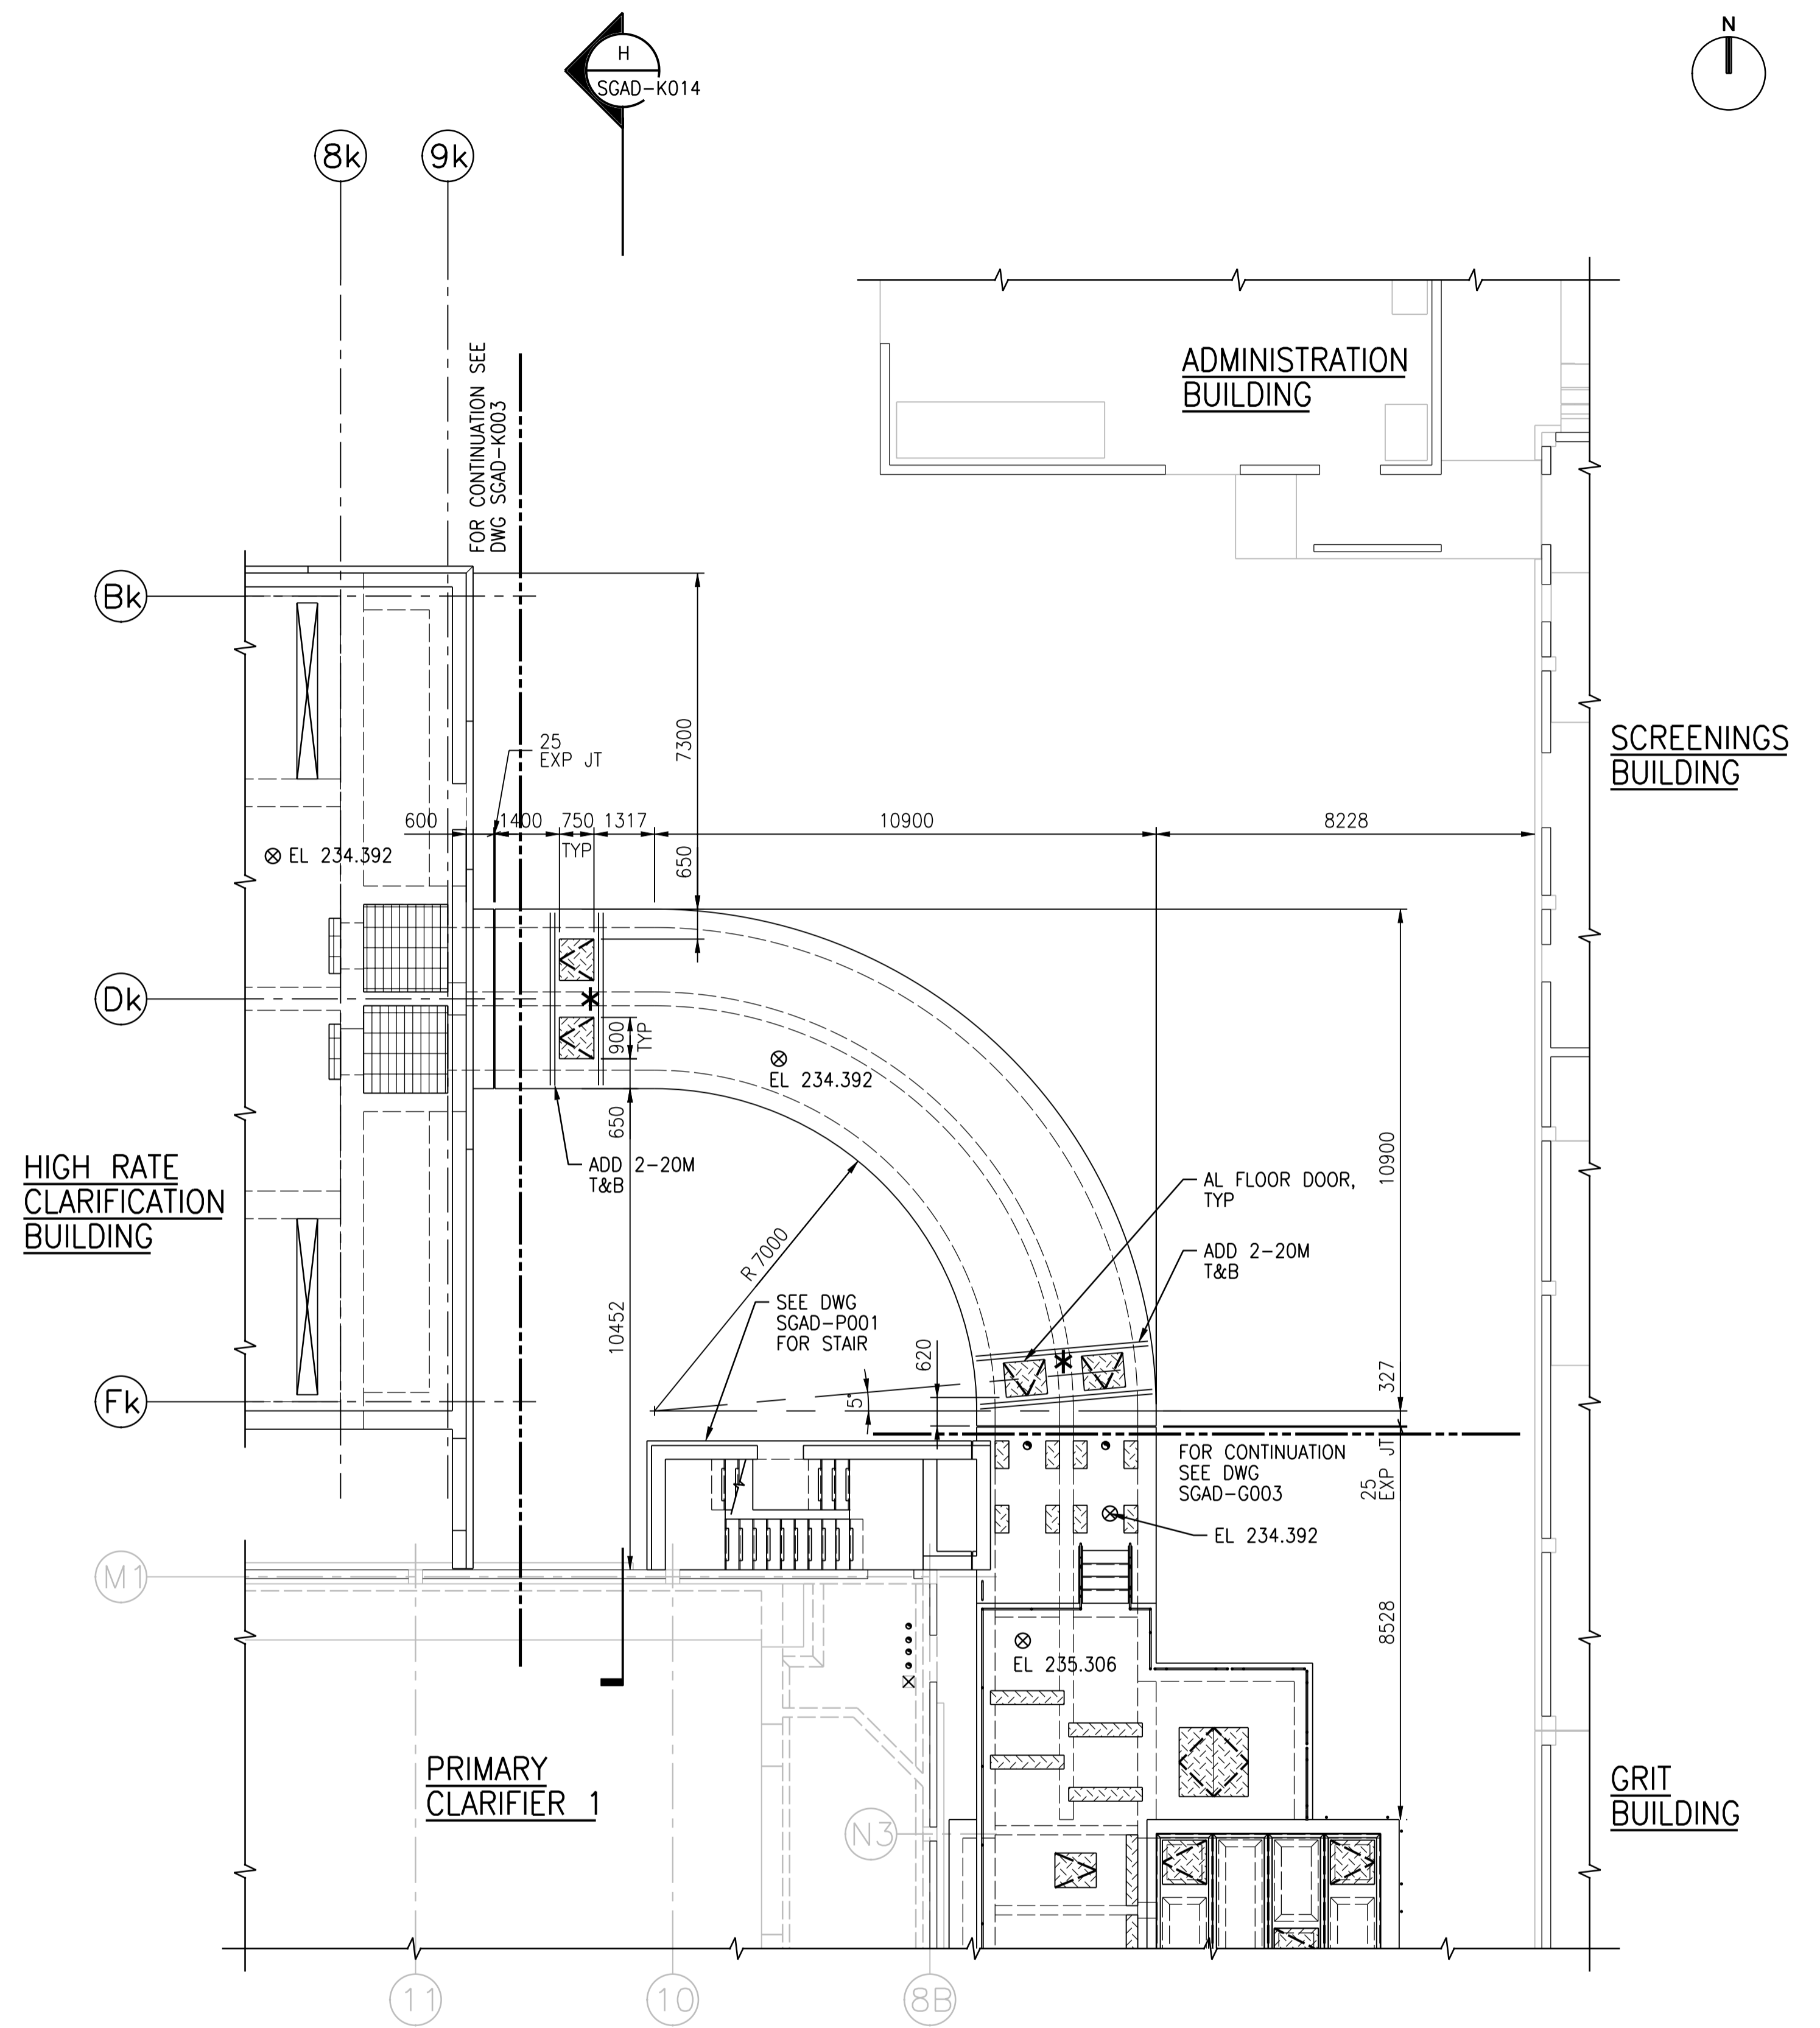

**GROUND FLOOR PLAN**

1:100

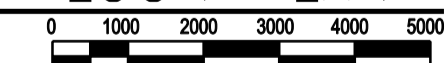

NO.	REVISIONS	DATE	DESIGN	CHECK
00	ISSUED FOR TENDER	08/2015	G.O.	J.C.

<b>CH2MHILL.</b>		<b>KCS GROUP CONSULTING ENGINEERS</b>	
DESIGNED BY: E. LUI	CHECKED BY: R. PARIKH	ENGINEER'S SEAL	
DRAWN BY: G. OMORI	APPROVED BY: E. LUI	13 AUG 2015 PROVINCE OF MANITOBA S.L.E. LUI Member 37003 REGISTERED PROFESSIONAL ENGINEER	
SCALE: 1:100	ISSUED FOR CONSTRUCTION BY: T. TURZAK	DATE: 2015/08/13	
DATE: 2015/08/13	DATE: 2015/08/13	CONSULTANT NO.: 474248	

SOUTH END WATER POLLUTION CONTROL CENTRE SEWPCC UPGRADING/EXPANSION PROJECT STRUCTURAL HIGH RATE CLARIFICATION BUILDING INFLUENT CHANNELS PLANS		
CITY DRAWING NUMBER 1-0102-SGAD-K005	SHEET 00	REV. SIZE A1