
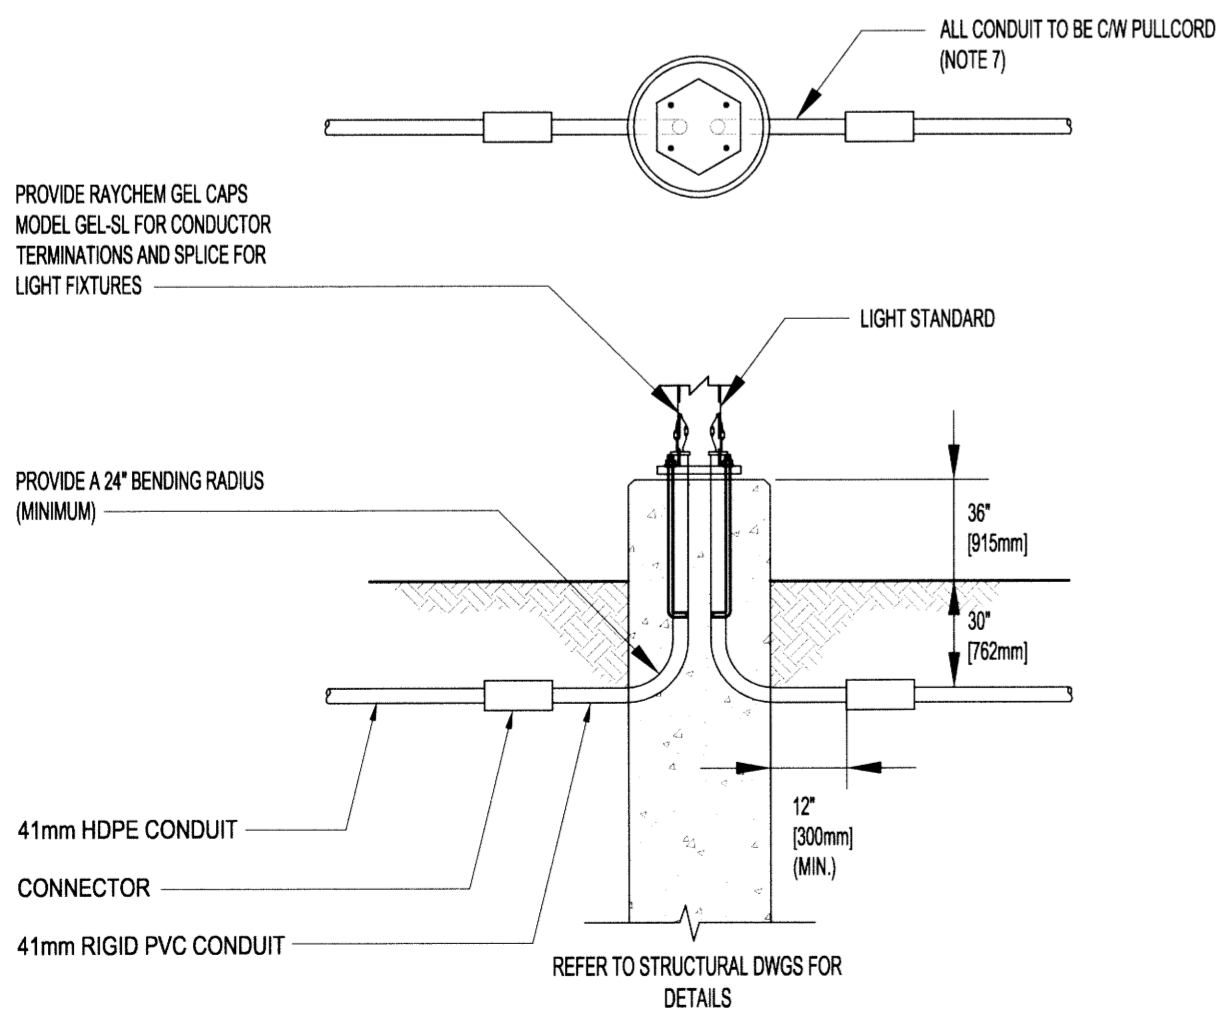


- ELECTRICAL NOTES:**
- GREY SHADED LINES DENOTE EXISTING.
  - DISCONNECT AND REMOVE THE EXISTING PARKING LOT HALOGEN FLOOD LIGHTS, POLES AND WIRING. UNDERGROUND CONDUITS AND WIRE SHALL BE ABANDONED.
  - PROVIDE FIVE (5) NEW PARKING LOT LIGHT FIXTURES COMPLETE WITH POLES, WIRING AND CONTROLS.
  - CONTRACTOR TO CONFIRM THE EXACT LOCATION OF ALL EXISTING UNDERGROUND AND OVERHEAD LINES ON SITE PRIOR TO PROCEEDING WITH THE NEW INSTALLATION.
  - CONTRACTOR TO PROVIDE LOCATES AND SOFT EXCAVATIONS AS REQUIRED.
  - THE CONTRACTOR SHALL PATCH AND RESTORE ANY DAMAGE TO THE ASPHALT CAUSED BY THIS SCOPE OF WORK.
  - MOUNT POLES ON CONCRETE BASES, CENTERED, PLUMBED AND TRUE. UTILIZE SHIMS AS REQUIRED.
  - POWER THE NEW PARKING LOT FIXTURES USING EXISTING 15A PARKING LOT CIRCUIT AND CONTROL RELAY.
  - POWER FEEDERS SHALL BE PUSHED UNDERGROUND IN HDPE CONDUIT. NEW POWER FEEDERS SHALL BE MINIMUM #10AWG RWU/90 CU.

**NOTES:**  
 THESE DRAWINGS SHALL NOT BE SCALED.  
 THE CONTRACTOR SHALL VISIT THE SITE AND SATISFY ONESELF ALL DIMENSIONS, DATUM, AND DETAILED INFORMATION SHOWN ARE CORRECT.  
 ALL PRODUCTS AND MATERIALS TO BE USED AND INSTALLED SHALL CONFORM WITH MANUFACTURERS SPECIFICATIONS & APPLICABLE CODES.

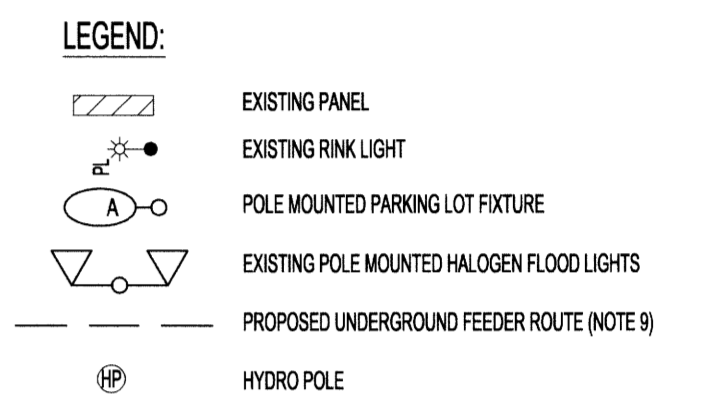

**A** PARKING LOT LIGHT POLE CONNECTION  
SCALE: N.T.S.

LUMINAIRE SCHEDULE				
TYPE	DESCRIPTION	VOLTAGE	LAMPS	DESIGN BASICS
A	33"x13" LED PARKING LOT FIXTURE COMPLETE WITH TYPE IV DISTRIBUTION, HOUSE SIDE SHIELD, 9421 LUMEN OUTPUT AND DARK BRONZE FINISH	120V	131W LED 4000°K	LITHONIA: DSX1 LED 60C 700 40K 14M 120 SPA HS DBXD
	24" LONG SQUARE STEEL POLE COMPLETE WITH DARK BRONZE FINISH			VALMONT: 5SS-24.0.1 DARK BRONZE

No.	REVISION/DESCRIPTION	BY	DATE
0	ISSUED FOR CONSTRUCTION		15.03.19

SEAL

DRAWN: GCN, CHECKED: [Signature], DESIGNED: CLS, APPROVED: [Signature]

DATE: 2014.11.10 USER APPROVAL

THE CITY OF WINNIPEG  
 PLANNING, PROPERTY AND  
 DEVELOPMENT DEPARTMENT  
 MUNICIPAL ACCOMMODATIONS DIVISION  
 3-65 GARRY STREET, R3C 4K4

PROJECT  
 CHALMERS COMMUNITY CENTRE  
 PARKING LOT LIGHTING UPGRADE

480 CHALMERS AVENUE  
 SHEET TITLE

ELECTRICAL  
 SITE PLAN

SCALE	PROJECT No:	SHEET No:
AS SHOWN	2015-78	E1

