


**1** 1:50  
**BOTTOM LAYER RADIAL REINFORCEMENT DETAIL**  
 SGAD-S003

**GENERAL NOTES:**

1. READ THIS DRAWING IN CONJUNCTION WITH SECTION **B** SGAD-S020 FOR THE REINFORCEMENT NOT SHOWN.
2. THE 1/16TH PORTION (22.5°) SHOWS PART REINFORCEMENT. THE SAME REINFORCEMENT IS APPLICABLE ALL AROUND FOR BOTH CLARIFIER BASE SLABS (360°).

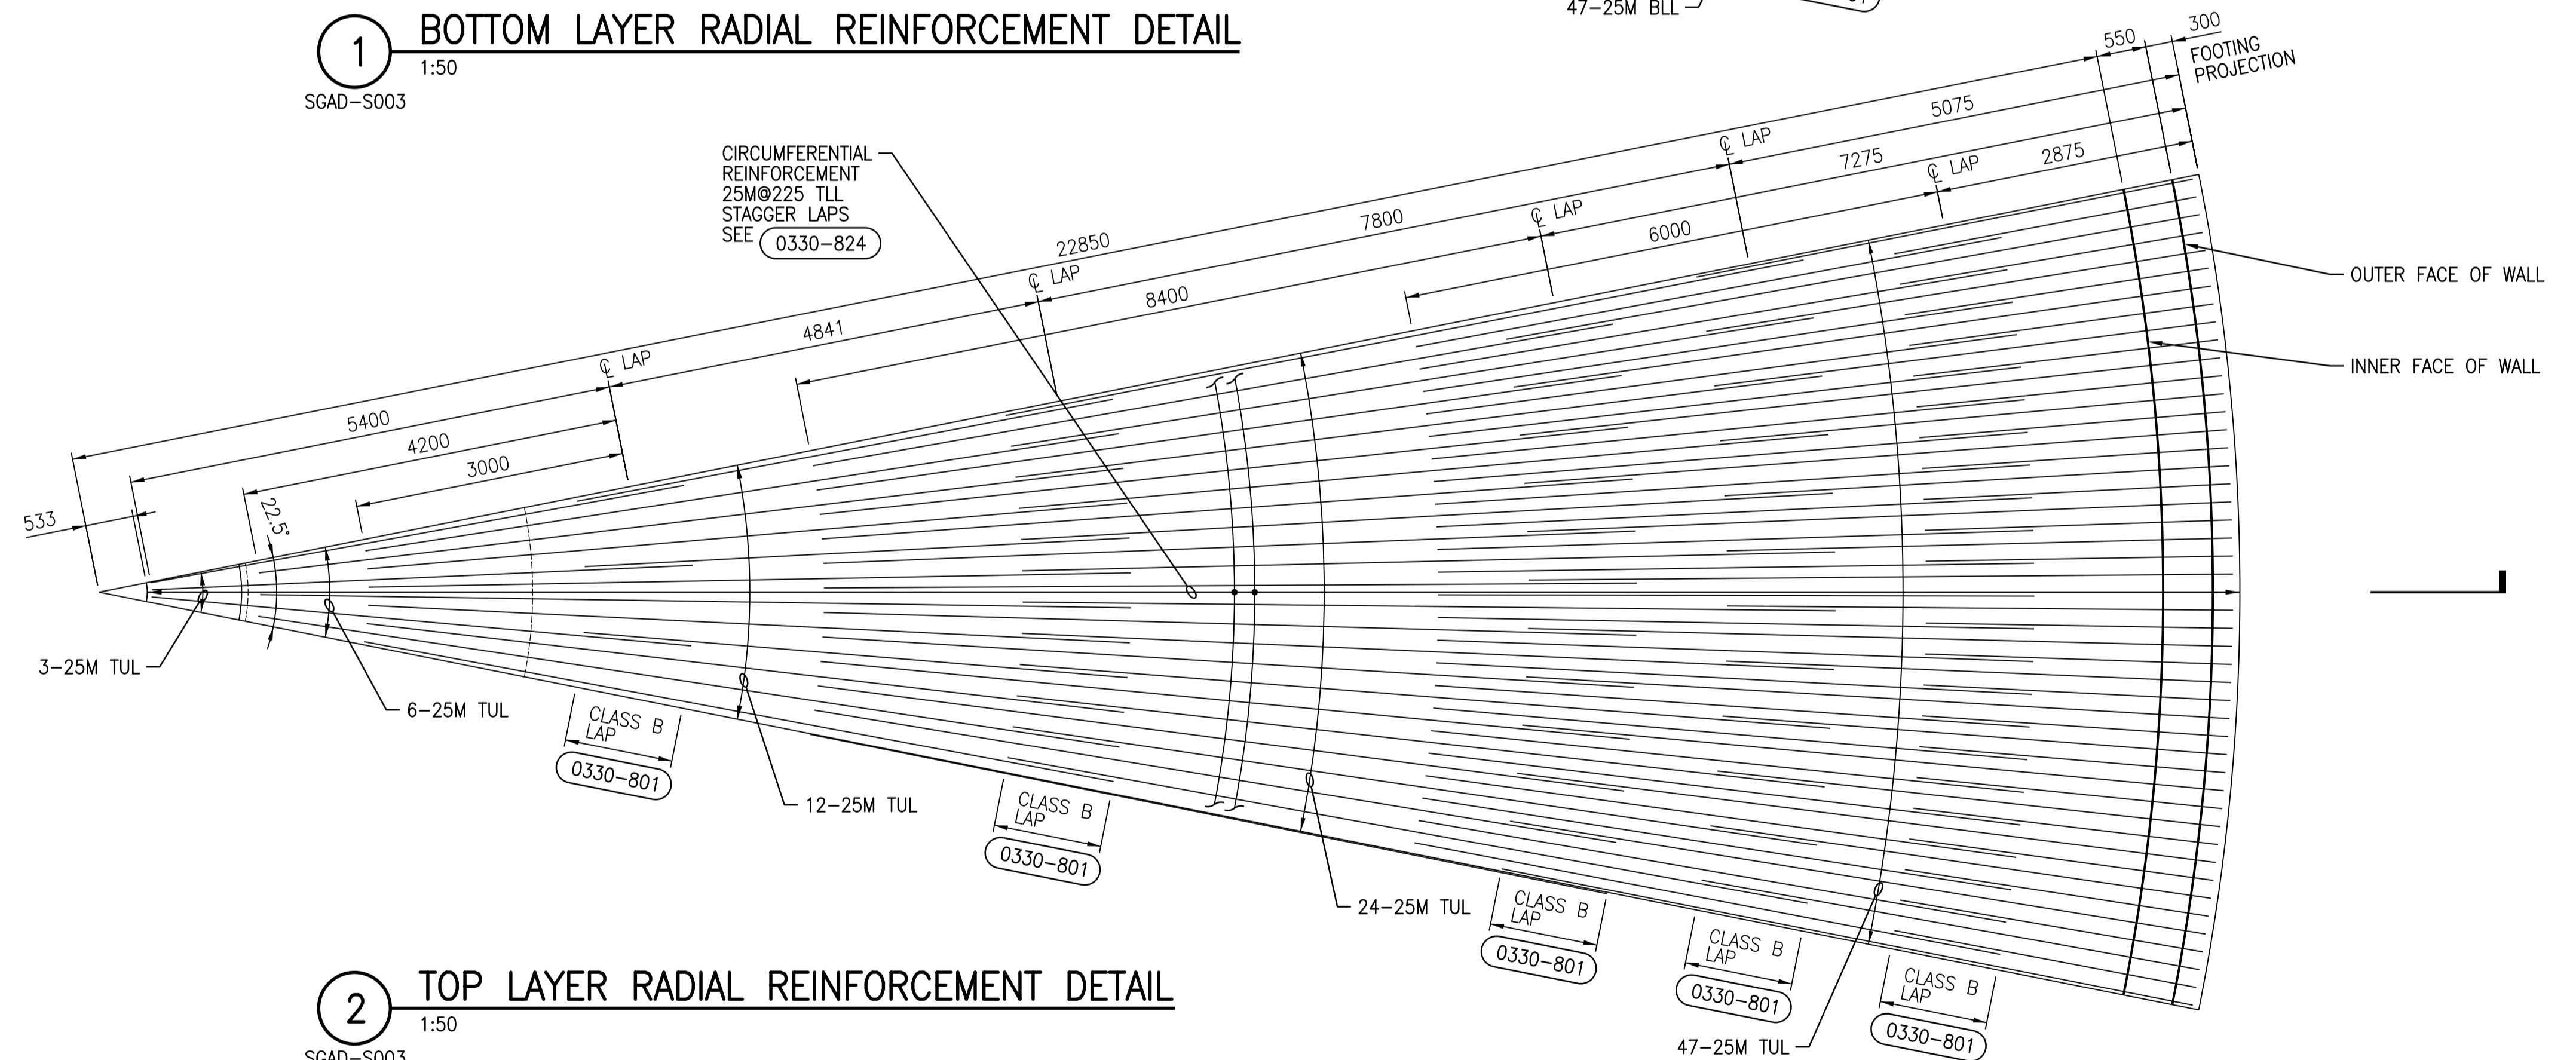


**2** 1:50  
**TOP LAYER RADIAL REINFORCEMENT DETAIL**  
 SGAD-S003



NO.	REVISIONS	DATE	DESIGN	CHECK
01	ISSUED FOR ADD. 2 - B.O. 899-2015	02/2016	G.O.	J.C.
00	ISSUED FOR TENDER - B.O. 899-2015	01/2016	G.O.	J.C.

**CH2MHILL**  
 SNC-LAVALIN  
 DESIGNED BY: A THAKKAR  
 DRAWN BY: G. OMORI  
 SCALE: 1:50  
 DATE: 2016/01/29  
 CONSULTANT NO.: 474248

CHECKED BY: R. PARIKH  
 APPROVED BY: H.T. FREIHAMMER  
 ISSUED FOR CONSTRUCTION BY: T. TURZAK  
 DATE: 2016/01/29

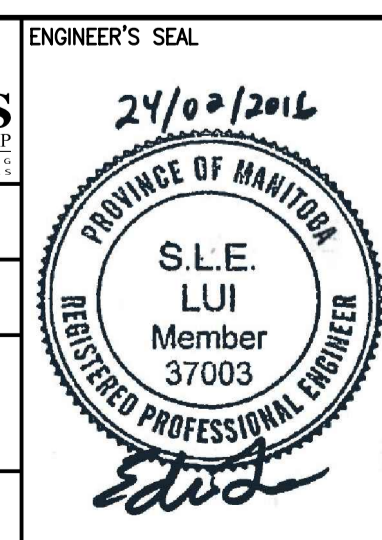

**THE CITY OF WINNIPEG**  
 WATER AND WASTE DEPARTMENT

SOUTH END WATER POLLUTION CONTROL CENTRE  
 SEWPCC UPGRADING/EXPANSION PROJECT  
 STRUCTURAL  
 SECONDARY CLARIFIERS 4 AND 5  
 DETAILS

CITY DRAWING NUMBER: 1-0102-SDTL-S002  
 SHEET: 001  
 REV: 01  
 SIZE: A1