
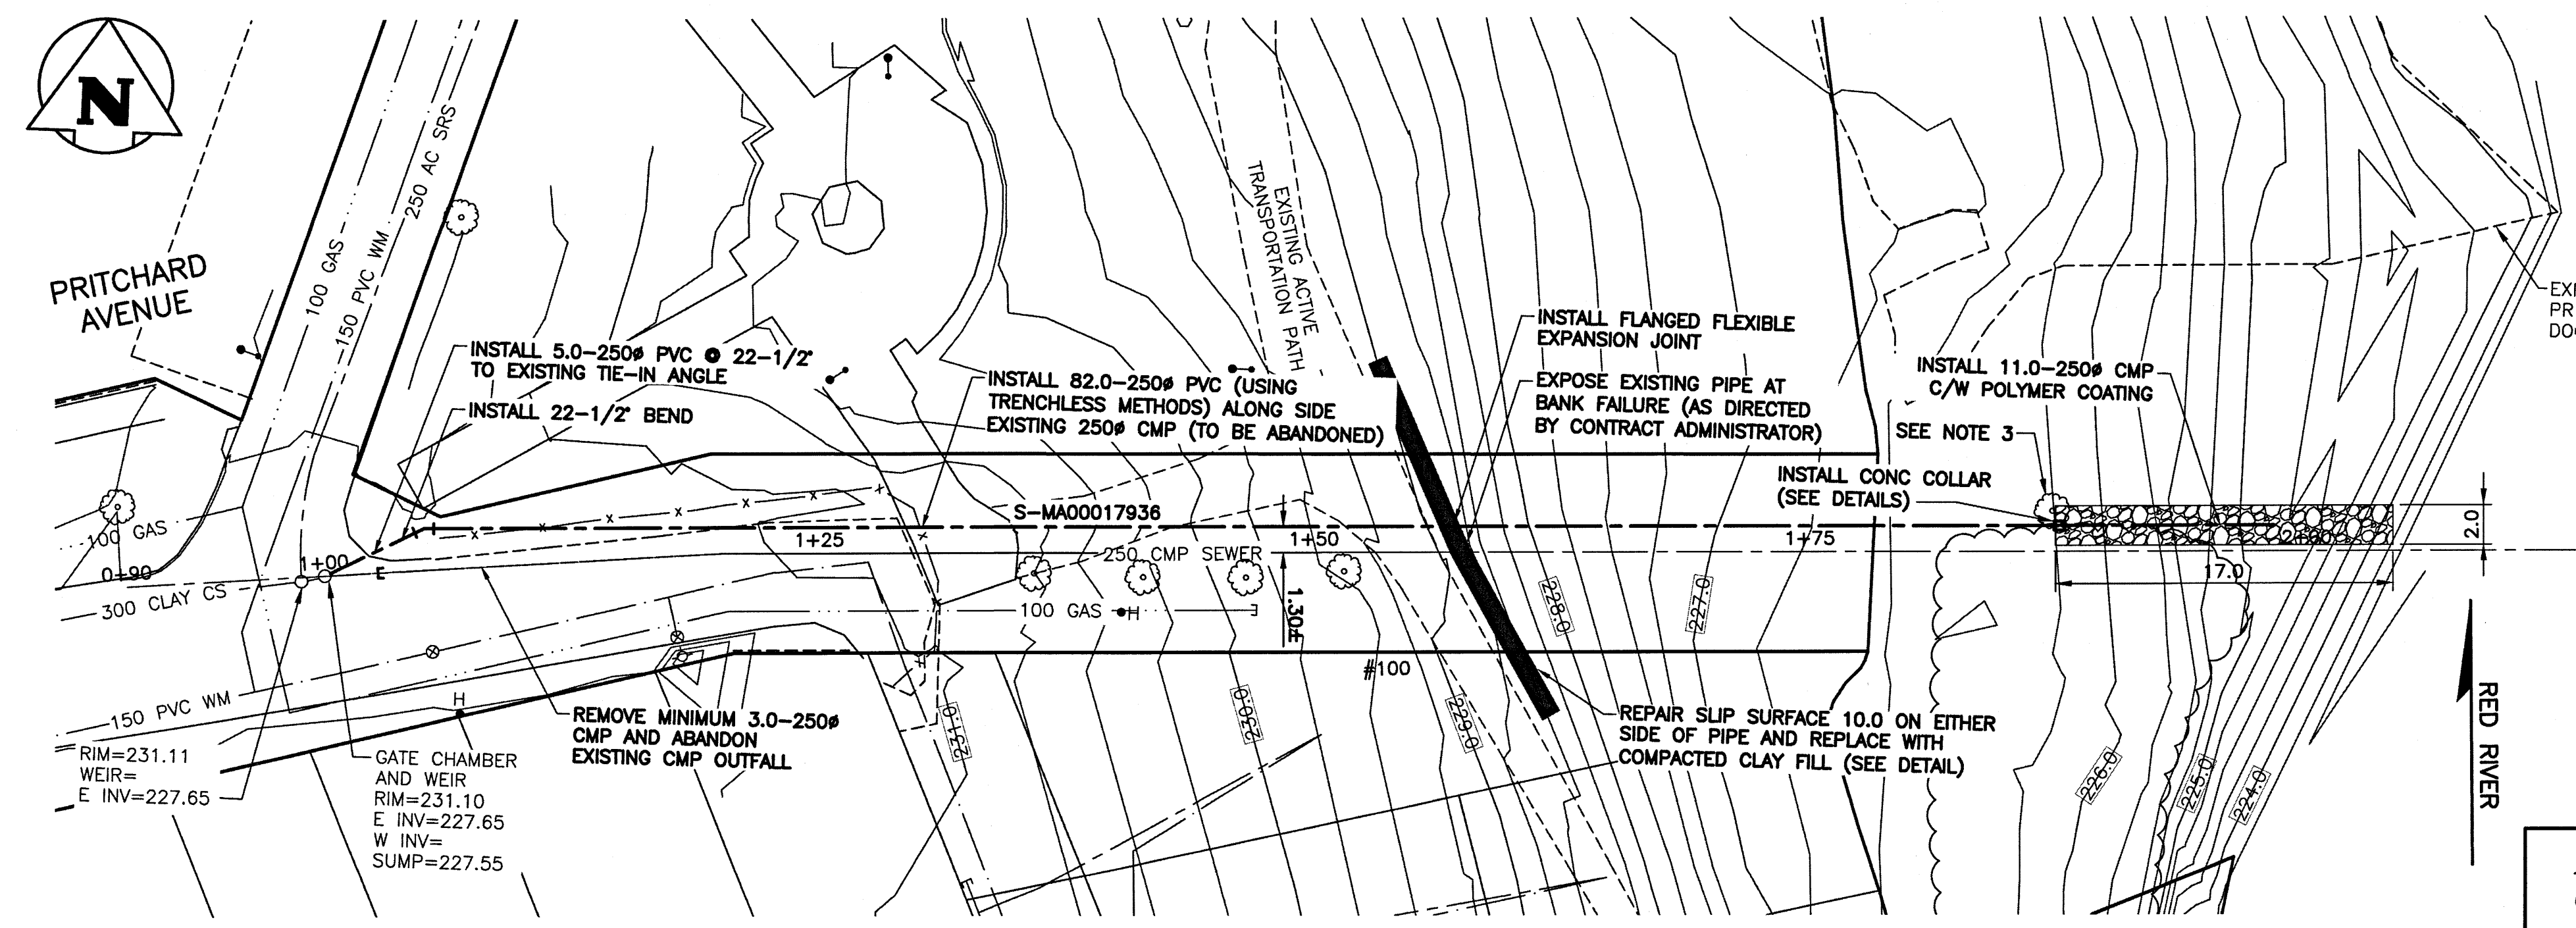
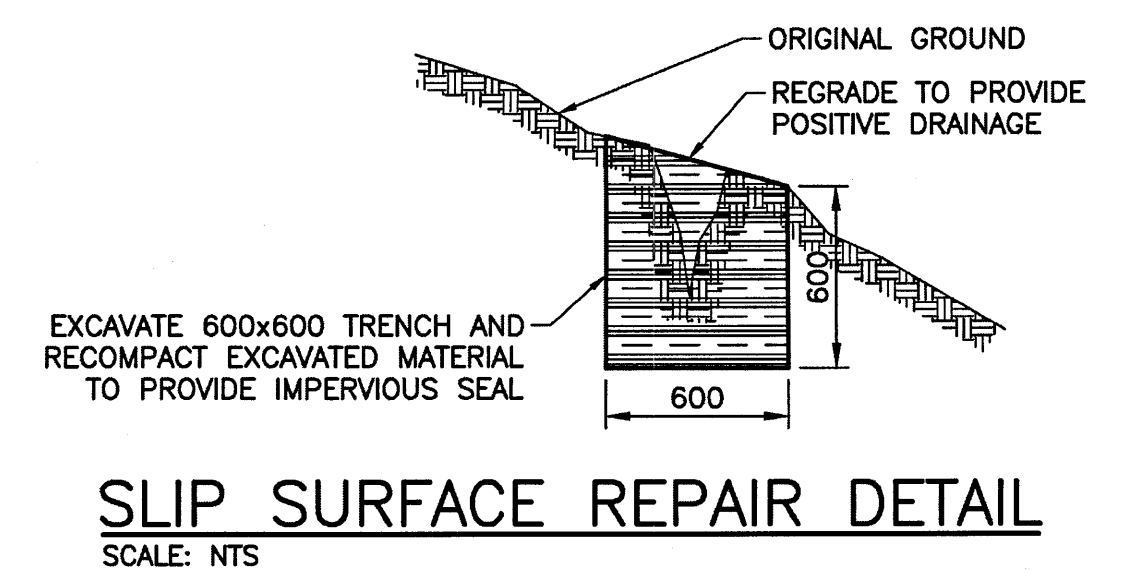
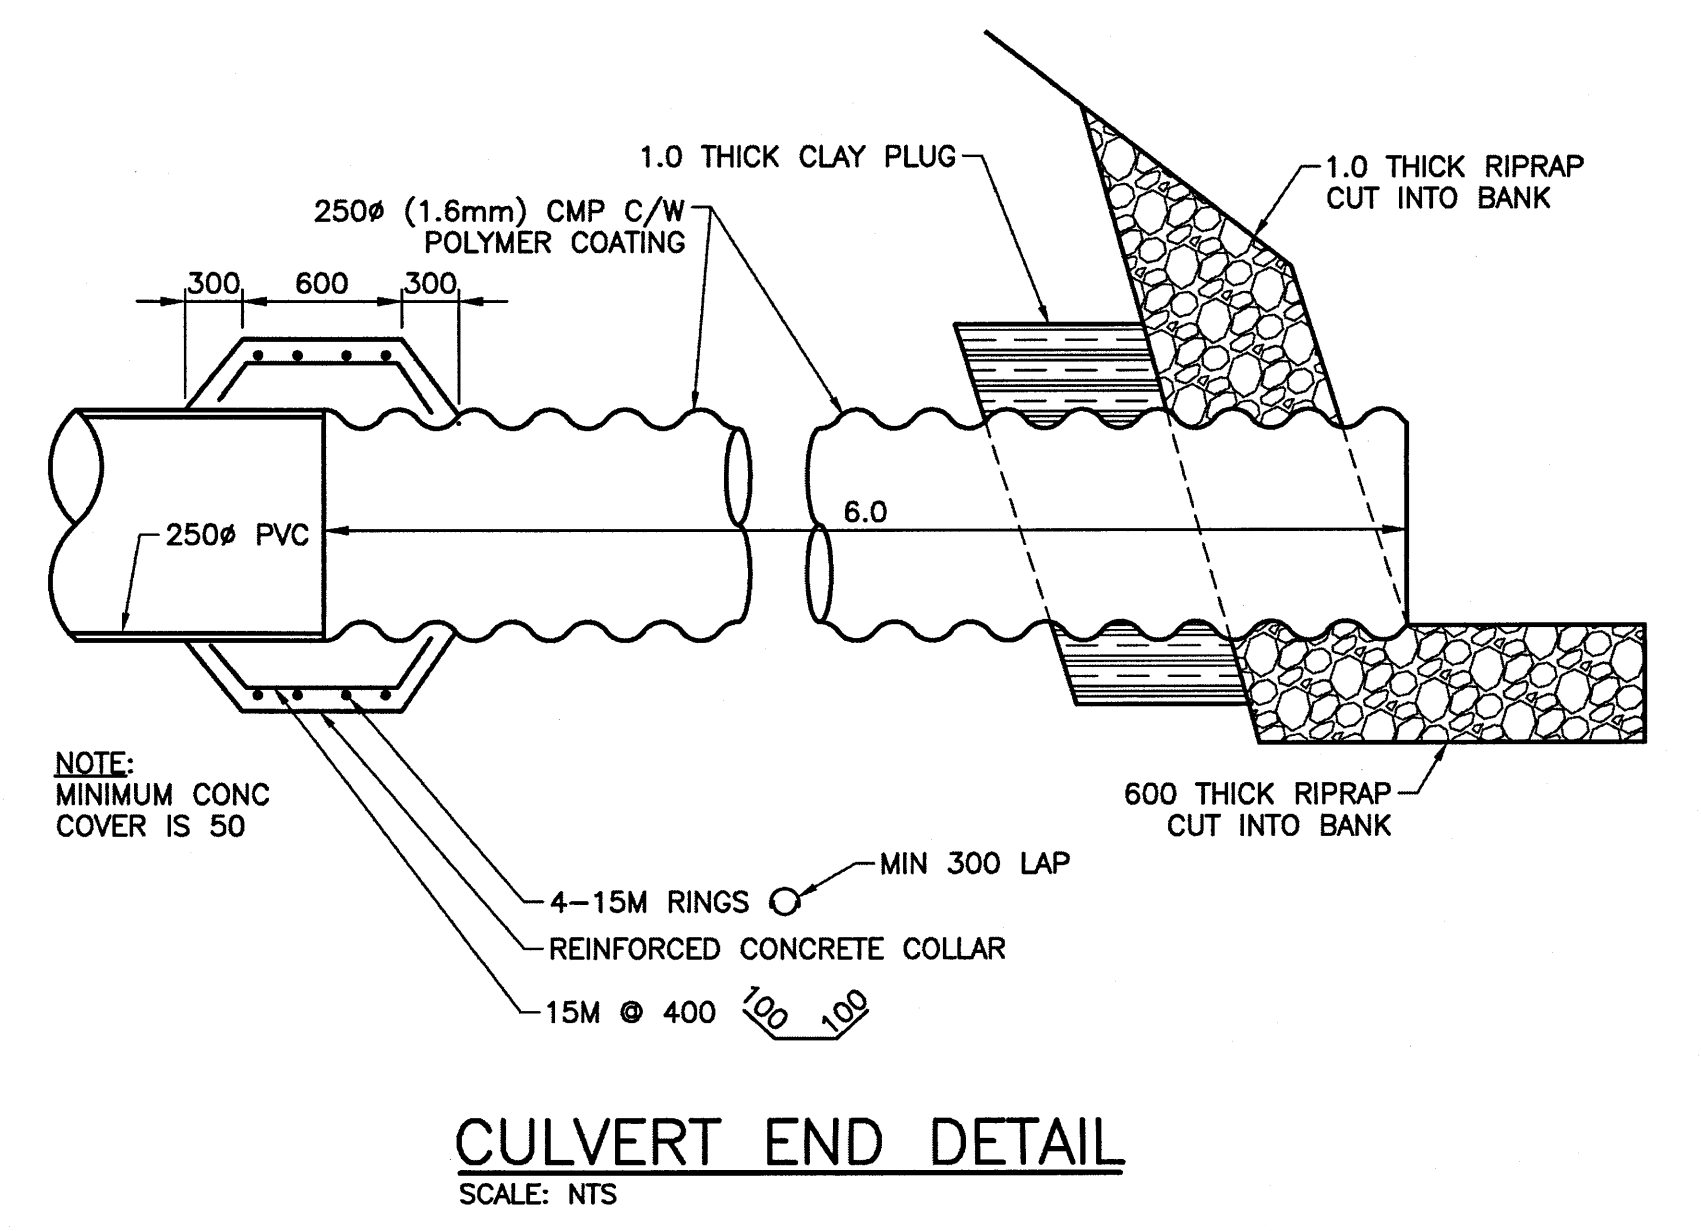


- NOTES:**
1. ALL EXCAVATED MATERIAL WITHIN 107.0 OF THE REGULATED SUMMER RIVER LEVEL (RSRL) MUST BE REMOVED FROM SITE (NO STOCKPILING).
 2. VERIFY ALIGNMENT OF EXISTING OUTFALL BEFORE INSTALLING NEW OUTFALL PIPE.
 3. REMOVE AND INSTALL NEW TREES AS DIRECTED BY THE CONTRACT ADMINISTRATOR.

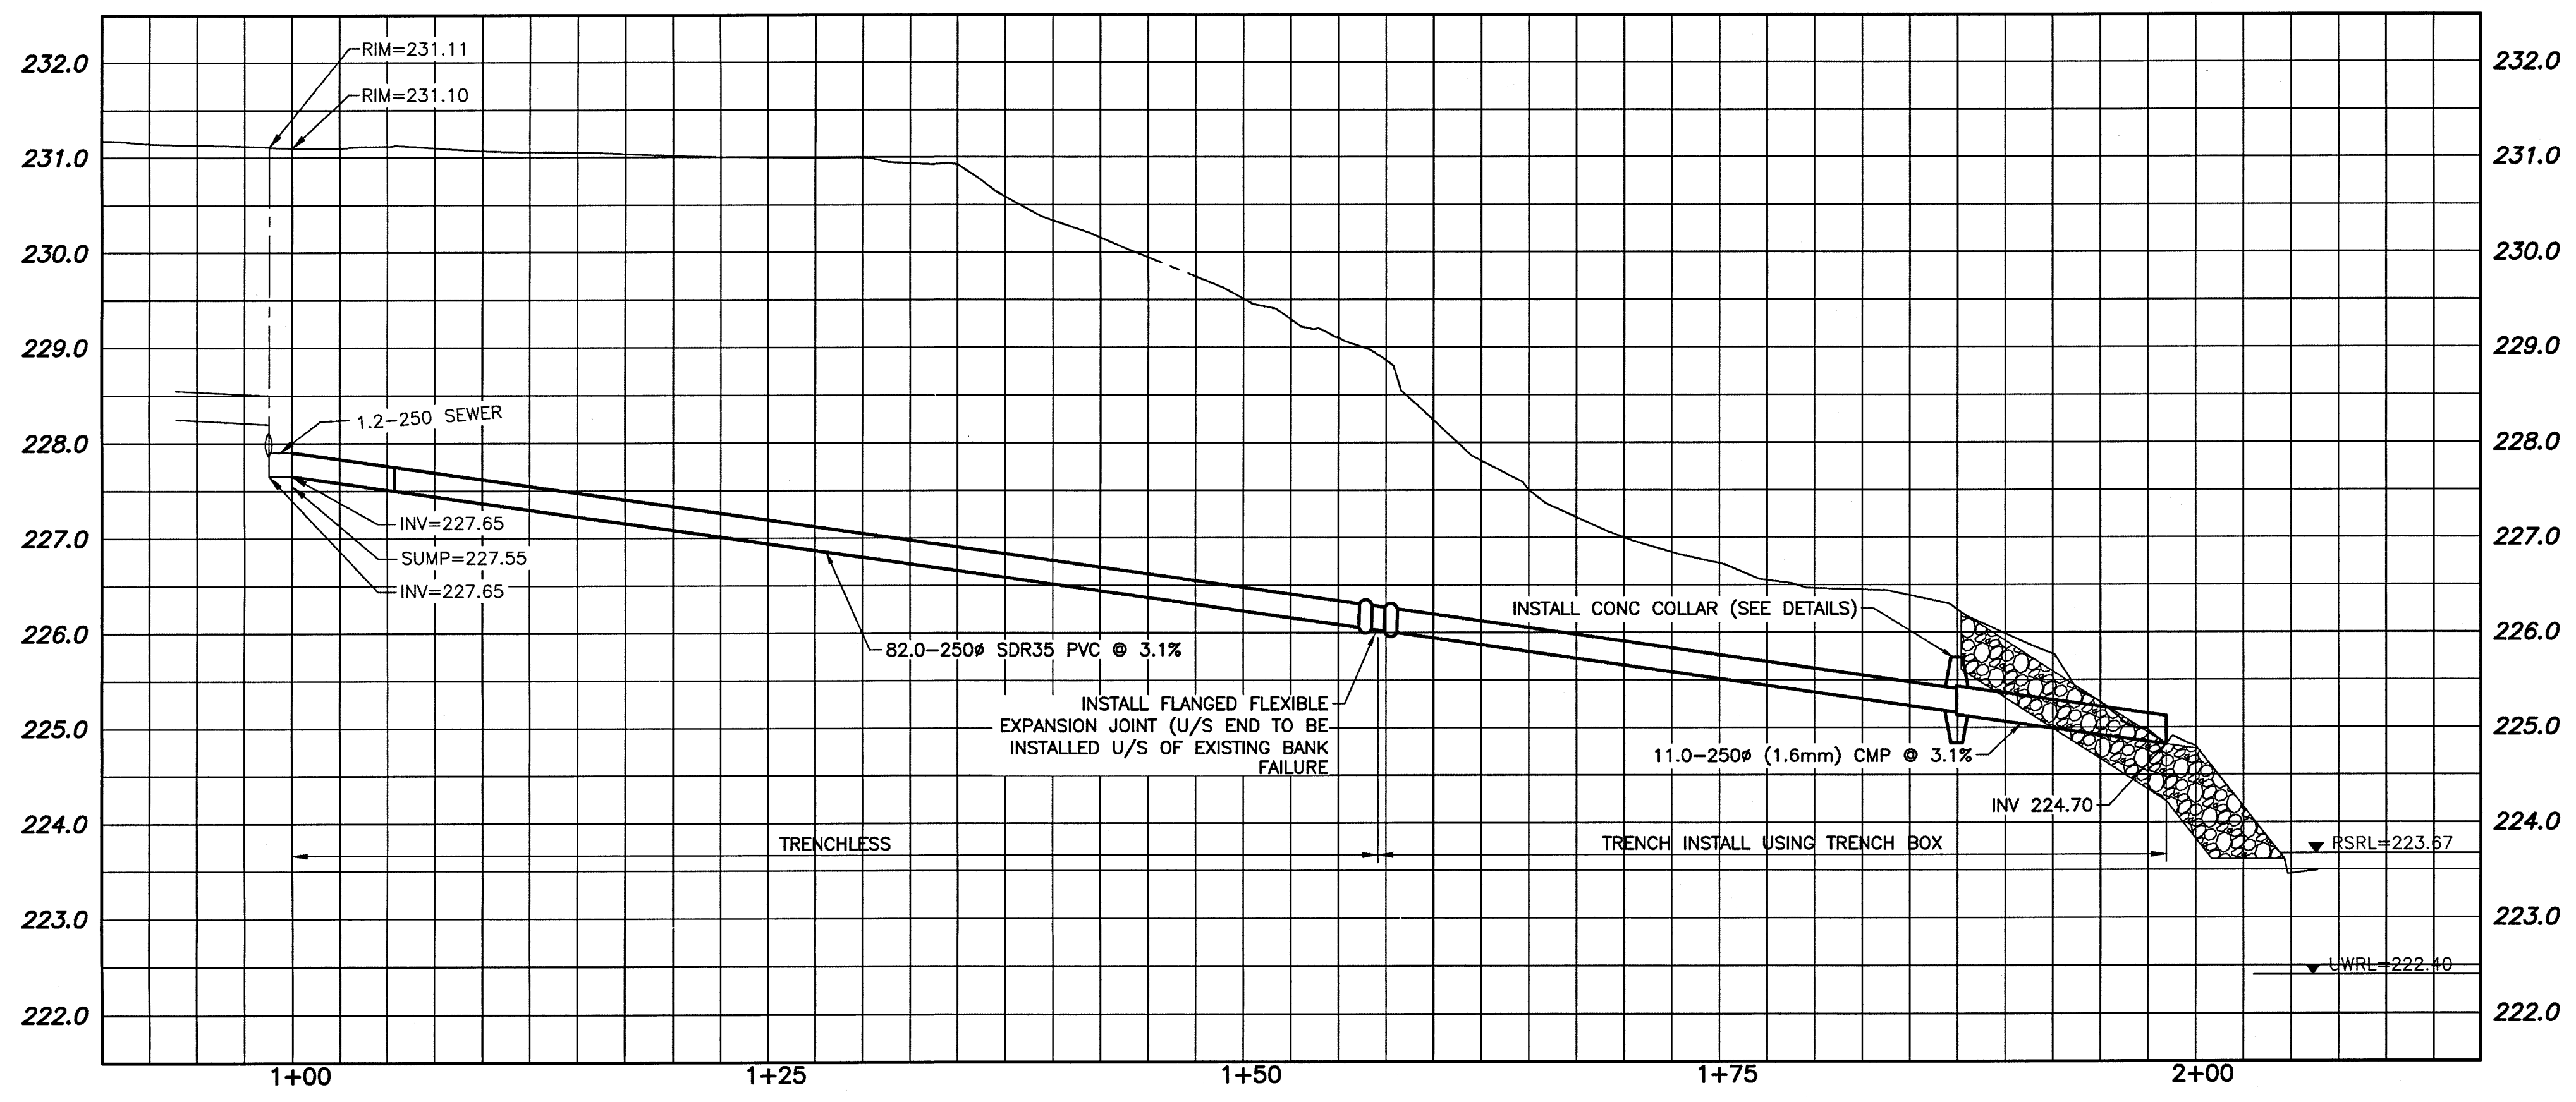

WARNING


1. NOTIFY THE GAS COMPANY OF THE PROPOSED LOCATION OF EXCAVATION.
2. TAKE PRECAUTION TO AVOID DAMAGE TO GAS COMPANY INSTALLATIONS.
3. SEE PROVINCIAL REGULATION 210/72 FOR DETAILS.

PROPERTY LIMITS DELINEATION

DELINEATION OF PROPERTY LIMITS AS SHOWN ON THIS DWG DOES NOT REPRESENT A "LEGAL SURVEY". KGS GROUP MAKES NO REPRESENTATION OR WARRANTY AS TO THE ACCURACY OF PROPERTY LIMITS DELINEATED ON THIS DWG, NOR ON THE DIMENSIONAL ACCURACY OF DWG FEATURES RELATIVE TO THOSE PROPERTY LIMITS.

METRIC

WHOLE NUMBERS INDICATE MILLIMETRES
DECIMALIZED NUMBERS INDICATE METRES

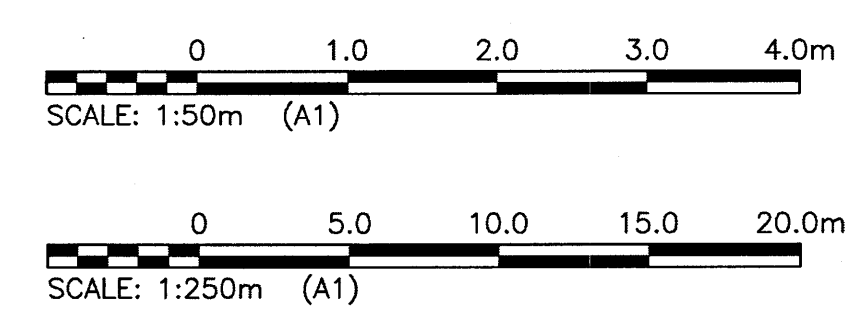

APEGM
Certificate of Authorization
KGS Group
No. 245

150 WM	WATERMAIN	150 WM	HYDRO
⊕	HYDRANT	⊕	M.T.S.
⊙	VALVE	⊕	PROPERTY LINE
300 IDS	LAND DRAINAGE SEWER	300 IDS	SURVEY BAR
250 WWS	WASTE WATER SEWER	250 WWS	LIGHT STANDARD
○	MANHOLE	●	HYDRO POLE
□	CATCH BASIN	⊖	GUY WIRE
▽	CURB INLET	○	SIGN
+	JUNCTIONS	+	BUSH LINE
▭	CULVERT	+	FENCE
---	GAS	231.334	ELEVATION
---	EXISTING	---	LEGEND-PLAN
---	LEGEND-PLAN	---	PROPOSED
---	PROPOSED	---	EXISTING
---	EXISTING	---	LEGEND-PROFILE
---	LEGEND-PROFILE	---	PROPOSED
---	PROPOSED	---	EXISTING

LOCATION APPROVED UNDERGROUND STRUCTURES

NOTE:
LOCATION OF UNDERGROUND STRUCTURES AS SHOWN ARE BASED ON THE BEST INFORMATION AVAILABLE. BUT NO GUARANTEE IS GIVEN THAT ALL EXISTING UTILITIES ARE SHOWN OR THAT THE GIVEN LOCATIONS ARE EXACT. CONFIRMATION OF EXISTENCE AND EXACT LOCATION OF ALL SERVICES MUST BE OBTAINED FROM THE INDIVIDUAL UTILITIES BEFORE PROCEEDING WITH CONSTRUCTION.

B.M. KGS_BASE
ELEV=249.213 NAD83 CSRS CGVD28

KGS GROUP
CONSULTING ENGINEERS

DESIGNED BY: JB
DRAWN BY: DMW
CHECKED BY: RBO
APPROVED BY: [Signature]
HOR. SCALE: 1:250
VERTICAL: 1:50
DATE: 28/09/16

ENGINEER'S SEAL
PROF. BOB BOSCHOW
Member 34869
2016-11-03
CONSULTANT DRAWING NO. 16-0107-021_003

THE CITY OF WINNIPEG
WATER & WASTE DEPARTMENT

2017 OUTFALL RENEWAL/REHABILITATION PROGRAM
PRITCHARD AVENUE OUTFALL (RR-75)
PLAN AND PROFILE
S-MA00017936

SHEET 03 OF 08
CAD FILE DRAWING NUMBER 16-0107-021_CALL
CITY DRAWING NUMBER LD-7988

File Name: U:\E\16-0107-021\16-0107-021_CALL.dwg - Tab: C03 Plotted By: dweber 16/11/03 [Thu 3:04pm]