


**MAIN FLOOR PLAN**  
SCALE: 1/8"=1'-0"

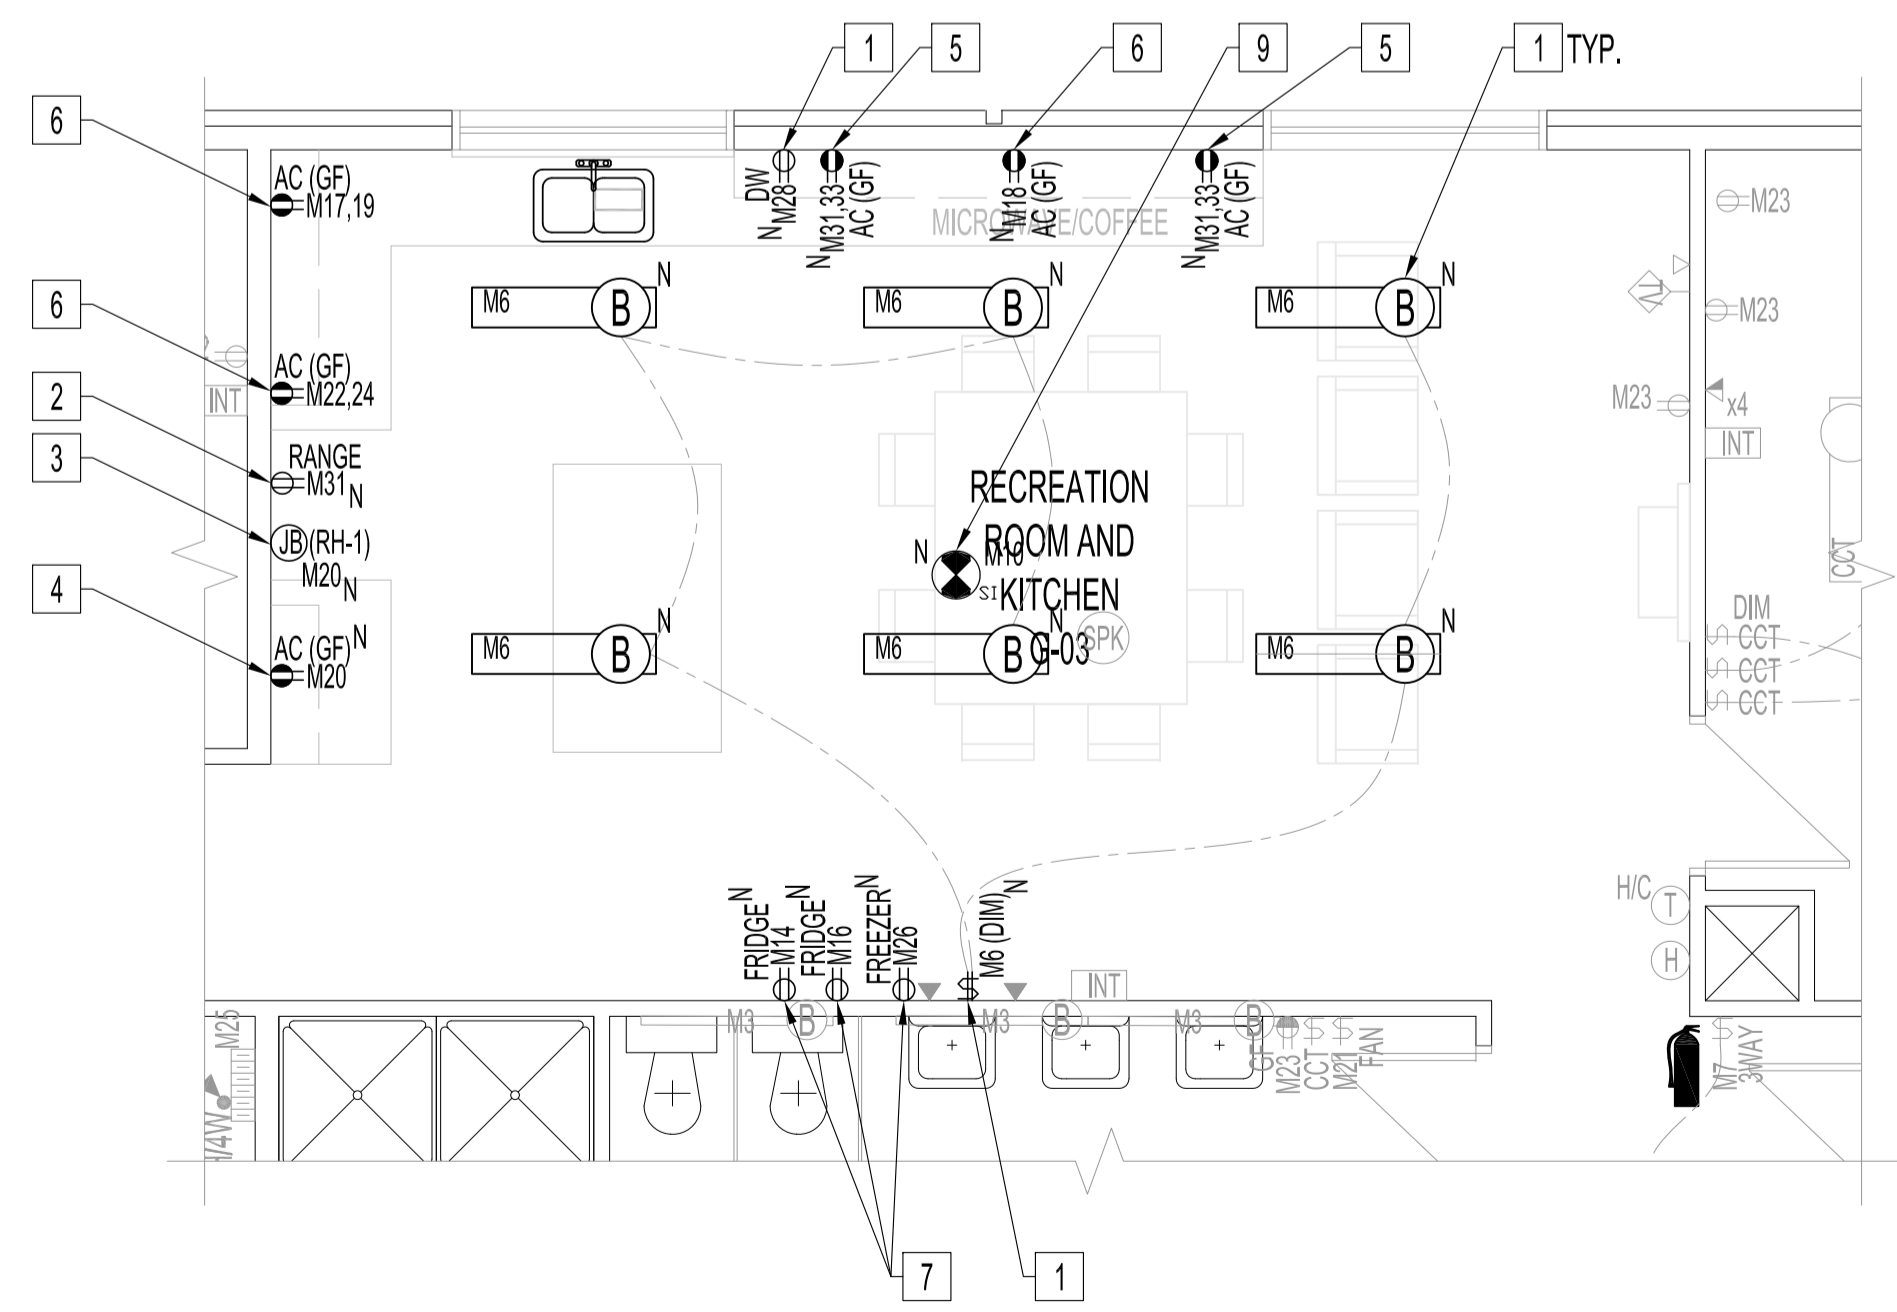


**RENOVATION - PARTIAL MAIN FLOOR PLAN**  
SCALE: 1/4"=1'-0"

**ELECTRICAL POWER & SYSTEMS**  
**RENOVATION NOTES: "X"**

- ALSO SEE NOTES & SPECIFICATIONS.  
ALL WIRING & CABLING IN CEILING SPACE SHALL BE IN EMT OR AC90 AS PER LATEST CEC.  
COORDINATE ALL RECEPTACLE OPENINGS WITH STAINLESS STEEL CABINET MANUFACTURER.
1. REPLACE LUMINAIRES & LIGHT SWITCHES IN RECKITCHEN WITH TYPE SHOWN. WIRE TO NEW 2-GANG DIMMER SWITCH WITH 0-10V CONTROL.
  2. PROVIDE DEDICATED RANGE RECEPTACLE, 120V, 15A CIRCUIT, #12/2 RW90 IN EMT TO 15A-1P BREAKER. MOUNT HEIGHT TO ALLOW RANGE INSTALLATION.
  3. PROVIDE JUNCTION BOX BEHIND WIRE RANGE HOOD EXHAUST FAN, (RH-1) SEE MECHANICAL DRAWING, TO EXISTING CIRCUIT SHOWN.
  4. RELOCATE EXISTING MW RECEPTACLE CIRCUIT TO AC AS SHOWN. CHANGE TO GFCI RECEPTACLE.
  5. PROVIDE AC SPLIT-CIRCUIT RECEPTACLE, 120V, 15A CIRCUITS, #12/2 RW90 IN EMT TO 15A-1P BREAKERS.
  6. REPLACE WITH GFCI 15A DUPLEX RECEPTACLE.
  7. PROVIDE DEDICATED APPLIANCE RECEPTACLES & CIRCUITS SHOWN, 120V, 15A CIRCUIT, #12/2 RW90 IN EMT TO 15A-1P BREAKER. CONFIRM LOCATIONS WITH CONTRACT ADMINISTRATOR.
  8. REPLACE EXISTING ELECTRIC BASEBOARD HEATER WITH NEW.
  9. PROVIDE CEILING-MOUNTED SMOKE DETECTOR, 120V WITH BATTERY BACK-UP. WIRE TO ADJACENT EXISTING SMOKE ALARM CIRCUIT, M10.
  10. PROVIDE DISCONNECT SWITCH & 208V, 40A CIRCUIT, #8/4 RW90 IN EMT TO 40A-3P CIRCUIT BREAKER IN MDP. USE CURRENT SENSOR ON MAU-1 TO INTERLOCK, MAU-1, WITH RANGE HOOD, RH-1, AS PER MANUFACTURER INSTRUCTIONS.
  11. PROVIDE ELECTRICAL SERVICE FOR FURNACE REPLACEMENTS & REQUIRE WORK FOR NEW FURNACES, FN-1 & FN-2. SEE MECHANICAL DRAWINGS.
  12. PROVIDE ELECTRICAL SERVICE FOR CONDENSING UNIT REPLACEMENT & REQUIRE WORK FOR NEW CONDENSING UNITS, CU-1 & CU-2. SEE MECHANICAL DRAWINGS.

**ELECTRICAL POWER & SYSTEMS**  
**DEMOLITION NOTES: "X"**

- ALSO SEE NOTES & SPECIFICATIONS.
1. REPLACE TYPE "A" LUMINAIRES & LIGHT SWITCHES IN RECKITCHEN, G-03. SEE RENOVATION NOTES.
  2. REMOVE RECEPTACLE & CIRCUIT BACK TO PANEL.
  3. RELOCATE RECEPTACLE & CIRCUIT, SEE RENOVATION NOTES.

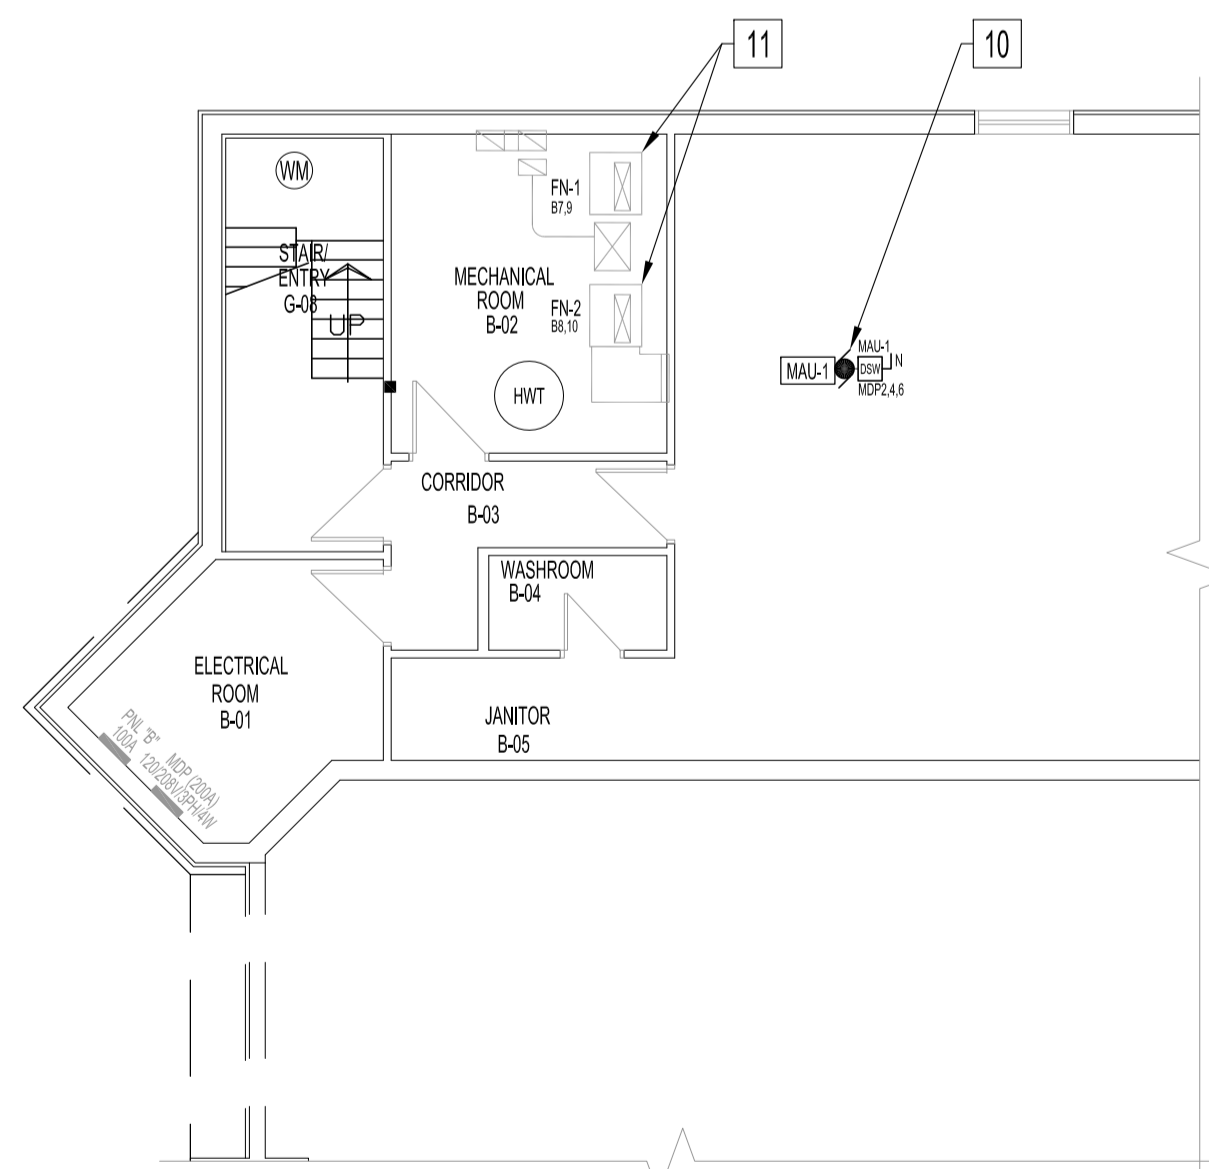

**RENOVATION - PARTIAL BASEMENT FLOOR PLAN**  
SCALE: 1/8"=1'-0"

**NOTES:**  
REFER TO DRAWING E1, NOTES.

No.	REVISION/DESCRIPTION	BY	DATE
0	ISSUE FOR CONSTRUCTION	DTA	2017.11.15



DRAWN	DTA	CHECKED	DESIGNED	DTA	APPROVED
DATE	2017.10.23	USER	APPROVAL		

THE CITY OF WINNIPEG  
PLANNING, PROPERTY AND  
DEVELOPMENT DEPARTMENT  
MUNICIPAL ACCOMMODATIONS DIVISION  
3-65 GARRY STREET, R3C 4K4

PROJECT  
WINNIPEG FIRE PARAMEDIC SERVICES  
STATION No.2  
INTERIOR RENOVATIONS  
55 WATT STREET  
BID OPP: 1013-2017

SHEET TITLE  
PARTIAL BASEMENT AND MAIN FLOOR PLANS  
DEMOLITION AND RENOVATION  
POWER AND SYSTEMS

SCALE	PROJECT No:	SHEET No:
AS SHOWN	2016-007	E2