
	COMMUNICATIONS
SYMBOL	DESCRIPTION
- OTIVIDOL	DATAVOICE OUTLET (X - INDICATES CABLE QTY)
X	ENTRYPHONE INTERCOM OUTLET (1 CABLE)
	CATV OUTLET (1 CABLE)
<u></u>	WALL MOUNTED HORN
COM	SUITE TEL/DATA DEMARCATION
TV	SUITE TV DEMARCATION
	GOITE TY DEMANDATION
	SECURITY AND CONTROL
D	DOOR HELD OPEN BUZZER
ADO	AUTOMATIC DOOR OPERATOR
•	PUSHBUTTON
□ _{RTE}	REQUEST TO EXIT PUSHBUTTON
D	DOOR CONTACT
DS	ELECTRIFIED DOOR STRIKE
DL	ELECTRIFIED DOOR LOCK
DP	ELECTRIFIED DOOR PINS/LATCH
CR	PROXIMITY CARD READER
K	KEYPAD
GB	GLASS BREAK SENSOR
S	SECURITY HORN
S	SECURITY STROBE
\bigotimes_{M}^{r}	PIR MOTION SENSOR
	PHOTOCELL RECEIVER
	PHOTOCELL TRANSMITTER
	CCVE CAMERA - PAN/TILT/ZOOM
	CCVE CAMERA - FIXED VIEW
DVR	CCVE DIGITAL VIDEO RECORDER
NVR	CCVE NETWORK VIDEO RECORDER
□	INFRARED ILLUMINATOR
000	PUSH BUTTON CONTROL STATION
①	LINE VOLTAGE THERMOSTAT
	FIRE ALARM
SYMBOL	DESCRIPTION
	FIRE ALARM PULL STATION
F	FIRE ALARM HORN
F	FIRE ALARM STROBE
QF()	FIRE ALARM HORN/STROBE
FS	SPRINKLER FLOW SWITCH
TS	SPRINKLER TAMPER SWITCH
⊗ _A	SMOKE ALARM
•	SMOKE DETECTOR
•	DUCT SMOKE DETECTOR
•	HEAT DETECTOR
① co	CARBON MONOXIDE DETECTOR
ISO	ISOLATION MODULE
AMM	ADDRESSABLE MONITORING MODULE
RAM	RELAY ADDRESSABLE MODULE
	FIRE ALARM REMOTE ANNUNCIATOR
	FIRE ALARM CONTROL PANEL
EOL [ww-]	END OF LINE RESISTOR
(H)	REMOTE CONTACT

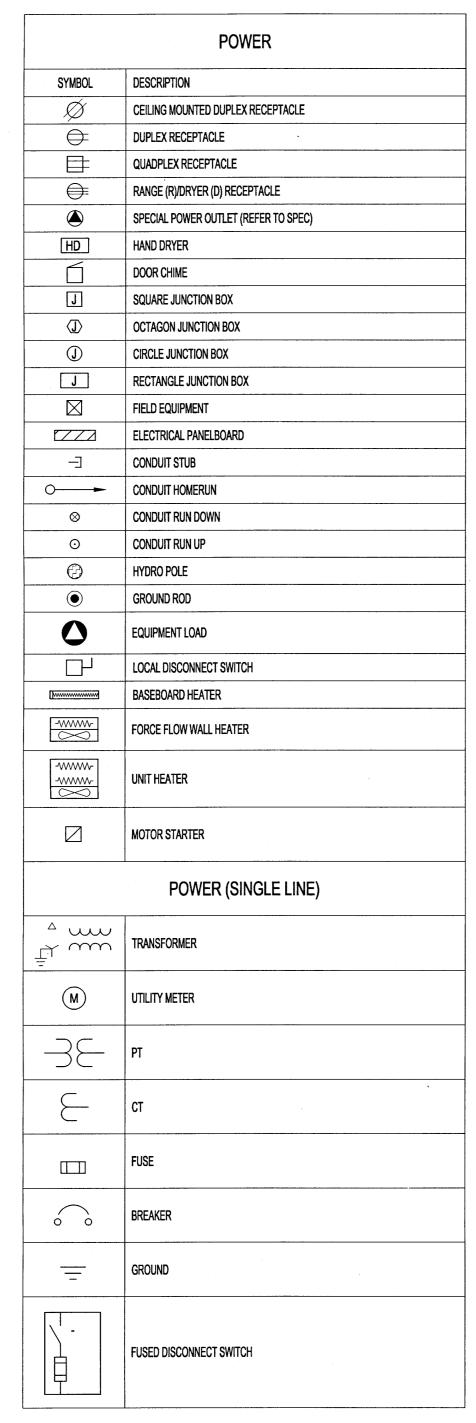

LIGHTING			
DESCRIPTION			
POLE MOUNTED LUMINAIRE			
WALL MOUNTED LUMINAIRE			
CEILING MOUNTED LUMINAIRE			
FLOOD LIGHT TRACK MOUNTED			
FLOOD LIGHT POLE MOUNTED			
FLOOD LIGHT WALL MOUNTED			
PHOTOCELL - POLE MOUNTED			
PHOTOCELL - WALL MOUNTED			
WALL MOUNTED OCCUPANCY SENSOR			
CEILING MOUNTED DAYLIGHT/OCCUPANCY SENSOR			
2'X4' RECESSED LIGHT FIXTURE			
DENOTATION: A1 - PANEL (A) AND CIRCUIT #(1) a - CONTROL SWITCH(ES) A - FIXTURE TYPE			
1'X4' RECESSED OR SURFACE MOUNTED LIGHT FIXTURE			
1'X4' SUSPENDED LIGHT FIXTURE			
WALL MOUNT LIGHT FIXTURE			
SINGLE POLE SWITCH DENOTATION: a - LIGHTS CONTROLLED D - DIMMER CONTROL O - OCCUPANCY MOTION SENSOR LV - LOW VOLTAGE 3 - 3-WAY SWITCH 4 - 4-WAY SWITCH			
TWO SWITCHES IN GANG			
THREE SWITCHES IN GANG			
TIME CLOCK			
HATCHING OF LIGHT FIXTURES INDICATES NIGHT LIGHT FUNCTION.			
EMERGENCY LIGHTING			
EMERGENCY LIGHTING - BATTERY 2 HEADS			
EMERGENCY LIGHTING - REMOTE 2 HEADS			
EXIT LIGHTING			
EXIT SIGN - SINGLE FACED			
EXIT SIGN - SINGLE FACED ARROW INDICATES DIRECTION			
EXIT SIGN - DOUBLE FACED ARROWS INDICATE DIRECTION			

ABBREVIATION	DESCRIPTION
а	MOUNTED ABOVE COUNTER/TABLE
AFF	ABOVE FINISHED FLOOR
BFC	BELOW FINISHED CEILING
СМ	CEILING MOUNTED
FM	FLOOR MOUNTED
WP	WEATHERPROOF
GFI/GFCI	GROUND FAULT CURRENT INTERRUPTER
IG	ISOLATED GROUND
С	COPIER
D	DRYER
R	RANGE
F	FRIDGE/FURN
DW	DISHWASHER
М	MICROWAVE
DF	DRINKING FOUNTAIN
T	TIMER
НС	HANDICAP
AV	AUDIO/VISUAL
CCVE	CLOSED CIRCUIT VIDEO EQUIPMENT
ACS	ACCESS CONTROL SYSTEM
DCS	DOOR CONTROL SYSTEM
WAP	WIRELESS ACCESS POINT
LV	LOW VOLTAGE
PIR	PASSIVE INFRARED
15/20	T-SLOT RECEPTACLE
TV	LCD MONITOR DISPLAY
EC	ELECTRICAL CONTRACTOR
MC	MECHANICAL CONTRACTOR
FT	FIXED TEMPERATURE
RR	RATE OF RISE
IC	ENTRYPHONE INTERCOM
FAJ	FIRE ALARM JUNCTION BOX
EF	EXHAUST FAN
UH	UNIT HEATER
WH	WALL HEATER
IAS	INTRUSION ALARM SYSTEM

GENERAL NOTES

- COORDINATE THE CONNECTIONS OF ALL EQUIPMENT PROVIDED BY OTHERS WITH THE CONTRACTOR PROVIDING THE EQUIPMENT PRIOR TO ROUGH-IN. THIS INCLUDES, BUT IS NOT LIMITED TO MECHANICAL EQUIPMENT, KITCHEN EQUIPMENT, ETC. THE ELECTRICAL SUBCONTRACTOR IS RESPONSIBLE TO PROVIDE THE APPROPRIATE DISCONNECTING MEANS FOR, AND TO MAKE THE FINAL CONNECTION TO, ANY HARDWIRED EQUIPMENT. THE ELECTRICAL SUBCONTRACTOR IS ALSO RESPONSIBLE TO PROVIDE AN APPROPRIATE CORD AND PLUG FOR ANY CORD-AND-PLUG CONNECTED EQUIPMENT THAT IS NOT EQUIPPED WITH AN INTEGRAL CORD AND PLUG.
- 2. ALL EQUIPMENT, DEVICES, AND LUMINAIRES SHALL BE SUITABLE FOR THE ENVIRONMENT IN WHICH THEY ARE INSTALLED. EQUIPMENT MOUNTED OUTDOORS SHALL BE NEMA 3R. DEVICES MOUNTED IN DAMP OR WET LOCATIONS SHALL BE WEATHERPROOF. RECEPTACLES RATED 15- OR 20- AMPS AND 120 VOLTS WHICH ARE LOCATED IN DAMP OR WET LOCATIONS SHALL BE GFCI PROTECTED AND EQUIPPED WITH A SUITABLE WEATHERPROOF COVERPLATE (WHILE-IN-USE IN WET LOCATIONS).
- ELECTRICAL SUBCONTRACTOR TO CONFIRM EXACT SIZE AND LOCATION AND WIRING REQUIREMENTS OF ALL MECHANICAL EQUIPMENT WITH MECHANICAL SUBCONTRACTOR PRIOR TO INSTALLATION OF ANY WIRING. ADJUST WIRING, BREAKERS, ETC. TO SUIT. ALL COSTS TO BE INCLUDED IN BASE TENDER QUOTE.

FIRE STOPPING NOTES

- A. ALL ELECTRICAL WIRES, CABLES, NON-COMBUSTIBLE RACEWAYS, OUTLET BOXES AND OTHER SIMILAR SERVICES THAT PENETRATE FIRE WALLS, FIRE SEPARATIONS OR ASSEMBLIES AND THAT ARE REQUIRED TO HAVE A FIRE RESISTANCE RATING OR FIRE SEPARATION, SHALL BE SEALED BY FIRE STOP SYSTEM WHICH HAS AN "F" AND/OR "FT" RATING NOT LESS THAN THE REQUIRED FIRE PROTECTION RATING OF FIRE SEPARATION.
- B. ELECTRICAL SUBCONTRACTOR SHALL ONLY USE LISTED MATERIALS AND METHODS.
- C. SERVICE PENETRATION AND FIRE STOPPING OF SERVICE PENETRATION IN FIRE SEPARATION AND FIRE RATED ASSEMBLIES SHALL COMPLY WITH THE CURRENT BUILDING CODE.
- D. PROVIDE FOR FIRE STOPS IN CONCEALED SPACES AS REQUIRED BY THE CURRENT BUILDING CODE.
- E. ALL FIRE RESISTANCE RATED ASSEMBLIES (I.E. WALLS CEILINGS, ETC.) WHICH CONTAIN PANEL BOARDS, BACK BOXES, RECESSED LIGHTING FIXTURES, ETC. SHALL BE C/W FIRE RATED BACKING TO MAINTAIN THE INTEGRITY OF THE FIRE RESISTANCE.

	DRAWING LIST
SHEET No:	SHEET TITLE
E01	SYMBOL LEGEND AND DRAWING LIST
E02	ELECTRICAL SITE PLAN
E03	SINGLE LINE DIAGRAM AND PANEL SCHEDULES
E04	HHW BUILDING POWER PLAN
E05	HHW BUILDING LIGHTING PLAN
E06	HHW BUILDING SYSTEM PLAN
E07	KIOSK BUILDING PLAN
E08	MECHANICAL EQUIPMENT SCHEDULE
E09	LUMINAIRE SCHEDULE
E10	ELECTRICAL DETAILS
E11	ELECTRICAL DETAILS
E12	SYSTEMS DETAILS
E13	SECURITY CAMERA SYSTEM
E14	SECURITY CAMERA SYSTEM DETAILS
E15	FIRE ALARM MOUNTING STANDARD

Certificate of Authorization

KGS Group

No. 245

LOCATION APPROVED B.M. ELEV. UNDERGROUND STRUCTURES SUPV. U/G STRUCTURES DATE COMMITTEE LOCATION OF UNDERGROUND STRUCTURES AS SHOWN ARE BASED ON THE BEST INFORMATION AVAILABLE BUT NO GUARANTEE IS GIVEN THAT ALL EXISTING UTILITIES ARE SHOWN OR THAT THE GIVEN LOCATIONS ARE EXACT. CONFIRMATION OF EXISTENCE AND EXACT LOCATION OF ALL SERVICES MUST BE OBTAINED FROM THE INDIVIDUAL UTILITIES BEFORE PROCEEDING WITH CONSTRUCTION.

KGS GROUP CONSULTING ENGINEERS DESIGNED CHECKED CLS DRAWN APPROVED CLS RELEASED FOR HOR. SCALE: AS NOTED CONSTRUCTION: AS NOTED VERTICAL: 17/03/14 CLS ISSUED FOR TENDER 16/08/17 DATE DATE NO. REVISIONS DATE

ENGINEER'S SEAL SARARAS Months Member 32618

CONSULTANT PROJECT NO.

16-0107-010

Winnipeg PROJECT TITLE

THE CITY OF WINNIPEG WATER AND WASTE DEPARTMENT

4R WINNIPEG DEPOT EAST WINNIPEG COMMUNITY RESOURCE RECOVERY CENTRE

SYMBOL LEGEND AND DRAWING LIST

SHEET OF 26 COMPUTER FILE NAME 16-0107-010

CONSULTANT DRAWING NUMBER