KEY NOTES 1 REROUTE E ACCOMMOD 2 NEW 4-POS' PAGING CAI 3 NEW INTRU

- 1 REROUTE EXISTING CONDUITS FEEDING PANELS AS REQUIRED TO ACCOMMODATE NEW SLOPED FLOOR INFILL.
 2 NEW 4-POST FULLY ENCLOSED VOICE/DATA, CCTV, AND OVERHEAD
- PAGING CABINET.

 NEW INTRUSION CONTROL PANEL.
 EXISTING PLYWOOD BACKBOARD.
- EXISTING PLYWOOD BACKBOARD.

 NEW PLYWOOD BACKBOARD.

 1.5-20R RECEPTACTES TO BE-MOUNT!
- L5-20R RECEPTACLES TO BE MOUNTED ABOVE THE NEW VOICE/DATA CABINET.

 POWER AND DATA RECEPTACLE TO BE MOUNTED INSIDE PANEL.

 LOCATION OF ACCESS CONTROL DOOR CONTROLLERS.


GENERAL NOTES

- A. COORDINATE LOCATION AND MOUNTING HEIGHT OF ELECTRICAL DEVICES IN CRAWLSPACE WITH ALL DISCIPLINES AND TRADES PRIOR TO INSTALLATION.
- B. WIRING BELOW 2" (50mm) / 50mm (2") ABOVE FLOOR LEVEL INCLUDING BELOW FLOOR LEVEL (SUMP PITS) SHALL BE EXPLOSION PROOF, UNLESS PROTECTED BY 2" (50mm) / 50mm (2") CONCRETE CURB OR PAD.
- C. FINAL CONNECTION TO ALL MECHANICAL EQUIPMENT SHALL BE FLEXIBLE. CONFIRM FINAL CIRCUIT BREAKER AND WIRE SIZE WITH MECHANICAL EQUIPMENT SHOP DRAWINGS. ADJUST CIRCUIT BREAKER AND WIRE SIZE AS REQUIRED WITHOUT ADDITIONAL COST TO OWNER.
- BASEMENT SYSTEMS CABINET, PROVIDE CONDUITS IN WALLS AND EXPOSED CEILING AREAS, AND J-HOOKS ABOVE T-BAR CEILING AREAS. ALL CATEGORY 6 CABLING SHALL BE FT-6 RATED.

HOMERUN ALL NEW VOICE/DATA CATEGORY 6 CABLING BACK TO

- E. WIRE ACCESS POINTS (WAP) SHALL BE OWNER FURNISHED AND CONTRACTOR INSTALLED. CONTRACTOR TO PROVIDE 15' FOOT SLACK LOOP ON WAP CABLING AND PROVIDE FEMALE JACKS ON CABLE ENDS.
- HOMERUN ALL PA SPEAKER CABLING TO 4-POST SYSTEMS CABINET IN BASEMENT ELECTRICAL ROOM.

3/32" = 1'-0" EP2.0-R1

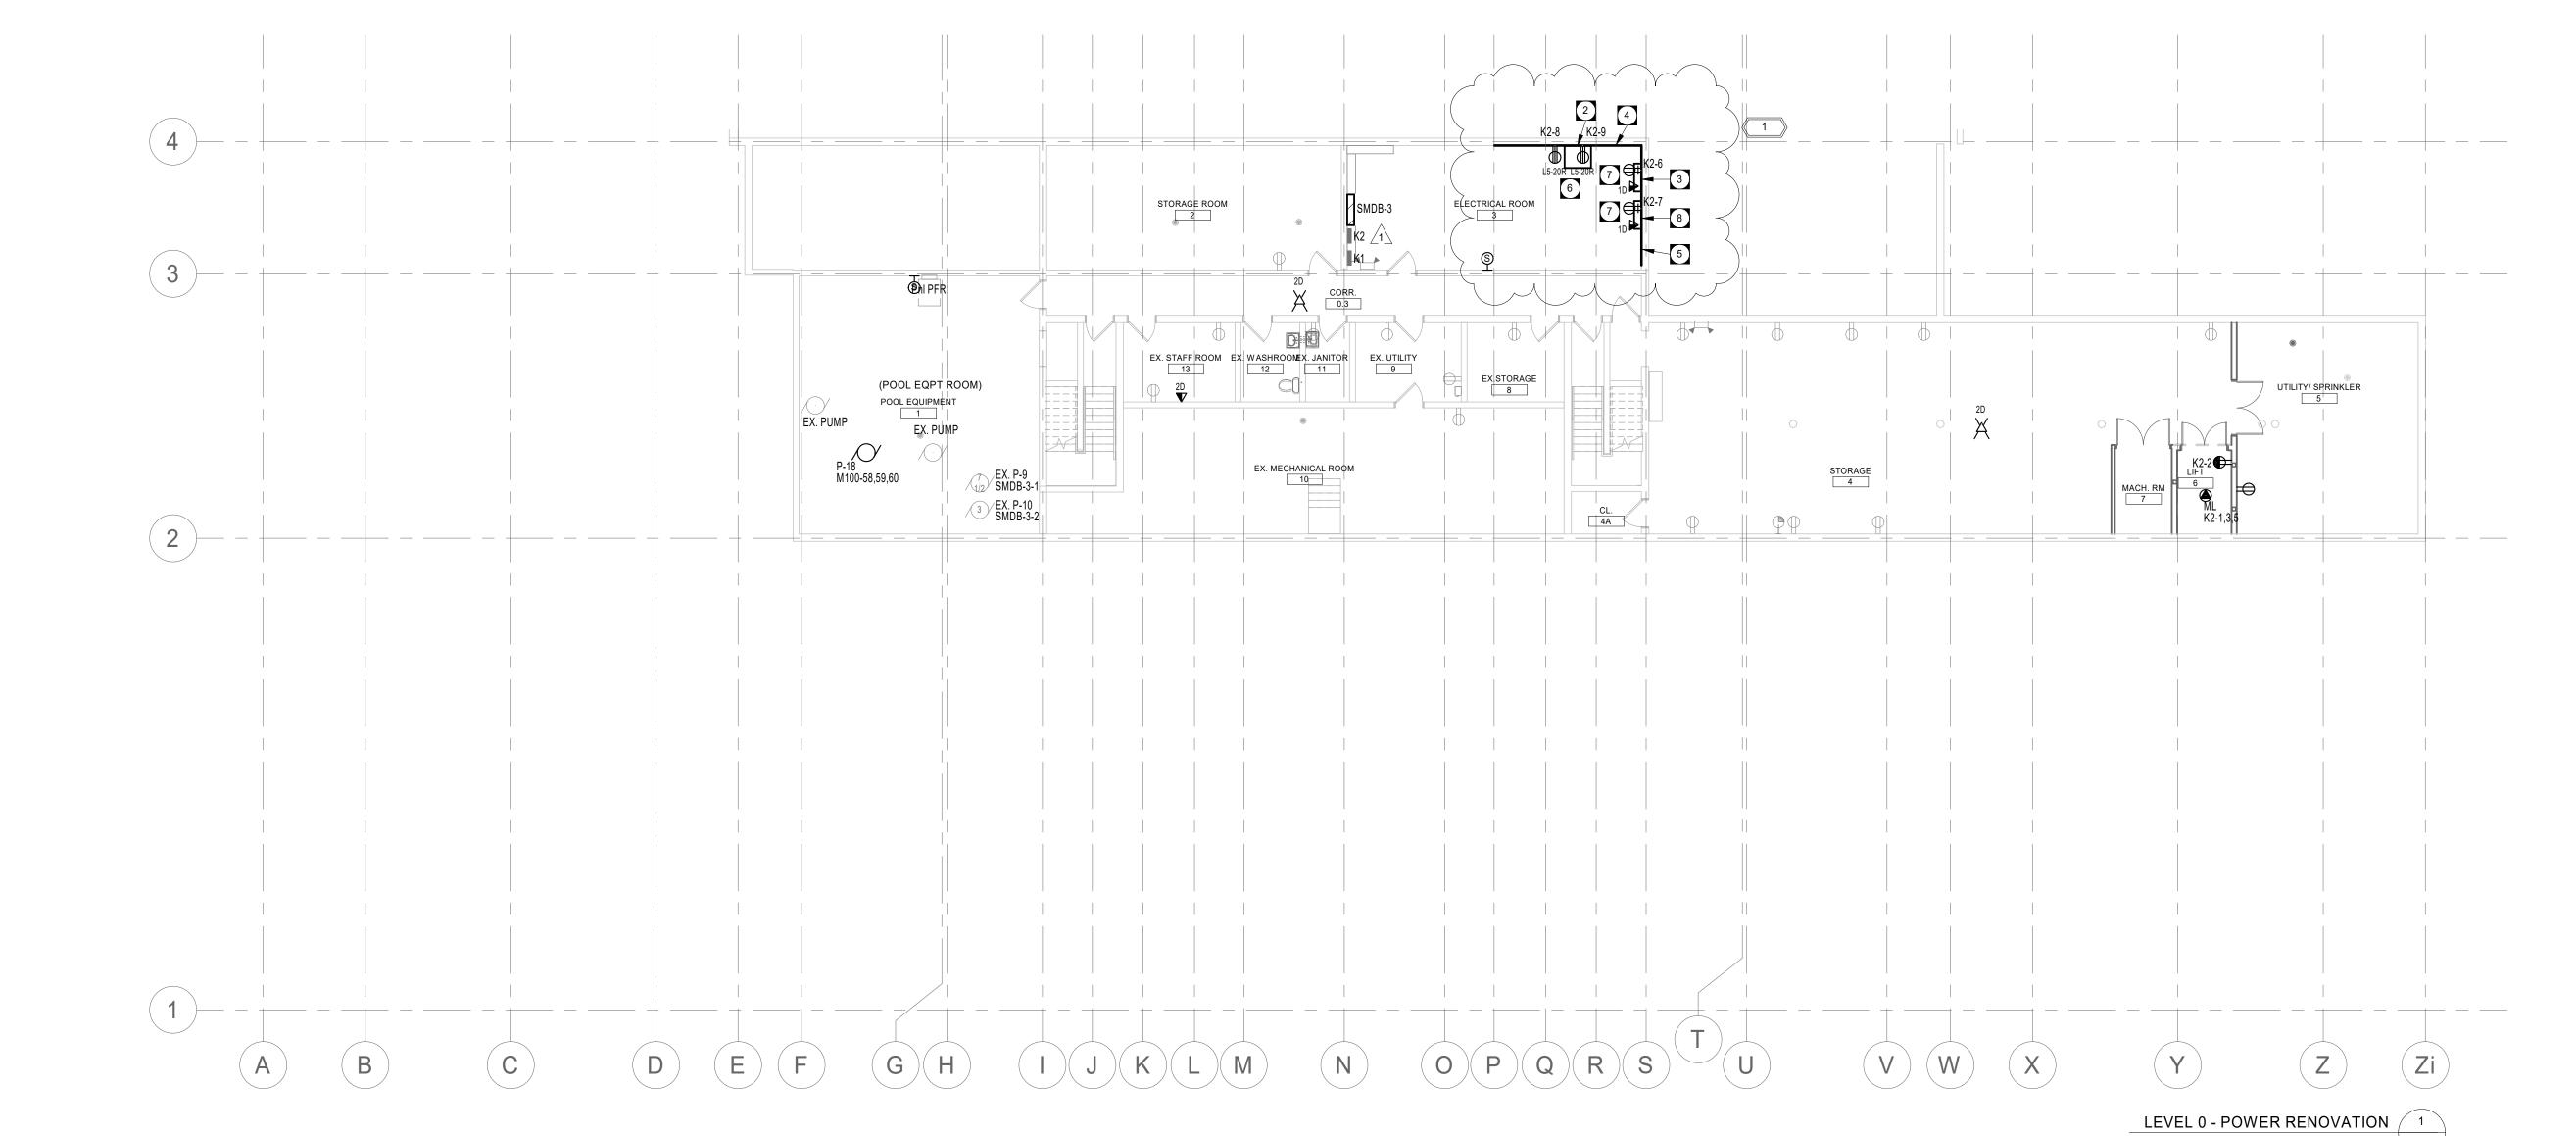

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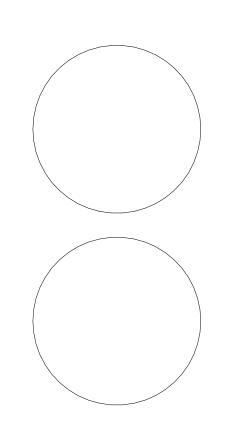
0 19-11-06 Issued for Construction1 19-12-09 Issued with ADD1ME



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Project

ST. JAMES CIVIC CENTRE

Drawing

Sheet:

BASEMENT RENOVATION POWER PLAN

Drawn By: Review By:

JA MP

Scale: Tender No:
As indicated 1176-2019

Date: 11/06/19

EP2.0-R1