

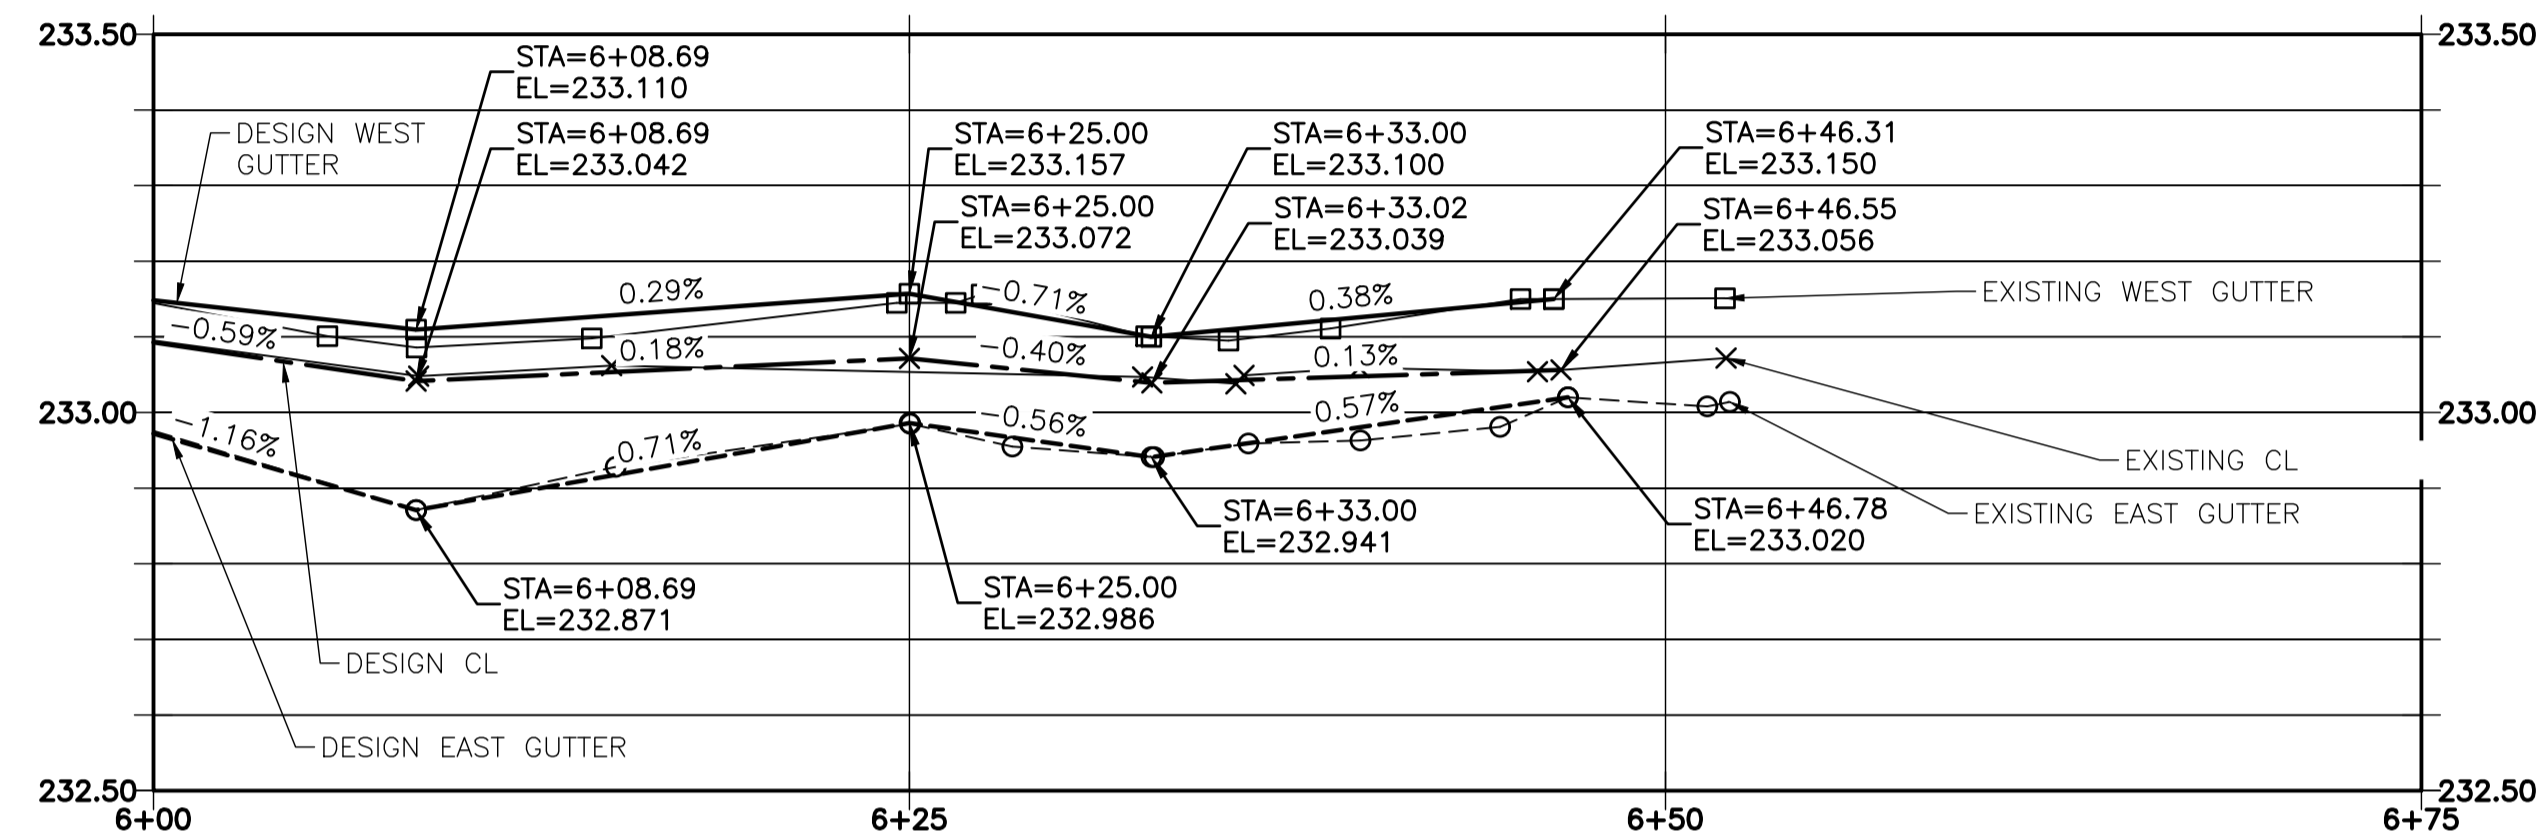
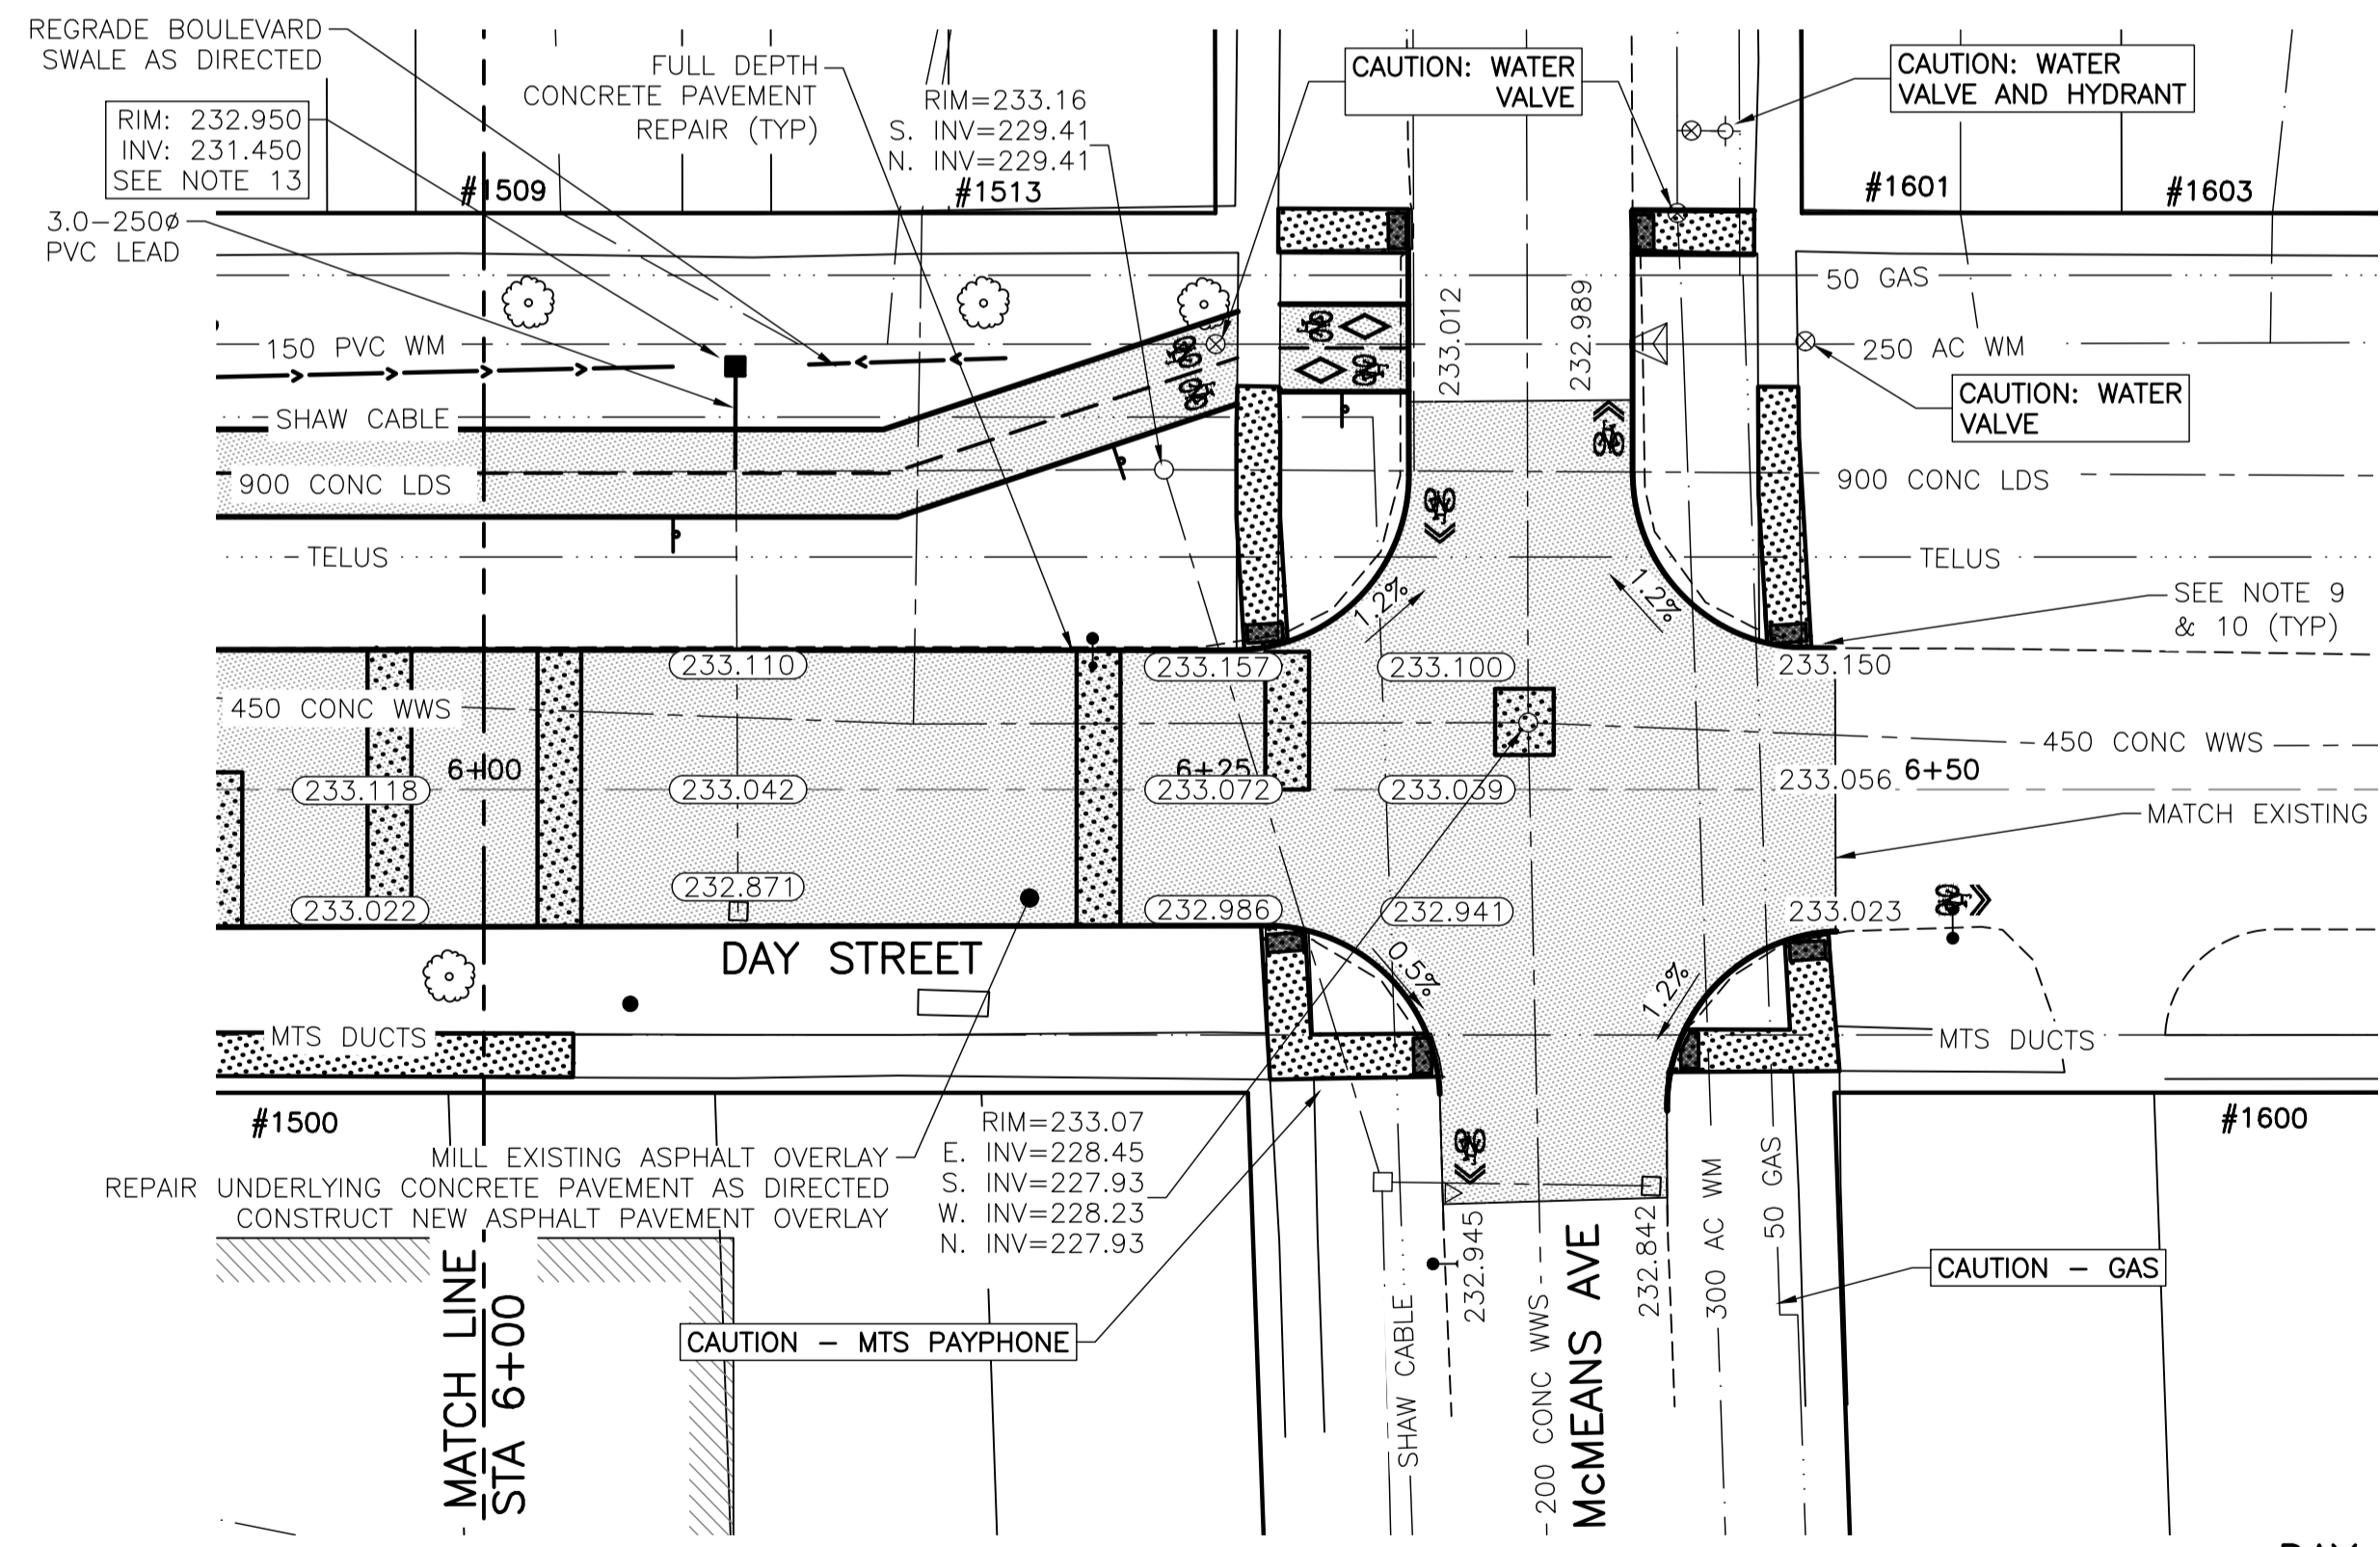


ACTIVE TRANSPORTATION PATH - PROFILE

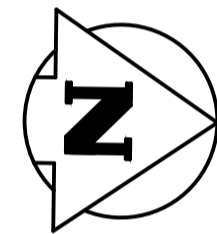

DAY STREET - PROFILE

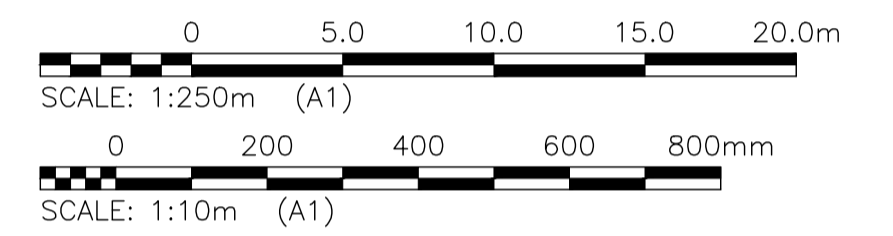

DAY STREET - PLAN

NOTES:

1. STATION IN CENTRE OF RIGHT-OF-WAY UNLESS OTHERWISE NOTED.
2. SOUTH PROPERTY LINE OF KILDARE AVENUE IS STA 1+00
3. ALL MEASUREMENTS TO BACK OF CURB.
4. ALL EXISTING TREES TO BE PROTECTED AND MAINTAINED THROUGHOUT CONSTRUCTION UNLESS NOTED OTHERWISE.
5. HAND OR SOFT DIG METHODS REQUIRED OVER GAS UTILITIES AT INTERVALS DETERMINED BY THE ENGINEER TO DETERMINE DEPTH OF COVER.
6. NO WORKS, INCLUDING CONCRETE CUTTING OR BREAKING, TO BE UNDERTAKEN NEAR GAS LINES UNTIL DEPTH OF COVER IS DETERMINED AND A MANITOBA HYDRO SAFETY WATCH REPRESENTATIVE IS ON SITE.
7. NO VIBRATORY COMPACTION PERMITTED WITHIN 1.0M OF GAS MAINS.
8. INSTALL MODIFIED BARRIER CURB AT ALL INTERSECTION RADII, ALLEY RADII, AND BULLNOSES.
9. CONSTRUCT NEW MONOLITHIC CURB RAMP (10mm HEIGHT INTEGRAL)
10. INSTALL DETECTABLE WARNING SURFACE TILE AT STREET INTERSECTIONS.
11. REMOVE EXISTING CURB AND CONSTRUCT NEW BARRIER CURB 150mm REVEAL, DOWELED.
12. INSTALL CATCH PIT AND BARRIER CURB AND GUTTER INLET FRAME (SD-023). INSTALL NEW 250 LEAD @ 2% MINIMUM GRADE
13. INSTALL NEW CATCH BASIN AND STANDARD FRAME (SD-024). INSTALL NEW 250 LEAD @ 2% MINIMUM GRADE
14. CONCRETE REPAIRS SHOWN BASED ON VISUAL INSPECTION PRIOR TO REMOVAL OF ASPHALT OVERLAY. FINAL REPAIR LIMITS AND DIMENSIONS MAY VARY FROM THOSE SHOWN.
15. ADJUST ALL WATER VALVES, WATER SERVICE VALVES, MANHOLES AND CATCH BASINS TO GRADE.

LOCATIONS OF UNDERGROUND STRUCTURES AS SHOWN ARE BASED ON THE BEST INFORMATION AVAILABLE. BUT NO GUARANTEE IS GIVEN THAT ALL EXISTING UTILITIES ARE SHOWN OR THAT THE GIVEN LOCATIONS ARE EXACT. CONFIRMATION OF THE EXISTENCE AND EXACT LOCATION OF ALL SERVICES MUST BE OBTAINED FROM INDIVIDUAL UTILITIES BEFORE PROCEEDING WITH CONSTRUCTION.

PROPERTY LIMITS DELINEATION
 DELINEATION OF PROPERTY LIMITS AS SHOWN ON THIS DWG DOES NOT REPRESENT A "LEGAL SURVEY". KGS GROUP MAKES NO REPRESENTATION OR WARRANTY AS TO THE ACCURACY OF PROPERTY LIMITS DELINEATED ON THIS DWG, NOR ON THE DIMENSIONAL ACCURACY OF DWG FEATURES RELATIVE TO THOSE PROPERTY LIMITS.

WARNING
 NOTIFY THE GAS COMPANY OF THE PROPOSED LOCATION OF EXCAVATION. TAKE PRECAUTION TO AVOID DAMAGE TO GAS COMPANY INSTALLATIONS. SEE PROVINCIAL REGULATION 210/72 FOR DETAILS.

METRIC
 WHOLE NUMBERS INDICATE MILLIMETRES
 DECIMALIZED NUMBERS INDICATE METRES

PRELIMINARY
 NOT TO BE USED FOR CONSTRUCTION

2019-05-01

U:\FMS\18-0107-016\18-0107-016_35 DAY.DWG
 PLOT: 1:1 (A-1)

300 LBS LAND DRAINAGE SEWER	300 LBS TEST HOLE	•	•
250 WWS WASTE WATER SEWER	GUY WIRE	—	—
150 WWS WATERMAIN	LIGHT STANDARD	••	••
HYDRANT	BACK OF CURB	---	---
VALVE	PARTIAL DEPTH REPAIR	XXXX	XXXX
MANHOLE	CONCRETE	XXXX	XXXX
CATCH BASIN	ASPHALT	XXXX	XXXX
CURB INLET	SIDEWALK	XXXX	XXXX
POLES	PROPERTY LINE	----	----
EXISTING	SURVEY BAR	----	----
LEGEND-PLAN	GEODETIC BENCHMARK	+	+
PROPOSED	ELEVATION	231.334	231.334
EXISTING	LEGEND-PROFILE	TTTT	TTTT
PROPOSED	PROPOSED	XXXX	XXXX

LOCATION APPROVED UNDERGROUND STRUCTURES
 SUPV. U/G STRUCTURES COMMITTEE DATE
 NOTE: LOCATION OF UNDERGROUND STRUCTURES AS SHOWN ARE BASED ON THE BEST INFORMATION AVAILABLE BUT NO GUARANTEE IS GIVEN THAT ALL EXISTING UTILITIES ARE SHOWN OR THAT THE GIVEN LOCATIONS ARE EXACT. CONFIRMATION OF EXISTENCE AND EXACT LOCATION OF ALL SERVICES MUST BE OBTAINED FROM THE INDIVIDUAL UTILITIES BEFORE PROCEEDING WITH CONSTRUCTION.

B	ISSUED FOR TENDER	19/05/02		
A	ISSUED FOR REVIEW	19/03/05	JB	
NO.	REVISIONS	DATE	BY	DATE

KGS GROUP CONSULTING ENGINEERS

DESIGNED BY: MH
 CHECKED BY:
 DRAWN BY: MH
 APPROVED BY:
 HOR. SCALE: 1:250
 VERTICAL: 1:10
 2019/01/24

ENGINEER'S SEAL
 CONSULTANT DRAWING NO. C120

THE CITY OF WINNIPEG PUBLIC WORKS DEPARTMENT ENGINEERING DIVISION

2019 LOCAL STREET PACKAGE
 DAY STREET
 PLAN AND PROFILE 6+00 TO 6+75

SHEET 20 OF 21
 COMPUTER FILE NAME: 18-0107-016_35 DAY.DWG
 CITY DRAWING NUMBER: -