


- NOTES:**
1. ALL WORK AND MATERIALS TO BE IN ACCORDANCE WITH THE LATEST REVISION OF THE CITY OF WINNIPEG STANDARD CONSTRUCTION SPECIFICATIONS.
 2. CONTRACTOR TO CONFIRM THE LOCATION OF ALL UTILITIES/SERVICES IN THE FIELD PRIOR TO CONSTRUCTION.
 3. ALL ROADWAY DIMENSIONS SHOWN ARE TO BACK OF CURB.
 4. RENEW CURB AND SIDEWALK AS IDENTIFIED BY CONTRACT ADMINISTRATOR.
 5. CONSTRUCT 200mm REINFORCED CONCRETE ALLEY APPROACHES AND 200mm REINFORCED CONCRETE COMMERCIAL APPROACHES WITH 75mm OF GRANULAR A BASE, 300mm-50mm GRANULAR A SUB-BASE, AND SEPARATION/FILTRATION GEOTEXTILE FABRIC AS DIRECTED BY CONTRACT ADMINISTRATOR.
 6. ALL PRIVATE WALKWAYS TO BE ADJUSTED/RENEWED TO NEW SIDEWALK OR TOP OF CURB ELEVATION, AS REQUIRED.
 7. ADJUST MH FRAMES, CB RIMS, VALVES, CURB STOPS AND HYDRANTS TO NEW GRADES, AS REQUIRED.
 8. MODIFIED BARRIER CURB TO BE CONSTRUCTED AT ALL INTERSECTION RADII AND BACK LANE RADII.
 9. ALL EXISTING LONG WATER SERVICES TO BE INSULATED AS PER SD-018 AND E14, AS REQUIRED.
 10. CONTRACTORS TO TAKE PRECAUTIONARY STEPS TO PROTECT EXISTING TREES WITHIN THE LIMITS OF CONSTRUCTION FROM DAMAGE FROM CONSTRUCTION ACTIVITIES AS OUTLINED IN THE SPECIFICATIONS.
 11. ALL BOULEVARDS TO BE SODDED UNLESS OTHERWISE NOTED.
 12. UTILITY MANHOLE ISOLATION DIMENSIONS TO BE ADJUSTED BY CONTRACT ADMINISTRATOR AFTER VAULTS HAVE BEEN EXPOSED DURING EXCAVATION.

EXISTING	LEGEND-PLAN	PROPOSED	EXISTING	LEGEND-PLAN	PROPOSED	EXISTING	LEGEND-PROFILE	PROPOSED
---	WATER MAIN	---	---	IRON BAR	---	---	---	---
---	LAND DRAINAGE SEWER	---	---	HYDRO POLE & LIGHT STANDARD	---	---	---	---
---	WASTE WATER SEWER	---	---	LIGHT STANDARD OR TRAFFIC SIGNAL	---	---	---	---
---	HYDRO	---	---	HYDRO POLE	---	---	---	---
---	BELL/MTS	---	---	CURB RAMP	---	---	---	---
---	GAS	---	---	DETECTABLE WARNING SURFACE TILE	---	---	---	---
---	SIGNALS	---	---	EDGE OF SIDEWALK	---	---	---	---
---	MANHOLE	---	---	FENCE	---	---	---	---
---	CATCH BASIN	---	---	PROPERTY LINE	---	---	---	---
---	CURB INLET	---	---	EDGE OF ASPHALT	---	---	---	---
---	UTILITIES ADJUSTED	---	---	EDGE OF CONCRETE	---	---	---	---
---	PLUG	---	---	MODIFIED BARRIER CURB	---	---	---	---
---	HYDRANT	---	---	BARRIER CURB	---	---	---	---
---	VALVE	---	---	BARRIER CURB AND GUTTER	---	---	---	---
---	CURB STOP	---	---	CONC SIDEWALK	---	---	---	---
---	GROUND GRADE	---	---	CONCRETE SLAB	---	---	---	---
---	PAVEMENT GRADE	---	---	ASPHALT	---	---	---	---
---	ANCHOR	---	---	MILLED SURFACE	---	---	---	---
---	#11 CIVIC ADDRESS	---	---	PAVEMENT REPAIR FABRIC	---	---	---	---
---	EXISTING	---	---	EXISTING	---	---	---	---

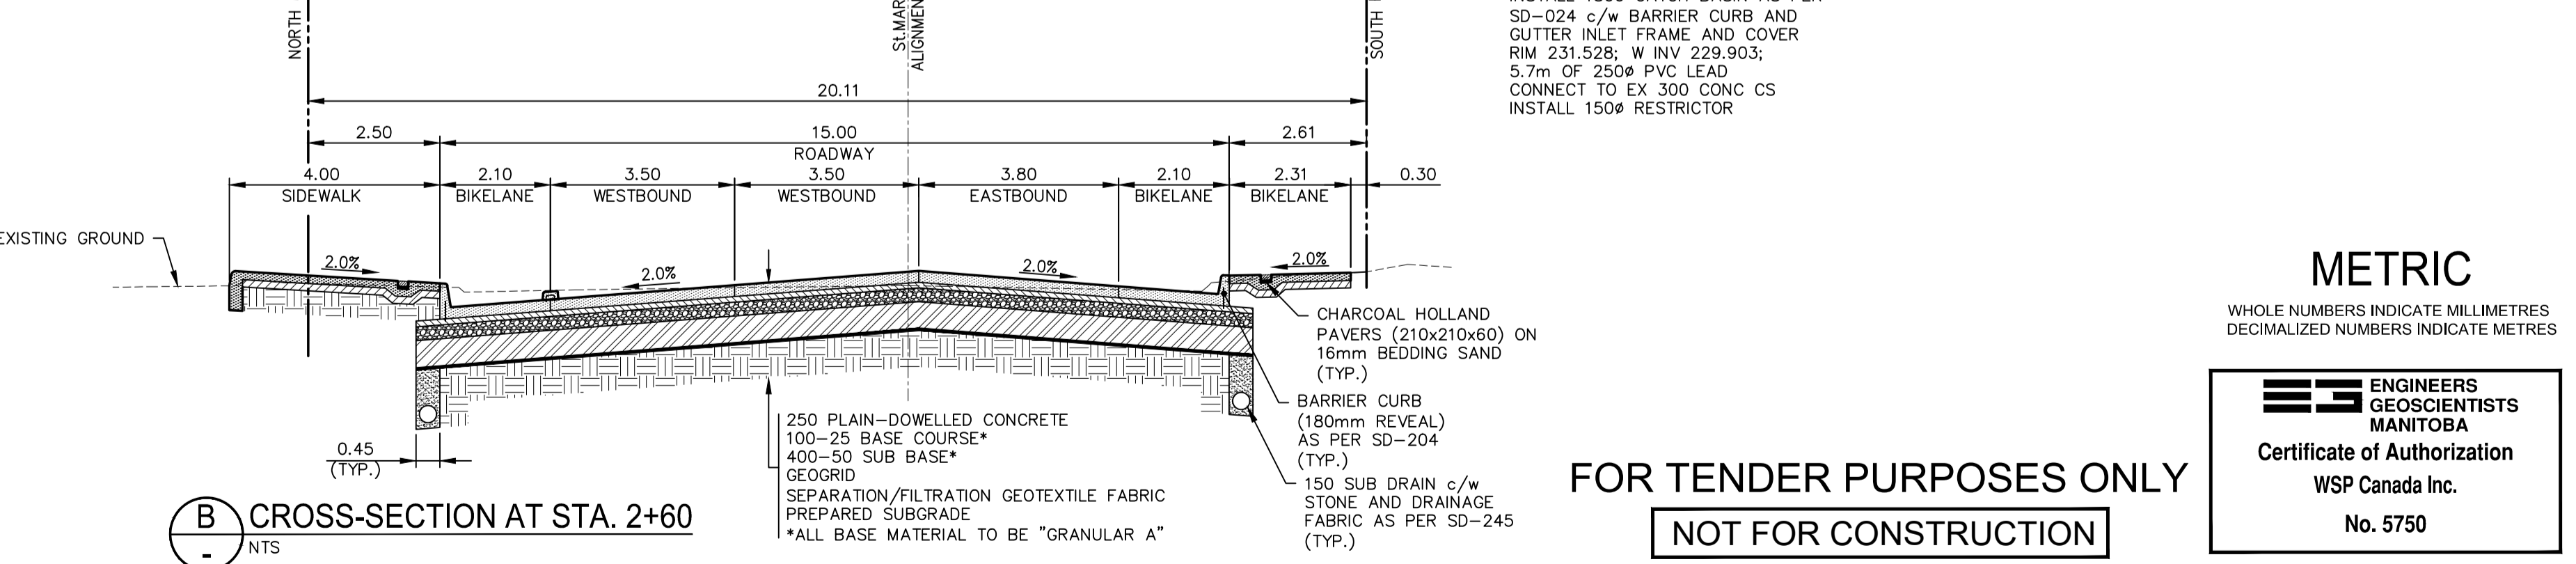

LOCATIONS APPROVED UNDERGROUND STRUCTURES

NO.	REVISIONS	DATE	BY

WSP
 DESIGNED BY: MV/SS
 CHECKED BY: SS
 DRAWN BY: SB
 APPROVED BY: SM

HOR. SCALE: 1:250
 VERTICAL SCALE: 1:10

ISSUED FOR TENDER: 25-02-2022
 ISSUED FOR PRELIMINARY DESIGN REVIEW: 09-02-2022

DATE: AUGUST 2021

**FOR TENDER PURPOSES ONLY
NOT FOR CONSTRUCTION**

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THE CITY OF WINNIPEG
 PUBLIC WORKS DEPARTMENT
 ENGINEERING SERVICES DIVISION

2021-2022 PIONEER, WILLIAM STEPHENSON, COLONY & ST. MARY RENEWALS PROJECT
 ST. MARY AVENUE - PLAN AND PROFILE
 CONCRETE RECONSTRUCTION
 STA. 1+85 TO STA. 3+15

CITY DRAWING NUMBER: P-3546-11
 SHEET 11 OF 19
 TENDER NO. 807-2021

CONSULTANT ACAD DWG. NO. 211-03198-00-11

Feb 24, 2022 - 3:41pm
 P:\2021\211-03198-00 - Pioneer_William Renewal Project\4.0 Tech & Professional Services\Drawings\04 Working Drawings\StMary_Plan&Profile.dwg - tab:807-2021_Drawing_211-03198-00-11-11-11