

- 2. PAINTED STEEL FABRICATIONS FOR HANDRAILS, PLATFORMS, PIPE SUPPORT FRAMES
- AND MONORAIL BEAMS.
- 3. PIPE SUPPORTS:

  TYPE 1: 30; TYPE 2: 7; TYPE 3: 12; TYPE 5: 8; TYPE 6: 5: TYPE 7: 2.

  SEE DRAWING D-8389 FOR DETAILS
- 4. L.L. FOR PLATFORM AND WALKWAY: L.L. FOR WALKWAY 2.5kN/m², L.L. FOR PLATFORM 13.5 kN/m².

## RECORD DRAWING


Certificate of Authorization Earth Tech Canada Inc. No. 730 Expiry: April 30, 2004

	B.M								ENGINEER'S SEAL	
ч	ELE	ELEV.			E A R T H 🕋 T E O H					
					_	,	CH CH	<b>12MHILL</b>		
					A SQUARE INTERNATIONAL LTD. COMPANY Sorth Sook (Cheeda) Inc. Storipeg, Medicola 504,477,6681				ORIGINAL SIGNED BY	
7									·	
					DESIGNED BY	ww	CHECKED	DK	D. KRUGER	
	3	RECORD DRAWING	07/01/30	SRP		ww	APPROVED BY	DT	03/12/13	
	2	AS BUILT	05/01/19	ŊΗ	DRAWN BY					
	2	SUPPORTS REVISED	04/03/18	TAR	HOD COALE	1: 75	RELEASED FOR			
	1	ISSUED FOR CONSTRUCTION	04/02/27	TAR	HOR. SCALE: VERTICAL SCAL		CONSTRUCTION		COLOUR TALLE BELLING IN	
╛	0	ISSUED FOR TENDER	03/12/12	WW					CONSULTANT DRAWING NO.	
	NO.	REVISIONS	DATE	BY	DATE 200	3/11/12	DATE		63672-C5-S01	

Winnipeg		CITY				E G
	WATER AND WASTE DEPARTMENT					

DEACON ULTRAVIOLET (UV) LIGHT SHEET OF 10 DISINFECTION PROJECT CITY DRAWING NUMBER STRUCTURAL — UV INSTALLATION OVERALL PLAN D-8388

Jan 21, 2008 - 3:12pm PLOTIED Bit: lee,edge: LAYOUT.Leyout! FELT.L:\\doo\63000\6302\CDa-CAD\Submission\AS-BULLIS\CS\Dijk-RECORD\CSOLejg

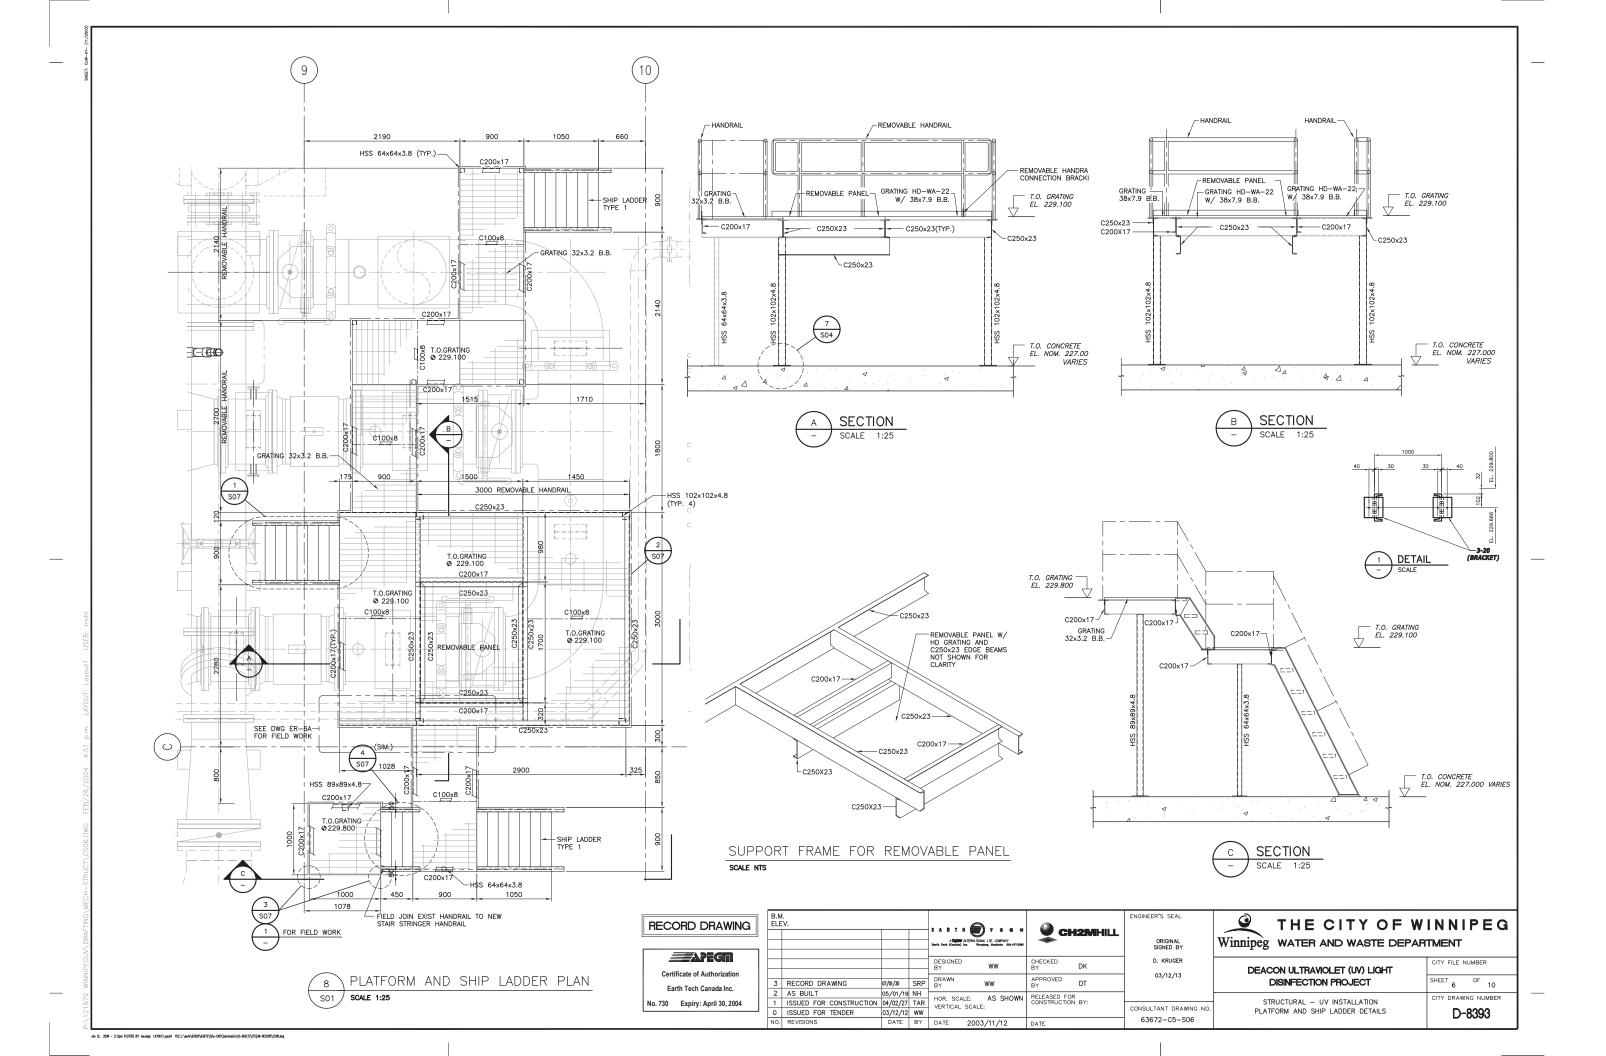

March. (5) (9) ( 8 EQUAL SPACES @ 4800 = 38 400 RIP-RAP RETAINING WALL CHLORINE TRENCH SEE DWG. 53 OF 13 -Nº 2 (C) 9 2100 1200 200 PART PLAN AT LOBBY 2 8.8 (H) (9) 3665 26 755 PLAN ABOVE FLOOR ELEV 236 500 m Allogren 13/04/31 **AS BUILT** G. REMPEL May 178 ENERED ENERED DIMENSIONS IN MILLIMETRES EXCEPT AS NOTED THE CITY OF WINNIPEG WATERWORKS, WASTE AND DISPOSAL DIVISION SCALE: AS SHOWN JAMES F. MACLAREN LIMITED
CONSULTING ENGINEERS, PLANNERS AND SCIENTISTS
WINNIPEG - LONDON - WINDSOR - WATERLOO - TORONTO DATE: MAY 30, 1978 DEACON BOOSTER PUMPING STATION CONSULTANT DRAWING N CENTRAL FILE ENGINEERING OFFICE A 3 of 12 ARCHITECTURAL DRAWING FILE NUMBER DRAWN BY: T.F CITY DRAWING No. I REVISED TO AS BUILT APPROVED BY LAPRICE PART PLAN ABOVE ELEV. 236.500 m GRID CO-ORDINATES BY DATE CHECKED BY: CV. W DBP-5 DESCRIPTION WORKS & OPERATIONS DEPARTMENT


MICROFILMED NOV -- 1981

FILE 10819 -A1-10348

VENS

REF. or DRAWING NO.-

DETAILS

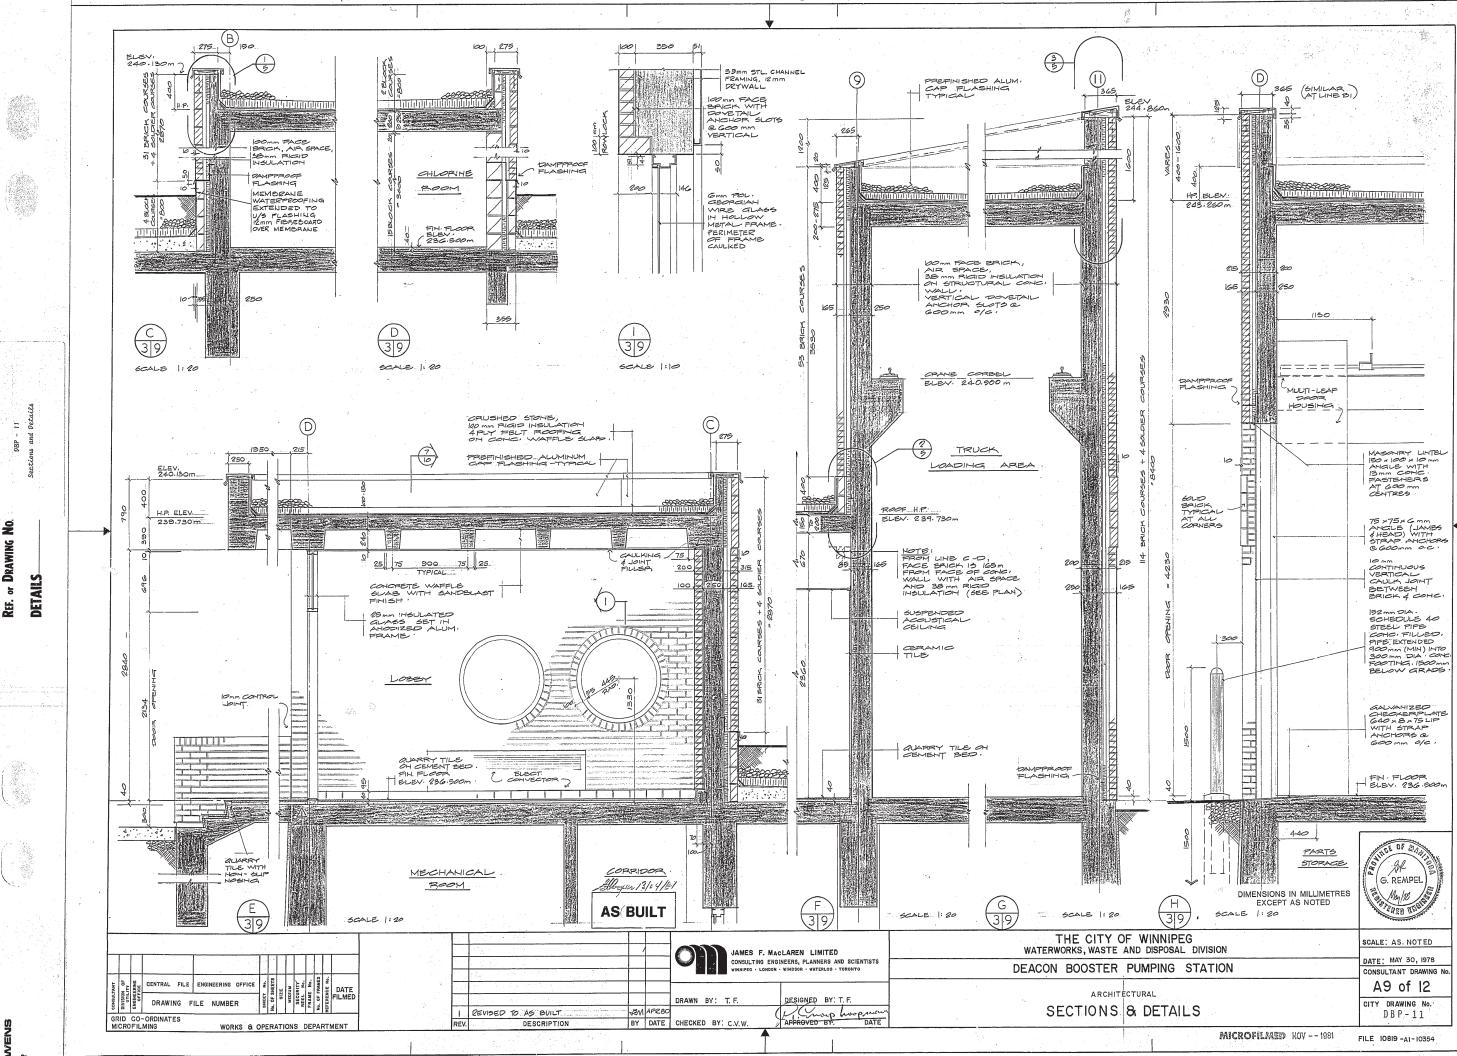

2

- DRAWING

2 (3) (4) (7)6 8 (9) (D) (2) 43200 200 2400 4800 4800 4800 2400 40 2400 CHLORINE TRENCH, FOR CONT'S DETAILS SEE DWG. SII OF 13. 40, 200 210 (.1025 ×2830 (B) 8 1025 × 2830 <del>(</del> L.P. EL. 236.460m CH.P.EL. 239.730m H IO K CHLORINE RM. BM. B-5  $\bigcirc$ (A) 1235 | 250 CONC. SLAB | | - LIGHT WEIGHT | | | CONC. FILL (175 MAX. - 0 MIN) | HIGH POINT EL 236.635m. 2440 CLEAR 375 1405 ROOF PLAN Bi)-OPNGS IN WALLS NOTE:
BEAMS B-2 AND B-3 ON GRID LINES
B, 9 AND 10 REMAINED SHORED
UNTIL 7 DAYS AFTER THE WALLS ABOVE
ELEV. 236,500m WERE POWRED, A P DBP - 18 Above Elev. 236.! and Roof Plans F 9 BM.B-4 BM . B - 5 BM, BS BM . B-5 (C) BILCO TYPE JD-ZAL UPPER CONTROL RM 25. 27. 27. 1200 1000 H TRUCK LOADING or DRAWING NO. (D)-1000 4 TEN 1000 2250 C A5 300 10 LEDGE O B LED -2-15 M E.F. -2-15 M E.F. 2-30M 1-30 M TOP 1-30 M TOP (3000 LG.) (E) LEDGE **DETAILS** ¢ PILES~ ( 190 185 250 125 3665 ; 4230 2-25 M (2500 LG.) PLAN ABOVE FLOOR ELEV. 236,500 m. #15@300 STI SCALE 1:100 200 PARAPE ON PARAPET BEAM B-5 ROOF HATCH -SCALE 1:50 (B) OF BEAMS PARAPET WALL (G) B 9 2-20 M E.F. (12 000 LONG) 2-30 M TOP -L.P. /EL. 229. 680m. R.D. H.P. EL. 239.730 3 BARS TYPE 'A' 3 BARS TYPE B BARS TYPE C .300 STIRRUPS SYMMETRICAL ABOUT & OF BEAMS. ٩ BEAMS B-1, B-2, B-3 2-30M SCALE 1:50 TYPE 'C' BARS.
TYPE 'B' BARS
TYPE 'A' BARS GR G. REMPEL 1100 PARAPET WALL PARAPET WALL BEAM Nº BAR A' BAR B' BAR C' Noy 178 (A) 450 SECTION B B1 B2 35M 35M 35M STERED ENG AS BUILT 45 M 45M 35M ROOF PLAN THE CITY OF WINNIPEG WATERWORKS, WASTE AND DISPOSAL DIVISION JAMES F. MACLAREN LIMITED CONSULTING ENGINEERS, PLANNERS AND SCIENTISTS
WINNIPEG - LONDON - WINDSOR - WATERLOO - TORONTO DATE: MAY 30, 1978. DEACON BOOSTER PUMPING STATION CONSULTANT DRAWING NO CENTRAL FILE ENGINEERING OFFICE 2 S4 of 13 DRAWING FILE NUMBER PLAN ABOVE ELEV. 236.500 m CITY DRAWING No. I PEVISED TO AS BUILT US YAM MEY ARPROVED BY: GRID CO-ORDINATES MICROFILMING AND ROOF PLANS DBP-18 BY DATE CHECKED BY: C.V. W WORKS & OPERATIONS DEPARTMENT MICROFILMED NOV -- 1981

FILE 10819 -A1-10361

REF. or DRAWING NO.

