

# THE CITY OF WINNIPEG

# **APPENDIX B**

Existing Drawings of Public Washroom Building

**TENDER NO. 581-2023** 

MAIN AND HENRY COMMUNITY CORNER PLAZA - 715 MAIN STREET

# 715 MAIN STREET PUBLIC TOILET

# 715 Main Street, Winnipeg, MB

### **ABBREVIATIONS**

A/VR Air/Vapour Barrier (Fully Adhered) Acoustic Ceiling Tile Auto Door Bottom AFF Above Finished Floor B/O B/U Built-Up BTW Catch Basin Canada Government Standards Board **CGSB** Cast In Plan Door Closer CLNG CMU CONC Concrete Masonry Unit Concrete CONST Construction CONT Continuous Carpet Tile Ceramic Tile Complete With DB Dead Bolt Door Opener Door Pull DS FLEC Electrical EXIS<sub>1</sub> Existing Flush Bolt FB Fire Extinguisher Fire Extinguisher Cabinet Fusible Link FLH Fixed Lever Handle F.R.R. Fire Rated Floor Stop G1S Good One Side Grade Two Gauge GAI V Galvanized Glass Fibre-Reinforced GFR Glazina Gypsum Wall Board **HORIZ** INS Insulated KMM Key to Master Kick Plate Lever Handle Laminate MAR MAX Maximum MECH Mechanical MIN Minimum MTL Metal Moisture Resistant Not Applicable NIC Not In Contract OSB Oriented Strand Board PC Precast Panic Hardware PLAM Plastic Laminate PLWD Plywood PLSH Polished Push Plate PRFFIN Pre-finished

Privacy Set

Pressed Steel Frame

Pressure Treated Green

Pressure Treated

Reverse Swing Resilient Sheet Flooring Rubber Wall Base Rain Water Leader RWL Hain Water
SBM Supplied by
SBO Supplied by
SC Self Cove E
SIM Similar
SS Stainless S
ST Stain
STL Steel
STRUCT Structural Supplied by Manufacturer Supplied by Owner Self Cove Base Stainless Steel Stain Grade SVC Sheet Vinyl Cove Sheet Vinyl Floor Solid Wood Door TH T/O TYP Threshold Top Of Typical U/S Underside VB VCT Vapor Retarder/Barrier Vinyl Composite Tile Vinyl Sheet Good VSG W/C

Washroom

Wall Stop

Wired Glass

Weather Stripping

Wall Mounted Fire Extinguisher

Wood

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### LISTS OF DRAWINGS

### **ARCHITECTURAL**

COVER SHEET
ASSEMBLIES AND GENERAL NOTES

3D AXO VIEWS

SITE CONTEXT PLAN

FOUNDATION PLAN

MAIN CONTAINER LEVEL PLAN SECOND CONTAINER LEVEL PLAN Δ102

THIRD CONTAINER LEVEL PLAN

MAIN FLOOR RCP

**EXTERIOR ELEVATIONS** 

**EXTERIOR ELEVATIONS** EXTERIOR FLEVATIONS

EXTERIOR ELEVATIONS

**BUILDING SECTION** 

**BUILDING SECTION** 

**BUILDING SECTION** 

**BUILDING SECTION** 

PLAN DETAILS PLAN DETAILS

A502

SECTION DETAILS

SECTION DETAILS

SECTION DETAILS

SECTION DETAILS

PLUMBING PEDESTAL DETAILS

INTERIOR FLEVATIONS

DOOR SCHEDULE

SANDBLASTING CONTAINERS (BY OTHERS)

### STRUCTURAL

GENERAL NOTES - PAGE 1 GENERAL NOTES - PAGE 2

FOLINDATION FRAMING PLAN MAIN FLOOR FRAMING PLAN

SECOND LEVEL FRAMING PLAN

THIRD LEVEL FRAMING PLAN

SITE CONCRETE PLAN

NORTH ELEVATION SOUTH ELEVATION

EAST AND WEST ELEVATIONS

BUILDING SECTIONS

**SECTION - GRID A INTERIOR** 

SECTION - GRID B - MECH.

SECTION - GRID B - SINKS

SECTION - GRID C - OFFICE

SECTIONS AND DETAILS SECTIONS AND DETAILS

3-D DETAILS

3-D DETAILS 3-D DETAILS

MECHANICAL M-1 LEGEND & SCHEDULE

INFLOOR HEATING FLOOR PLAN

MAIN FLOOR PLAN - HVAC

UPPER LEVEL FLOOR PLAN - MECHANICAL

M-5 MAIN FLOOR PLAN - PLUMBING M-6 SPECIFICATION & EQUIPMENT LIST

### ELECTRICAL

TITLE SHEET

MAIN LEVEL - POWER LAYOUT

MAIN LEVEL - LIGHTING LAYOUT MAIN LEVEL - LOW VOLTAGE SYSTEMS

SECOND LEVEL - POWER LAYOUT SECOND LEVEL - LIGHTING LAYOUT

**EQUIPMENT & PANEL SCHEDULES** 

INSTALLATION SPECIFICATIONS - PART 1

**INSTALLATION SPECIFICATIONS - PART 2** 

C1 LOT GRADING & SERVICING PLAN

### **GENERAL NOTES**


1. THESE DRAWINGS SHALL NOT BE SCALED

DECK IS TO BE PRESSURE-TREATED.

- 2. THE CONTRACTOR IS RESPONSIBLE FOR THE VERIFICATION OF MEASUREMENTS AND QUANTITIES OF MATERIALS REQUIRED
- 3. DIMENSIONS ARE TO GRID LINES, FACE OF STUD, CONCRETE OR EXISTING WORK TO REMAIN UNLESS NOTED OTHERWISE
- 4. PERFORM WORK IN STRICT ACCORDANCE WITH THE 2012 MANITOBA BUILDING CODE AND ANY OTHER CODE OF PROVINCIAL APPLICATION. OBSERVE ALL LOCAL ORDINANCES AND REGULATIONS.
- 5. CONTRACTOR TO REVIEW ALL ARCHITECTURAL, MECHANICAL, AND ELECTRICAL DRAWINGS FOR ALL OPENINGS THROUGH FLOOR, WALLS, AND ROOF ASSEMBLIES. REFER TO STRUCTURAL DETAILS FOR
- 6. CONTRACTOR TO VERIFY ALL EXISTING SITE CONDITIONS AND REPORT ALL DISCREPANCIES TO THE CONTRACT ADMINISTRATOR PRIOR TO
- 7. ALL PLYWOOD AND/OR WOOD BLOCKING USED AT OR BELOW GRADE IS TO BE PRESSURE-TREATED. 8. ALL PLYWOOD OR WOOD BLOCKING USED ABOVE PLANE OF ROOF
- 9. IN CASE OF DOUBT; CONFLICT OR DISCREPANCIES ON THE DRAWINGS AND/OR SPECIFICATIONS; OR QUESTIONS REGARDING MATERIALS OR SUITABLE METHOD OF CONSTRUCTION, CONSULT ARCHITECT FOR
- 10. CONTRACTOR TO SUBMIT APPLICATIONS FOR EQUAL IN WRITING. ALONG WITH SUPPORTING DATA, FOR APPROVAL PRIOR TO

CLARIFICATION REFORE PROCEEDING WITH WORK

- 11. COMPENSATION WILL NOT BE MADE BECAUSE OF FAILURE TO MAKE PROPER SITE INVESTIGATIONS AND REPORT OF ANY DISCEPANCIES TO THE CONTRACT ADMINISTRATOR PRIOR TO TENDER CLOSING OR BECAUSE OF FAILURE TO UNDERSTAND FULL NATURE OF WORK
- 12. GENERAL CONTRACTOR TO COORDINATE AND PROVIDE ALL SOLID BLOCKING WITHIN THE WALL AND CEILING AREAS TO SUPPORT SUBFACE MOUNTED FIXTURES AND FITTINGS INCILIDING BUT NOT LIMITED TO APPLIANCES. HANDRAILS, SIGNS AND ACCESSORIES -INCLUDING ITEMS NOTED AS N.I.C. IN COORDINATION WITH THE OWNER.

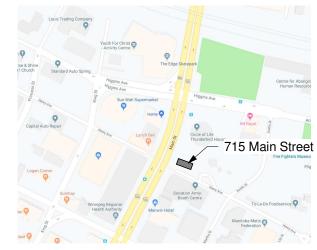



# **bridgman**collaborative

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### Proiect: 715 MAIN STREET **PUBLIC TOILET**

715 Main Street, Winnipeg, MB

Project Number

Bid Opportunity Number: 54-2021



### Issue/Revision Date

ISSUED FOR CONSTRUCTION

MAR. 3, 2021

Drawing Title: **COVER SHEET** 

Sheet No:

## **ASSEMBLY LEGEND**

### **WALL TYPES**

EW1 METAL CLADDING ON WOOD STUD FRAMING - PLYWOOD INTERIOR

- 22mm PREFINISHED 22 GA. CORRUGATED METAL CLADDING
- SPUN POLYOLEFIN WATER RESISTIVE BARRIER MEMBRANE
- 16mm GLASS FIBRE REINFORCED EXTERIOR SHEATHING
- 184mm WOOD STUD FRAMING @ 203MM O.C. (REFER TO STRUCT) (FILL STUD CAVITY W/6" MIN. BATT INSULATION)
- 6 MIL POLYETHYLENE VAPOUR BARRIER MEMBRANE
- 13mm BALTIC BIRCH PLYWOOD CLEAR SEALED (SEE GENERAL NOTE #6)

EW2 METAL CLADDING ON WOOD STUD FRAMING - GWB INTERIOR

- 22mm PREFINISHED 22 GA. CORRUGATED METAL CLADDING
- SPUN POLYOLEFIN WATER RESISTIVE BARRIER MEMBRANE
- 16mm GLASS FIBRE REINFORCED EXTERIOR SHEATHING
- 184mm WOOD STUD FRAMING @ 203MM O.C. (REFER TO STRUCT)
- (FILL STUD CAVITY W/6" MIN. BATT INSULATION)
- 6 MIL POLYETHYLENE VAPOUR BARRIER MEMBRANE • 1/2" GYPSUM BOARD - PAINTED (ABOVE ELEVATION U/S CONTAINER 2)

EW3 METAL CLADDING ON WOOD STUD FRAMING - NO INSULATION

- 22mm PREFINISHED 22 GA. CORRUGATED METAL CLADDING
- SPUN POLYOLEFIN WATER RESISTIVE BARRIER MEMBRANE
- 16mm GLASS FIBRE REINFORCED EXTERIOR SHEATHING
- 92mm WOOD STUD FRAMING @ 203MM O.C. (REFER TO STRUCT)

IW1 CONCRETE BLOCK

• 92mm CONCRETE BLOCK - SEALED

NOTE: REFER TO FLOOR PLAN FOR AREAS OF 76mm MIN. SPRAYFOAM INSULATION BETWEEN SHIPPING CONTAINER AND CONC BLOCK

IW2 92mm STEEL STUD PARTITION

- 92mm STEEL STUDS @ MAX 406mm O.C.
- 16mm ABUSE-RESISTANT GYPSUM BOARD

IW3 92mm STEEL STUD PARTITION - SPRAYFOAM INSULATION

- 13mm CONSTRUCTION GRADE PLYWOOD
- 92mm STEEL STUDS @ MAX 406mm O.C.

(FILL CAVITY SPACE BETWEEN STUDS & SHIPPING CONTAINER WALL WITH 76mm MIN. SPRAYFOAM)

### IW3a 92mm STEEL STUD PARTITION - BATT INSULATION

- 13mm CONSTRUCTION GRADE PLYWOOD
- 92mm STEEL STUDS @ MAX 406mm O.C.

(FILL STUD CAVITY SPACE WITH 89mm MINERAL WOOL BATT INSULATION)

• VAPOUR BARRIER, TAPPED ALL SIDES & CONTINUOUS WITH ADJACENT WALLS

NOTE: CONSTRUCT WALL TO BE REMOVABLE WHEN ACCESS IS REQUIRED THROUGH CONTAINER DOORS

### **ROOF TYPES**

R1 SLOPED WOOD ROOF

- 2 PLY MOD. BIT. HEAT WELDED CAP SHEET
- ICE & WATER SHIELD TO COVER ENTIRE ROOF
- 3mm PROTECTION COVER BOARD (BASIS OF DESIGN: IKO PROTECTOBOARD)
- FULLY ADHERED SBS MODIFIED BITUMEN AIR/VAPOUR BARRIER
- 16mm PLYWOOD SHEATHING
- P.T. WOOD BLOCKING AS REQUIRED FOR SLOPE (REFER TO STRUCTURAL)
- 89mm P.T. WOOD STUDS ON FLAT @ 406mm O.C. ACROSS TOP OF CONTAINERS

NOTE: SECURE ROOF TO CONTAINER TOP CHANNEL FRAMES ONLY (NO PENETRATIONS ALLOWED INTO CONTAINER CORRUGATED ROOF)

## **GENERAL NOTES:**

- 1. SHIPPING CONTAINERS & SANDBLASTING OF CONTAINERS PROVIDED BY CLIENT
- 2. PROVIDE SEPARATE PRICE FOR 2 URINALS ON EAST ELEVATION
- 3. PROVIDE SEPARATE PRICE FOR 'LOO LOO' & 'W PG' 1220mm x 152mm LETTERING ON STANDOFFS (LOCATED ON WEST & NORTH ELEVATIONS)
- 4. ALL SHIPPING CONTAINER WALLS WHERE SPRAYFOAM INSULATION IS INDICATED ON DRAWINGS TO BE A MINIMUM THICKNESS OF 76mm (REFER TO PLANS AND
- 5. ALL CAVITIES WHERE SPRAYFOAM IS INDICATED TO BE COMPLETELY FILLED WITH NO VOIDS ALLOWED. IF VOIDS ARE DISCOVERED. THE CONTRACT ADMINISTRATOR MAY REQUEST A FULL INSPECTION OF SPRAYFOAM APPLICATION AT THE GC'S EXPENSE
- 6. BALTIC BIRCH PLYWOOD INTERIOR FINISH TO BE FULL SIZE 1220x2434mm SHEETS OF PLYWOOD ALIGNED WITH ELEVATION U/S CONTAINER 2. CUT BALTIC BIRCH PLYWOOD, SIZE TO SUIT, BELOW FULL SHEET AS WALL BASE - CLEAR SEALED.
- 7. ALL GLAZING, UNLESS OTHERWISE NOTED, TO BE TEMPERED TYPICAL
- 8. ALL EXPOSED STEEL FABRICATED EDGES TO BE GROUND SMOOTH
- 9. ALL EXPOSED WELDING TO BE CONTINUOUS AND GROUND SMOOTH
- 10. MAKE GOOD ANY DAMAGE DONE TO EXISTING CITY SIDEWALK
- 11. CONFIRM FINISHES OF ALL STEEL WORK WITH CONTRACT ADMINISTRATOR
- 12. WATERPROOF RUBBER MEMBRANE TO BE: Blue Seal Waterproofing Rubber Membrane Model # BE185169 Home Depot
- 13. ALL EXPOSED CONCRETE BLOCK TO BE SEALED WITH: Quikrete Acrylic Concrete Sealer 3.8L - Model 880003 SKU 1000 142722 Home Depot
- 14. ALL CONCRETE FLOORS AND TOPPING TO BE SEALED. CONCRETE SEALER TO BE AN EPOXY-BASED LIQUID COATING SYSTEM. INSTALLED AS PER MANUFACTURER'S INSTRUCTIONS OVER ALL INTERIOR CONCRETE: PRODUCT TO BE (REFER TO SPEC):

Manufacturer: Soprema System Name: Aslan Floor Quartz Colour: Grey OR White ( to be confirmed)

### **FLOOR TYPES**

CONCRETE STRUCTURAL SLAB ON GRADE

- CONCRETE SLAB ON GRADE (REFER TO STRUCTURAL)
- 10mil POLYETHELENE SHEET VAPOUR RETARDER
- 102mm EPS FOIL-FACE RIGID INSULATION
- 152mm VOID FORM (REFER TO STRUCTURAL)
- COMPACTED GRANULAR FILL (REFER TO STRUCTURAL)

### CONCRETE TOPPING

- 51mm CONCRETE TOPPING (REFER TO STRUCTURAL)
- EXISTING CONTAINER PLYWOOD FLOOR
- SPRAYFOAM CAVITY BETWEEN EXISTING CONTAINER FLOOR STEEL MEMBERS
- 10mil POLYETHELENE SHEET VAPOUR RETARDER
- 102mm EPS RIGID INSULATION
- COMPACTED GRANULAR FILL (REFER TO STRUCTURAL)

EXISTING CONTAINER FLOOR W/ SPRAYFOAM FLOOR CAVITY


- EXISTING CONTAINER PLYWOOD FLOOR
- SPRAYFOAM INSULATION IN CAVITY BETWEEN CONTAINER FLOOR STEEL MEMBERS

WOOD JOIST FLOOR - INSULATED

• 16mm PLYWOOD SHEATHING (REFER TO STRUCTURAL) • 184mm WOOD JOISTS @ 406mm O.C. (REFER TO STRUCTURAL) (FILL FULL JOIST CAVITY W/ BATT INSULATION)

- 6 MIL POLYETHYLENE VAPOUR BARRIER MEMBRANE
- 1/2" GYPSUM BOARD PAINTED

# SYMBOL LEGEND

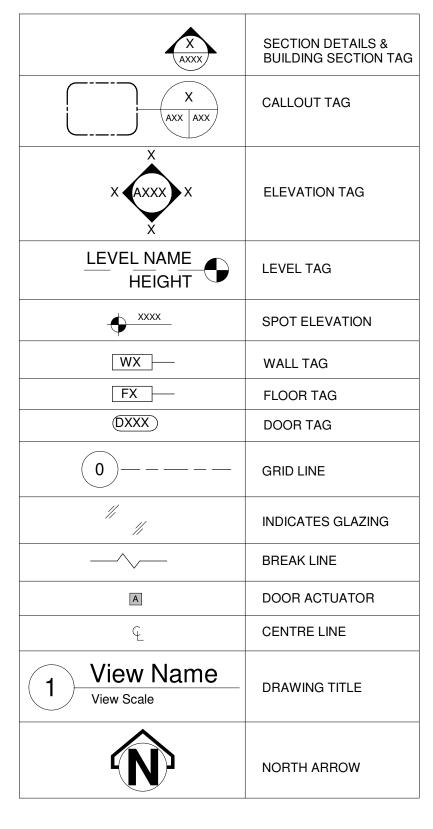

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715 Main Street, Winnipeg, MB

Project Number:

2022 Bid Opportunity Number: 54-2021



### Issue/Revision Date


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Drawing Title: **ASSEMBLIES AND** 

**GENERAL NOTES** 

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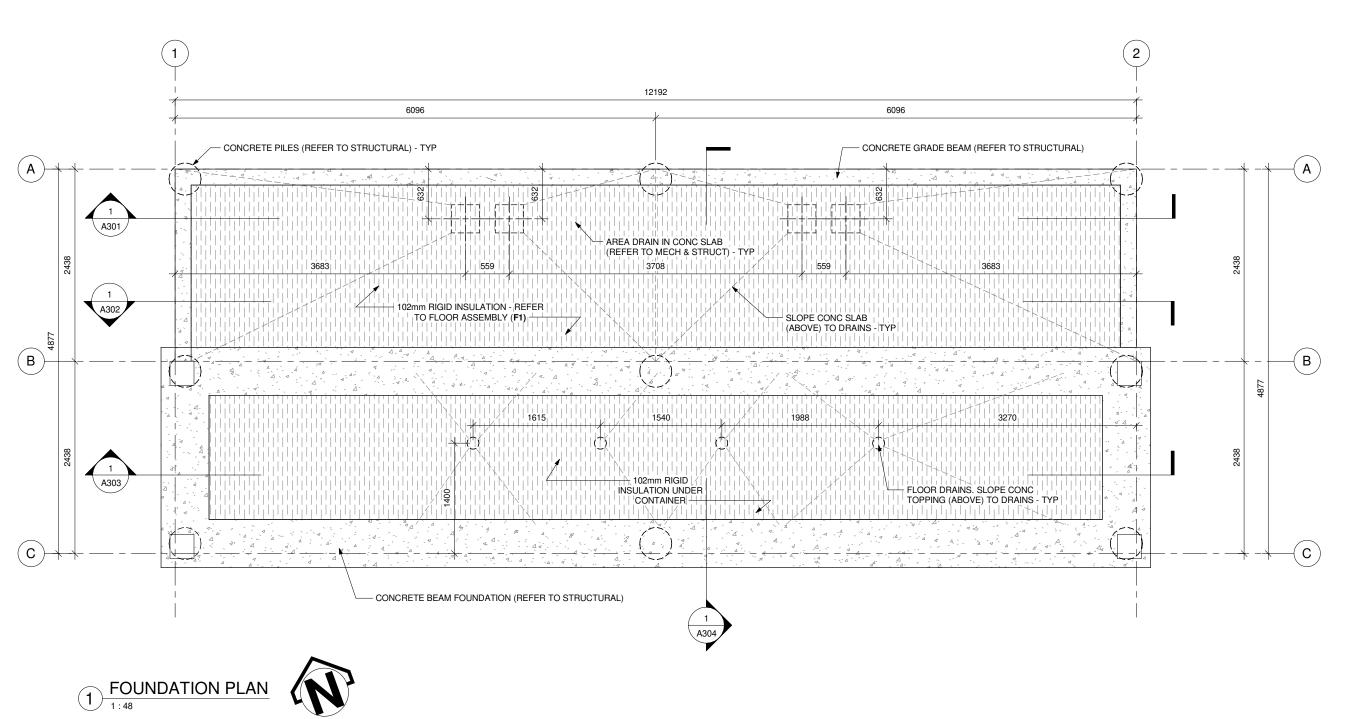


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Drawing Title: 3D AXO VIEWS

A002

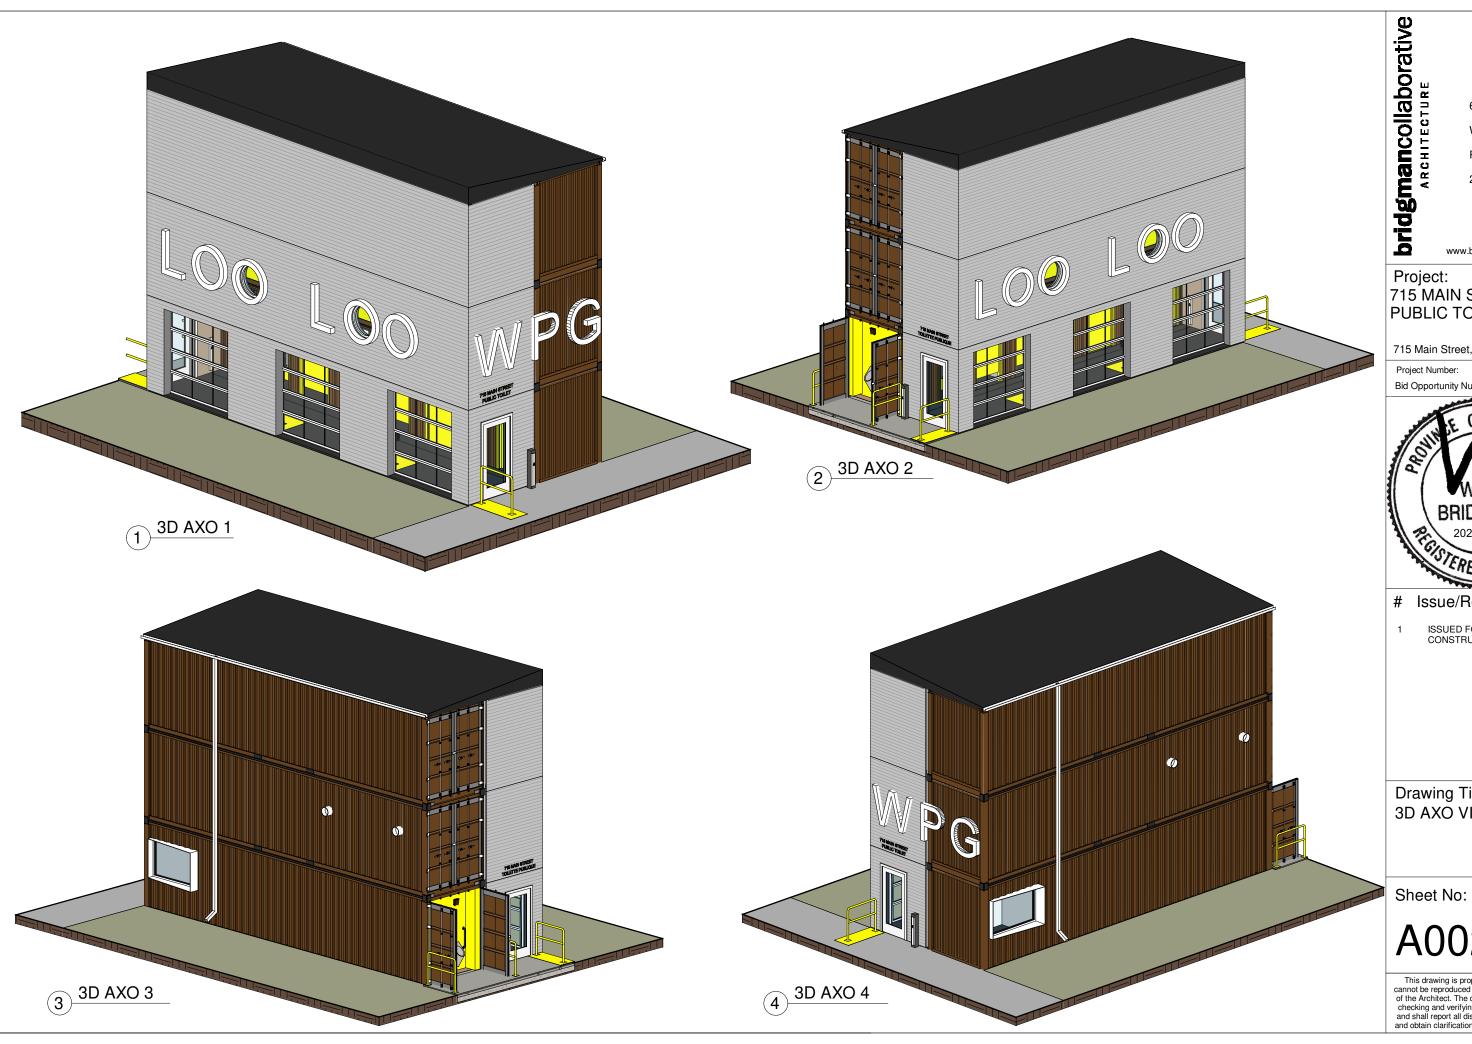

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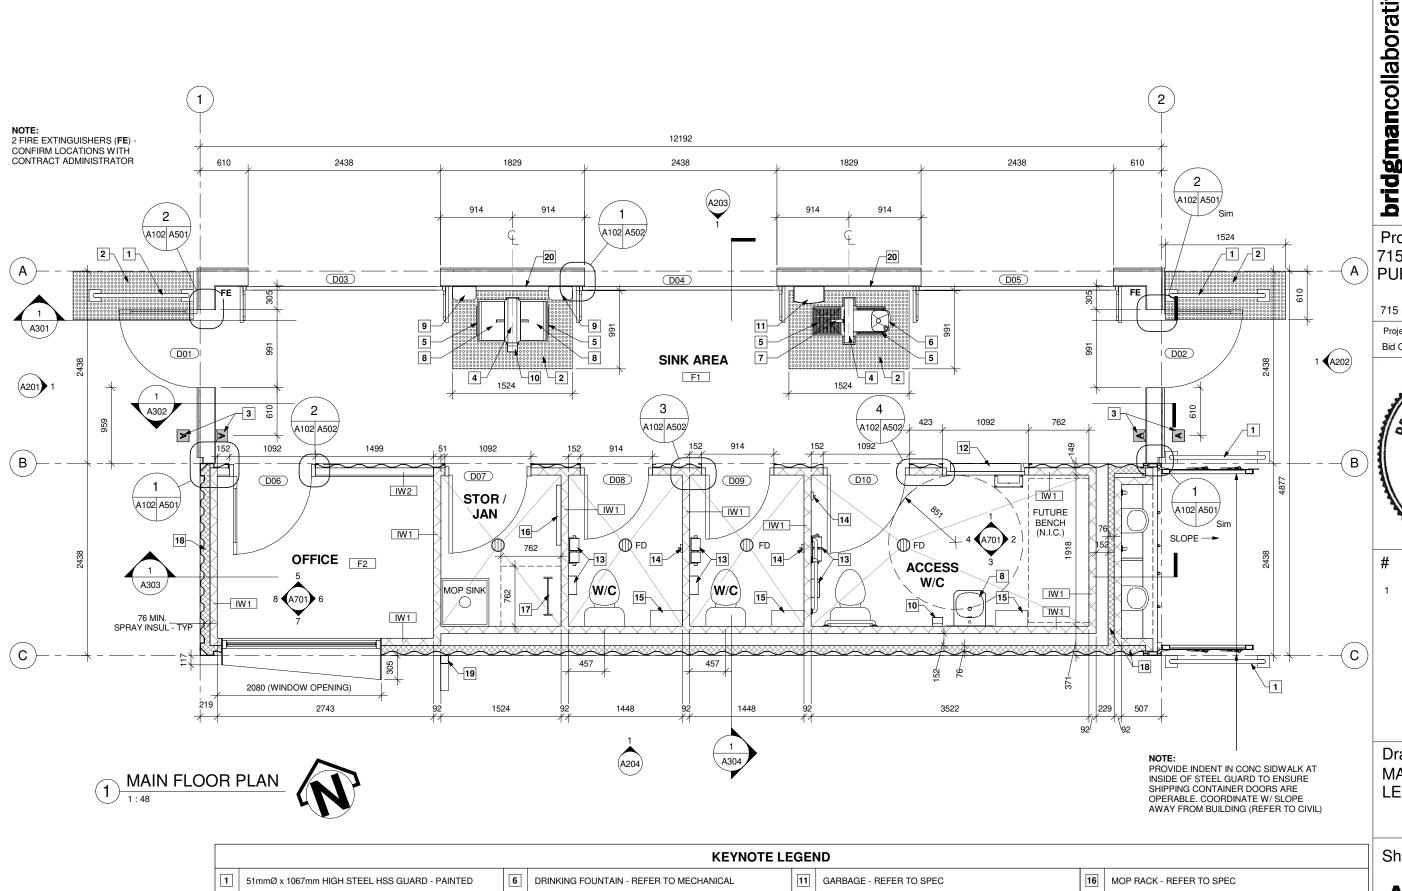
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Sheet No:



HOSE SPIGOT - REFER TO MECHANICAL

HAND SINK - REFER TO MECHANICAL

HAND DRYER - REFER TO SPEC

10 SOAP DISPENSER - REFER TO SPEC

FOLD-DOWN BABY CHANGE TABLE - REFER TO SPEC

SANITARY NAPKIN DISPOSAL & TOILET PAPER HOLDER IN ALL W/C STALLS (TYP) - REFER TO SPEC

COLLAPSIBLE COAT HOOK IN ALL W/C STALLS (TYP) - REFER TO SPEC

STAINLESS STEEL SHELF IN ALL W/C STALLS

(TYP) - REFER TO SPEC

TACTILE WARNING SURFACE - REFER TO SPEC

BOLLARD (EXTERIOR) & WALL MOUNTED (INTERIOR) BAR TYPE DOOR ACTUATOR - TYP

PLUMBING PEDESTAL - REFER TO DETAILS

AREA DRAIN - REFER TO MECHANICAL

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Drawing Title: MAIN CONTAINER LEVEL PLAN

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MECH CONTAINER LADDER ACCESS


PREFIN METAL DOWNSPOUT

18

76mm MIN. SPRAYFOAM INSULATION INDICATED THUS - TYP

13mm WALL APPLIED SOLID SURFACE BETWEEN

DOORS. HEIGHT TO MATCH 2 PLUMBING PEDESTALS

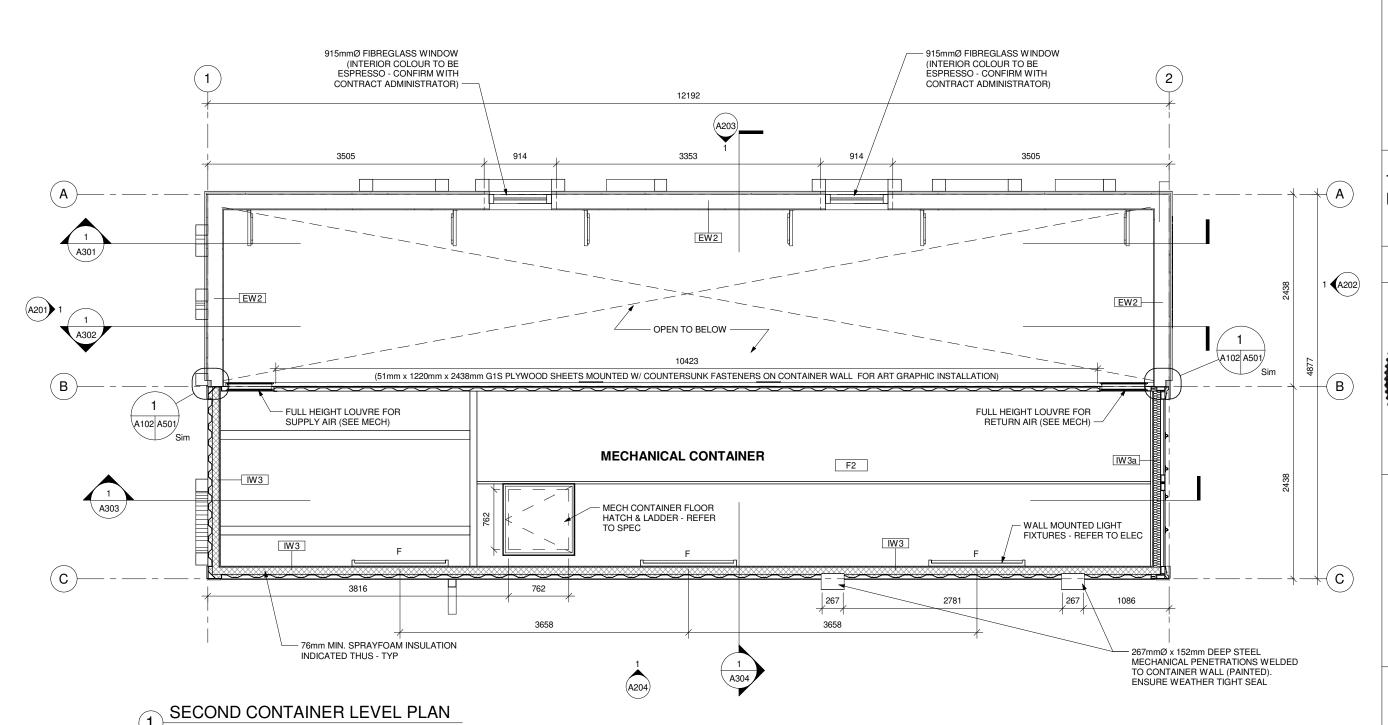

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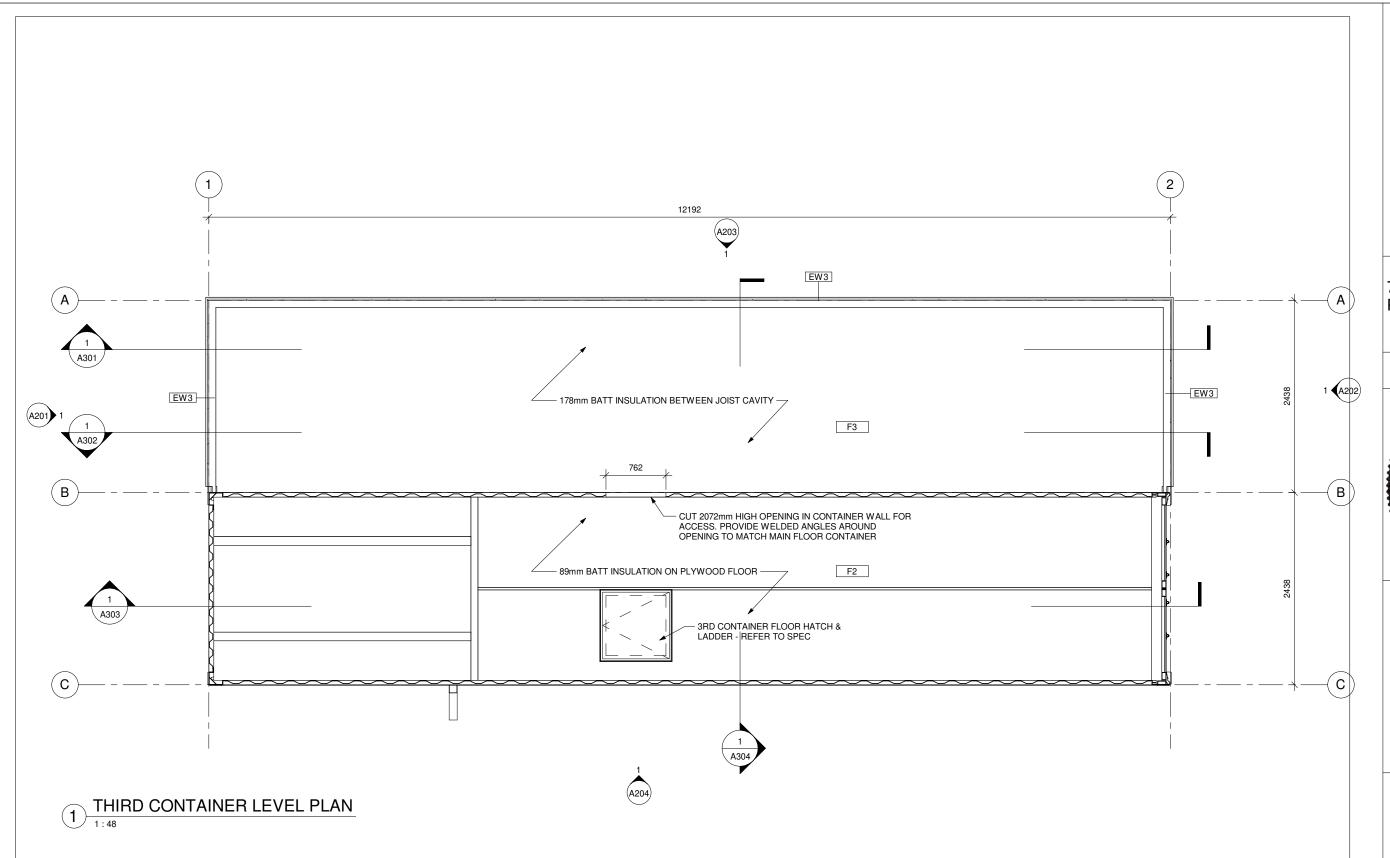
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Drawing Title: SECOND CONTAINER LEVEL PLAN

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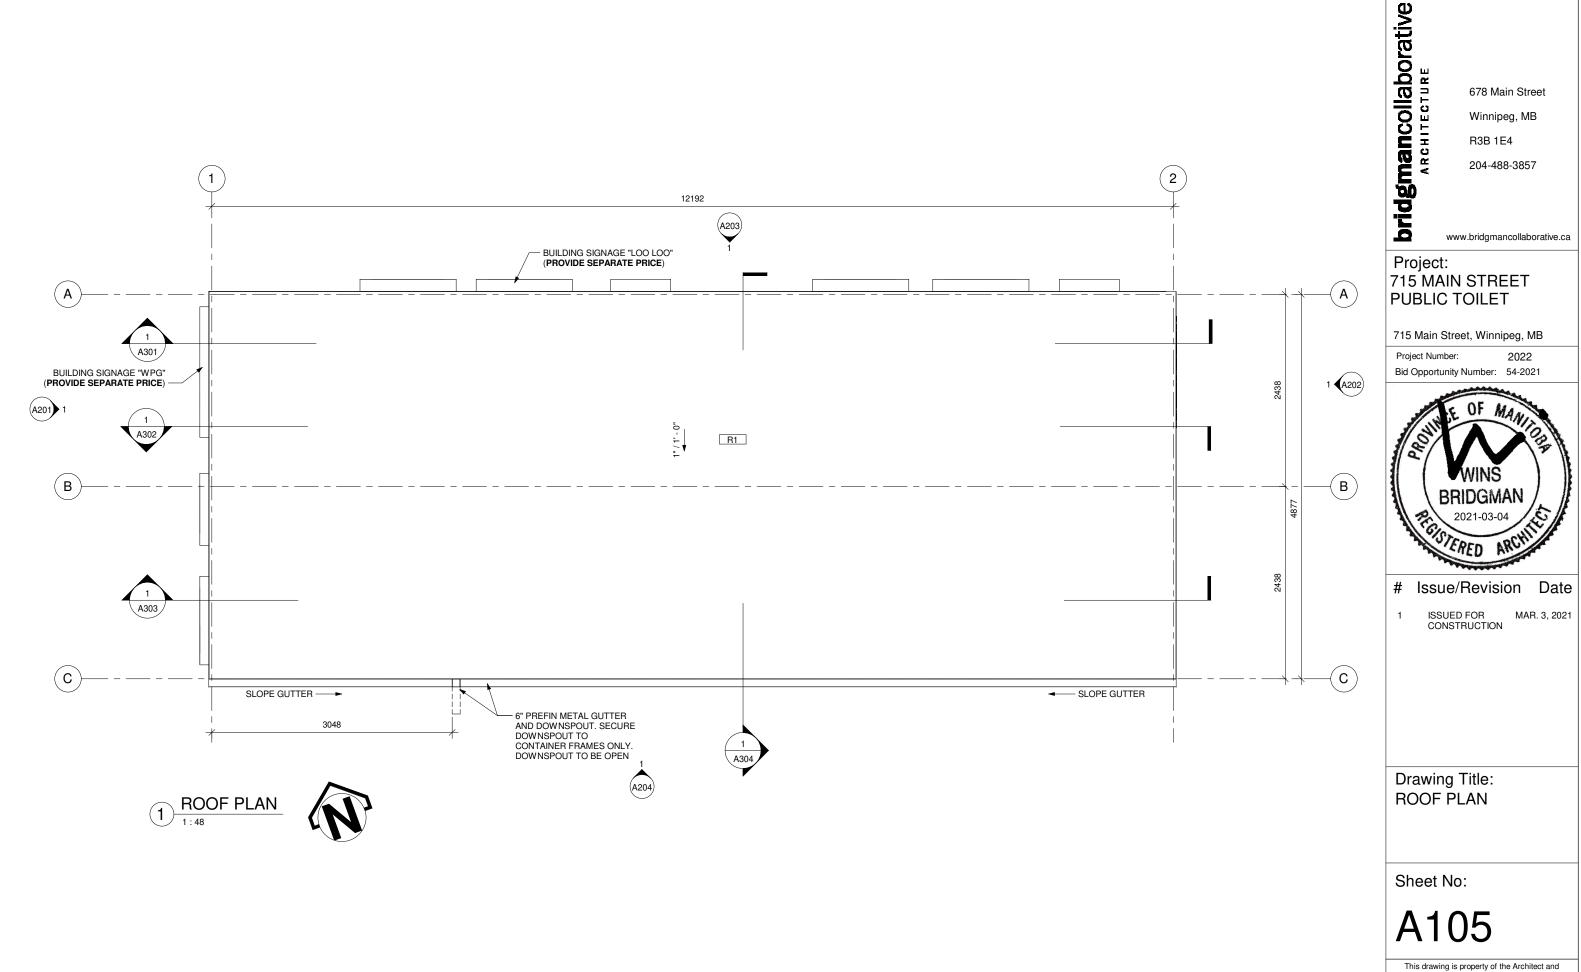
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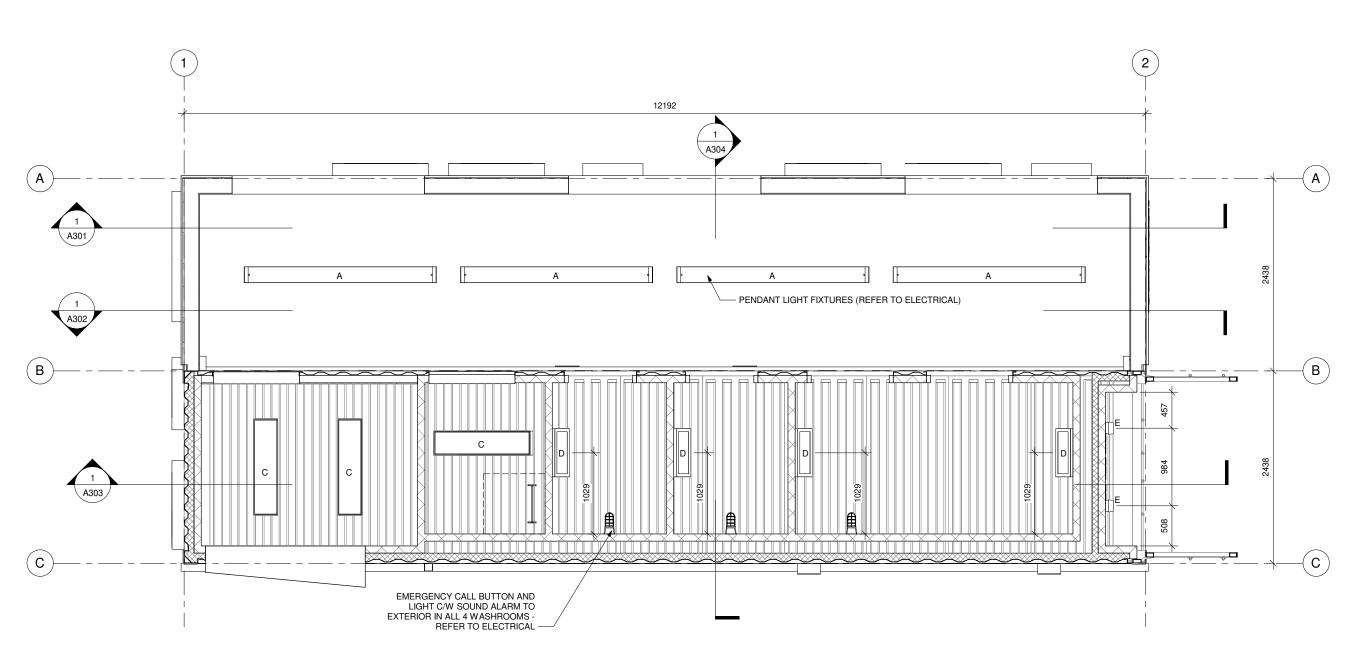
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Drawing Title: THIRD CONTAINER LEVEL PLAN

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A104





1) REFLECTED CEILING PLAN

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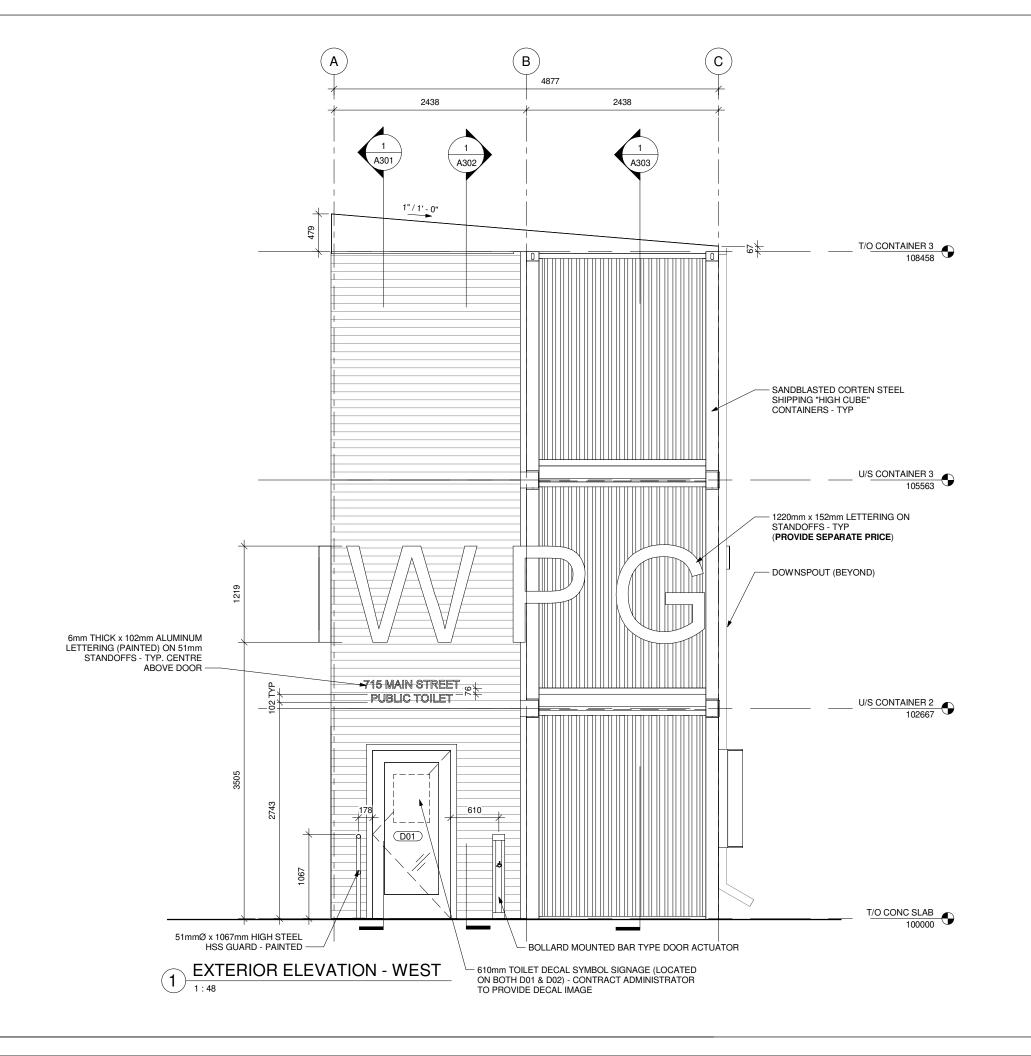
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Drawing Title: MAIN FLOOR RCP

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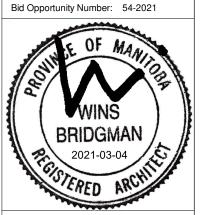
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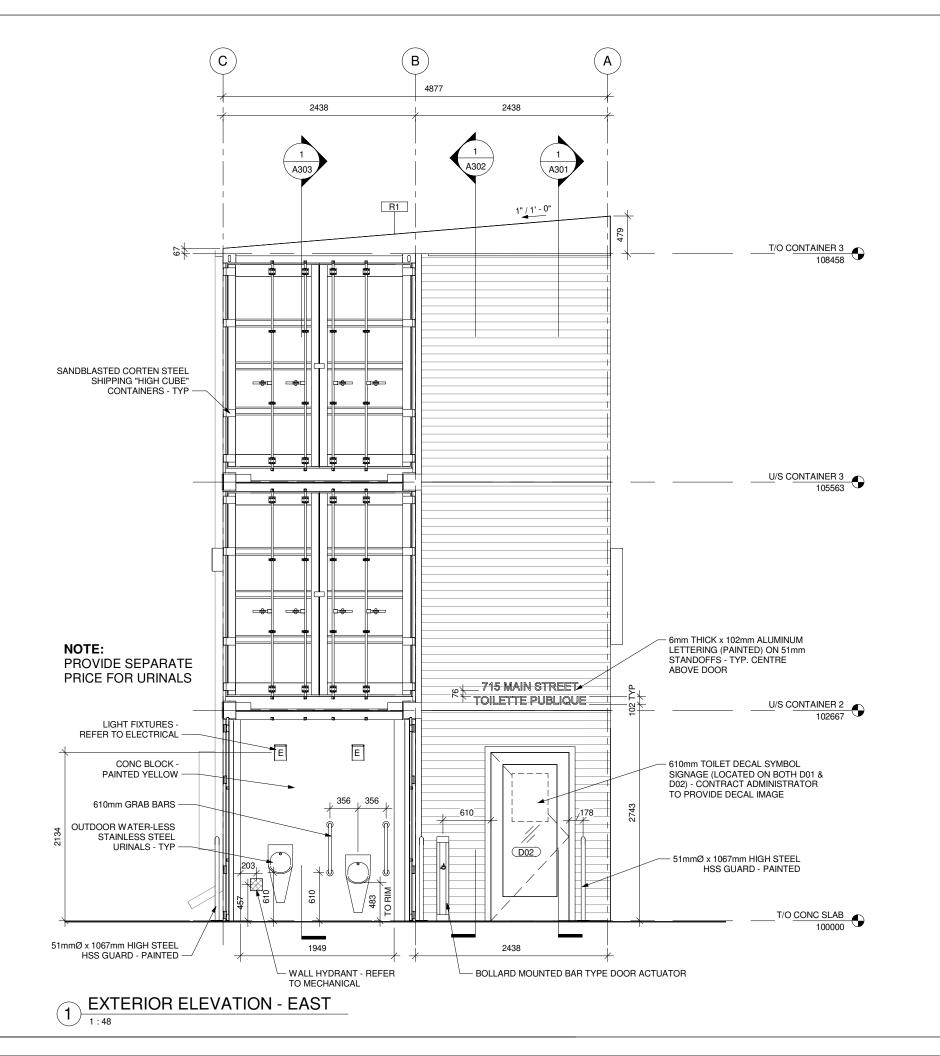
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Drawing Title: EXTERIOR ELEVATIONS

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A201



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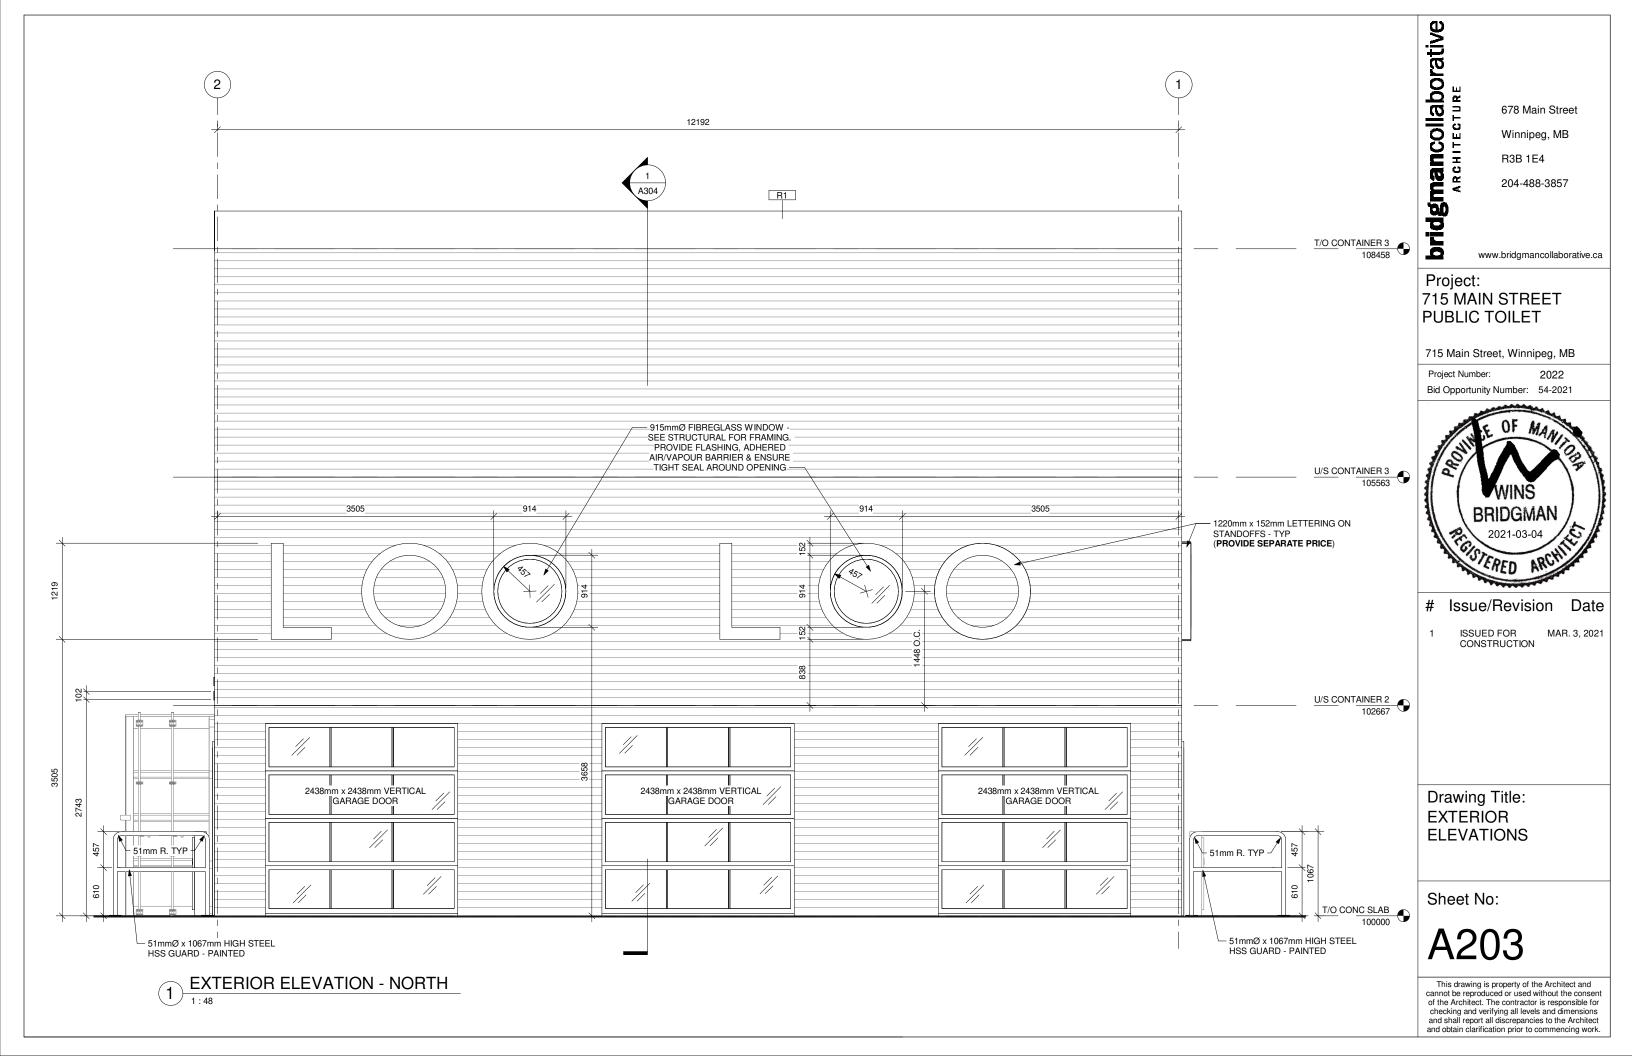
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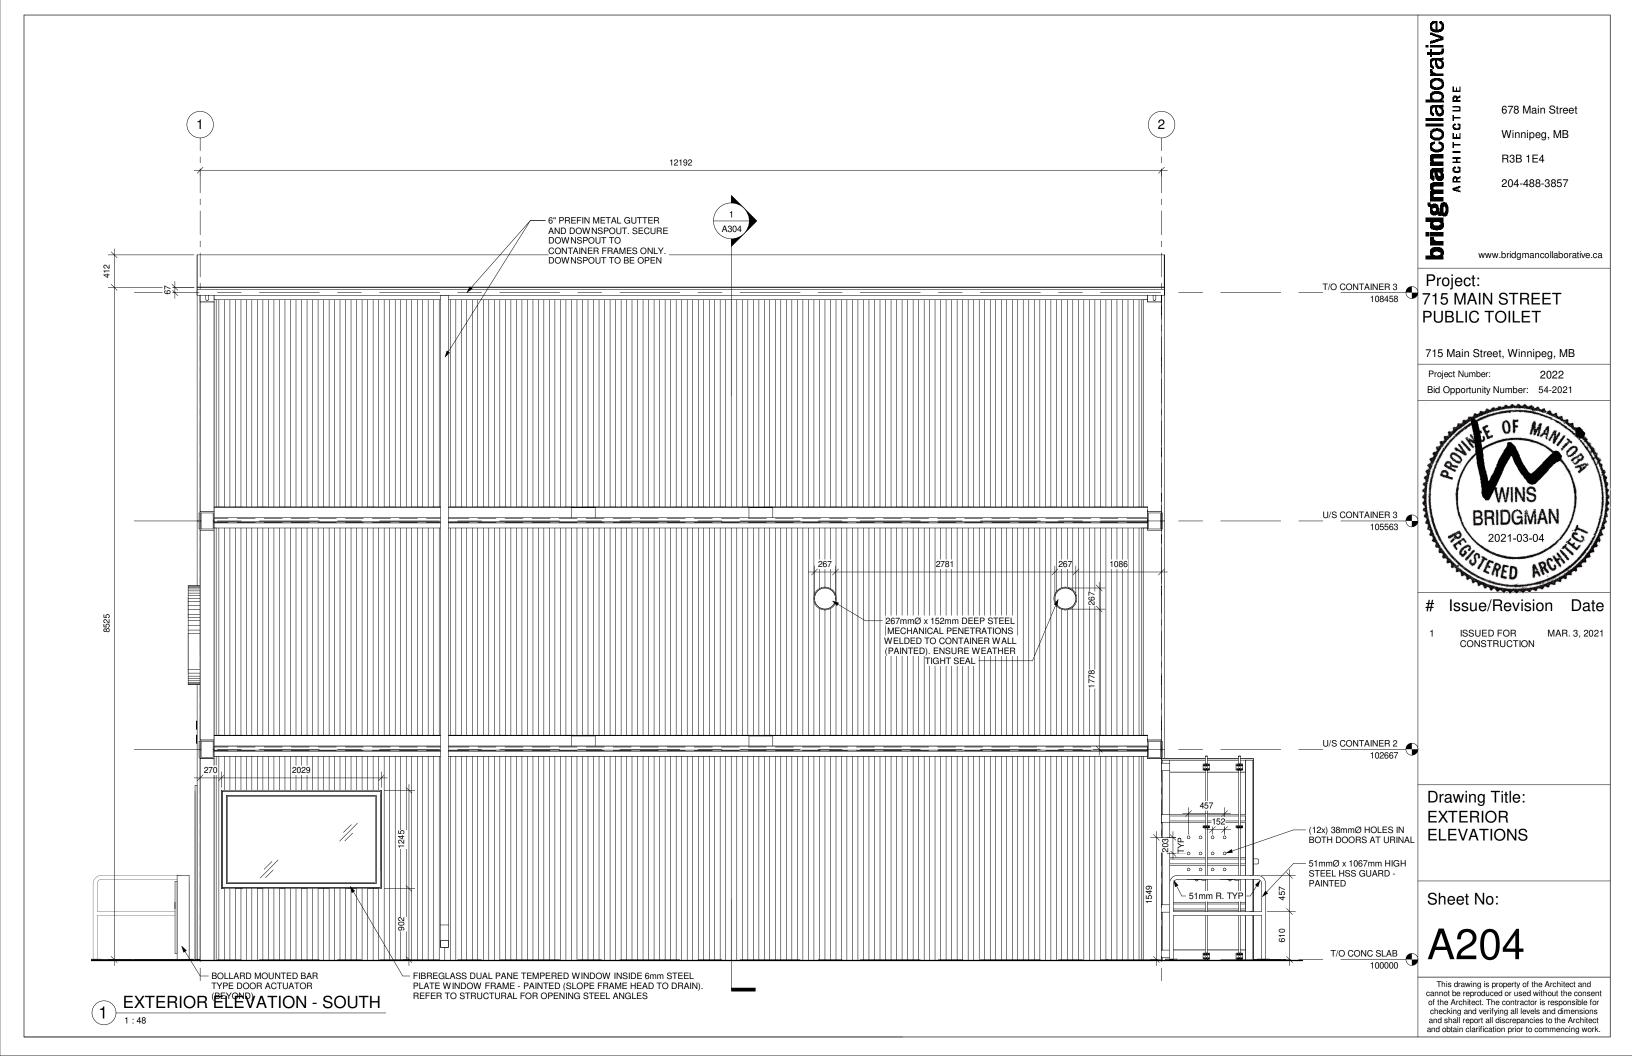
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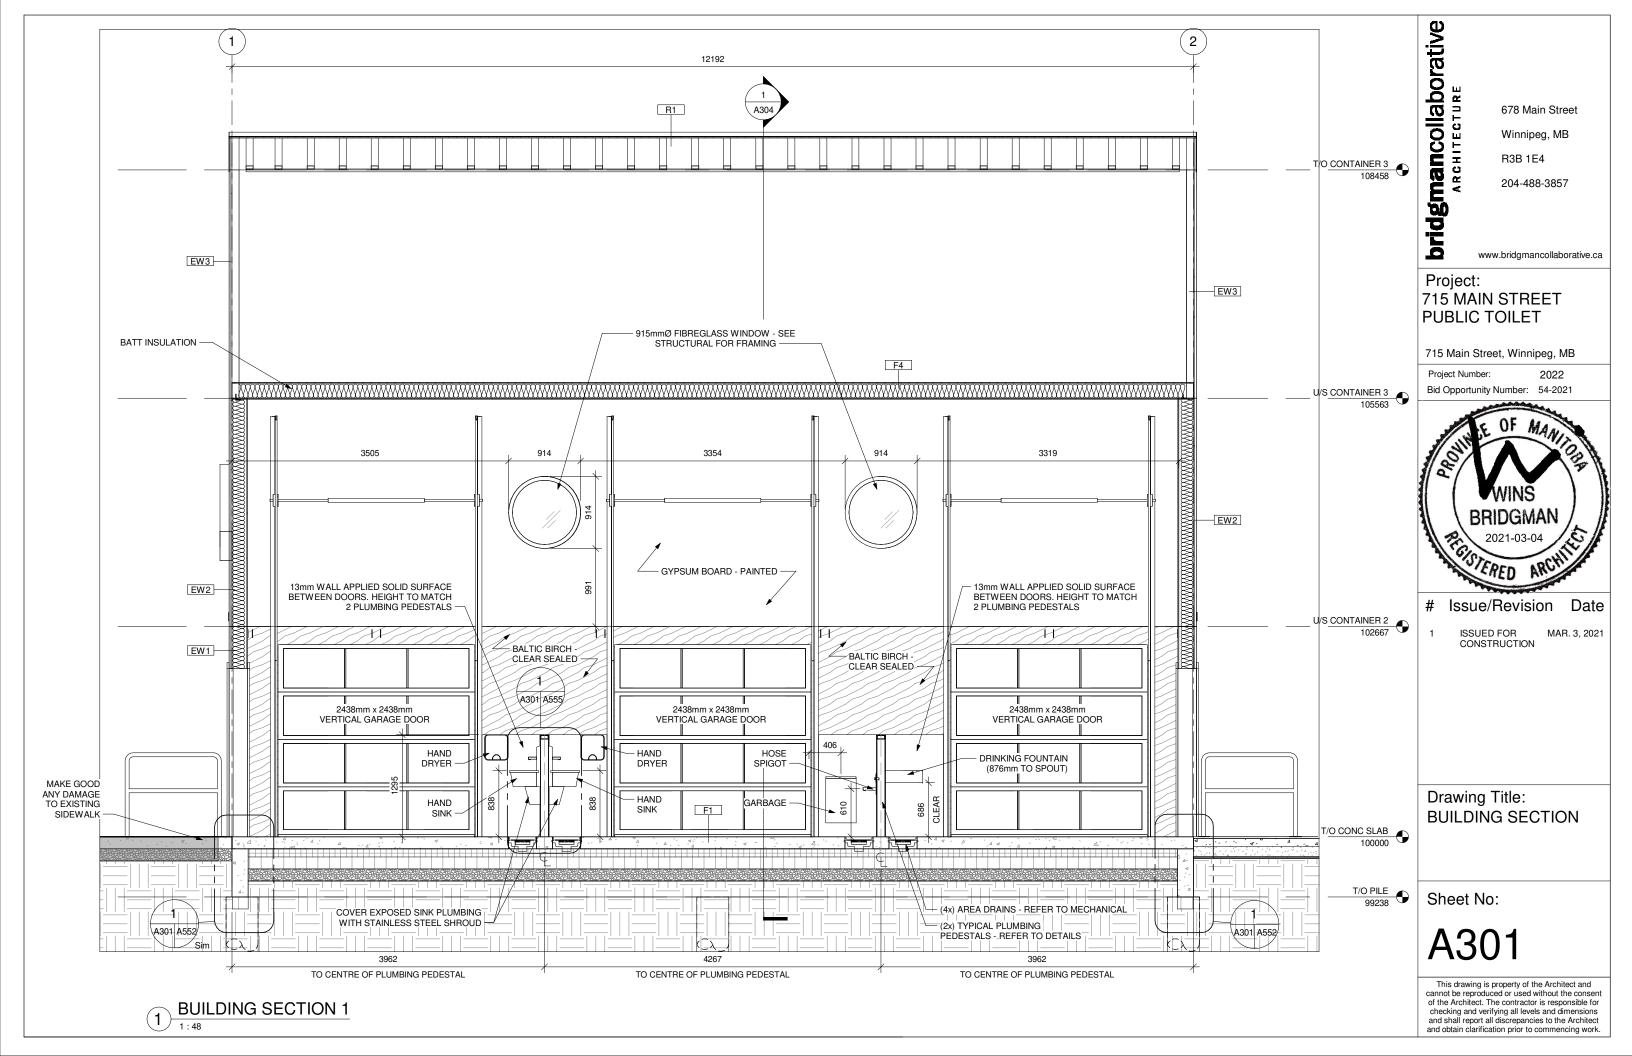
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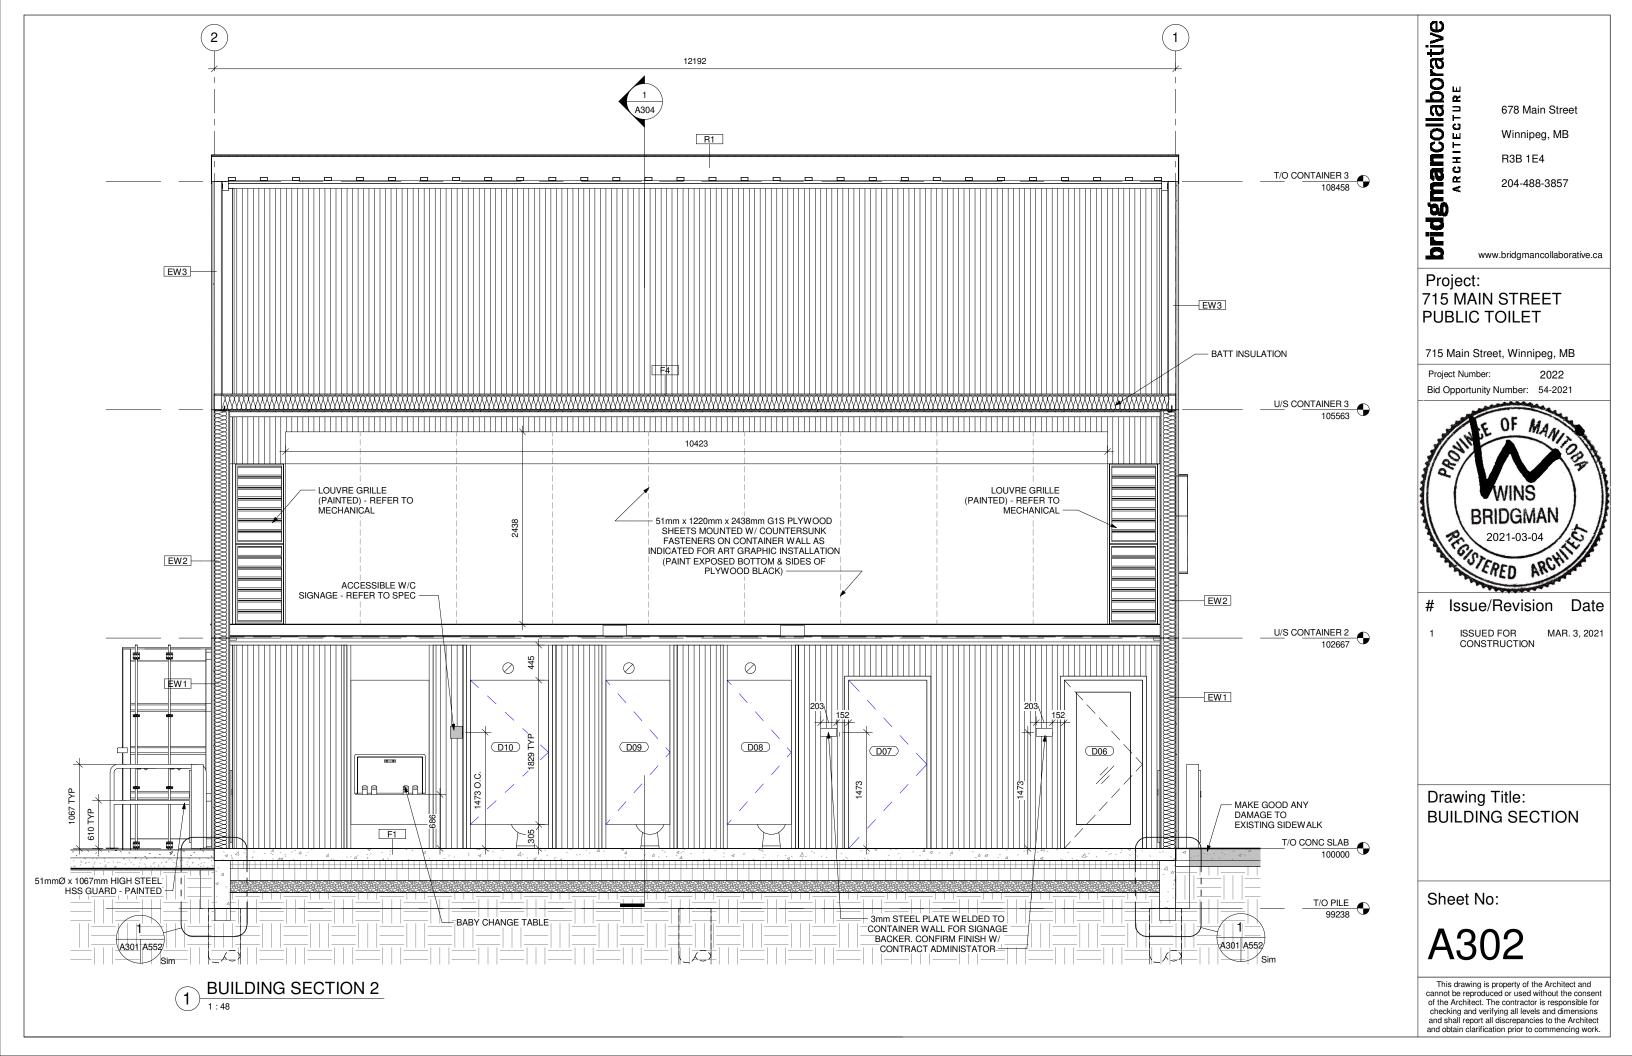
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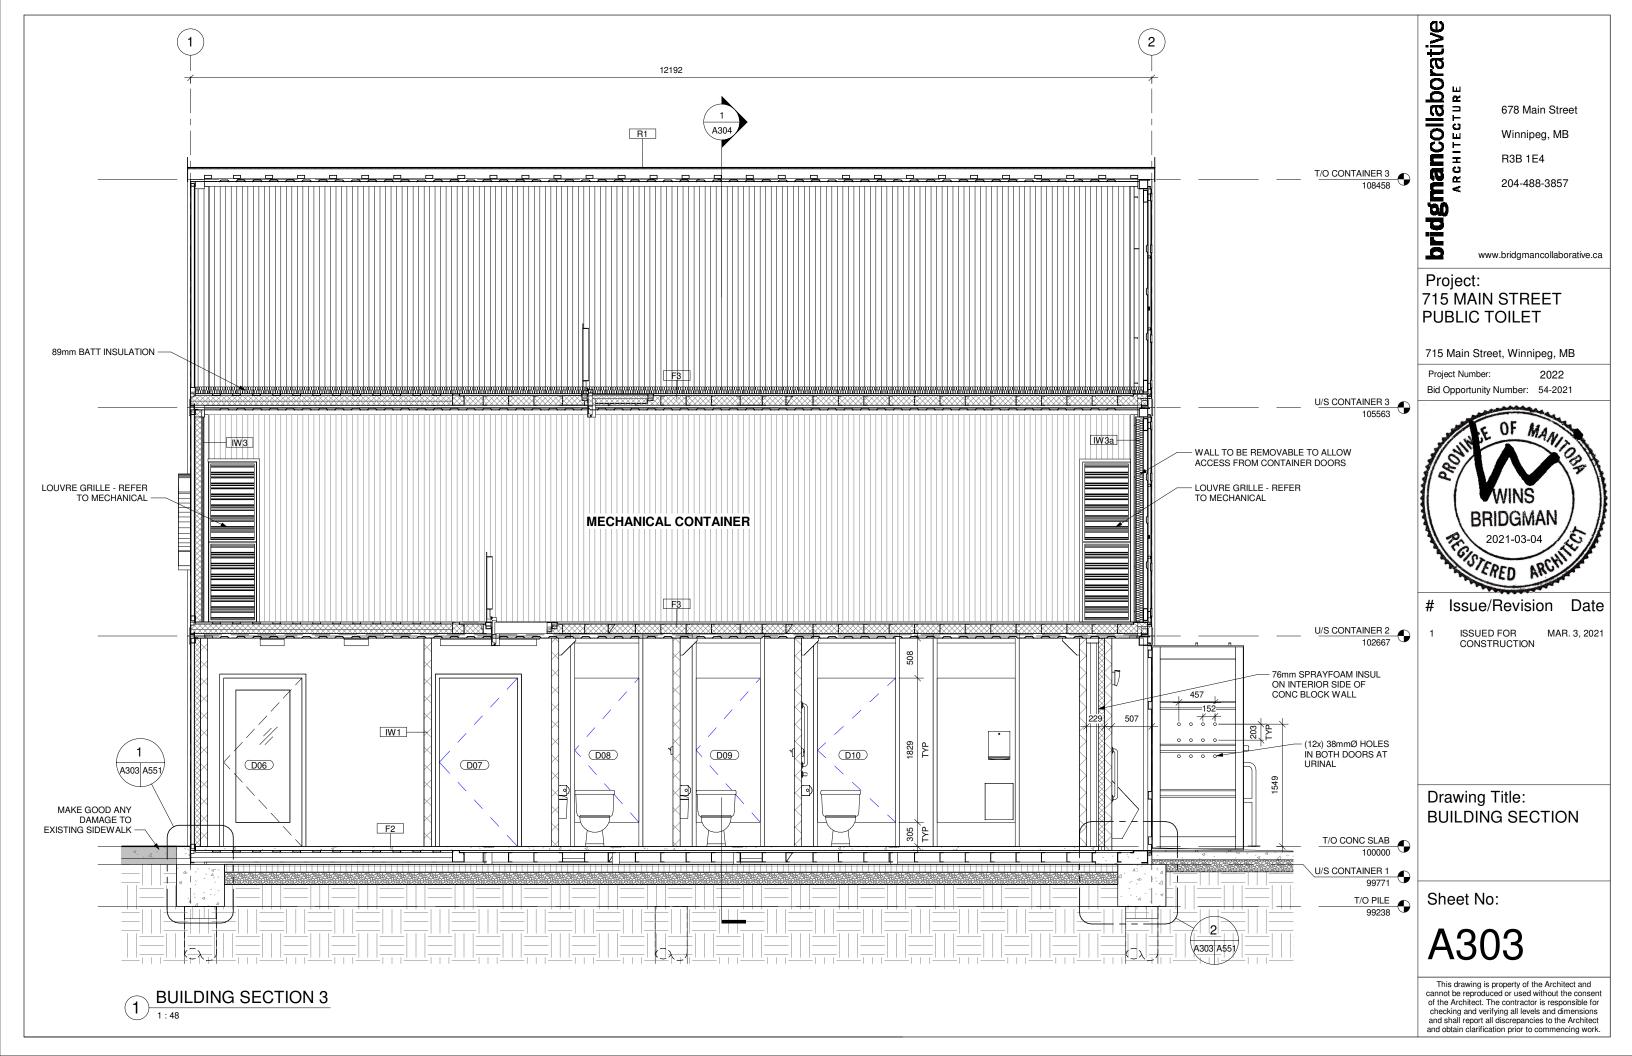
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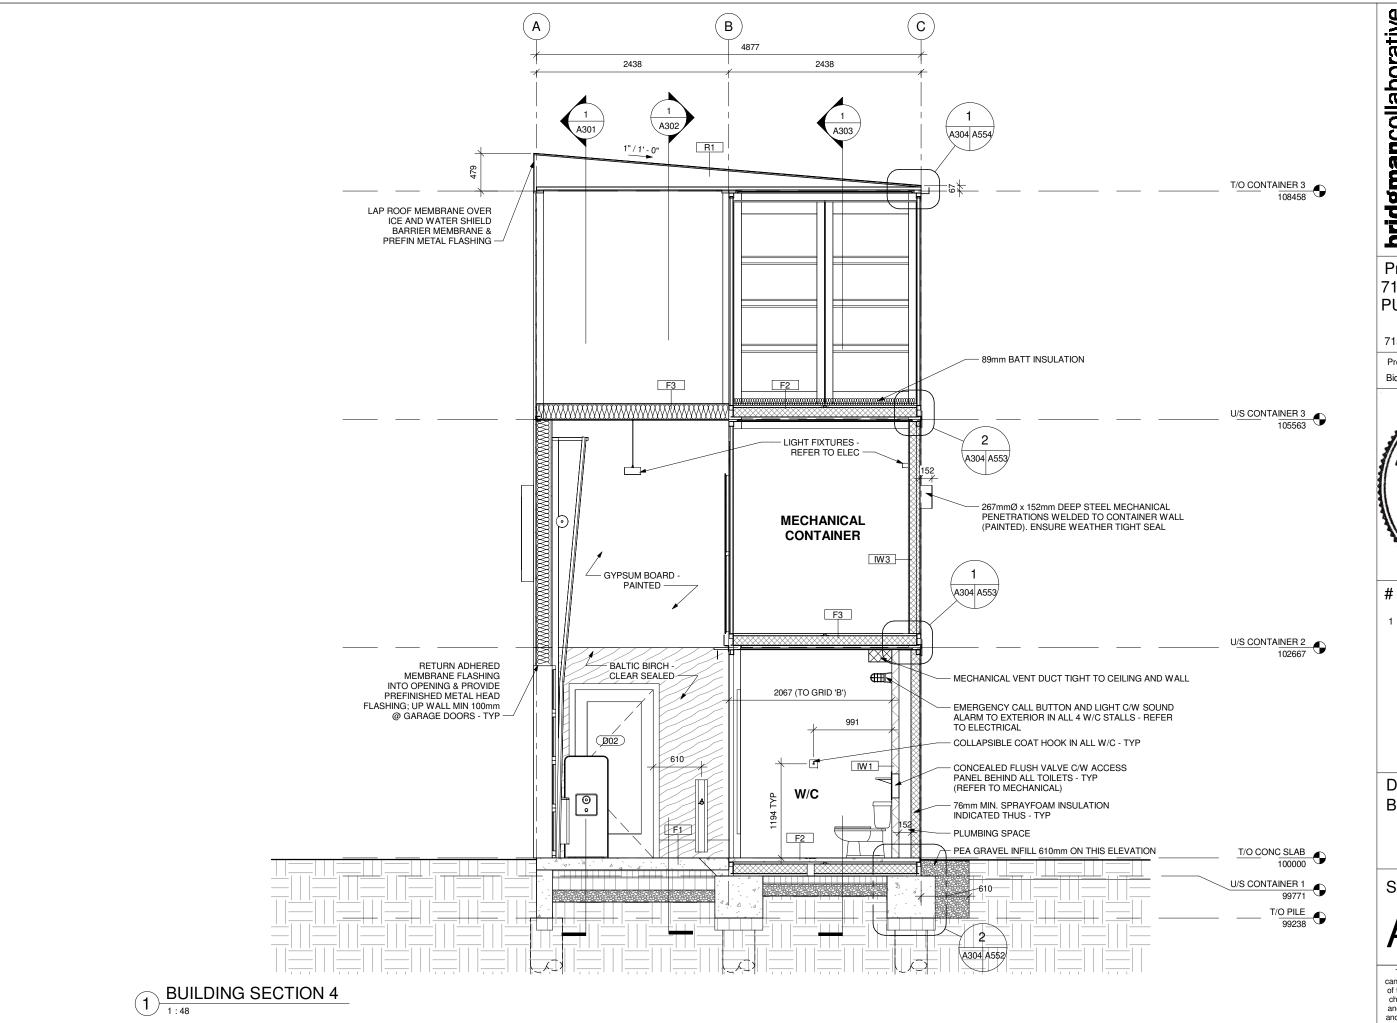












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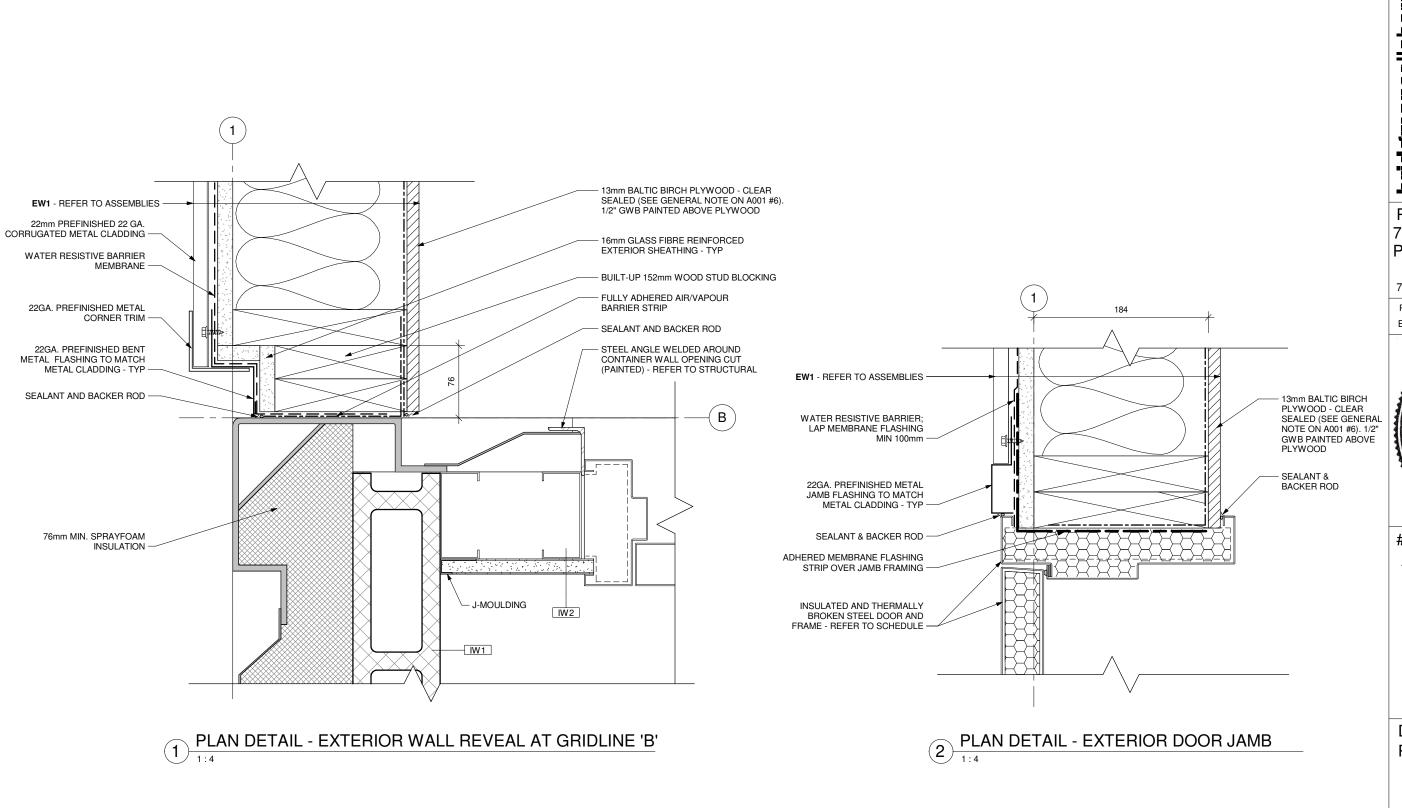
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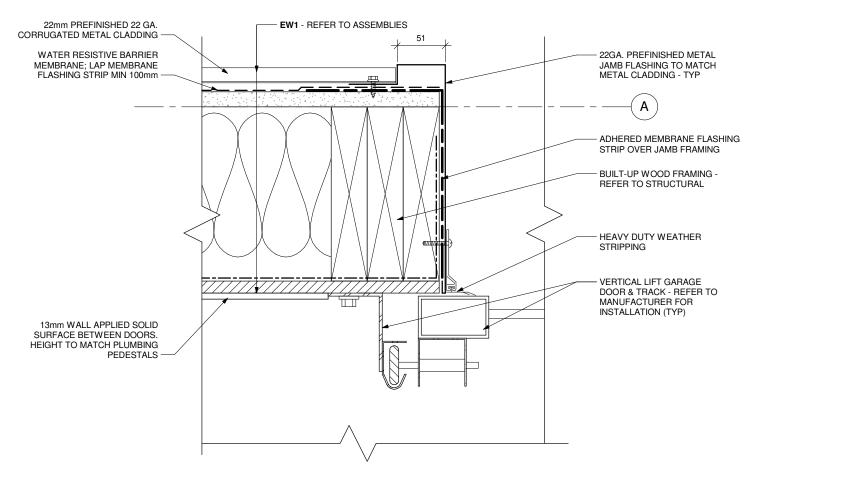
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Drawing Title: PLAN DETAILS

Sheet No:


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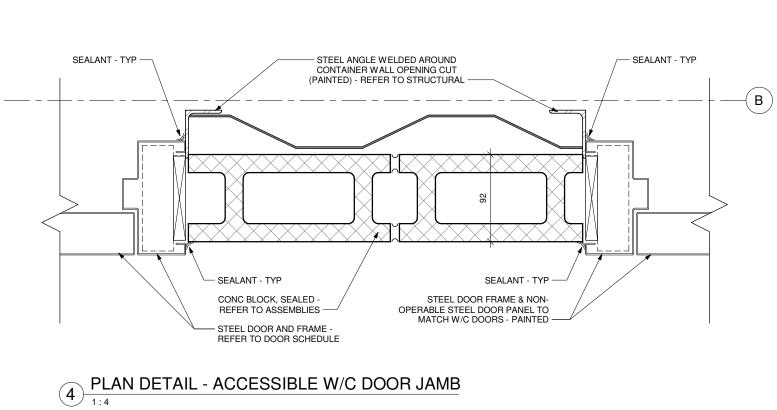


STEEL ANGLE WELDED AROUND CONTAINER WALL OPENING CUT (PAINTED) - REFER TO STRUCTURAL SEALANT - TYP -В STEEL DOOR AND FRAME - REFER TO DOOR SCHEDULE

2 PLAN DETAIL - OFFICE DOOR JAMB

PLAN DETAIL - GARAGE DOOR JAMB - TYPICAL



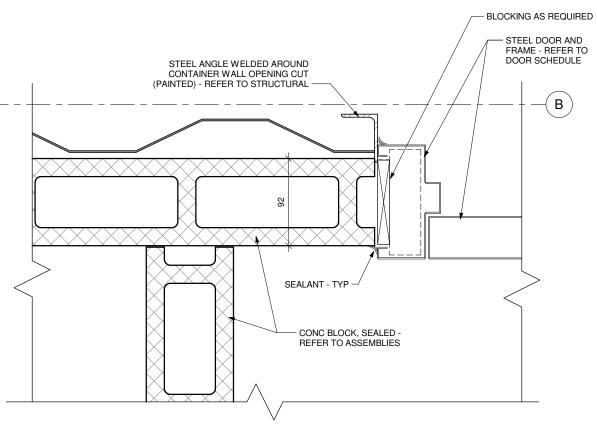

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PLAN DETAIL - W/C DOOR JAMB TYPICAL

### PROVIDE INDENT IN CONC SIDWALK AT INSIDE OF STEEL GUARD TO ENSURE SHIPPING CONTAINER DOORS ARE OPERABLE. COORDINATE W/ SLOPE AWAY FROM BUILDING (REFER TO CIVIL) 76mm MIN. SPRAYFOAM - URINAL 2 INSULATION ON CONC **BLOCK WALL** 152 507 76mm MIN. SPRAYFOAM INSULATION ON SHIPPING MAKE GOOD ANY DAMAGE TO EXISTING SIDEWALK CONTAINER WALL REMOVE SHIPPING CONTAINER PLYWOOD FLOOR BACK TO STEEL MEMBER AND INFILL FLOOR VOID WITH IW1 CONCRETE AS INDICATED IW1 REFER TO STRUCTURAL **EXPANSION** MATERIAL CONTAINER DOOR 51mm CONCRETE TOPPING - REFER TO (BEYOND) IW1 F2 -F2 STRUCTURAL T/O CONC SLAB 100000 T/O CONC SLAB 100000 **EXPANSION MATERIAL** CONTAINER CONCRETE SIDEWALK -PLYWOOD FLOOR REFER TO STRUCTURAL (SLOPE AWAY FROM SPRAYFOAM INSULATION IN CAVITY BETWEEN CONTAINER FLOOR BUILDING) STEEL MEMBERS U/S CONTAINER 1 U/S CONTAINER 1 99771 99771 10mil POLYETHELENE SHEET VAPOUR RETARDER **FULLY ADHERED FLEXIBLE** FLASHING OVER FOUNDATION WALL 102mm RIGID INSUL 2 COATS OF FULLY ADHERED FLEXIBLE. WATERPROOFING RUBBER FLASHING OVER MEMBRANE ON ALL EDGES FOUNDATION WALL OF SHIPPING CONTAINER COMPACTED (UNDER GRADE) AND DOWN **GRANULAR FILL** FOUNDATION AS INDICATED WATERPROOFING RUBBER CONCRETE BEAM MEMBRANE ON ALL EDGES FOUNDATION - REFER TO OF SHIPPING CONTAINER STRUCTURAL (UNDER GRADE) AND DOWN FOUNDATION AS INDICATED FOUNDATION - REFER TO STRUCTURAL T/O PILE T/O PILE 99238 99238 CONCRETE PILES CONCRETE PILES (BEYOND) - REFER TO (BEYOND) - REFER TO STRUCTÚRAL SECTION DETAIL - FOUNDATION AT EXISTING SIDEWALK SECTION DETAIL - FOUNDATION AT URINALS

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### Project: 715 MAIN STREET **PUBLIC TOILET**

715 Main Street, Winnipeg, MB

Project Number:

2022

Bid Opportunity Number: 54-2021




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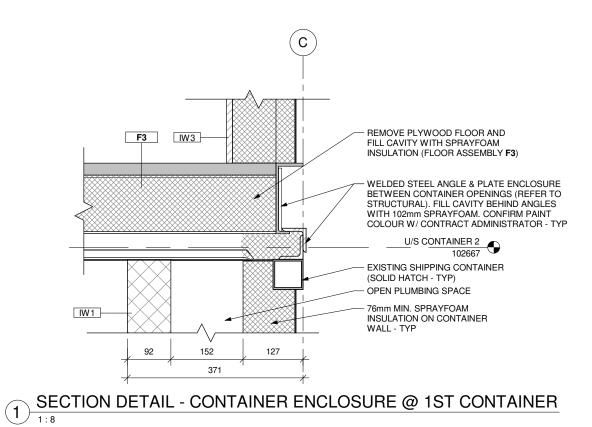
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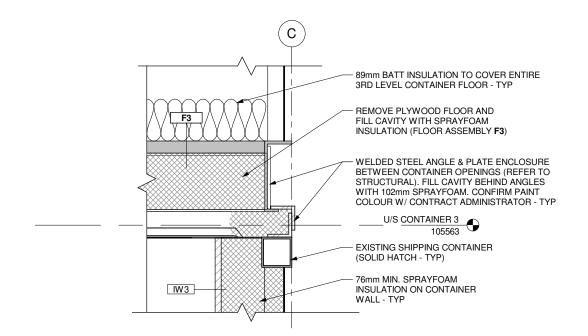
MAR. 3, 2021

Drawing Title: **SECTION DETAILS** 

Sheet No:





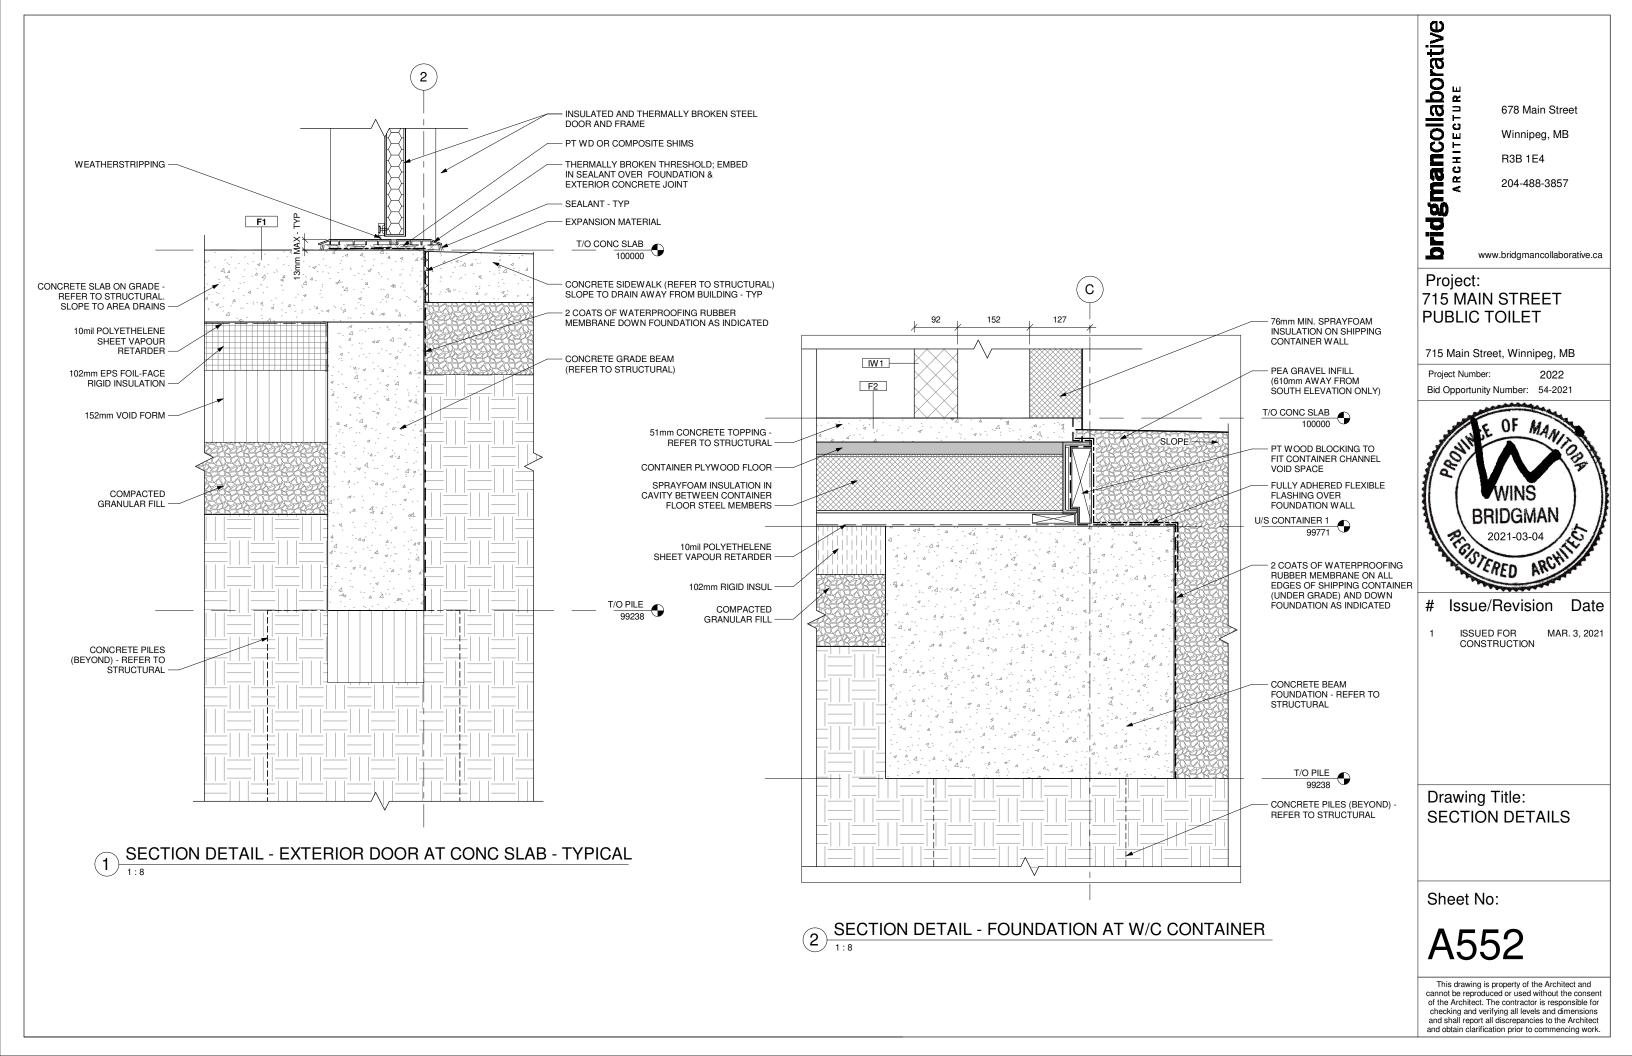

2 SECTION DETAIL - CONTAINER ENCLOSURE @ 2ND CONTAINER

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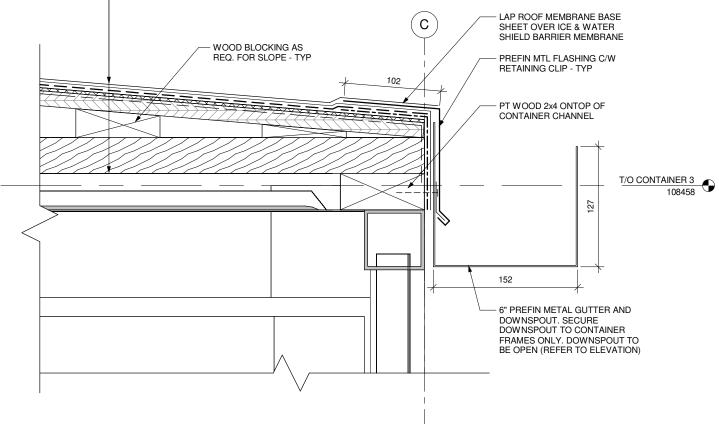
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**Drawing Title: SECTION DETAILS** 

Sheet No:

# POOF ASSEMBLY (R1) • 2-PLY MODIFIED BITUMEN ROOF MEMBRANE • ICE & WATER SHIELD TO COVER ENTIRE ROOF • 3mm PROTECTION COVER BOARD • FULLY ADHERED SBS MODIFIED BITUMEN AIR/VAPOUR BARRIERFULLY ADHERED AIR/VAPOUR BARRIER MEMBRANE • 16mm PLYWOOD SHEATHING • P.T. WOOD BLOCKING AS REQUIRED FOR SLOPE (REFER TO STRUCTURAL) • 89mm P.T. WOOD STUDS ON FLAT @ 406mm O.C. ACROSS TOP OF CONTAINERS



SECTION DETAIL - ROOF @ SOUTH ELEV GUTTER

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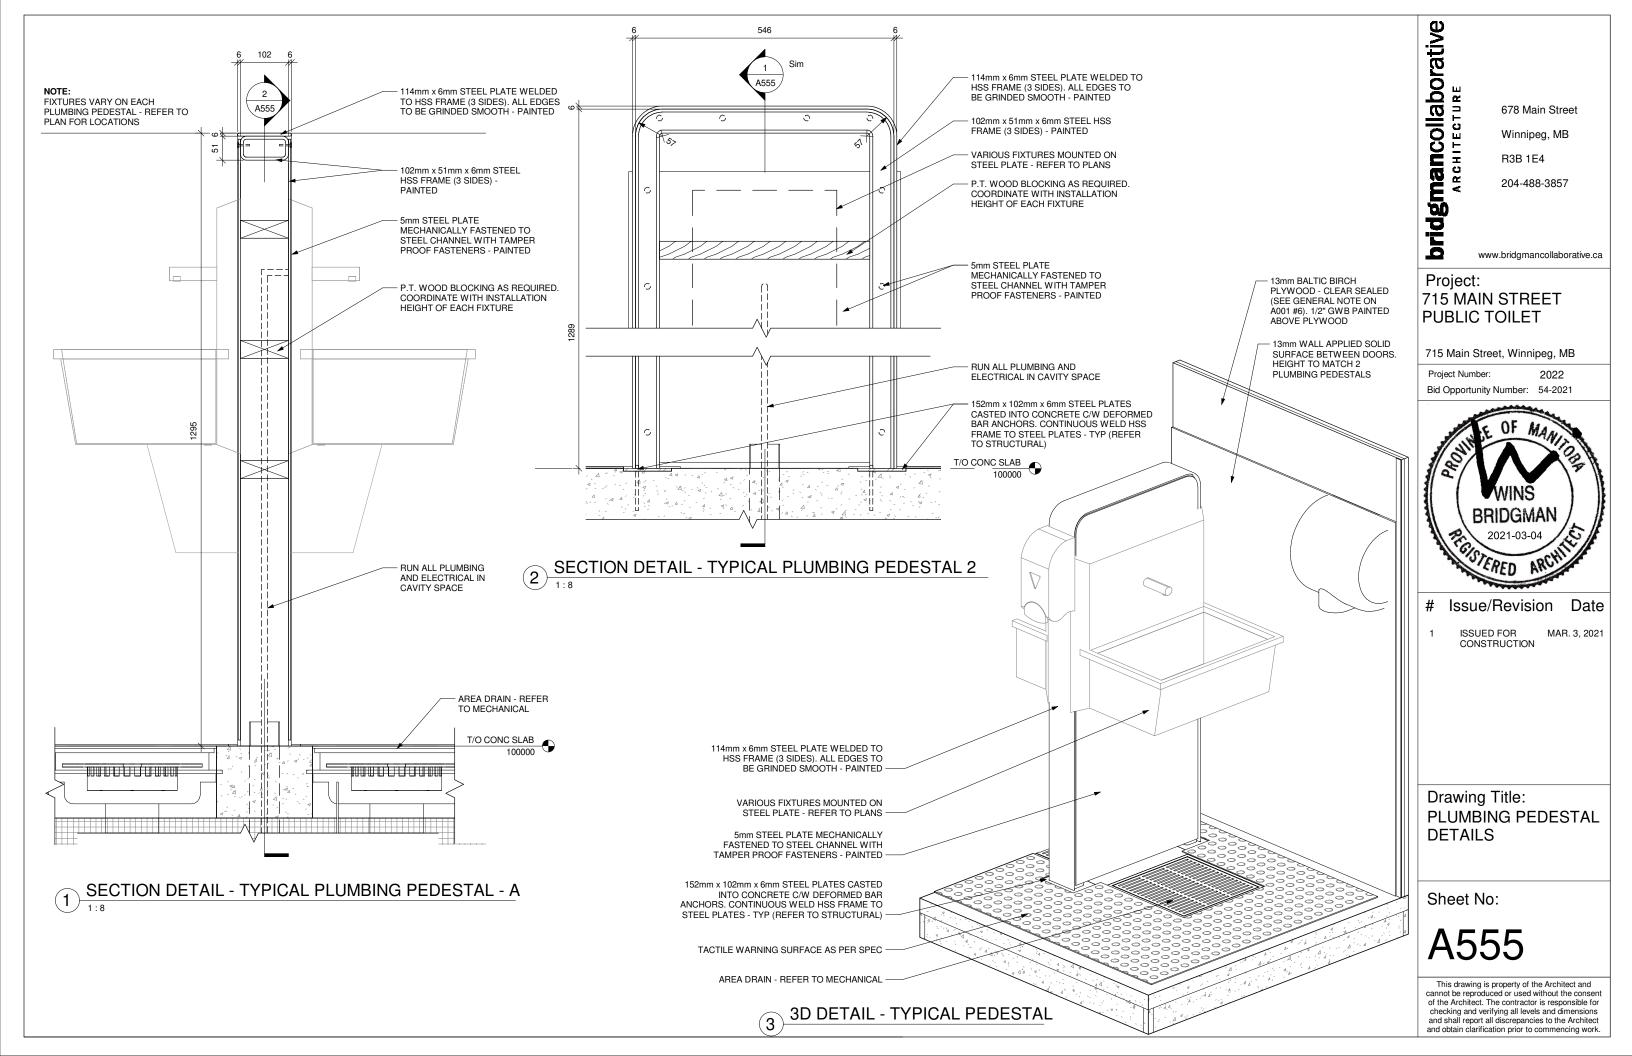
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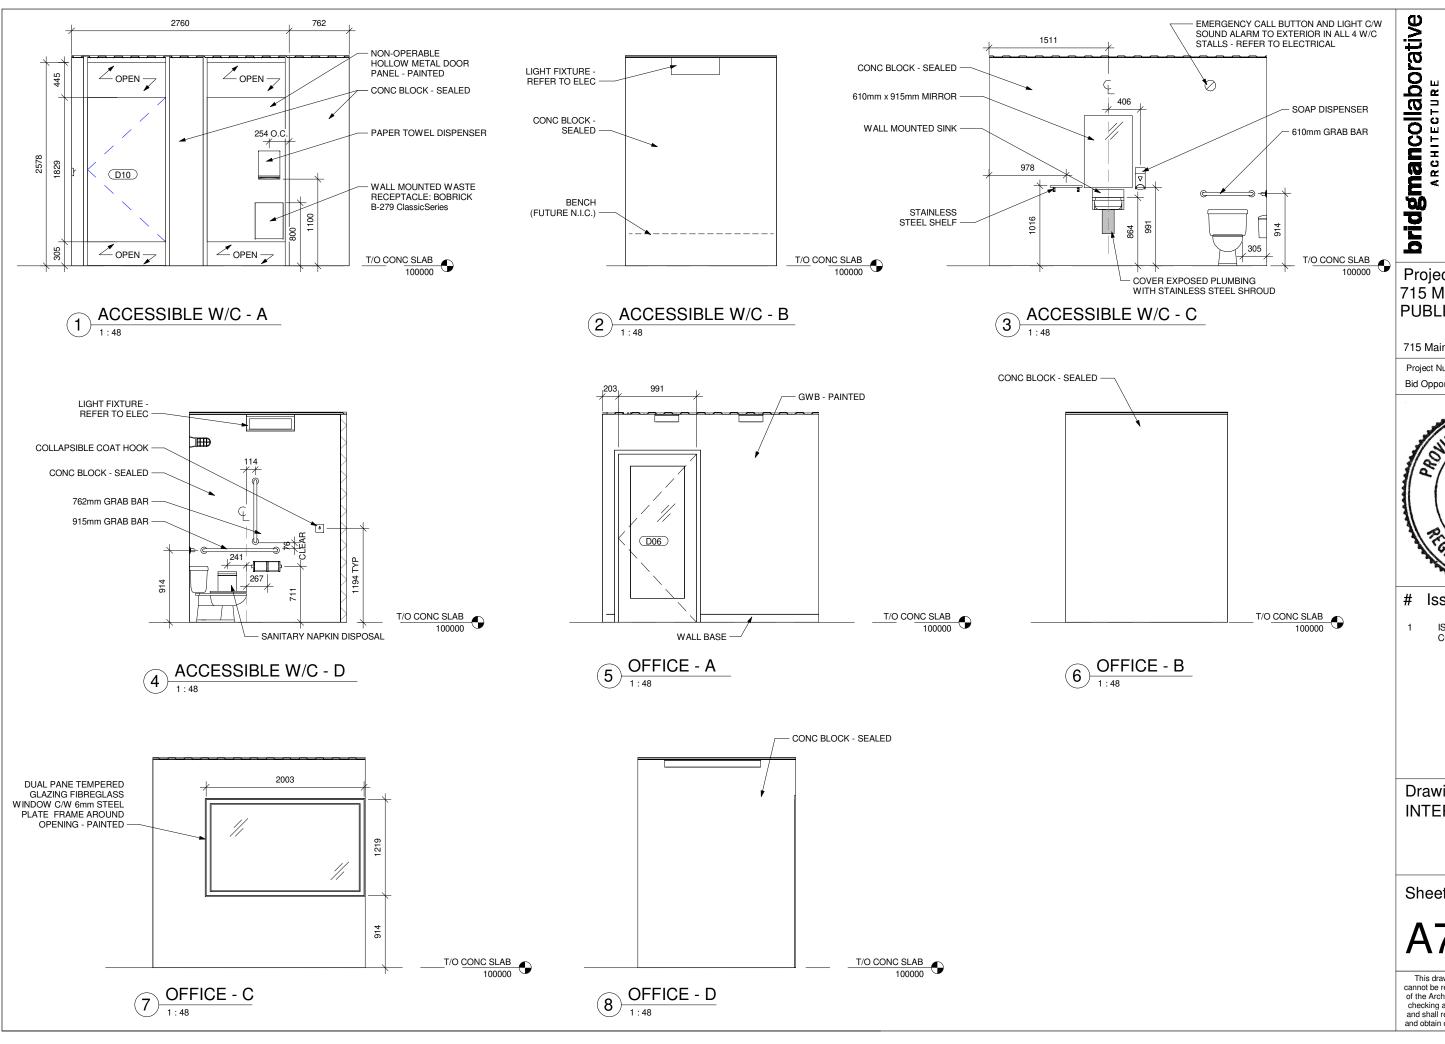
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Drawing Title: SECTION DETAILS

Sheet No:

A554





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### Project: 715 MAIN STREET **PUBLIC TOILET**

715 Main Street, Winnipeg, MB

Project Number:

2022 Bid Opportunity Number: 54-2021




Issue/Revision Date

ISSUED FOR MAR. 3, 2021 CONSTRUCTION

Drawing Title: INTERIOR ELEVATIONS

Sheet No:

								DOOF	R SCHE	DULE						
DOOR NUMBER	ROOM NAME	HARWARE SET	DOOR TYPE	WIDTH	HEIGHT	THICKNESS	DOOR MATERIAL	DOOR FINISH	DOOR FIRE RATING	INSULATED	FRAME TYPE	FRAME MATERIAL	FRAME FINISH	FRAME FIRE RATING	GLAZING TYPE	COMMENTS
D01	SINK AREA	1	DT1	991	2134	51	HOLLOW METAL	PAINTED	N/A	YES	FT1	HOLLOW METAL	PAINTED	N/A	DUAL, TEMPERED, LAMINATED	DOOR ACTUATOR
D02	SINK AREA	1	DT1	991	2134	51	HOLLOW METAL	PAINTED	N/A	YES	FT1	HOLLOW METAL	PAINTED	N/A	DUAL, TEMPERED, LAMINATED	DOOR ACTUATOR
D03	SINK AREA	MANUFAC	DT5	1829	2438	AS PER MFG	ALUMINUM	ANODIZED CLEAR ALUM	N/A	YES		ALUMINUM	ANODIZED CLEAR ALUM	N/A	SINGLE, TEMPERED	VERTICAL GARAGE DOOR
D04	SINK AREA	MANUFAC	DT5	2438	2438	AS PER MFG	ALUMINUM	ANODIZED CLEAR ALUM	N/A	YES		ALUMINUM	ANODIZED CLEAR ALUM	N/A	SINGLE, TEMPERED	VERTICAL GARAGE DOOR
D05	SINK AREA	MANUFAC	DT5	2438	2438	AS PER MFG	ALUMINUM	ANODIZED CLEAR ALUM	N/A	YES		ALUMINUM	ANODIZED CLEAR ALUM	N/A	SINGLE, TEMPERED	VERTICAL GARAGE DOOR
D06	OFFICE	3	DT2	991	2134	44	HOLLOW METAL	PAINTED	N/A	NO	FT1	HOLLOW METAL	PAINTED	N/A	SINGLE PANE TEMPERED, LAMINATE	
D07	STOR / JAN	3	DT3	991	2134	44	HOLLOW METAL	PAINTED	N/A	NO	FT1	HOLLOW METAL	PAINTED	N/A	N/A	
D08	W/C	4	DT4	813	1829	44	HOLLOW METAL	PAINTED	N/A	NO	FT2	HOLLOW METAL	PAINTED	N/A	N/A	BOTTOM OF DOOR @ 1'-0" AFF
D09	W/C	4	DT4	813	1829	44	HOLLOW METAL	PAINTED	N/A	NO	FT2	HOLLOW METAL	PAINTED	N/A	N/A	BOTTOM OF DOOR @ 1'-0" AFF
D10	ACCESS W/C	4	DT4	991	1829	44	HOLLOW METAL	PAINTED	N/A	NO	FT2	HOLLOW METAL	PAINTED	N/A	N/A	BOTTOM OF DOOR @ 1'-0" AFF

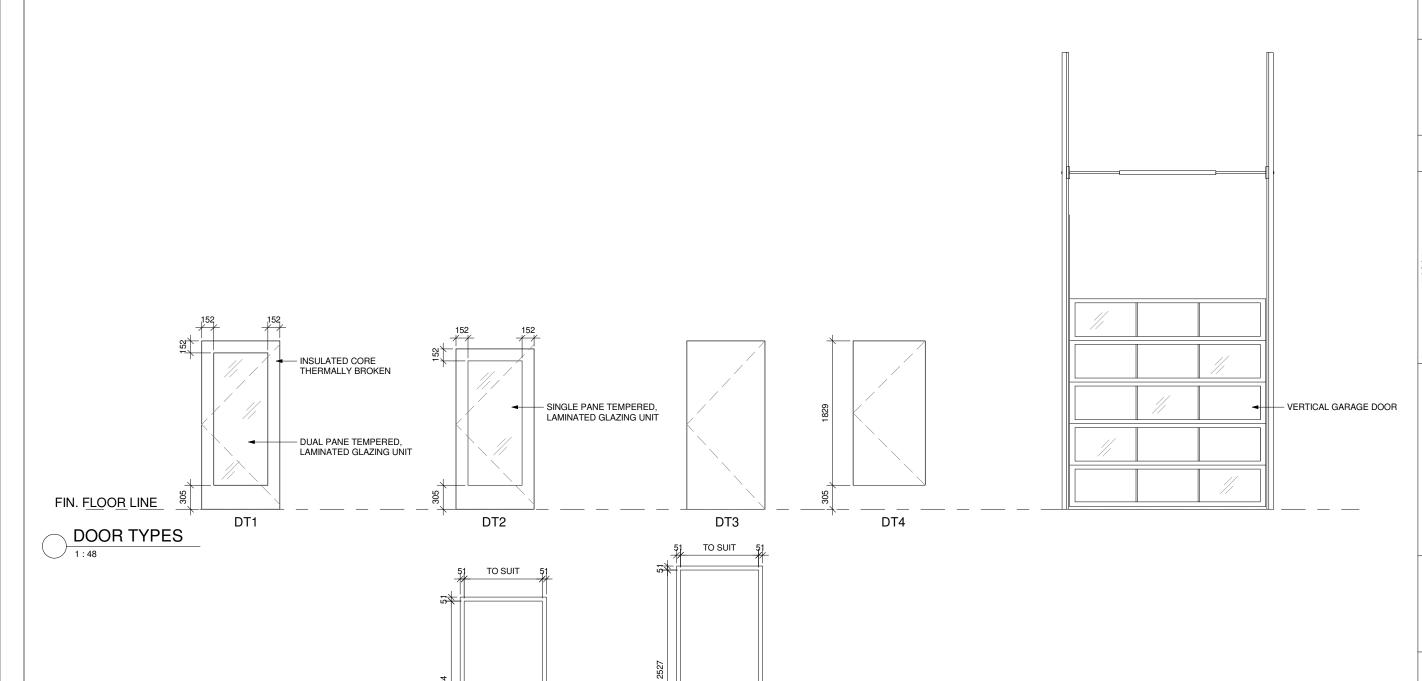

FT2

DOOR FRAME TYPES

FIN. FLOOR LINE

FT1

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715 Main Street, Winnipeg, MB

Project Number:

Bid Opportunity Number: 54-2021



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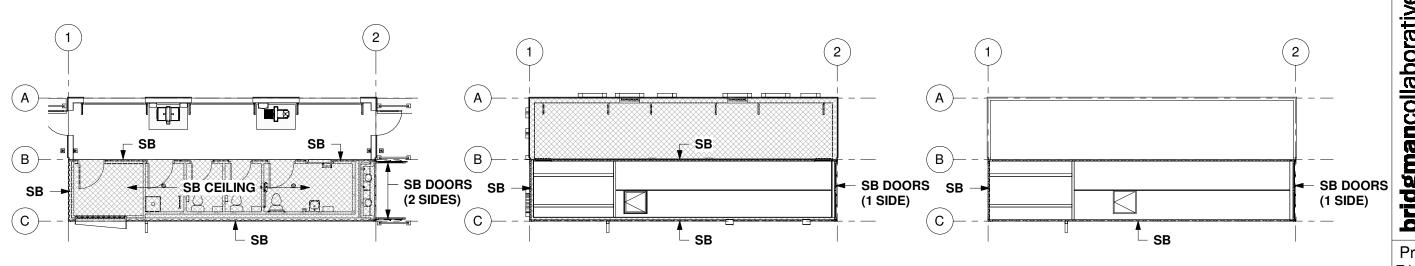
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Drawing Title:
DOOR SCHEDULE

Sheet No:

A901




SANDBLASTING PLAN - 1ST CONTAINER LEVEL

SANDBLASTING PLAN - 2ND CONTAINER LEVEL

SANDBLASTING PLAN - 3RD CONTAINER LEVEL

### **GENERAL NOTE:**

ALL SANDBLASTING TO BE DONE BY OTHERS - TYP

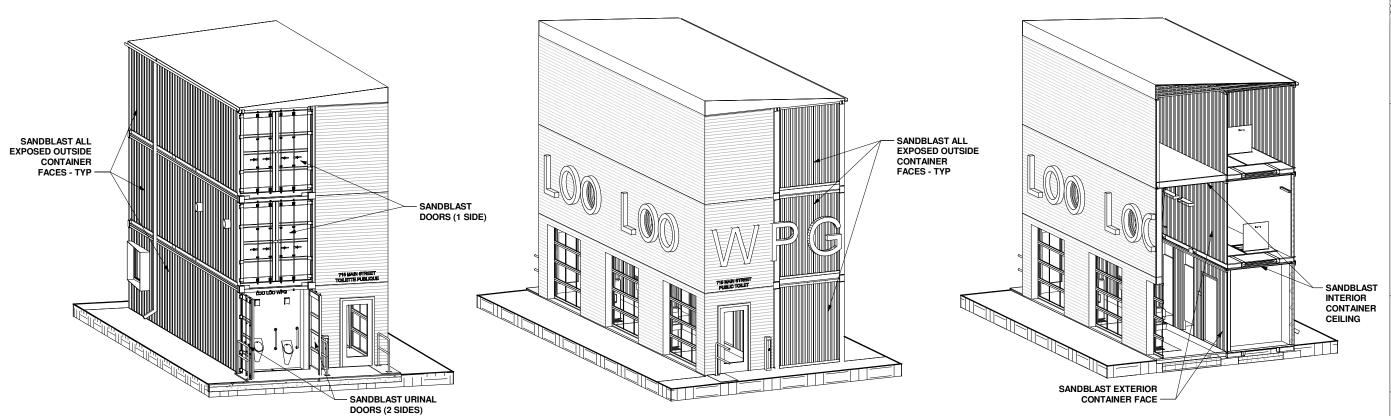

4 3D - CONTAINER SANDBLASTING EXTERIOR 1

(5) 3D - CONTAINER SANDBLASTING EXTERIOR 2

3D - CONTAINER SANDBLASTING INTERIOR

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Project Number:

2022 Bid Opportunity Number: 54-2021



Issue/Revision Date

MAR. 3, 2021

ISSUED FOR CONSTRUCTION

Drawing Title: SANDBLASTING **CONTAINERS (BY** OTHERS)

Sheet No:

### 1. CIVIC ADDRESS:

LOO LOO WINNIPEG 715 MAIN ST., WINNIPEG, MB

### 2. DRAWING INDEX:

E01.0 - TITLE SHEET

E01.1 - SITE PLAN

E02.1 - MAIN LEVEL - POWER LAYOUT

E02.2 - MAIN LEVEL - LIGHTING LAYOUT

E02.3 - MAIN LEVEL - LOW VOLTAGE SYSTEMS

E03.1 - SECOND LEVEL - POWER LAYOUT

E03.2 - SECOND LEVEL - LIGHTING LAYOUT

E06.0 - SINGLE LINE DIAGRAM & SCHEDULES

FOR 1 - INSTALLATION SPECIFICATIONS - PART

E08.2 - INSTALLATION SPECIFICATIONS - PART 2

### 3. WARNING:

THIS DRAWING MUST BE READ IN CONJUNCTION WITH THE LATEST ARCHITECTURAL, STRUCTURAL, CIVIL, MECHANICAL, AND LANDSCAPE DRAWINGS

BEFORE ROUGH-IN WIRING, REFER TO ARCHITECTURAL DRAWING FOR EXACT LAYOUT, DIMENSIONS AND **ELEVATIONS** 

ANY CHANGES TO DRAWINGS SHALL BE IN WRITING & AUTHORIZED BY THE CONTRACT ADMINISTRATOR.

ELECTRICAL CONTRACTOR TO SUPPLY & INSTALL ELECTRICAL EQUIPMENT NOTED ON PLANS FOR A WORKING SYSTEM UNLESS OTHERWISE NOTED.

DO NOT SCALE OFF DRAWINGS.

### 4. ELECTRICAL CONTRACTOR TENDER NOTES

### 4.1. EQUIPMENT:

- ALL WORK MUST SATISFY THE REQUIREMENTS OF THE CURRENT THE WINNIPEG ELECTRICAL 4.1.1. BYLAW, MANITOBA BUILDING CODE, AND ALL AUTHORITIES HAVING JURISDICTION.
- THE ELECTRICAL CONTRACTOR SHALL NOT UNDER ANY INSTANCE REDUCE THE STANDARD ESTABLISHED BY THE CONTRACT DOCUMENTS BY ANY OF THESE CODES OR REGULATIONS REFEREED TO IN (3).
- ANY PROPOSED RELOCATION(S) BY THE ELECTRICAL CONTRACTOR OF ELECTRICAL EQUIPMENT 4.1.3. AND OTHER EQUIPMENT THAT REQUIRES ELECTRICAL POWER/CONNECTIONS (FROM THAT SHOWN ON THE DRAWINGS) MUST BE APPROVED BY THE CONTRACT ADMINISTRATOR/CLIENT IN

### 4.2. DOCUMENTS:

- CONTRACTORS PRICING/TENDERING MUST OBTAIN A COMPLETE SET OF CURRENT DOCUMENTS 4.2.1. INCLUDING ARCHITECTURAL, MECHANICAL, PLUMBING, SPRINKLER, STRUCTURAL, SURVEY AND ALL OTHER DRAWINGS/SPECIFICATIONS FOR THIS PROJECT.
- CERTAIN INFORMATION REQUIRED TO PROPERLY PRICE WORK INDICATED ON THE ELECTRICAL DRAWINGS MAY BE FOUND IN OTHER CONSULTANTS DRAWINGS.

### 5. UTILITY:

POWER/TELERHONE/CABLEVISION INCOMING SERVICE (LOCATION OF EQUIPMENT/DUCT ROUTING) INFORMATION TO BE CONFIRMED. (INFORMATION SHOWN IS TO FACILITATE DISCUSSION WITH AUTHORITY ON PROPOSED SERVICE ENTRY PREFERRED LOCATION AND ARE FOR THAT PURPOSE ONLY).

### 6. <u>NOTES:</u>

### 6.1. UTILITIES:

- 6.1.1. ALL UNDERGROUND UTILITY SLEEVES/DUCTS ARE TO BE INSTALLED AS PER CEC 12-012, ELECTRICAL & COMMUNICATION UNDERGROUND INSTALLATION TO RUN IN JOINT TRENCH WHERE POSSIBLE TO THE BUILDING. BENDS MUST BE OF MINIMUM BEND RADIUS OF 36".
- ELECTRICAL CONTRACTOR MUST CO-ORDINATE ROUTING AND INSTALLATION OF ALL UNDERGROUND DUCTS WITH:
- 6.1.2.1. UTILITIES (HYDRO, TELEPHONE, GAS, CABLE) REGARDING EXACT ROUTING, DEPTH OF BURIAL AND OTHER REQUIREMENTS.
- 6.1.2.2. MECHANICAL AND GENERAL CONTRACTOR REGARDING INTERFERENCE WITH STORM SEWER, SANITARY SEWER, GAS LINES, CATCHBASINS, AND SIMILAR UNDERGROUND SITE/CITY SERVICES.
- SEAL THE DUCTS FROM UTILITY SIDE TO PREVENT WATER ACCUMULATION IN DUCTS. IF THAT CANNOT BE ENSURED, PROVIDE SERVICE DUCTS WITH A DRAIN CONNECTION BEFORE ENTRY TO THE BUILDING. THIS DRAIN IS INTENDED FOR RELIEF OF INCIDENTAL WATER ENTERING THE DUCT. THE DRAIN MUST NOT BE USED TO HANDLE ANY FORM OF AREA DRAINAGE.
- ALL SERVICE DUCTS MUST BE SEALED AT POINT OF ENTRY INTO BUILDING THROUGH WALLS. THE SEAL SHALL PREVENT WATER ENTRY INTO THE BUILDING THROUGH THE WALL PENETRATION AND IN ADDITION, THE INSIDE OF THE DUCTS (WHERE POSSIBLE) MUST ALSO BE SEALED AGAINST WATER ENTRY. ENSURE WATERPROOF MATERIAL DOES NOT OBSTRUCT DUCT DRAIN WHEN PROVIDED.
- WHEN INSTALLED OUTDOORS, ARC PRODUCING ELECTRICAL EQUIPMENT/POWER METER SHALL NOT BE INSTALLED WITHIN 1 METER OF THE COMBUSTIBLE GAS METER. GAS RELIEF DEVICE OR VENT.
- CO-ORDINATE WITH THE GENERAL CONTRACTOR, HYDRO, ELECTRICAL INSPECTOR AND WITH ALL AUTHORITIES HAVING THE JURISDICTION FOR THE FOLLOWING:
- 6.1.6.1. MECHANICAL PROTECTION (STEEL PROTECTION) POSTS AND REQUIREMENTS OF POSTS PER LITILITY AND CODE

### 6.1.6.2. MECHANICAL PROTECTION POSTS TO BE PROVIDED (SUPPLY/INSTALLATION) BY THE GENERAL CONTRACTOR.

6.1.6.3. PROTECTION OF EXISTING TREES/SHRUBS: ELECTRICAL CONTRACTOR MUST CO-ORDINATE ROUTING OF ALL UNDERGROUND DUCTS AND ALL UNDERGROUND WIRING WITH ARCHITECT SITE-SUPERVISOR AND LANDSCAPE ARCHITECT TO PROTECT AND MAINTAIN EXISTING TREES AND SHRUBS AS INDICATED ON LANDSCAPE AND ARCHITECTURAL DRAWINGS.

### 6.2. OUTDOOR LIGHTS:

- THE OUTDOOR LIGHTS (LANDSCAPE, BUILDING PERIMETER, ROADWAY, ETC.) SHALL BE CONTROLLED BY PHOTOCELL AND TIME CLOCK, VIA CONTACTOR(S).
- REFER TO DRAWINGS FOR LIGHTING LAYOUT AND LUMINAIRE SCHEDULE.
- 6.2. CAUTION: ALL OTHER SUBCONSULTANTS/TRADES ELECTRICAL ROOM:
- NO LAVATORIES, BATH TUBS, ETC. ON FLOOR AREA ABOVE THE ELECTRICAL ROOM.
- IF EQUIPMENT ABOVE HAVE TO BE LOCATED ABOVE TO ELECTRICAL ROOM DUE TO FLOOR AREA LIMITATION, PROVIDE ADEQUATE PROTECTION TO ELECTRICAL EQUIPMENT TO PREVENT LEAKED WATER, CONDENSATION WATER, AND ANY OTHER FORM OF WATER FROM ACCIDENTAL AND SUDDEN DISCHARGE ON ELECTRICAL REQUIREMENT.

	ABBREVIATIONS
FFL	FINISH FLOOR LEVEL
AFF	ABOVE FINISH FLOOR
FGL	FINISH GRADE LEVEL
MOUNTING HEIGHTS	TO UNDERSIDE OF THE ROUGH—IN OF THE SAID INSTALLATION
NL	NIGHT LIGHT
FF	FORCE FLOW UNIT
U/G	UNDER GROUND
WP	WEATHER PROOF

VERIFY SHEET SIZE. BAR TO THE RIGHT IS 1" IF THIS IS A FULL SIZE DRAWING.

	LEGEND
P)	DOOR ASSISTS ACTIVATOR PUSH BUTTON
NL	NIGHT LIGHT
\$3	SINGLE POLE SWITCH (3 DENOTE 3 WAY SWITCH, D DENOTE DIMMER, OS DENOTE OCCUPANCY SENSOR)
Ф	DUPLEX RECEPTACLE—C DENOTES UNDER COUNTER, M DENOTES MICROWAVE DESIGNATED, F DENOTES FLOOR, IPLC DENOTES IPLC BLOCK HEATER CONTROLLER, GFI GROUND FAULT CIRCUIT INTERRUPTER, C CEILING MOUNTED, M FOR MICROWAVE, ARC FOR ARC FAULT, S SURFACE MOUNTED
0	208/240V RECEPTACLE - CONFIGURATION BY AMPERAGE
<del>**</del>	QUAD RECEPTACLE
0	JUNCTION BOX — CEILING/WALL

STROBE /HORN LINIT \_ FIRE ALARM

	SYSTEM (1 DENOTE TYPE, C DENOTE CEILING MOUNTED)
×	STROBE UNIT (1 DENOTE TYPE, C DENOTE CEILING MOUNTED)
F	PULL STATION - FIRE ALARM SYSTEM
R	RELAY MODULE - FIRE ALARM SYSTEM
M	MONITOR MODULE - FIRE ALARM SYSTEM
<b>©</b>	CARBON MONOXIDE DETECTOR — FIRE ALARM SYSTEM
<b>®</b>	SMOKE DETECTOR
DSD	SMOKE DETECTOR — DUCT MOUNTED
Θ	HEAT DETECTOR — (D DENOTES DUCT MOUNTED, MP DENOTES MOISTURE PROOF)
(9)	CARBON MONOXIDE ALARM — CONNECTED TO 120V NON-SWITCHED CIRCUIT C/W BATTERY BACKUP
	HORN UNIT — FIRE ALARM SYSTEM (1 DENOTE TYPE, C DENOTE CEILING MOUNTED)

$\blacksquare$	VOICE / DATA OUTLET
>	TV/CABLE OUTLET
	POWER PANELBOARD — FLUSH MOUNT/SURFACE MOUNT
<b>₩</b>	COMMUNICATION BOARD
8	HARDWIRED CONNECTION
O	MOTOR CONNECTION
	DISCONNECT SWITCH-NUMBER OF POLES PER CIRCUIT DESIGNATION
	1

	BATTERY PACK C/W EMERGENCY LIGHTS
<u> </u>	EMERGENCY LIGHTS - DUAL HEADS
	EMERGENCY LIGHT AND EXIT COMBO - ARROWS AS REQUIRED
$\bigotimes$	EMERGENCY EXIT SIGN

FA	FIRE ALARM PANEL
ANN	FIRE ALARM ANNUNCIATION PANEL

# FMT ROUTING & GENERAL INSTALLATION REQUIREMENTS

- ELECTRICAL CONTRACTOR TO SUPPLY & INSTALL EMT CONDUITS ALL EMT & ELECTRICAL INSTALLATIONS FROM OFFICE & SECOND LEVEL AREAS DESTINED TO SINK AREA TO BE ROUTED THROUGH THIRD LEVEL CONTAINER/WOOD. NO HORIZONTAL EMT CONDUITS ALLOWED TO BE ROUTED IN CEILING OF SINK AREA
- ELECTRICAL CONTRACTOR TO ARRANGE & CARRY ALL COSTS INVOLVED TO DRILL, WELD, RECTIFY, REPAIR, SUPPORT, SECURE, & PAINT TO ARCHITECTURAL SPECIFICATIONS' CONDITION OF FINISH ALL PENETRATIONS REQUIRED FOR EMT CONDUITS. ROUGH EDGES EDGES SHALL BE SMOOTHED, DEBURRD, & SEALED WITH PRINTABLE SEALANT AS REQUIRED BY ARCHITECTURAL SPECIFICATIONS.
- USE STAINLESS STEEL OR GALVANIZED FASTENERS TO SECURE EMT CONDUIT'S SUPPORTS & ELECTRICAL ITEMS, & PARTS TO CONTAINERS' STEEL SURFACES. USE SELF-TAPPING SCREWS FOR ITEMS ABOVE 7', USE BOLT & STAINLESS STEEL NUTS WITH NYLON INSERTS COMBINATIONS FOR ITEMS BELOW 7'. SELF-TAPPING SCREWS SHALL NOT PROTRUDE MORE THAN 1" BEYOND EXTERIOR OF CONTAINER'S WALLS. TORQUE PER CODE.

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CLIENT: BRIDGMAN COLLABORATIVE ARCHITECTURE 678 MAIN STREET WINNIPEG, MB R3B 1E4 (204)488 - 3857

PROJECT TITLE:

LOO LOO WINNIPEG 715 MAIN ST., WINNIPEG, MB BID OPPORTUNITY 54-2021

SHEET TITLE: TITLE SHEET


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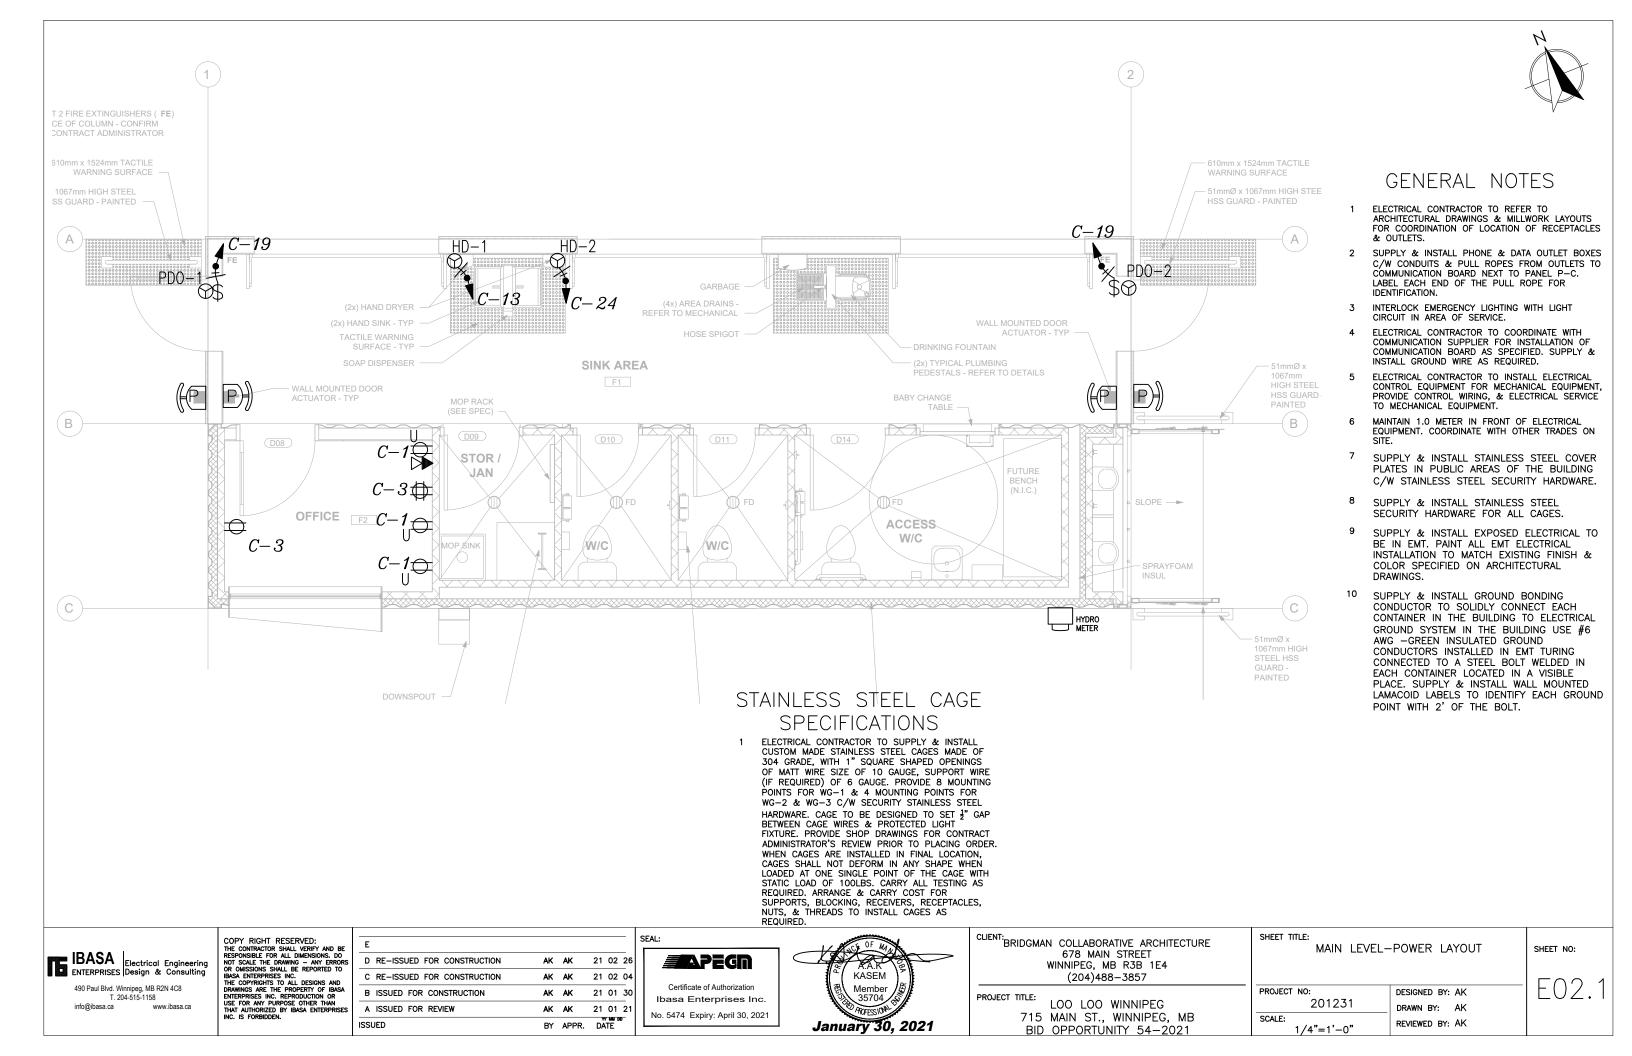
NTS


SCALE:

SHFFT NO:

DESIGNED BY: AK 201231 DRAWN BY: AK REVIEWED BY: AK



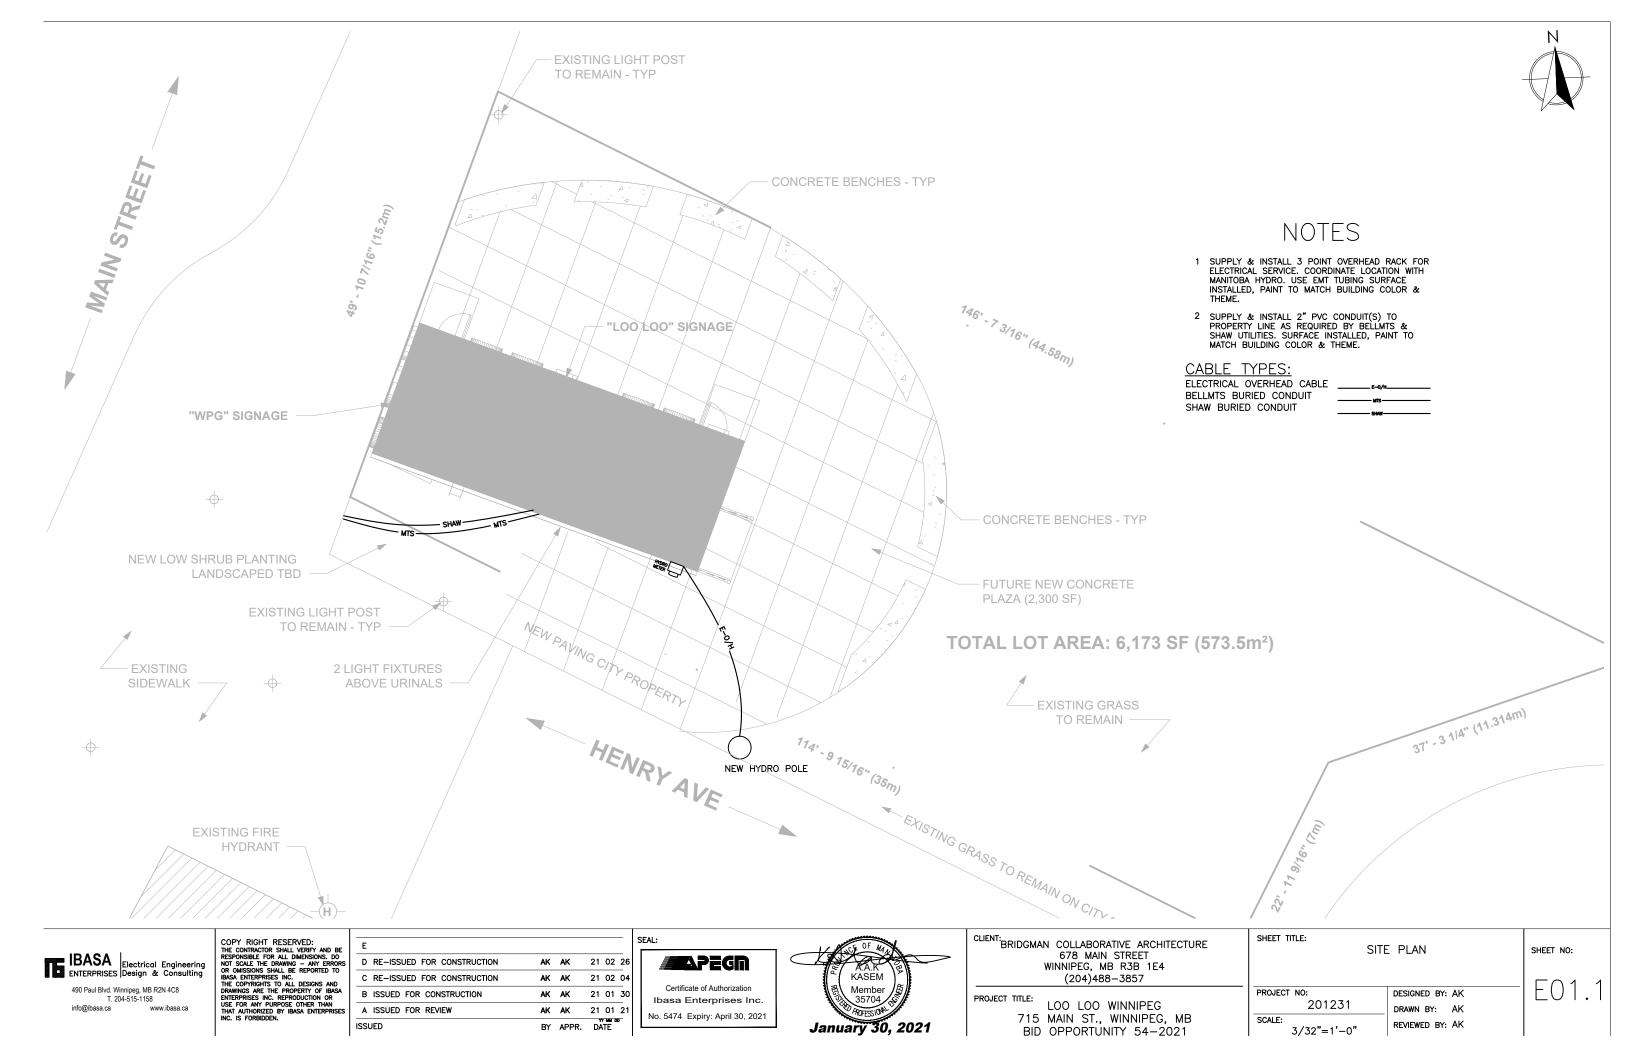

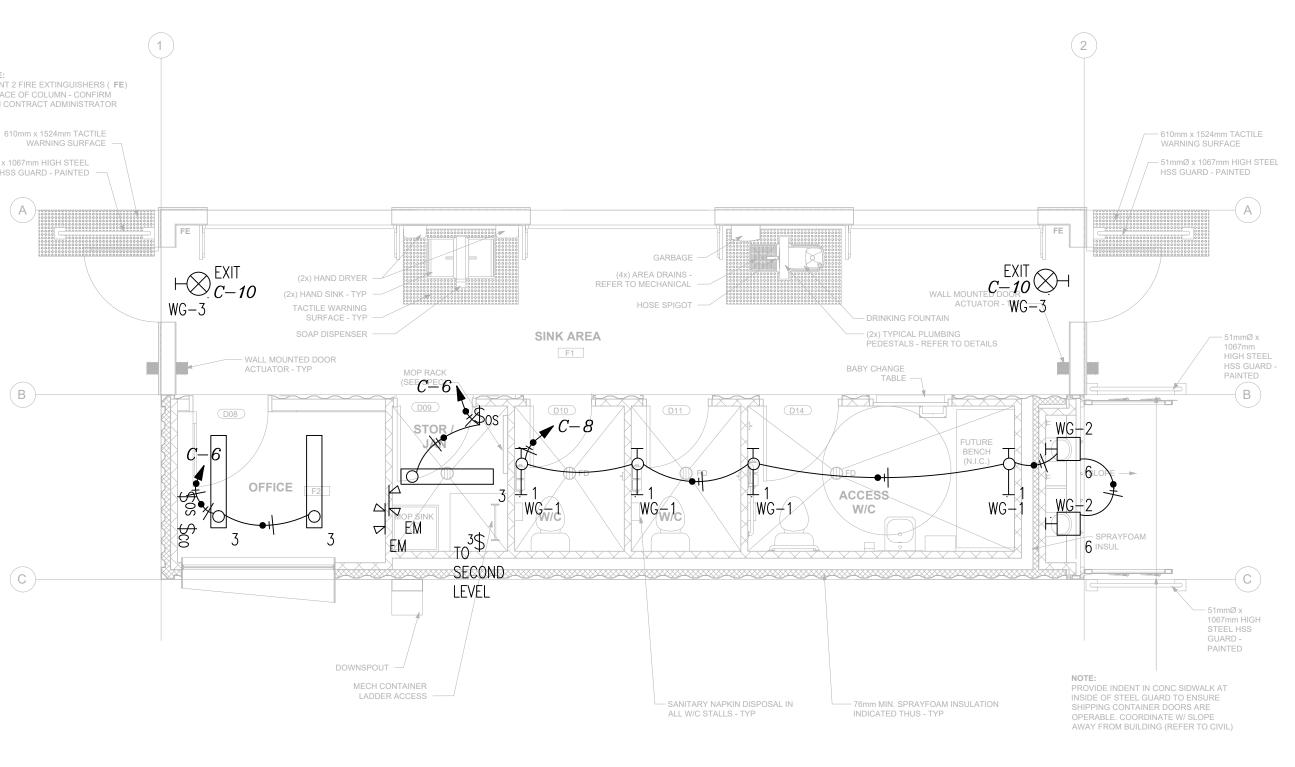



- ELECTRICAL CONTRACTOR TO REFER TO ARCHITECTURAL DRAWINGS FOR INSTALL LOCATIONS OF LIGHT FIXTURES.
- INTERLOCK EMERGENCY LIGHTING WITH LIGHT CIRCUIT IN AREA OF SERVICE.
- SUPPLY & INSTALL 3/4" THICKNESS BACKING FOR POT LIGHT TO EXTEND AT LEAST A MINIMUM OF 12" IN ALL DIRECTIONS. BACKING TO BE PLYWOOD, HARDIBOARD OR EQUIVALENT MATERIAL.
- SUPPLY & INSTALL STAINLESS STEEL SECURITY HARDWARE FOR ALL LIGHT FIXTURES & CAGES WITHIN 10' OF FFL OR FGL.
- SUPPLY & INSTALL EXPOSED ELECTRICAL TO BE IN EMT. PAINT ALL EMT ELECTRICAL INSTALLATION TO MATCH EXISTING FINISH & COLOR SPECIFIED ON ARCHITECTURAL DRAWINGS.

CALLOUT	SYMBOL	NOTE 1
CO Switch	\$ <sub>∞</sub>	LEVITON, PART#VPOSR-10 FOR WIRING TO PART# VPT24-1PZ. FULL' PROGRAM & SETUP.
0S	\$ <sub>05</sub>	LEVITON, PART#OSSMIT-MOW, ADJUST BLINDS TO PREVENT EXTENDED ACTIVATION
TIME-LOCK Switch	* os *	

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SEAL: **M**PEGN Certificate of Authorization Ibasa Enterprises Inc.

No. 5474 Expiry: April 30, 2021




CLIENT: BRIDGMAN COLLABORATIVE ARCHITECTURE 678 MAIN STREET WINNIPEG, MB R3B 1E4 (204)488 - 3857


> LOO LOO WINNIPEG 715 MAIN ST., WINNIPEG, MB BID OPPORTUNITY 54-2021

MAIN LEVEL-LIGHTING LAYOUT

SHEET NO:

PROJECT NO: DESIGNED BY: AK 201231 DRAWN BY: AK SCALE: REVIEWED BY: AK 1/4"=1'-0"

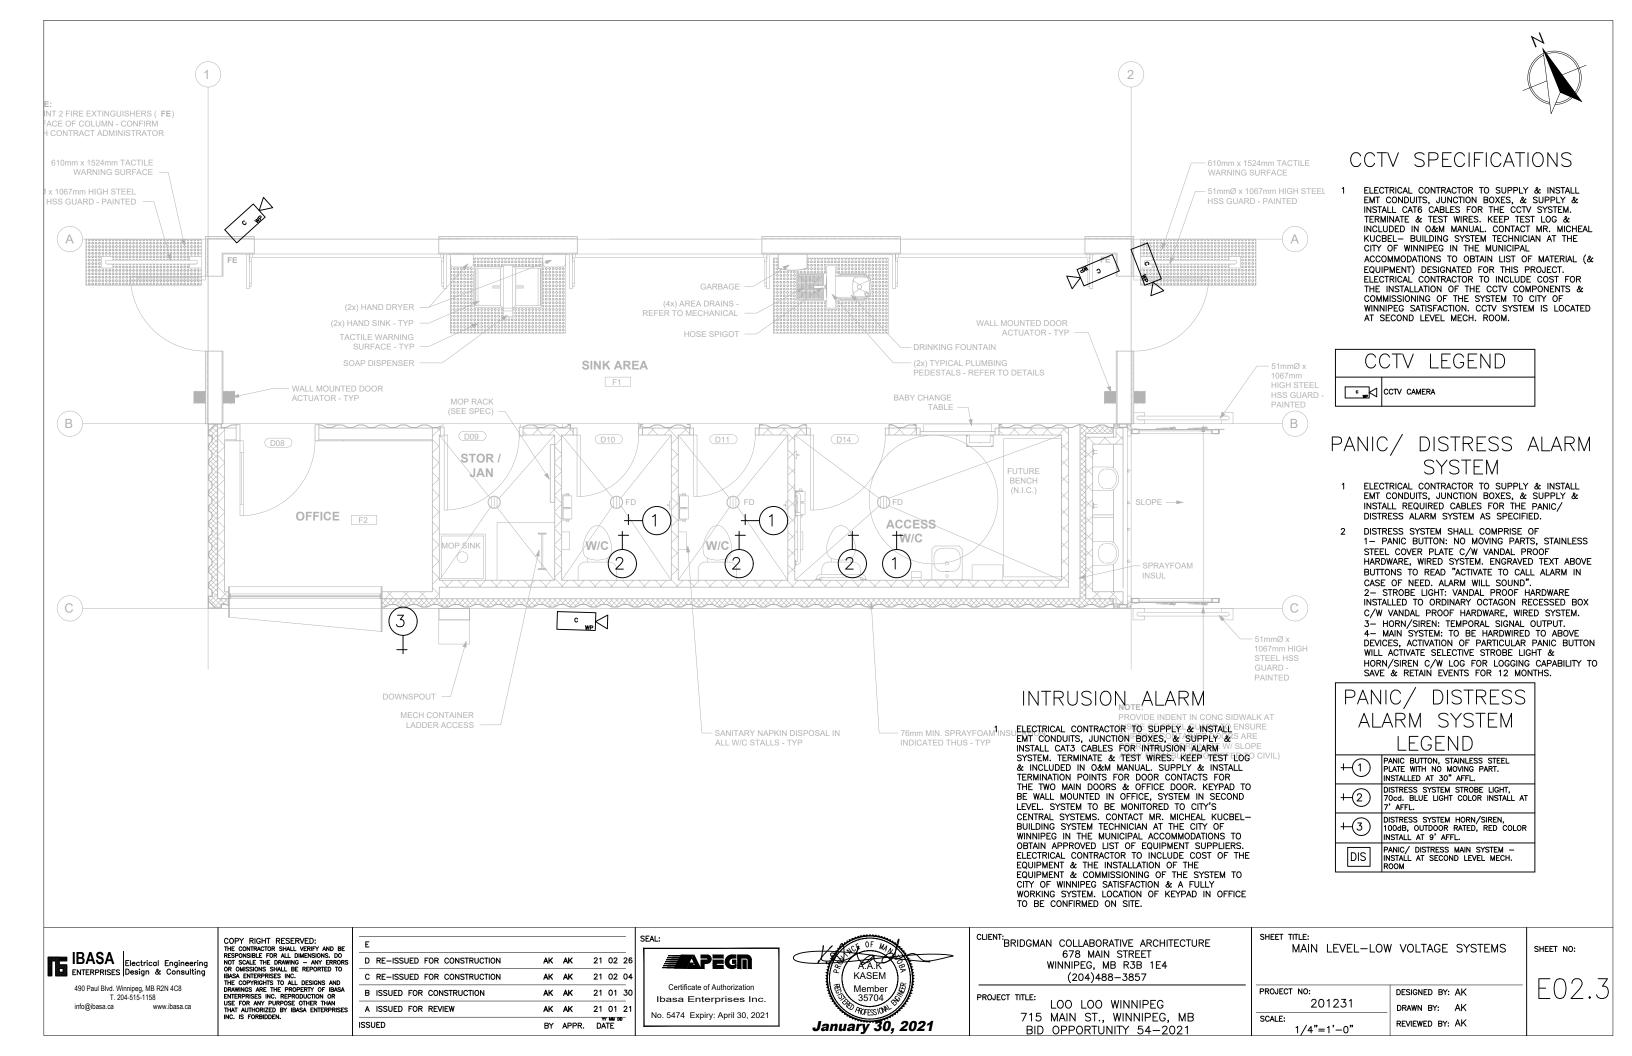

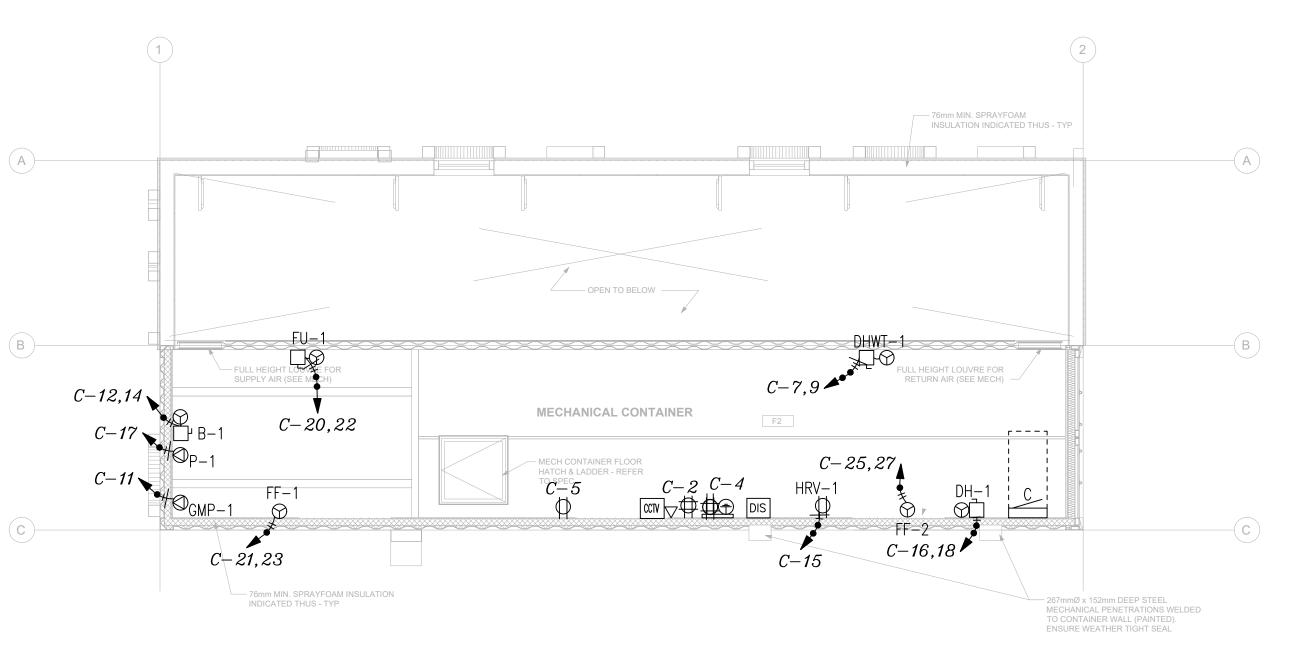



GENERAL NOTES

- ELECTRICAL CONTRACTOR TO REFER TO ARCHITECTURAL DRAWINGS & MILLWORK LAYOUTS FOR COORDINATION OF LOCATION OF RECEPTACLES & OUTLETS.
- SUPPLY & INSTALL PHONE & DATA OUTLET BOXES C/W CONDUITS & PULL ROPES FROM OUTLETS TO EXISTING COMMUNICATION BOARD IN THE BUILDING. LABEL EACH END OF THE PULL ROPE FOR IDENTIFICATION.
- INTERLOCK EMERGENCY LIGHTING WITH LIGHT CIRCUIT IN AREA OF SERVICE.
- ELECTRICAL CONTRACTOR TO INSTALL ELECTRICAL CONTROL EQUIPMENT FOR MECHANICAL EQUIPMENT, PROVIDE CONTROL WIRING, & ELECTRICAL SERVICE TO MECHANICAL EQUIPMENT.
- COORDINATE WITH OTHER TRADES ON SITE FOR INSTALLATION OF LIGHT FIXTURES IN THE SPACE.
- SUPPLY & INSTALL EXPOSED ELECTRICAL TO BE IN EMT.
- SUPPLY & INSTALL ALL EMT TUBING DESTINED FROM MECHANICAL AREA/ROOM AT SECOND LEVEL TO SINK AREA LIGHTS & ALL OTHER WALL MOUNTED SYSTEMS IN THE SINK AREA, INCLUDING BUT NOT LIMITED TO CCTV, POWER FOR DOOR OPERATORS TO BE ROUTED THROUGH THIRD LEVEL CONTAINERS WITH MINIMUM OCCUPANCY OF SINK ROOM CEILING.

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E					
D RE-ISSUED FOR CONSTRUCTION	AK	AK	21	02	26
C RE-ISSUED FOR CONSTRUCTION	AK	AK	21	02	04
B ISSUED FOR CONSTRUCTION	AK	AK	21	01	30
A ISSUED FOR REVIEW	AK	AK	21	01	21
ISSUED	BY	APPR.	DA	TE	0



CLIENT: BRIDGMAN COLLABORATIVE ARCHITECTURE
678 MAIN STREET
WINNIPEG, MB R3B 1E4
(204)488-3857

PROJECT TITLE: LOO LOO WINNIPEG BID OPPORTUNITY 54-2021


SHEET	TITLE:		
	SECOND	LEVEL-POWER	LAYOUT

SCALE:

SHEET NO:

715 MAIN ST., WINNIPEG, MB

PROJECT NO: DESIGNED BY: AK 201231 DRAWN BY: AK REVIEWED BY: AK 1/4"=1'-0"

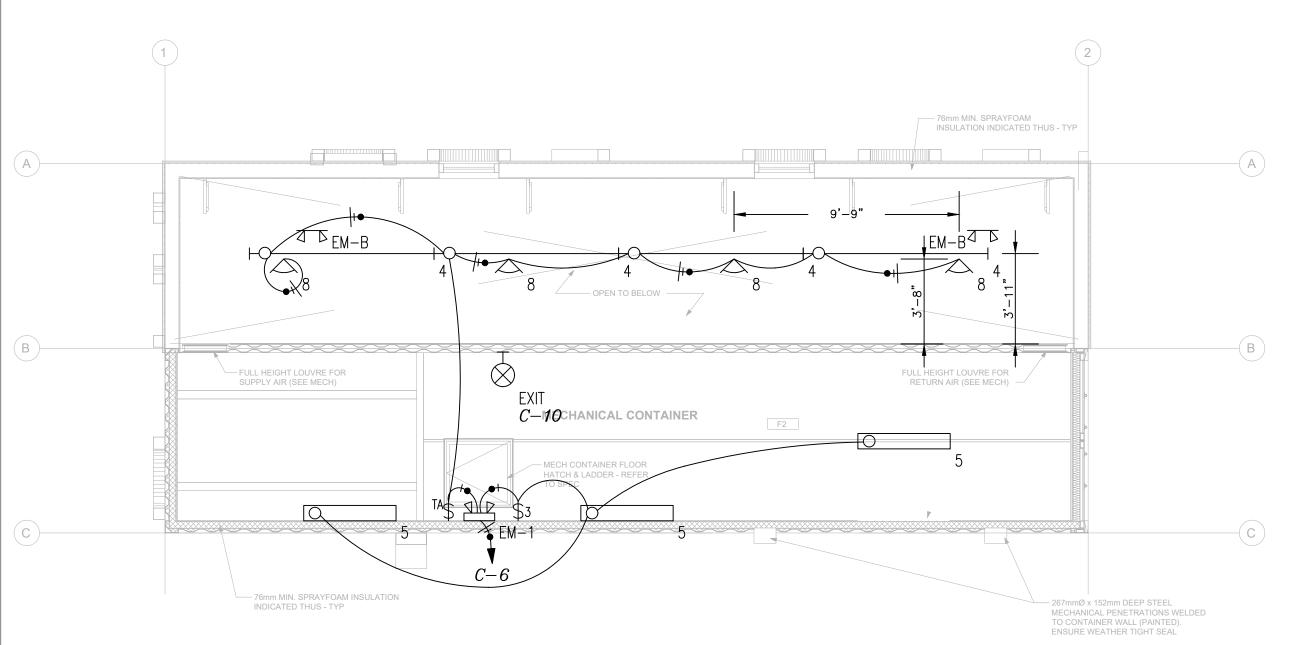



## GENERAL NOTES

- ELECTRICAL CONTRACTOR TO REFER TO ARCHITECTURAL DRAWINGS FOR INSTALL LOCATIONS
- INTERLOCK EMERGENCY LIGHTING WITH LIGHT CIRCUIT IN AREA OF SERVICE.
- SUPPLY & INSTALL REMOTE EMERGENCY LIGHTING HEAD SHOWN TO TO BE CONNECTED TO EXISTING EMERGENCY LIGHTING BATTERY BANK IN THE BUILDING.
- SUPPLY & INSTALL EXPOSED ELECTRICAL TO BE IN EMT.

CALLOUT	SYMBOL	NOTE 1
CO Switch	\$ <sub>00</sub>	LEVITON, PART#VPOSR-10 FOR WIRING TO PART# VPT24-1PZ. FULLY PROGRAM & SETUP.
OS .	\$ <sub>05</sub>	LEVITON, PART#OSSMT-MOW, ADJUST BLINDS TO PREVENT EXTENDED ACTIVATION
TIME-LOCK Switch	\$ <sub>TA</sub>	LEVITON, PART# VPT24-1PZ. FULLY PROGRAM & SETUP. IF LOAD EXCEEDS 80% OF TIME LOCK CAPACITY USE CONTACTOR TO CONTROL CIRCUIT

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D RE-ISSUED FOR CONSTRUCTION 21 02 26 C RE-ISSUED FOR CONSTRUCTION AK AK 21 02 04 B ISSUED FOR CONSTRUCTION AK AK 21 01 30 A ISSUED FOR REVIEW AK AK 21 01 21 BY APPR. DATE





CLIENT: BRIDGMAN COLLABORATIVE ARCHITECTURE
678 MAIN STREET
WINNIPEG, MB R3B 1E4
(204)488-3857

PROJECT TITLE: LOO LOO WINNIPEG
715 MAIN ST., WINNIPEG, MB BID OPPORTUNITY 54-2021

SECOND LEVEL-LIGHTING LAYOUT

SHEET NO:

PROJECT NO: DESIGNED BY: AK 201231 DRAWN BY: AK SCALE: REVIEWED BY: AK 1/4"=1'-0"

CALLOUT	SYMBOL	LAMP	DESCRIPTION	MOUNTING	MODEL	INPUT WATTS	VOLTS	NOTE 1	QUANTIT:
	Ð	(1) LED-3500K	VISCOR - LCOMN Square - Intellect-LED Linear Type N - Architectural Lighting	CEILING	LCOM-N-24- LEDB-35K-020L-UNV- P95-V99(LV02) C/W INTEGRAL OCCUPANCY SENSOR	18	120V 1P 2W	C/W Remote Controller, ELC00368, ONE UNIT FOR SITE.—SET OCCUPANY TIMEOUT TO 10MIN.	4
	0	(1) LED-3000K	AERALUX LIGTING-LED LINEAR	SURFACE	AE-SF-ER-ECO-UV-4- 32-N-30	32	120V 1P 2W		3
	ю———	(4) LED-3500K	VISIONEERING 8' LED INDOOR STRIP LUMINAIREWITH WHITE INTERIOR AND NO LENS	CEILING	LCOM96-LED835K140LUNV	103.62	120V 1P 2W	C/W STEM KIT PART#KIT00050	4
i	0	(1) LED-3000K	AERALUX LIGTING—LED LINEAR	WALL	AE-SF-ER-ECO-UV-4- 32-N-30	32	120V 1P 2W	INSTALL AT 7' AFFL.	3
i	Н	(1) LED-4000K	ORACLE LIGHTING LED Die-Cast Aluminum Slim Full Cut-Off Wall	WALL	OWP-FC-116-LED- 3500L- MYOLT-30K-**-WPPHC	27	120V 1P 2W	C/W INTEGRAL PHOTOCELL—INSTALL AT 7.5' AFGL— CONFIRM FINISH PRIOR TO ORDER	2
3	4	(1) LED-4000K	ORACLE LIGHTING - LED Mini Slimline Floodlight Series	SURFACE	ELITE, OFL-SL-202-LED- 3000L-MVOLT-40K-BZ	30	120V 1P 2W	INSTALL ON 2.0' EMT STEM BELOW CEILING SURFACE	4
M	4	(2) LED	EMERGI LITE-REMOTE HEAD	WALL/CEILING	EMERGI LITE EF9DMLG	8	12V 1P 2W		2
M-1	[£	(2) LED	EMERGENCY LIGHTING C/W BATTERY & TWO HEADS	WALL	EMERGI-LITE 12ESL-144-/2LG	100	120V 1P 2W		1
:M-8	4	(2) LED	EMERGI LITE-REMOTE HEAD	WALL/CEILING	EMERGI LITE EF9DMLG	8	12V 1P 2W	BLACK COLOR	2
EXIT	₩	(1) LED	EMERGENCY EXIT LIGHT	WALL/CEILING	EMERGI-LITE EA1WI	2.5	120V 1P 2W	GREEN PICTOGRAMC/W CAGE	3
/G-1	٠	(1) -	WIRE GUARD-CUSTOM PART	CEILING	STAINLESS STEEL MESH, 1" X 1" OPENINGS & 8 SECURITY SCREWS - TO SUIT		120V 1P 2W	C/W HARDWARE INSTALLED IN WALLS AS SPECIFIED TO COVER FIXTURE TYPE 1	4
VG-2		(1) -	WIRE GUARD-CUSTOM PART	CEILING	STAINLESS STEEL MESH, 1" X 1" OPENINGS & 4 SECURITY SCREWS		120V 1P 2W	C/W HARDWARE INSTALLED IN WALLS AS SPECIFIED TO COVER FIXTURE TYPE 6	2
VG-3		(1) -	WIRE GUARD-CUSTOM PART	CEILING	STAINLESS STEEL MESH, 1" X 1" OPENINGS & 4 SECURITY SCREWS		120V 1P 2W	C/W HARDWARE INSTALLED IN WALLS AS SPECIFIED TO COVER FIXTURE EXIT SIGN	2

CIRCUIT

C-12,14

C-16,18

C-21,23


C-25,27

C-20,22

KW

FED	NTING SI FROM H	YDRO		BUS AM NEUTRA	240/12 IPS 200 L 100%	)	3W		MAIN	22,000 BKR 200 STANDARD			
NOTE CKT	CKT	−P1aB4A2−42 	ED-C/W 200	AMP MAIN BR		KVA	скт	СКТ				LOAD	KVA
#	BKR	CIRCUIT DES	CRIPTION		A	В	*#	BKR	CIRCUIT DESC	CRIPTION		A	В
1	15/1	USB OUTLET CHA	NRGER		0.54		2	15/1	RECEPTACLE			0.18	
3	15/1	RECEPTACLE			İ	0.36	4	15/1	RECEPTACLE				0.18
5 [	15/1	RECEPTACLE			0.18	[	6	15/1	LIGHTING			0.826	[
7	30/2	DHWT-1			ļ <sub></sub>	2.25	8	15/1	LIGHTING			1	0.126
9	45/4				2.25		10	15/1	LIGHTING			0.008	_ ا
11   13	15/1 15/1	GMP-1 HD-1			1.6	0.1	12 14	60/2	B-1			5	5
15	15/1	HRV-1			1.6	0.3	16	20/2	DH-1			3	1.5
17	15/1	P-1			0.1	0.5	18	20/2	UII			1.5	'
19	15/1	PDO-1, PDO-2				0.6	20	80/2	FU-1				7.5
21	15/2	FF-1			1	Ī	22	ĺĺ	Ì			7.5	İ
23 [	İ	[			I	1	24	15/1	HD-2				1.6
25 [	15/2	FF-2			[ 1	[	26	15/1	SPACE			0	Į.
27		ļ			ļ	1	28	15/1	SPACE			l.	0
29	15/1	SPACE			0		30	15/1	SPACE			0	
31	15/1	SPACE				0	32	15/1	SPACE				0
33   35	15/1 15/1	SPACE SPACE			0	0	34 36	15/1 15/1	SPACE SPACE			0	۱ ۵
35   37	15/1	SPACE			۱ ،	٠,	38	15/1	SPACE				١ ٠
39	15/1	SPACE			۱ "	0	40	15/1	SPACE			1	۱ ،
41	15/1	SPACE			1 0	ľ	42	15/1	SPACE			0	
		t			i				TOTAL CO	ONNECTED KV	/A BY PHASE	21.7	21.5
			CONN KVA	CALC KVA		<u> </u>				CONN KVA	CALC KVA		
	LICE	ITING	0.96	1.2	(125%)			001	ITINUOUS	4.5	5.63	(125%)	
		GEST MOTOR	0.96	0.075	(25%)				TING	4.5 28.3	28.3	(120%)	
		ER MOTORS	0.8	0.075	(100%)				DLING	0.3	0	(0%)	
		EPTACLES	1.44	1.44	(50%>1	0)			ICONTINUOUS	0.0	ŏ	(100%)	
		HEN EQUIP	0	0	(N/A)	-,			RSE	7.2	1.68	(23%)	
								MET	ERED DEMAND	0	0	(125%)	

3 PANEL SCHEDULES

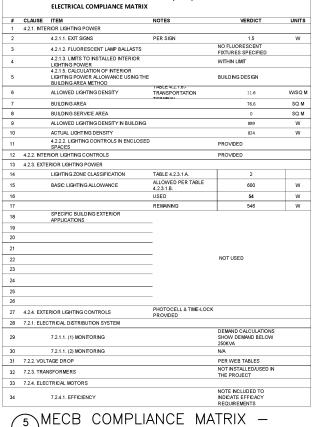

MANITOBA ENERGY CODE FOR BUILDINGS (MECB)

# E06 NEW BUILDING

### | EQUIPMENT & MUTURS EQUIPMENT SCHEDULE

CALLOUT	DESCRIPTION	SYMBOL	VOLTS	AMPS	KW	CIRCUIT	NOTE 1
DHWT-1	DOMESTIC HOT WATER TANK-ELECTRIC	87□	240/120V 2P 3W	18.75	4.5	C-7,9	SUPPLIED BY OTHERS
GMP-1	IN-FLOOR HEATING MAKE-UP PACKAGE	0	120V 1P 2W	0.83	0.1	C-11	SUPPLIED BY OTHERS
HD-1	HAND DRYER	0	120V 1P 2W	13.33	1.6	C-13	SUPPLIED BY OTHERS
HD-2	HAND DRYER	0	120V 1P 2W	13.33	1.6	C-24	SUPPLIED BY OTHERS
HRV-1	HEAT RECOVERY VENTILATOR	ф	120V 1P 2W	2.5	0.3	C-15	SUPPLIED BY OTHERS
P-1	IN-FLOOR HEATING RE-CIRCULATING PUMP	0	120V 1P 2W	0.83	0.1	C-17	SUPPLIED BY OTHERS
PD0-1	POWER DOOR OPERATOR	<b>8∕\$</b>	120V 1P 2W	2.5	0.3	C-19	SUPPLIED BY OTHERS
PD0-2	POWER DOOR OPERATOR	⊗∕\$	120V 1P 2W	2.5	0.3	C-19	SUPPLIED BY OTHERS

## XFMR HYDRO 50 KVA 240/120V OVERHEAD MAST - SERVICE FROM UTILITY POLE MOUNTED TRANSFORMER 2000/2J.B

OUTDOOR

SECOND LEVEL

ELEC. ROOM

3 W 4 200/2J.B





# NOTES

- 1 CIRCUIT BREAKER PROTECTION: 1. FULLY RATED OR USING SERIES RATED
- 2. INTEGRATED EQUIPMENT RATED (IER) WHEN USING SERIES—RATED SYSTEMS, THEY SHALL BE TESTED/LABELED AS A SERIES—RATED COMBINATION
- COMBINATION
  3. LABEL/NAMEPLATE TO BE INSTALLED IN A
  CONSPICUS AND LEGIBLE MANNER TO INDICATE
  THAT THEY SHOULD ONLY BE REPLACED WITH
  COMPONENTS OF THE SAME TYPE AND RATING REFER TO CEC 14-014
- REFER TO CEC 14-014

  2 DOWNSTREAM OVERCURRENT DEVICES MUST BE SERIES RATED COMBINATIONS WITH THE UPSTREAM PROTECTIVE DEVICE. FOR SERIES RATED COMBINATIONS, EACH DEVICE MUST BE LABELED TO INDICATE:

  1. THAT REPLACEMENT COMPONENTS MUST BE OF THE SAME TYPE AND RATING ONLY

  2. TESTED IER KA RATING

  3. SPECIFIC UPSTREAM PROTECTIVE DEVICE

  4. PERMISSIBLE BRANCH DEVICES

  5. PANELBOARD DESIGNATION
- 5. PANELBOARD DESIGNATION 6. VOLTAGE
- 3 ELECTRICAL SERVICE EQUIPMENT SHALL MEET UTILITY REQUIREMENTS.
- 4 ELECTRICAL SERVICE EQUIPMENT INSTALLED OUTDOOR SHALL BE RATED NEMA/CSA 3R.

FEEL	DER S	CHEDULE
ID	FEEDER AMPS	CONDUIT AND FEEDER
200/2J.B	200	2"C,2#250kcmil AL,#250kcmil AL N,#4G

43.2

200/2J.B 200 SIZING METHOD: N FOR NEUTRAL, G FOR GROUND. C FOR CONDUIT. NUMBER BETWEEN ( ) INDICATES NUMBER OF LINE & NEUTRAL PARALLEL RUNS

### PANEL SCHEDULE

BALANCED AMPS

CALLOUT	VOLTS	BUS AMPS	MAIN DISCONNECT TYPE	MAIN DISCONNECT AMPS	MOUNTING	POLES	NOTE 1	AIC RATING			
С	240/120V 2P 3W	200	BREAKER	200	SURFACE	42	EATON-P1AB4A2-42ED-C/W 200AMP MAIN BREAKER	22,000			

### **ELECTRICAL CONTROLS, OUTLETS, & SWITCHES INSTALLATION**

	AREA/ROOM								
TYPE	PUBLIC AREAS	OFFICE	MECH. ROOM	WASHROOMS	COUNTERS				
RECEPTACLE *	18	18	40						
HVAC CONTROLS		47.3 (1200mm)							
COMMUNICATION OUTLETS		WITH							
EMERGENCY LIGHTING		MILLWORK							
MANUAL LIGHT CONTROLS		43	ļ.		LAYOUTS				
OCCUPANCY SENSORS		47.3 (120	Omm)		1				

- \* EXCEPT CEILING MOUNTED ONES

  \*\* EXCEPT OTHERWISE NOTED ON PIANS

  \*\*\*HEIGHTS ARE MEASURED FROM FINISH FLOOR LEVEL TO BOTTOM OF OUTLET BOX
- 4 INSTALLATION HEIGHTS— EDG ELECTRICAL CONTROLS

# EQUIPMENT SCHEDULES

ELECTRIC HEATERS EQUIPMENT SCHEDULE

SYMBOL

❤️□

VOLTS

240V 2P 2W

240/120V 2P 3W

⊕ 240/120V 2P 3W 62.5

AMPS

41.67

12.5

8.33



# IBASA Electrical Engineering Design & Consulting

CALLOUT

FF-2

DESCRIPTION

FORCE FLOW HEATER-BACKUP

FORCE FLOW HEATER-BACKUP

ELECTRIC FURNACE

IN-FLOOR HEATING BOILER-ELECTRIC

490 Paul Blvd. Winnipeg, MB R2N 4C8 T. 204-515-1158 info@ibasa.ca

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ORDERING INFORMATION

OUELLET, PART#OACO2000 WITH TAMPERPROOF THERMOSTAT SET TO 5 DEG. C. NO ACCESS SHALL BE AVAILABLE TO USER TO ADJUST TEMPERATURE

OUELLET, PART#OACO2000 WITH TAMPERPROOF THERMOSTAT SET TO 5 DEG. C. NO ACCESS SHALL BE AVAILABLE TO USER TO ADJUST TEMPERATURE

SUPPLIED BY OTHERS

SUPPLIED BY OTHERS

SUPPLIED BY OTHERS





CLIENT: BRIDGMAN COLLABORATIVE ARCHITECTURE 678 MAIN STREET WINNIPEG, MB R3B 1E4

LOO LOO WINNIPEG

SHEET TITLE: EQUIPMENT & PANEL SCHEDULES

> DESIGNED BY: AL 201231 DRAWN BY: AL REVIEWED BY: AL

F06

SHEET NO:

PROJECT TITLE:

715 MAIN ST., WINNIPEG, MB BID OPPORTUNITY 54-2021

(204)488 - 3857

PROJECT NO: SCALE: NTS

#### GENERAL

- 1.1. REQUIREMENTS, INSTRUCTIONS TO BIDDERS, THIS SPECIFICATIONS AND ANY ADDENDA HERETO FORM PART OF THE CONTRACT DOCUMENTS AND SHALL BE READ IN CONJUNCTION WITH THEM. WORK TO INCLUDE THE FURNISHING OF ALL LABOR AND MATERIALS UNLESS OTHERWISE SPECIFIED OTHERWISE TO COMPLETE AND PUT INTO OPERATING CONDITIONS ALL ELECTRICAL SYSTEMS AS INDICATED ON THE DRAWINGS AND SPECIFIED HEREIN.
- 1.2. RESPONSIBILITY AS TO WHICH TRADES PROVIDES REQUIRED ARTICLES OR MATERIAL RESTS SOLELY WITH THE GENERAL CONTRACT TRADE. EXTRAS WILL NOT BE CONSIDERED BASED ON GROUNDS OF DIFFERENCE OF INTERPRETATION OF SPECIFICATIONS AS TO WHICH TRADE INVOLVED SHALL PROVIDE CERTAIN SPECIALITIES OR MATERIALS.
- 1.3. EXAMINE SITE, LOCAL CONDITIONS, DRAWINGS FOR FACTORS AFFECTING WORK TO WHICH DRAWINGS APPLY TO ENSURE THAT WORK CAN SATISFACTORY BR CARRIED OUT WITHOUT CHANGES TO DRAWINGS. NO ALLOWANCES WILL BE MAKE LATER FOR ANY EXPENSE INCURRED THROUGH FAILURE TO MAKE THIS EXAMINATION. START OF WORK WILL DEEMED EVIDENCE OF, ACCEPTANCE OF, AND SATISFACTION WITH SITE, LOCAL CONDITIONS, AND DRAWINGS.
- MUST: THIS WORD, OR THE TERMS "REQUIRED" OR "SHALL", MEAN THAT THE DEFINITION IS AN ABSOLUTE REQUIREMENT OF THE SPECIFICATION. PROVIDE TO MEAN "SUPPLY & INSTALL."

#### 2. DRAWINGS AND SPECIFICATIONS

- 2.1. DRAWINGS AND SPECIFICATIONS ARE COMPLEMENTARY TO EACH OTHER AND WHAT IS CALLED FOR BY ONE TO BE BINDING AS IF CALLED FOR BY OTHER.
- 2.2. SHOULD ANY DISCREPANCY APPEAR BETWEEN DRAWINGS AND SPECIFICATIONS WHICH LEAVES ELECTRICAL CONTRACTOR IN DOUBT AS TO TRUE INTENT AND MEANING, OBTAIN RULING BEFORE SUBMITTING TENDER. IF THIS IS NOT DONE, IT WILL BE ASSUMED THAT THE MOST EXPENSIVE ALTERNATE HAS BEEN FIGURED.

### 3. EXAMINATION OF OTHER DRAWINGS

3.1. THIS CONTRACTOR TO EXAMINE CAREFULLY STRUCTURAL, ARCHITECTURAL AND MECHANICAL DRAWINGS AND WORK OF OTHER TRADES AND SATISFY HIMSELF THAT THE WORK UNDER THIS CONTRACT CAN BE SATISFACTORY CARRIED OUT WITHOUT CHANGES TO THE BUILDING AS SHOWN ON THE PLANS. SHOULD ANY DIFFICULTY ARISE SHOWING CONFLICT WITH, OR REQUIRING ADDITIONAL WORK BEYOND THE WORK OF THESE DRAWINGS, BRING THIS MATTER TO THE ATTENTION OF THE CONTRACT ADMINISTRATOR BEFORE SUBMITTING TENDER.

#### 4. UNIFORMITY OF EQUIPMENT

4.1. UNLESS OTHERWISE SPECIFIED, UNIFORMITY OF MANUFACTURER TO BE MAINTAINED FOR ANY PARTICULAR ITEM THROUGHOUT.

### 5. STANDARDS OF MATERIAL AND WORKMANSHIP

- 5.1. ALL MATERIALS TO BE NEW AND OF THE QUALITY SPECIFIED AND CONFORM TO THE STANDARDS OF THE CSA. WHERE EQUIPMENT OR MATERIALS ARE SPECIFIED BY TECHNICAL DESCRIPTION ONLY, THEY SHALL BE OF THE BEST COMMERCIAL QUALITY OBTAINABLE FOR THE PURPOSE.
- ALL WORK TO BE EXECUTED IN A NEAT AND WORKMANLIKE MANNER BY QUALIFIED TRADESMEN. ELECTRICAL CONTRACTOR TO KEEP A COMPETENT FOREMAN AND NECESSARY ASSISTANTS ON THE JOB DURING THE PROGRESS OF THE WORK.
- 5.3. ALL MATERIAL AND INSTALLATION SHALL MATCH BUILDING STANDARD UNLESS IT IS NOTED ON THE

### 6. RECORD PLANS & DIGITAL PHOTOGRAPHS

- 6.1. THE CONTRACT ADMINISTRATOR WILL FURNISH TO THE ELECTRICAL CONTRACTOR A PORTABLE DOCUMENT FORMAT "PDF" DRAWING SET TO BE USED FOR RECORD PURPOSES. ALL REVISIONS MADE ON SITE DURING CONSTRUCTION TO BE ACCURATELY RECORDED.
- 6.2. ELECTRICAL CONTRACTOR TO PRODUCE AT HIS OWN EXPENSE A SET OF AUTOCAD DRAWINGS INCLUDING ALL CHANGES TO THE ORIGINAL TENDER DRAWINGS COVERED BY ADDENDA, CHANGE ORDER, FIELD CHANGES, JOB CONDITIONS ETC., AND TURN THESE OVER TO THE CONTRACT ADMINISTRATOR IN ELECTRONIC AND HARD COPY FORM. COMPLETED RECORD DRAWINGS TO BE CLEARLY MARKED "RECORD DRAWINGS".
- SHOW ALL MAJOR, JUNCTION BOXES, CORE HOLES, CONDUIT HOME RUNS AND CIRCUIT NUMBERS
- PROVIDE THREE COPIES OF MAINTENANCE MANUALS TO INCLUDE ALL NEW ELECTRICAL EQUIPMENT SUCH AS: LIGHT FIXTURES, EXIT LIGHTS, BATTERY UNITS, LIGHTING CONTROLS, PANELS,
- 6.5. INCLUDE COPIES OF COMPUTER PRINTED PANEL DIRECTORIES FOR ALL PANELS.
  6.6. PROVIDE AS—BUILT DRAWINGS AND MANUALS TO BUILDING MANAGEMENT AT TIME OF COMPLETION. DRAWINGS AND MANUALS SHALL BE REVIEWED FOR ACCURACY BY CONTRACT ADMINISTRATOR AT
- 6.7. ELECTRICAL CONTRACTOR TO MAINTAIN DIGITAL PHOTOGRAPH RECORDS OF ALL ELECTRICAL INSTALLATION PRIOR TO CONCEALMENT. DIGITAL PHOTOGRAPHS TO HAVE LEGIBLE BUILDING REFERENCE POINTS FOR IDENTIFICATION. PROVIDE THE DIGITAL PHOTOGRAPHS AS PART OF THE AS-BUILT DRAWINGS IN ORIGINAL DIGITAL FORMAT.

### 7. SHOP DRAWINGS

- 7.1. ELECTRICAL CONTRACTOR TO SUBMIT TO THE CONTRACT ADMINISTRATOR FOR REVIEW, SHOP DRAWINGS OF ELECTRICAL COMPONENTS INDICATED ON DRAWINGS IDENTIFIED AND TO INCLUDE ALL SPECIFIC SITE REQUIREMENTS & INSTALLATION REQUIREMENTS REQUIRED BY THE MANUFACTURER
- 7.2. ALL DRAWINGS TO BE SUBMITTED IN ELECTRONIC FORMAT. ALLOW AT LEAST FOR TEN WORK DAYS

#### FOR SHOP DRAWINGS REVIEW.

- CONTRACT ADMINISTRATOR'S REVIEW OF SHOP DRAWINGS TO BE FOR GENERAL DESIGN ONLY AND WILL NOT RELIVE ELECTRICAL CONTRACTOR OR SUPPLIERS FROM RESPONSIBILITY FOR ERRORS, PROPER FITTING, CONSTRUCTION OF WORK AND FURNISHING OF MATERIALS. REVIEW WILL NOT BE CONSTRUED AS APPROVING DEPARTURES FROM CONTRACT DOCUMENT REQUIREMENTS IF SUCH DEPARTURES ARE NOT SPECIFICALLY NOTED. ELECTRICAL CONTRACTOR TO BE RESPONSIBLE FOR VERIFYING ALL DIMENSIONS.
- 7.4. ALL EXTRA COSTS ASSOCIATED WITH AN ALTERNATE PRODUCT THAT IS SPECIFIED IS THE RESPONSIBILITY OF THE ELECTRICAL CONTRACTOR. EXTRAS RESULTING FROM THE LACK OF AN ALTERNATIVE PRODUCT TO MATCH SPECIFIED PRODUCT WILL NOT BE CONSIDERED.

#### 8. GUARANTEE WARRANTY

- 8.1. FURNISH A WRITTEN GUARANTEE WARRANTY COUNTERSIGNED AND GUARANTEED BY GENERAL CONTRACT TRADE STATING:
- THAT ALL WORK EXECUTED UNDER THIS CONTRACT WILL BE FREE FROM DEFECTS OF MATERIALS AND WORKMANSHIP FOR A PERIOD OF ONE YEAR FROM THE DATE OF FINAL ACCEPTANCE.
- THE ABOVE PARTIES FURTHER AGREE TO, AT THEIR OWN EXPENSE, REPAIR AND REPLACE ALL SUCH DEFECTIVE WORK AND OTHER WORK DAMAGED THEREBY WHICH FAILS OR BECOMES DEFECTIVE DURING THE TERM OF GUARANTEE WARRANTY PROVIDED THAT SUCH FAILURE IS NOT DUE TO IMPROPER USAGE.
- PERIOD OF THE GUARANTEE SPECIFIED TO BE IN NO WAY SUPPLANT ANY OTHER GUARANTEE OF A LONGER PERIOD BUT BE BINDING ON WORK NOT OTHERWISE COVERED.

### 9. SETTING OUT OF THE WORK

- 9.1. ELECTRICAL CONTRACTOR TO BE RESPONSIBLE FOR CORRECTING ALL WORK COMPLETED CONTRARY TO INTENT OF DRAWINGS AND SPECIFICATIONS AND BEAR ALL COST FOR THE SAME. WHERE INTENT OF DRAWINGS AND SPECIFICATIONS IS NOT CLEAR, OBTAIN CLARIFICATION BEFORE PROCEEDING WITH
- ELECTRICAL CONTRACTOR TO GIVE WORK HIS PERSONAL SUPERVISION LAY OUT HIS OWN WORK, DO ALL NECESSARY LEVELING AND MEASURING OR EMPLOY A COMPETENT CONTRACT ADMINISTRATOR TO DO SO, FIGURES, FULL SIZE AND DETAIL DRAWINGS TO TAKE PRECEDENT OVER SCALE MEASUREMENTS.
- WHERE ANY EQUIPMENT SUPPLIED BY ELECTRICAL CONTRACTOR MUST BE BUILT IN WITH WORK OF OTHER CONTRACTOR, THIS CONTRACTOR TO BE RESPONSIBLE FOR SUPPLYING THE EQUIPMENT TO BE BUILT IN OR MEASUREMENTS TO ALLOW NECESSARY OPENING TO BE LEFT SO AS NOT TO HOLD
- ELECTRICAL CONTRACTOR TO BE RESPONSIBLE FOR ANY DAMAGE CAUSED BY THEM AND/OR BY ANY OTHER ELECTRICAL SUB-TRADE BY IMPROPER LOCATION OR CARRYING OUT OF HIS WORK
- ELECTRICAL CONTRACTOR IN SETTING OUT OF HIS WORK, TO MAKE REFERENCE TO ARCHITECTURAL STRUCTURAL, AND MECHANICAL DRAWINGS. CONSULT WITH RESPECTIVE TRADES IN SETTING OUT LOCATIONS FOR CONDUIT RUNS, LIGHTING FIXTURES, PANEL ASSEMBLIES, AND THE LIKE, SO THAT CONFLICTS ARE AVOIDED AND SYMMETRICAL SPACING IS MAINTAINED.
- WHERE RECEPTACLES ARE MOUNTED ABOVE COUNTERS, BENCHES, SPLASHBACKS, AND THE LIKE, LOCATION AND MOUNTING HEIGHTS TO BE COORDINATED WITH BUILT-IN UNITS. REFER TO ARCHITECTURAL DETAILS. WHERE RECEPTACLES OCCUR IN OUTSIDE WALLS WHERE HEATING UNITS OCCUR, RECEPTACLE HEIGHT TO BE ADJUSTED TO COORDINATE WITH THE HEATING UNIT.
- ELECTRICAL CONTRACTOR TO COORDINATE ANY INTERRUPTIONS TO ADJOINING TENANTS IN ORDER TO AVOID ANY INCONVENIENCES TO SAID TENANT. IF NECESSARY ELECTRICAL CONTRACTOR TO DO ANY REQUIRED CONNECTIONS ON OFF HOURS.
- SWITCH MOUNTING HEIGHTS TO BE COORDINATED WITH ARCHITECTURAL DETAILS AND TO BE ADJUSTED IF REQUIRED, TO COORDINATE WITH PANELING, MASONRY COURSE LINES AND THE LIKE.
- WHERE OUTLETS OCCUR IN EXTERIOR WALLS, ELECTRICAL CONTRACTOR TO ENSURE THAT THERE IS INSULATION BEHIND THE OUTLET BOXES TO PREVENT CONDENSATION THROUGH THE BOXES.

### 10. EXAMINATION OF SITE

10.1. PRIOR TO SUBMITTING TENDER, ELECTRICAL CONTRACTOR TO CAREFULLY EXAMINE THE SITE AND ASCERTAIN ALL CONDITIONS WHICH MAY AFFECT HIS TRADE. NO EXTRAS WILL BE ALLOWED FOR WORK RESULTING FROM CONDITIONS WHAT WOULD HAVE BEEN EVIDENT UPON A THROUGH EXAMINATION OF SITE.

### 11 CLEANUP

- 11.1. ELECTRICAL CONTRACTOR AND HIS SUBTRADES AT ALL TIMES DURING CONSTRUCTION, KEEP SITE FREE OF ALL DEBRIS, BOXES, PACKING AND THE LIKE RESULTING FROM WORK OF THIS TRADE.
- 11.2. UPON COMPLETION OF WORK, ELECTRICAL INSTALLATION TO BE LEFT IN A CLEAN AND FINISHED CONDITION TO SATISFACTION OF THE CONTRACT ADMINISTRATOR.

12.1. ELECTRICAL CONTRACTOR TO SUPPLY AND INSTALL ACESS DOORS REQUIRED FOR PROPER SERVICING OF ALL ELECTRICAL WORK, ACCESS DOORS TO BE COMPLETE WITH NECESSARY FRAMES AND HINGED DOORS HELD CLOSED WITH CAPTIVE STUDS. ACCESS PANELS TO BE OF NOT LESS THAN 14 GAUGE STEEL, PRIME COATED FINISHED AND PAINTED ON THE JOB TO MATCH THE WALL OR CEILING FINISH.

### 13. CODES, PERMITS AND INSPECTION

- 13.1. INSTALLATION TO COMPLY WITH REQUIREMENTS OF BUILDING CODES AND CANADIAN ELECTRICA CODE AND REGULATIONS OF THE INSPECTION DEPARTMENT.
- 13.2. ELECTRICAL CONTRACTOR TO OBTAIN ALL PERMITS REQUIRED AND AFTER COMPLETION OF THE WORK

FURNISH TO THE CONTRACT ADMINISTRATOR A CERTIFICATE OF FINAL INSPECTION AND APPROVAL FROM ELECTRICAL INSPECTION DEPARTMENT.

### 14. MECHANICAL EQUIPMENT

14.1. UNLESS OTHERWISE, ELECTRICAL CONTRACTOR TO SUPPLY AND INSTALL ALL CONDUIT AND WIRE. FITTINGS AND CONNECTIONS FOR ALL MECHANICAL EQUIPMENT. MOTOR PROTECTION SWITCHES COMPLETE WITH OVERLOAD RELAYS, AND OTHER REQUIRED PARTS TO COMPLETE THE JOB TO BE SUPPLIED AND INSTALLED BY ELECTRICAL CONTRACTOR. ELECTRICAL CONTRACTOR TO CONFIRM WITH MECHANICAL TRADE SIZE, CHARACTERISTICS AND LOCATIONS OF ALL MECHANICAL EQUIPMENT BEFORE INSTALLATION OF CONDUIT, OUTLETS, HEATERS, AND THE LIKE. ELECTRICAL CONTRACTOR TO EXAMINE MECHANICAL DRAWINGS FOR ALL MECHANICAL EQUIPMENT REQUIRES ELECTRICAL CONTRACTOR RELATED INSTALLATIONS. NOT ALL MECHANICAL REQUIREMENT ARE NOTED ON ELECTRICAL DRAWINGS.

### 15. TESTS

- 15.1. ALL PORTIONS OF ELECTRICAL WORK TO BE TESTED AND CHECKED FOR SATISFACTORY INSTALLATION AND OPERATION. USE STANDARD INDUSTRY FORMS. PRESENT TEST RECORDS TO THE CONTRACT ADMINISTRATOR UPON REQUEST.
- 15.2. BEFORE ENERGIZING ANY PORTION OF ELECTRICAL SYSTEM, PERFORM MEGGER TESTS ON ALL FEEDERS AND BRANCH CIRCUITS. RESULTS OF SUCH TESTS TO CONFORM TO REQUIREMENTS OF CANADIAN ELECTRICAL CODE AND BE TO SATISFACTION OF AUTHORIZED INSPECTION AGENCY AND THE CONTRACT ADMINISTRATOR. KEEP DATED TEST LOGS AND PRESENT TO THE CONTRACT ADMINISTRATOR UPON REQUEST.
- 15.3. UPON COMPLETION AND IMMEDIATELY PRIOR TO FINAL INSPECTION AND TAKEOVER, CHECK LOAD BALANCE ON ALL FEEDERS AND AL DISTRIBUTION CENTERS, PANELS, AND THE LIKE. TEST TO BE CARRIED OUT BY TURNING ON ALL POSSIBLE LOADS AND CHECKING LOAD CURRENT BALANCE. IF LOAD UNBALANCE EXCEEDS 15% RECONNECT CIRCUITS TO BALANCE LOAD.

- 16.1. PLAN, ORGANIZE, AND HIRE A THIRD PARTY TO IMPLEMENT A CONTRACTOR PREPARED COMMISSIONING PLAN WITH A DEFINED SCHEDULE FOR ALL ELECTRICAL AND RELATED MECHANICAL SYSTEMS.
- 16.2. COMMISSIONING PLAN SHALL INCLUDE AS MINIMUM THE FOLLOWING: INSTALLATION CHECKLISTS START-UP CHECKLISTS, VERIFICATION, SHEETS AND INTEGRATED TESTING TESTING SHEETS.
- SUPPLY COMPLETE INSTRUCTIONS AND INFORMATION RELATING TO THE OPERATION AND MAINTENANCE OF ALL EQUIPMENT AND SYSTEMS.
- 16.4. DELIVER A SYSTEM WHICH PERFORMS IN ACCORDANCE WITH THE CONTRACT DOCUMENTS AND EQUIPMENT MANUFACTURER'S REQUIREMENTS.

### 17. PAINTING AND FINISHES

- 17.1. ALL ELECTRICAL FITTINGS, SUPPORT, HANGER RODS, PULLBOXES, CHANNEL FRAMES, CONDUIT RACKS, OUTLET BOXES, BRACKETS, CLAMPS AND ALL OTHER SIMILAR COMPONENTS OF THE ELECTRICAL INSTALLATION TO HAVE GALVANIZED FINISH OR PAINT FINISH OVER CORROSION-RESISTANCE PRIMER.
- 17.2. ALL PANEL TO BE FACTORY FINISHED WITH SPRAY-ON AIR DRAY ENAMEL. ALL ENAMEL TO BE APPLIED OVER CORROSION-RESISTANCE PRIMER, MATT OR FLAT TYPE FINISH PAINT WILL NOT BE ACCEPTED. ALL PANELS OR SIMILAR FACTORY FINISHED UNITS THAT ARE SCRATCHED OR MARKED DURING INSTALLATION TO BE TOUCHED UP WITH MATCHING SPRY-ON AIR DRY LACQUER AND IF REQUIRED TO PROVIDE SATISFACTORY JOB TO BE COMPLETELY REFINISHED.
- 17.3. ALL PANELBOARDS, PULLBOXES AND THE LIKE TO BE FINISHED IN GRAY ENAMEL.
- 17.4. PULLBOXES, JUNCTIONBOXES, TERMINAL PANELS, AND THE LIKE TO BE FINISHED IN ACCORDANCE WITH EXISTING BUILDING.

- 18.1. ALL WIRE AND CABLE TO BE INSTALLED IN CONDUIT EXCEPT WHERE IS NOTED OTHERWISE ON THE DRAWINGS. BX WIRING MAY BE UTILIZED FOR DROPS FROM JUNCTION BOXES TO OUTLETS AND LIGHTS NOT TO EXCEED 30 FEET IN LENGTH.
- 18.2. CONDUIT TO BE ELECTRIC METALLIC TUBING, UTILIZE RIGID GALVANIZED STEEL CONDUIT FOR ALL EXPOSED RUNS OUTDOOR ABOVE GRADE AND WHERE IN JUDGMENT BY THE ELECTRICAL INSPECTION AUTHORITY IS SUBJECT TO MECHANICAL DAMAGE.
- 18.3. PROVIDE HEAVY WALL RIGID PVC CONDUIT FOR BURIED AND FOR BELOW GRADE INSTALLATIONS AND
- 18.4. SURFACE MOUNTED CONDUITS TO BE INSTALLED PARALLEL OR PERPENDICULAR TO STRUCTURAL LINES AND WHERE BENDS OCCUR FOR PARALLEL RUNS, THEY SHALL BE CONCENTRIC.
- 18.5. CONDUITS TO BE INSTALLED FREE FROM DENTS AND HAVE ENDS PLUGGED TO PREVENT ENTRANCE OF DUST OR MOISTURE.
- 18.6. ALL CONDUITS, EXCEPT WHERE OTHERWISE TO BE SIZED IN ACCORDANCE WITH CANADIAN ELECTRICAL CODE.
- 18.7. FLEXIBLE CONDUIT CONNECTIONS TO MOTORS, CONTROLS, AND THE LIKE TO BE FLEXIBLE PLASTIC JACKETED, SEAL TIGHT OR APPROVED EQUAL. FLEXIBLE CONDUIT CONNECTIONS ARE REQUIRED TO ALL MOTORS FROM STUB-UP OR JUNCTION BOXES.
- 18.8. APPROPRIATE AND COORDINATED METAL TYPE FITTINGS TO BE USED WITH CONDUITS.
- 18.9. SUPPLY & INSTALL FLEXIBLE CONDUIT CONNECTIONS FOR PRIMARY AND SECONDARY FEEDS TO DRY TYPE TRANSFORMERS TO REDUCE NOISE TRANSMISSION.

### 19. EXPANSION JOINTS

19.1. WHERE CONDUITS ARE INSTALLED IN CONCRETE SLABS AND CROSS STRUCTURAL EXPANSION JOINTS,

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CLIENT: BRIDGMAN COLLABORATIVE ARCHITECTURE 678 MAIN STREET WINNIPEG, MB R3B 1E4 (204)488 - 3857

LOO LOO WINNIPEG 715 MAIN ST., WINNIPEG, MB BID OPPORTUNITY 54-2021

INSTALLATION SPECIFICATIONS-PART 1

PROJECT NO DESIGNED BY: AK 201231 DRAWN BY: AK SCALE:

REVIEWED BY: AK

SHEET NO:

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AN APPROVED EXPANSION FITTING COMPLETE WITH BONDING JUMPER AND CLAMPS SHALL BE INSTALLED. ELECTRICAL CONTRACTOR TO USE APPROVED EXPANSION JOINTS.

#### 20. WIRE AND CABLE

- 20.1. ALL BUILDING WIRING TO BE APPROVED COPPER OR ALUMINUM.
- 20.2. MINIMUM CONDUCTOR SIZE IS #12 AWG TO BE USED.
- 20.3. SMALL CONDUCTORS FOR CONTROL OR LOW VOLTAGE WORK TO BE USED WHERE CALLED FOR ON DRAWINGS OR IN SPECIFICATIONS.
- 20.4. ALL CONDUCTORS TO BE COLOR CODED THROUGHOUT IN ACCORDANCE WITH THE FOLLOWING TO MATCH EXISTING:

EQUIPMENT GROUNDING CONDUCTOR - GREEN

NEUTRAL CONDUCTOR - WHITE

120/208 VOLTS PHASE WIRES - RED, BLACK, AND BLUE

#### 21. OUTLET BOXES

- 21.1. BOXES: HOT DIP GALVANIZED, CONFORMING TO CSA REQUIREMENTS.
- 21.2. USE CEILING FIXTURE BOX WITH CEILING GRID BRACKET FOR ALL INSTALLATIONS IN CEILING GRIDS.
- 21.3. BOXES FOR CEILING: #54151 OR #72171 OR SIMILAR APPROVED.
- 21.4. BOXES FOR INDOOR SURFACE MOUNTED EQUIPMENT, USE 4 INCH SQUARE #52151, #52171, #58361 OR SIMILAR APPROVED WITH APPROVED COVERS.
- 21.5. ALL OUTLET BOXES TO BE FLUSH MOUNTED EXCEPT AS SPECIFIED.
- 21.6. NO DRYWALL PLATES, PLASTER PLATES, BOXES WITH OPEN BACK, SECTIONAL, OR HANDY BOXES ALLOWED.

#### 22. LOCATION OF OUTLETS

- 22.1. THE CONTRACT ADMINISTRATOR RESERVES THE RIGHT TO CHANGE LOCATION OF OUTLETS TO WITHIN THREE METERS OF POINTS INDICATED ON THE PLANS WITHOUT EXTRA CHARGE PROVIDING CONTRACTOR IS ADVISED BEFORE INSTALLATION IS MADE.
- 22.2. ELECTRICAL CONTRACTOR TO REFER TO ARCHITECTURAL ROOM ELEVATIONS FOR POSITION, AND MOUNTING HEIGHTS OF ALL OUTLETS, SWITCHES, INTERCOMMUNICATIONS, TELEPHONES, SPEAKERS, CLOCKS, AND THE LIKE. POSITIONS SHOWN ON ARCHITECTURAL PLANS TO TAKE PRECEDENCE OVER POSITIONS OR MOUNTING HEIGHTS SHOWN ON ELECTRICAL PLANS.

### 23. PULLBOXES

23.1. SUPPLY AND INSTALL PULLBOXES AS REQUIRED TO SUIT JOB CONDITIONS. PULLBOXES TO CONFORM TO CANADIAN ELECTRICAL CODE AND BE FINISHED IN ENAMEL OVER CORRISION—RESISTANCE PRIMER WITH SCREW—ON OR HINGED COVER. IN REMOVABLE CEILING AREAS, PULLBOXES ARE TO BE INSTALLED ABOVE THE CEILING. PULLBOXES IN FINISHED WALLS AND PLASTER OR NON—REMOVABLE CEILINGS TO HAVE OVERLAPPING TYPE TRIM WITH COVERS PRIME COATED AND PAINTED ON JOB TO MATCH WALL OR CEILING FINISH.

#### 24. SWITCHES AND RECEPTACLES

- 24.1. LINE VOLTAGE SWITCHES TO BE RATED 15A, 125 VOLTS, OF MATCHING FINISH TO SURROUNDING, EXCEPT WHEN NOTED. TWO POLE, THREE WAY, FOUR WAY SWITCHES TO BE OF MATCHING TYPE.
- 24.2. STANDARD RECEPTACLES TO MATCH EXISTING OR EQUAL.
- 24.3. ISOLATED GROUND RECEPTACLES TO BE THREE WIRE, ORANGE FACE, STRAIGHT BLADE, COVER PLATE TO BE OF IMPACT RESISTANCE OF MATCHING FINISH TO SURROUNDING, EXCEPT WHEN NOTED.
- 24.4. PLATES FOR ALL FLUSH MOUNTING DEVICES TO BE OF THERMOPLASTIC WITH MATCHING FINISH TO SURROUNDING, EXCEPT WHEN NOTED.
- 24.5. PROVIDE LABELS FOR ALL RECEPTACLES.
- 24.6. FOR ALL RECEPTACLES OTHER THAN STANDARD 15A DUPLEX RECEPTACLES, PROVIDE TAGS GIVING AMP RATING, PHASE, AND VOLTAGE.

### 25. SUPPORTS

- 25.1. ALL SURFACE CONDUITS, ELECTRICAL EQUIPMENT, AND THE LIKE TO BE SECURELY AND ADEQUATELY SUPPORTED.
- 25.2. CABLES INSTALLED ON ROOF SHALL BE INSTALLED MECHANICALLY SECURED & SUPPORTED TO CABLE TRAY SYSTEM. SECURING CABLES TO ROOF RUBBER BLOCKS DIRECTLY IS NOT AN ACCEPTABLE MECHANICAL SUPPORT MEANS.
- 25.3. WHERE INSERTS ARE REQUIRED IN CONCRETE, EXPANSION INSERTS, LEAD INSERTS OR PLASTIC INSERTS TO BE USED IN DRILLED HOLES. SHORT DRIVEN PINS MAY BE USED IN STRUCTURAL CONCRETE ONLY WITH THE PERMISSION OF THE CONTRACT ADMINISTRATOR.
- 25.4. ELECTRICAL CONTRACTOR TO RETAIN THE SERVICES OF STRUCTURAL CONTRACT ADMINISTRATOR LICENCE IN THE PROVINCE OF THE PROJECT TO REVIEW & TO DESIGN SUPPORTS FOR ANY ELECTRICAL ITEMS HUNG FROM CEILING. PROVIDE CERTIFICATION LETTER FROM DESIGN CONTRACT ADMINISTRATOR HEREIN AFTER WORK COMPLETION.
- 25.5. SUPPLY & INSTALL ADEQUATE SOLID BACKING IN WALLS TO EXTEND AT LEAST TWO TIMES THE SQUARE AREA OF THE MOUNTING SURFACE OF THE FIXTURE INSTALLED FOR WALL MOUNTED EQUIPMENT.

### 26. GROUNDING

- 26.1. SUPPLY AND INSTALL COMPLETE GROUNDING SYSTEM AS REQUIRED BY THE CANADIAN ELECTRICAL CODE AND THE ELECTRICAL INSPECTION DEPARTMENT. ALL COMPONENTS TO BE SECURELY AND ADEQUATELY GROUNDED AND WHERE REQUIRED TO ACCOMPLISH THIS, GROUNDING JUMPERS, GROUNDING STUDS AND BUSHING TO BE USED.
- 26.2. PROVIDE AN UN-INSULATED ISOLATED GROUND BUS IN NEW ELECTRICAL PANEL AND PROVIDE A #6
  AWG INSULATED ISOLATED GREEN GROUND WIRE FROM ISOLATED GROUND BUS TO MAIN GROUND
  BUS IN BUILDING ELECTRICAL ROOM.

- 26.3. PROVIDE A #12 INSULATED ISOLATED GREEN GROUND WIRE FROM EACH ISOLATED GROUND OUTLET TO INSULATED ISOLATED GREEN GROUND BUS IN PANEL.
- 26.4. PROVIDE BONDING JUMPER ACROSS WATER METER.
- 26.5. ALL GROUND RODS SHALL BE INSTALLED IN LISTED PVC GROUND TEST WELL INSTALLED PER MANUFACTURER SPECIFICATIONS.

#### 27. PANELS

- 27.1. NEW PANELS TO BE 120/208 VOLTS, 347/600 VOLTS, OR AS NOTED, 4 WIRE, SOLID NEUTRAL DESIGN WITH SEQUENCE STYLE BUSSING AND FULL CAPACITY NEUTRAL, COMPOSED OF AN ASSEMBLY OF BOLT IN PLACE TO ACCEPT MOLDED CASE CIRCUIT BREAKERS AS INDICATED WITH THERMAL AND MAGNETIC TRIP AND TRIP FREE POSITIONS SEPARATE FROM EITHER THE ON OR THE OFF POSITION. TWO AND THREE POLE BREAKERS TO HAVE A COMMON SIMULTANEOUS TRIP.
- 27.2. UTILIZE EXITING PANELBOARDS AS INDICATED ON THE DRAWING. REUSE EXITING BREAKERS WHERE IS POSSIBLE. PROVIDE NEW BREAKERS AS REQUIRED (FOR PROJECTS WITH EXISTING ELECTRICAL SERVICE AND DISTRIBUTION).
- 27.3. BALANCE PANEL LOAD FOR EACH PHASES, A, B, AND C. ALLOW FOR RELOCATING CIRCUITS WITHIN PANELBOARDS TO BALANCE THE LOAD.
- 27.4. PROVIDE COMPUTER PRINTED PANEL DIRECTORIES FOR ALL PANELS.
- 27.5. USE AFCI (ARC FAULT CIRCUIT INTERRUPTER) CIRCUIT BREAKERS FOR SLEEPING AREA CIRCUITS.

### 28. LIGHTING LUMINARIES AND LIGHTING CONTROLS

- 28.1. ELECTRICAL CONTRACTOR TO SUPPLY AND INSTALL ALL LIGHTING LUMINARIES COMPLETE WITH LAMPS, MOUNTING BRACKETS, BALLASTS AND ALL NECESSARY ACCESSORIES IN ACCORDANCE WITH THE LUMINARIES TYPES SHOWN.
- 28.2. ALL LIGHT FIXTURES' COLOR TEMPERATURE SHALL BE CONSISTENT.
- 28.3. ELECTRICAL CONTRACTOR TO SUPPLY AND INSTALL ALL LIGHTING CONTROLS WITH LINE VOLTAGE SWITCHES, DIMMER SWITCHES (RATED 1500 WATT), LOW VOLTAGE DIMMER SWITCHES, LOW VOLTAGE SWITCHES, LIGHTING RELAYS, BARRIER AND ALL CONTROL WIRING AND COMPONENTS TO SUIT THE LAYOUT. ALL MATERIAL AND INSTALLATION SHALL BE IN ACCORDANCE WITH THE RECOMMENDATION OF THE MANUFACTURER AND COMPLY WITH CODES.
- 28.4. LOW VOLTAGE MASTER SWITCHES AND BUILDING LIGHTING CONTROL SHALL HAVE THE CAPABILITY TO TURN ON AND OFF ALL LIGHTING (120 AND 347 VOLTS) WITH THE EXCEPTION OF LUMINARIES ON EMERGENCY LIGHTING CIRCUITS OR UN-SWITCHED NIGHT LIGHT CIRCUITS.
- 28.5. COORDINATE LIGHTING CONTROL PROGRAMMING WITH THE BUILDING SUPERVISOR.
- 28.6. ALL LIGHTING RELAYS SHALL BE LOCATED IN THE ELECTRICAL ROOM. PROVIDE NEW RELAY CABINET AS REQUIRED TO SUIT LAYOUT.
- 8.7. INSTALL OUTDOOR LIGHTING LUMINARIES TO BE CONTROLLED BY ASTRONOMICAL TIME-LOCK AND PHOTO SWITCH.
- 28.8. LIGHT STANDARD CONCRETE BASES, WHERE LIGHT STANDARD SPECIFIED, ARE TO BE PROVIDED BY GENERAL CONTRACTOR, WITH CONDUIT EMERGING FROM CENTER OF BASE.
- 28.9. LED LIGHT FIXTURES SHALL CARRY A MANUFACTURER WARRANTY FOR FIVE YEARS AT MINIMUM STARTING ONE DAY AFTER THE DATE OF THE FINAL CONTRACT ADMINISTRATOR'S CERTIFICATION LETTER.

### 29. EXIT LIGHTING AND EMERGENCY LIGHTING

- 29.1. PROVIDE NEW EXIT LIGHTS TO MATCH BUILDING STANDARD, EMERGENCY BATTERY UNITS, EMERGENCY REMOTE HEADS AND CONNECT LUMINARIES TO EMERGENCY LIGHTING CIRCUIT AS SHOWN ON THE DRAWINGS.
- 29.2. EMERGENCY BATTERY SHALL HAVE A FULL LOAD CAPACITY OF A PERIOD OF MINIMUM 30 MINUTES UNLESS IT IS SPECIFIED OTHERWISE ON THE DRAWINGS.
- 29.3. CHECK CIRCUIT LOADING OF ALL LIGHTING CIRCUITS AND EXIT LIGHTING CIRCUITS PRIOR TO CONNECTION. PROVIDE NEW CIRCUITS IF REQUIRED.
- 29.4. EMERGENCY LIGHTING SHALL BE INTERLOCKED WITH SPACE LIGHTING IN AREA OF SERVICE. PROVIDE VOLTAGE SENSING RELAY UNITS OR OTHER MEANS OF INTERLOCK ACCEPTABLE TO THE CONTRACT ADMINISTRATOR.

### 30. FIRE ALARM SYSTEM

- 30.1. PROVIDE NEW DEVICES OR RELOCATE EXISTING DEVICES AS SPECIFIED FOR A COMPLETE OPERATING FIRE ALARM SYSTEM AS REQUIRED BY CODE OR SHOWN ON THE DRAWINGS.
- 30.2. MANUAL PULL STATIONS WITH GLASS RODS USED AS PULL HANDLE RESTRAIN ARE NOT ACCEPTABLE.
- 30.3. LOCATE STROBE LIGHTS TO OBTAIN GREATEST VISIBILITY IN THE SPACE. USE ADDITIONAL STROBE LIGHTS TO ACHIEVE VISIBILITY.
- 30.4. USE LOOP ISOLATORS TO MAINTAIN/PROTECT THE CONTINUITY OF THE FIRE ALARM DETECTION CIRCUIT.
- 30.5. INSTALL FIRE ALARM DETECTORS IN THE OPTIMUM LOCATION TO ACHIEVE THE BEST DETECTION. 30.6. UPON COMPLETION OF SYSTEM MODIFICATIONS, ELECTRICAL CONTRACTOR TO HIRE BASE BUILDING
- 60.6. UPON COMPLETION OF SYSTEM MODIFICATIONS, ELECTRICAL CONTRACTOR TO HIRE BASE BUILDING FIRE ALARM CONTRACTOR TO PERFORM SYSTEM VERIFICATION, ENCOMPASSING ALL REVISIONS TO THE FIRE ALARM SYSTEM.
- 30.7. FIRE ALARM INSTALLATION TO COMPLY WITH CSA-S524-06 & VERIFIED TO CSA-S537-04.
- 30.8. INCLUDE AND PAY FOR INTEGRATED SYSTEMS TESTING OF ALL FIRE PROTECTION AND ALL LIFE SAFETY SYSTEMS IN THE CONTRACT PER CAN/ULC-S1001 INCLUDING PREPARATION OF TESTING PLAN. SUBMIT PLAN FOR CONTRACT ADMINISTRATOR'S REVIEW PRIOR TO TESTING COMMENCEMENT.
- 31. COMMUNICATION/DATA

- 31.1. PROVIDE OUTLET BOXES AND EMPTY CONDUITS WITH PULL STRING FOR COMMUNICATION OUTLETS AS SHOWN AND NOTED ON THE DRAWINGS.
- 31.2. INSTALL 1 INCH CONDUIT FROM EACH COMMUNICATION OUTLET -PHONE/CABLE/ETHERNET- TO COMMUNICATION BOARD/DEMARCATION POINT/NETWORK SERVER.
- 31.3. USE J-HOOKS IN ACCESSIBLE CEILING SPACES ONLY WHEN PERMITTED BY THE CONTRACT ADMINISTRATOR, USE CONDUITS IN CONCEALED SPACES OR TO PASS THROUGH PARTITIONS/WALLS.
- 31.4. WHERE WIRING IS INCLUDED IN CONTRACT, TESTING OF ALL WIRING SHALL BE DOCUMENTED AND PRESENTED TO THE CONTRACT ADMINISTRATOR UPON REQUEST.

### 32. EQUIPMENT IDENTIFICATION

- 32.1. PROVIDE COMPUTER PRINTED LABELS OR LAMACOID ENGRAVED PLATES IN INDUSTRY ACCEPTABLE STANDARDS TO THE SATISFACTION OF THE CONTRACT ADMINISTRATOR TO BE SUITABLE FOR INSTALLATION ENVIRONMENT.
- 32.2. IDENTIFICATION TO BE AFFIXED TO EQUIPMENT, PANELS, SAFETY AND DISCONNECT SWITCHES, TRANSFORMERS, PULL BOXES, TERMINAL CABINETS, BATTERY BANKS, RECEPTACLES, AND ALL OTHER EQUIPMENT ON THE DRAWINGS.
- 32.3. IDENTIFICATION WORDING TO BE APPROVED BY THE CONTRACT ADMINISTRATOR PRIOR TO PRINTING OR PRIOR TO ORDER.

#### 3. GENERAL

- 33.1. COORDINATE AND GET APPROVAL FROM BUILDING OWNER OR HIS REPRESENTATIVE FOR ALL CORING AND CUTTING OF BUILDING STRUCTURE. X—RAY AND COORDINATE LOCATION ON SITE PRIOR TO CORING
- 33.2. CLEAN UP AND REMOVE ALL UNUSED WIRING AND CONDUITS.
- 33.3. REWIRE EXISTING LIGHTING AND POWER THAT ARE AFFECTED BY THIS CONSTRUCTION.
- 33.4. ALLOW AFTER HOUR WORK AND PROVIDE TEMPORARY POWER AND LIGHTING TO SUIT CONSTRUCTIONS SCHEDULE AND PHASES.
- 33.5. CONFIRM OUTLET LOCATIONS AND MOUNTING HEIGHT WITH PROJECT COORDINATOR ON SITE PRIOR TO INSTALLATION.
- 33.6. FIRE PROOF ALL FIRE RATED PENETRATIONS AFTER INSTALLATION TO COMPLY WITH CODES AND TO PROVIDE EQUAL FIRE SEPARATION RATING.
- 33.7. ELECTRICAL EQUIPMENT INSTALLED IN SPRINKLERED BUILDING SHALL BE COMPLETE WITH DRIP PROOF HOOD.
- 33.8. ELECTRICAL CONTRACTOR TO REPAIR TO FULLY WORKING CONDITION ANY ELECTRICAL INSTALLATION AFFECTED BY THIS CONTRACT (FOR WORK IN OR ADJACENT TO EXISTING BUILDINGS.)
- 33.9. INSTALL BASEBOARD HEATERS 4" ABOVE FINISH FLOOR LEVEL.
- 33.10.SUPPLY & INSTALL 3/4" PLYWOOD C/W FIRE RETARDANT PAINT BEHIND ELECTRICAL PANEL & FOR COMMUNICATION BOARD. INCLUDE PAINT MANUFACTURER CERTIFICATE OF COMPLIANCE AS PART OF O&M MANUAL
- 33.11.ELECTRICAL CONTRACTOR TO SUPPLY & INSTALL PAINT & MUD PROTECTION FOR ELECTRICAL ROUGH—IN INSTALLATIONS INCLUDING WIRES, BOXES, AND THE LIKE.
- 33.12.INSTALL ELECTRICAL WIRING AND CONNECTIONS FOR POWER DOOR OPERATORS AS SPECIFIED ON PROJECT DRAWINGS. COORDINATE WITH MANUFACTURER AND SUPPLIER.
- 33.13.CAULK ALL PENETRATIONS IN ASSEMBLIES USED FOR ELECTRICAL INSTALLATION TO RESTORE COMPARABLE FINISH AND TO THE SATISFACTION OF THE CONTRACT ADMINISTRATOR.

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CLIENT: BRIDGMAN COLLABORATIVE ARCHITECTURE 678 MAIN STREET WINNIPEG, MB R3B 1E4 (204)488-3857

PROJECT TITLE: LOO

LOO LOO WINNIPEG
715 MAIN ST., WINNIPEG, MB
BID OPPORTUNITY 54-2021

SHEET TITLE:
INSTALLATION SPECIFICATIONS—PART 2

DESIGNED BY: AK

SHEET NO:

201231 DRAWN BY: AK
REVIEWED BY: AK

PROJECT NO

### **GENERAL NOTES**

- 1. THIS SET OF DRAWINGS SHOWS THE COMPLETED PROJECT. IT IS TO BE READ IN CONJUNCTION WITH THE NON-STRUCTURAL DRAWING SETS. IT DOES NOT INCLUDE COMPONENTS THAT MAY BE NECESSARY FOR CONSTRUCTION SAFETY. THE CONTRACTOR IS RESPONSIBLE FOR SAFETY IN AND ABOUT THE JOB SITE DURING CONSTRUCTION, AND THE DESIGN AND ERECTION OF ALL TEMPORARY STRUCTURES. FORM WORK, FALSE WORK, SHORING, ETC. REQUIRED TO COMPLETE THE WORK.
- 2. THE USE OF THESE DRAWINGS IS LIMITED TO THAT IDENTIFIED IN THE REVISIONS COLUMN. DO NOT CONSTRUCT FROM THESE DRAWINGS UNLESS MARKED "ISSUED FOR CONSTRUCTION" IN THE REVISIONS COLUMN BY CONTRACT ADMINISTRATOR.
- 3. THE INFORMATION ON THIS DRAWING SHALL NOT BE USED FOR ANYTHING OTHER THAN THE SPECIFIED WORKS OR PART OF THE WORKS FOR WHICH IT HAS BEEN AUTHORIZED BY CONTRACT ADMINISTRATOR.
- 4. SEE ARCHITECTURAL DRAWINGS FOR FLOOR AND ROOF ELEVATIONS, RECESSES, DRAINAGE SLOPES, DETAILED DIMENSIONS FOR DOORS, WINDOWS AND OTHER OPENINGS ETC.
- 5. SEE ARCHITECTURAL, MECHANICAL, AND ELECTRICAL DRAWINGS FOR SLEEVES, NAILERS, INSERTS, ETC. TO BE ENCASED IN CONCRETE.
- 6. THE CONTRACTOR SHALL REVIEW ALL THE DRAWINGS AND CHECK DIMENSIONS BEFORE CONSTRUCTION. REPORT DISCREPANCIES BETWEEN STRUCTURAL AND OTHER DISCIPLINES DRAWINGS FOR CLARIFICATION.
- 7. THE CONTRACTOR SHALL REPORT ANY SITE MODIFICATIONS MADE DURING CONSTRUCTION, THAT DIFFER FROM THE STRUCTURAL DRAWINGS, TO CONTRACT ADMINISTRATOR FOR REVIEW
- 8. DO NOT CUT OR DRILL ANY OPENINGS IN STRUCTURAL MEMBERS WITHOUT THE WRITTEN PERMISSION OF CONTRACT ADMINISTRATOR. CONTRACTOR TO PROVIDE APPROPRIATE ATTACHMENTS AND CONNECTIONS FOR MECHANICAL, ELECTRICAL, AND OTHER SERVICES WITHOUT CUTTING OR DRILLING.
- REFER TO ARCHITECTURAL, MECHANICAL, ELECTRICAL DRAWINGS FOR LOCATIONS, CONFIGURATIONS, EXTENT, AND SIZES OF ALL CURBS, UPSTANDS, DOWNTURNS: AND FOR OPENINGS THROUGH FLOORS AND WALLS FOR DUCTS.
- 10. FIRE RESISTANCE RATINGS: SEE ARCHITECTURAL DRAWINGS AND SPECIFICATION FOR PRECISE LOCATIONS OF REQUIRED FIRE RESISTANCE RATINGS.
- 11. THE CONTRACTOR SHALL BE FAMILIAR WITH THE CONTENT AND RECOMMENDATIONS OF THE GEOTECHNICAL REPORTS.
- 12. THE CONTRACTOR SHALL SUBMIT SHOP DRAWINGS FOR ALL STRUCTURAL COMPONENTS TO CONTRACT ADMINISTRATOR FOR REVIEW PRIOR TO FABRICATION. SHOP DRAWINGS ARE TO INCLUDE SEAL AND SIGNATURE OF A PROFESSIONAL ENGINEER, REGISTERED IN THE PROJECT PROVINCE, FOR DESIGN OF COMPONENTS AND/OR CONNECTIONS AS REQUIRED.

### OWNERSHIP AND COPYRIGHT RESERVED

1. ALL DRAWINGS, PLANS, MODELS, DESIGNS, SPECIFICATIONS AND OTHER DOCUMENTS PREPARED BY CONTRACT ADMINISTRATOR AND USED IN CONNECTION WITH THE PROJECT ARE INSTRUMENTS OF SERVICE FOR THE EXECUTION OF THE PROJECT, AND ARE AND REMAIN THE PROPERTY OF CONTRACT ADMINISTRATOR, WHETHER THE PROJECT IS EXECUTED OR NOT, AND CONTRACT ADMINISTRATOR RESERVES THE COPYRIGHT THEREIN AND IN THE WORK EXECUTED THEREFROM: SHALL NOT BE USED FOR ANY OTHER PROJECT. EXCEPT ONLY FOR GENERAL REFERENCE PURPOSES FOR ADDITION OF ALTERATION TO THE WORK SHOWN IN THEM, AND SINCE SUCH DOCUMENTS ARE "DESIGN" DOCUMENTS ONLY AND MAY NOT REPRESENT THE ACTUAL PROJECT "AS CONSTRUCTED", USE OF THESE DOCUMENTS FOR GENERAL REFERENCE PURPOSES IS AT THE SOLE RISK OF THE PARTY USING THEM: THEY SHALL NOT BE COPIED WITHOUT THE WRITTEN CONSENT OF AN AUTHORIZED REPRESENTATIVE OF CONTRACT ADMINISTRATOR.

### LIST OF STRUCTURAL DRAWINGS

Sheet No.	Sheet Name	Sheet No.	Sheet Name
S001	GENERAL NOTES - PAGE 1	S301	BUILDING SECTIONS
S002	GENERAL NOTES - PAGE 2	S302	SECTION - GRID A INTERIOR
S101	FOUNDATION FRAMING PLAN	S303	SECTION - GRID B - MECH.
S102	MAIN FLOOR FRAMING PLAN	S304	SECTION - GRID B - SINKS
S103	SECOND LEVEL FRAMING PLAN	S305	SECTION -GRID C - OFFICE
S104	THIRD LEVEL FRAMING PLAN	S401	SECTIONS AND DETAILS
S105	ROOF FRAMING PLAN	S402	SECTIONS AND DETAILS
S106	SITE CONCRETE PLAN	S403	SECTIONS AND DETAILS
S201	NORTH ELEVATION	S901	SECTIONS AND 3D DETAILS
S202	SOUTH ELEVATION	S902	3-D DETAILS
S203	EAST AND WEST ELEVATIONS		

### **ABBREVIATIONS**

ALT	ALTERNATE
BOT	воттом
BR	BRACKET
BTW	BETWEEN
B/W	BOTH WAYS
BLL	BOTTOM LOWER LAYER
BUL	BOTTOM UPPER LAYER
C/W	COMPLETE WITH
CL	CENTRELINE
C/C	CENTRE TO CENTRE
CIP	CAST IN PLACE
CMU	CONCRETE MASONRY UNIT
DL	DEAD LOAD
LL	LIVE LOAD
SL	SNOW LOAD
E/E	EACH END
E/F	EACH FACE
E/S	EACH SIDE
E/W	EACH WAY
H1E	HOOK ONE END
H2E	HOOK TWO ENDS
H & V	HORIZONTAL AND VERTICAL
HOR	HORIZONTAL

GALV	HOT DIPPED GALVANIZED
MAX.	MAXIMUM
MIN.	MINIMUM
N.T.S.	NOT TO SCALE
O/C	ON CENTER
R/W	REINFORCED WITH
S.D.L.	SUPERIMPOSED DEAD LOAD
SIM.	SIMILAR
S.O.G.	SLAB ON GRADE
STAG.	STAGGER
S.J.	STRUT JOIST
TLL	TOP LOWER LAYER
TUL	TOP UPPER LAYER
TYP.	TYPICAL
T/O	TOP OF
T1E	TIE ONE END
T & B	TOP AND BOTTOM
T & C	TENSION AND COMPRESSION
U.N.O.	UNLESS NOTED OTHERWISE
U/S	UNDER SIDE OF
VERT.	VERTICAL
OSF	OUTSIDE FACE
ISF	INSIDE FACE


### SYMBOL LEGEND




SECTION MARKER (MEANS SECTION # SHOWN ON DRAWING SHEET S#)



PLAN DETAIL REFERENCE MARKER (MEANS DETAIL # SHOWN ON DRAWING SHEET S#)

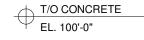

ELEVATION REFERENCE MARKER

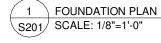


DRAWING SHEET REFERENCE MARKER



NORTH ARROW REFERENCE MARKER



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### 715 MAIN STREET PUBLIC TOILET

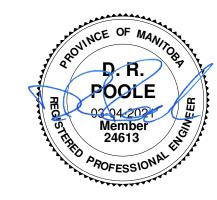THE CITY OF WINNIPEG

**BID OPPORTUNITY 54-2021** 

No.	Description	Date
1	ISSUED FOR CONSTRUCTION	21-03-04

GENERAL	NOTES -	- PAGF 1
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Project number	20-104	
Date	2021-03-04	S001
Drawn by	DP	
Checked by	DP	Scale 1:100

### **DESIGN CRITERIA**

THE DESIGN OF THE STRUCTURE IS IN ACCORDANCE WITH PART 4 OF DIVISION B, NBCC 2010 AND THE 2011 MANITOBA BUILDING CODE AMENDMENTS.

IMPORTANCE CATEGORY NORMAL

SNOW DESIGN DATA Ss = 1.9 kPa Sr = 0.2 kPa Is = 1.0 ULS / 0.9 SLS

WIND DESIGN DATA 0.45 kPa q(1/50) 0.35 kPa q(1/10) lw = 1.0 ULS / 0.75 SLS

SITE CLASSIFICATION FOR SEISMIC SITE RESPONSE: SÍTE NOT CLASSIFIED, SEISMIC DESIGN NOT REQUIRED DUE TO MB CODE AMMENDMENT

REFER TO PLANS FOR DESIGN LOADING

CONTRACTOR TO ENSURE THAT CONSTRUCTION LOADS DO NOT EXCEED DESIGN LOADS.

### STRUCTURAL MOVEMENTS/ TOLERANCES

- THIS STRUCTURE WILL UNDERGO NORMAL TYPES OF MOVEMENT AND DEFLECTION AND THE NON-STRUCTURAL COMPONENTS MUST BE DETAILED TO ACCOMMODATE THIS.
- DRYWALL PARTITIONS, MECHANICAL EQUIPMENT, ELECTRICAL EQUIPMENT, BUILDING FIXTURES, GLAZING AND CURTAIN WALLS
  MUST BE DETAILED AND INSTALLED TO ACCOMMODATE SLAB MOVEMENT.
- ALL STRUCTURES ARE SUBJECT TO CONSTRUCTION TOLERANCES. THIS SHOULD BE ALLOWED FOR IN DETAILING NON-STRUCTURAL COMPONENTS.

### NON-STRUCTURAL ELEMENTS

- . "NON-STRUCTURAL" OR "SECONDARY STRUCTURAL" ELEMENTS ARE NOT THE RESPONSIBILITY OF STRUCTURAL ENGINEER. THEY ARE DESIGNED, DETAILED, AND REVIEWED IN THE FIELD BY OTHERS. THEY APPEAR ON DRAWINGS OTHER THAN THE STRUCTURAL ENGINEER. WHERE STRUCTURAL ENGINEERING RESPONSIBILITY IS REQUIRED FOR THESE ELEMENTS, THIS SHALL BE PROVIDED BY SPECIALTY STRUCTURAL ENGINEERS, WHO SHALL ALSO PROVIDE ANY CERTIFICATION REQUIRED BY BUILDING PERMIT AUTHORITIES. SPECIALTY STRUCTURAL ENGINEERS ARE TO DESIGN THESE ELEMENTS ACCORDING TO THE APPLICABLE DESIGN LOADS AS NOTED IN PART 4 OF THE MOST CURRENT NBCC.
- 2. EXAMPLES OF NON-STRUCTURAL OR SECONDARY STRUCTURAL ELEMENTS INCLUDE, BUT ARE NOT LIMITED TO:
  - A. ARCHITECTURAL COMPONENTS SUCH AS GUARDRAILS, HANDRAILS, CEILINGS, MILLWORK ETC.
  - B. LANDSCAPE ELEMENTS SUCH AS BENCHES, LIGHT POSTS, PLANTERS, ETC.
  - C. CLADDING, GLAZING, WINDOW MULLIONS, INTERIOR STUD WALLS AND EXTERIOR STUD WALLS.
  - D. ARCHITECTURAL PRECAST, PRECAST CLADDING.
  - E. MECHANICAL AND ELECTRICAL EQUIPMENT, COMPONENTS, AND THEIR ATTACHMENT DETAILS.
  - F. ELEVATORS, ELEVATOR HOIST BEAMS, ESCALATORS, AND OTHER CONVEYING SYSTEMS.
  - G. BRICK OR BLOCK VENEERS AND THEIR ATTACHMENTS.
  - H. NON-LOAD BEARING MASONRY.
  - I. NON-STRUCTURAL CONCRETE TOPPINGS
  - J. ALUMINUM SKYLIGHTS.
  - K. STAIRS
- 3. SHOP DRAWINGS FOR NON-STRUCTURAL ELEMENTS WHICH MAY AFFECT THE PRIMARY STRUCTURAL SYSTEM SHALL BE SUBMITTED TO CONTRACT ADMINISTRATOR THESE DRAWINGS WILL BE REVIEWED ONLY FOR THE EFFECT ON THE PRIMARY STRUCTURAL SYSTEM.

### LUMBER

- FRAMING LUMBER SHALL CONFORM TO THE LATEST EDITION CSA 0141 AND SHALL BE OF THE FOLLOWING MINIMUM GRADES: LINTELS, JOISTS, AND BEAMS: S-P-F No.1/No.2, STUD WALLS: S-P-F No.1/No.2
- 2. ALL SHEATHING MATERIAL TO BE MIN 1/2" THICK PLYWOOD IN ACCORDANCE WITH LATEST EDITION CSA 0325 U.N.O. ALL SHEETS TO BE STAGGERED. FASTEN SHEETS WITH 3" COMMON NAILS AT 12" O/C ALONG ALL STUDS AND AT 6" O/C ALONG EDGES OF SHEET, U.N.O. STAPLES ARE NOT ACCEPTABLE. OSB FOR VERTICAL SHEATHING ONLY
- ALL FLOOR AND ROOF JOISTS TO BE NAILED AND GLUED AND TO HAVE CONTINUOUS CROSS BRIDGING AT 6'-0" MAX. SPACING U.N.O.
- 4. 48" WOOD BLOCKING FULL DEPTH CONTINUOUS FOR STUDS.
- 5. EDGE BLOCKING FOR PARALLEL WALLS AT 16", 32" AND 48" IN NEXT BAYS.
- 6. WOOD IN CRAWL SPACE OR IN CONTACT WITH STEEL, MASONRY OR CONCRETE IN ITS FINAL INSTALLED CONDITION IS TO BE PRESSURE TREATED U.N.O.
- 7. CONTINUOUS SILL GASKET REQUIRED AT JOIST BEARING POINTS ON CONCRETE.

### CONCRETE

- 1. ALL CONCRETE CONSTRUCTION, COLD WEATHER CONSTRUCTION & CONCRETE TESTING TO BE IN ACCORDANCE WITH THE LATEST EDITION CSA STANDARDS A23.1 AND A23.2.
- 2. ALL CONCRETE TO BE NORMAL WEIGHT HARD ROCK CONCRETE WITH A MINIMUM 28 DAY COMPRESSIVE STRENGTH AS NOTED IN TABLE 2 OF THE LATEST EDITION CSA A23.1.
- 3. CONCRETE CLASSES OF EXPOSURE (REFER TO TABLE 1, LATEST EDITION CSA A23.1):
- A. GARAGE SLAB ON GRADE, THICKENED SLAB EDGE CLASS C-2 EXPOSURE (32 MPa @28d)
- 4. CONCRETE SLUMP TO BE COORDINATED BETWEEN CONTRACTOR AND CONCRETE SUPPLIER CONSIDERING THE PERFORMANCE CRITERIA AND THE CONTRACTOR'S CRITERIA FOR CONSTRUCTION AND PLACEMENT.
- 5. CONCRETE SAMPLING AND TESTING TO BE COMPLETE IN ACCORDANCE WITH THE LATEST EDITION CSA A23.1/A23.2

### **REINFORCING**

- 1. REINFORCING STEEL SHALL BE GRADE 400 DEFORMED NEW BILLET STOCK CONFORMING TO THE LATEST EDITION OF CSA SPECIFICATION G30.18. WELDED WIRE MESH SHALL CONFORM TO THE LATEST EDITION CSA A23.1 CLAUSE 6.1.1.1.
- 2. CONCRETE COVER TO BE AS PER TABLE 17 OF THE LATEST EDITION CSA A23.1

	EXPOSURE CLASS		
			C-XL, C-1, C-3,
EXPOSURE CONDITION	N	F-1, F-2, S-1, S-2	A-1, A-2, A-3
CAST AGAINST AND PERMANENTLY EXPOSED TO EARTH	-	75mm	75mm
BEAMS, GIRDERS, COLUMNS, AND PILES	30mm	40mm	60mm
SLABS, WALLS, JOISTS	20mm	40mm	60mm


- 3. CONCRETE COVER FOR EXPOSURE CLASSES NOT NOTED ABOVE TO BE 40 mm.
- 4. TOP STEEL IN GRADE BEAMS TO BE SPLICED AT CENTER SPAN AND BOTTOM STEEL TO BE SPLICED OVER SUPPORTS. SPLICE LENGTHS:
  - A. TENSION ZONE SPLICE TO BE AVOIDED WHEREVER POSSIBLE, BUT IF REQUIRED, LENGTH SHOULD BE SPECIFIED BY SWP PROJECTS LTD..
    - B. COMPRESSION ZONE SPLICE SHOULD NOT BE LESS THAN 30 BAR DIAMETERS.
- 5. CONCRETE COVER FOR FIRE RATING REQUIREMENTS AS PER CURRENT EDITION OF NBCC

### **FOUNDATION - CAST IN PLACE SKIN FRICTION PILES**

- FOUNDATION DESIGN FOR HAS BEEN DONE IN ACCORDANCE WITH GEOTECHINCAL REPORT AS PREPARED BY TREK GEOTECHNICAL AND DATED JANUARY 27, 2021.
- 2. CONTRACTOR SHALL OBTAIN AND FAMILIARIZE THEMSELVES WITH THE REQUIREMENTS OF THE GEOTECHNICAL REPORT INCLUDING BUT NOT LIMITED TO SITE CLEANING AND GRUBBING, EXCAVATION AND PROTECTION TO SUB GRADE ELEVATION LEVEL, PROOF ROLLING OF SUB-GRADE, PLACEMENT AND COMPACTION OF GRANULAR BASE COURSES. SPECIFICALLY, REPORT PROVIDES INFORMATION ABOUT THE POTENTIAL PRESENCE OF OLD FOUNDATIONS / RUBBLE IN THE GENERAL PROJECT AREA AND THE NEED FOR THE USE OF STEEL SLEEVES DURING PILE INSTALLATION
- B. DESIGN HAS BEEN DONE ASSUMING ULS AND SLS SKIN FRICTION CRITERIA AS FOLLOWS:
- A. 0 TO 3m BELOW EXISTING GRADE 0 kPa
- B. 3 TO 7m BELOW EXISTING GRADE 8 kPa SLS / 10 kPa ULS
- C. 7 TO 11m BELOW EXISTING GRADE 7 kPa SLS / 8 kPA ULS



No. 6036 Expiry: April 30,2021

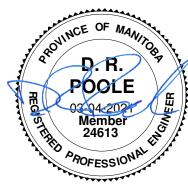



### 715 MAIN STREET PUBLIC TOILET


THE CITY OF WINNIPEG

**BID OPPORTUNITY 54-2021** 

No.	Description	Date
1	ISSUED FOR CONSTRUCTION	21-03-04

### **GENERAL NOTES - PAGE 2**

Project number	20-104	
Date	2021-03-04	S002
Drawn by	DP	
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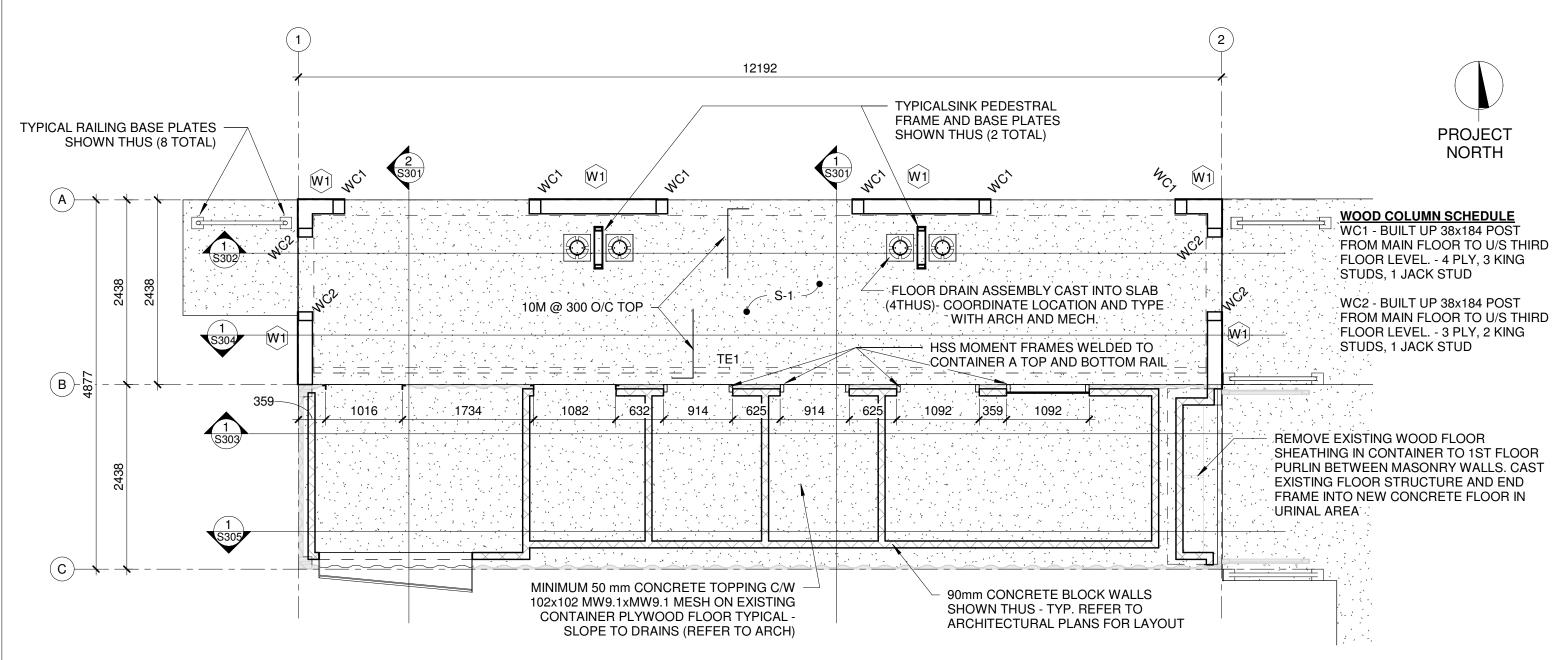
### 715 MAIN STREET PUBLIC TOILET

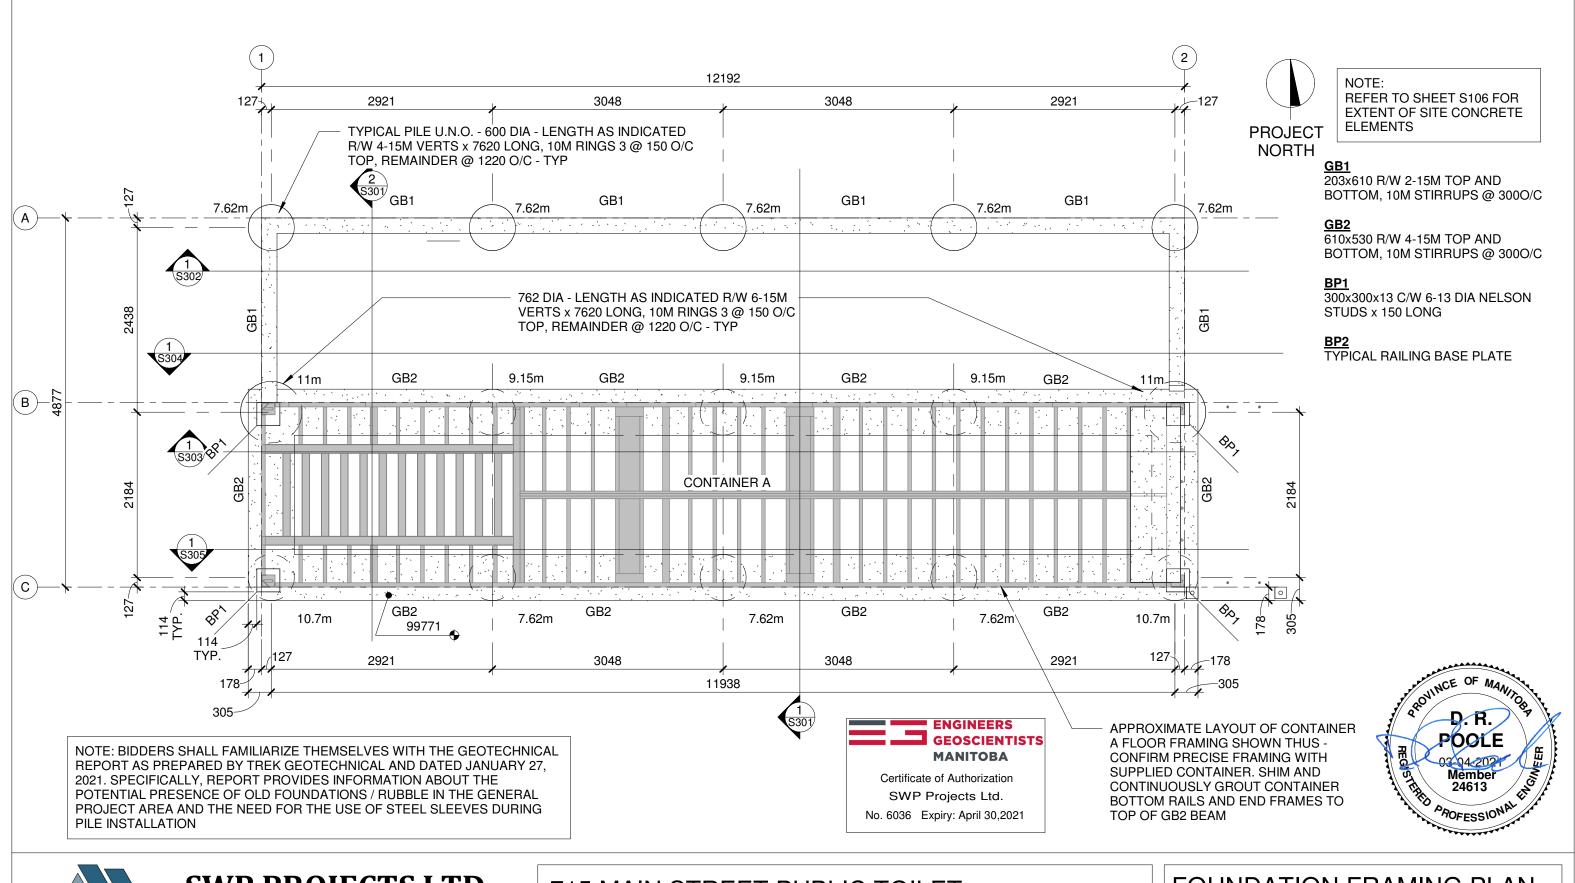THE CITY OF WINNIPEG

THE CITY OF WINNIPEG	No.	Description	Date
	1	ISSUED FOR CONSTRUCTION	21-03-04
BID OPPORTUNITY 54-2021			

### FOUNDATION FRAMING PLAN

Project number	20-104	
Date	2021-03-04	S101
Drawn by	DP	
Checked by	DP	Scale 1:50



**SPECIFIED DESIGN LOADS** 

LIVE LOAD 4.8 kPa
DEAD LOAD

150 CONCRETE SLAB ON VOID - 3.6 kPa
MINIMUM 50 CONCRETE TOPPING - 1.2 kPa
CONTAINER - TARE WEIGHT NOT TO EXCEED 4018 kg (9000 lb)

### S-1 SLAB

150 CONCRETE SLAB ON MINIMUM 150 VOID FORM R/W 10M @ 300 O/C EACH WAY BOTTOM, 10M L-DOWELS @ 300 O/C TOP FROM PERIMETER GRADE BEAM GRID A AND TE1 GRID B

### **TE1 THICKENED EDGE**

150x225 THICKENED EDGE R/W 1-15M TOP AND BOTTOM

### **WOOD WALL SCHEDULE**

W1 - 38x184 SPF NO. 2 OR BETTER STUDS @ 203 O/C FROM MAIN FLOOR TO U/S THIRD FLOOR LEVEL

W2 - 38x184 SPF NO. 2 OR BETTER STUDS @ 406 O/C INFILL WALL ABOVE GARAGE DOOR OPENINGS TO U/S THIRD FLOOR LEVEL

W3 - 38x140 SPF NO. 2 OR BETTER STUDS @ 406 O/C FROM THIRD FLOOR TO U/S ROOF JOISTS



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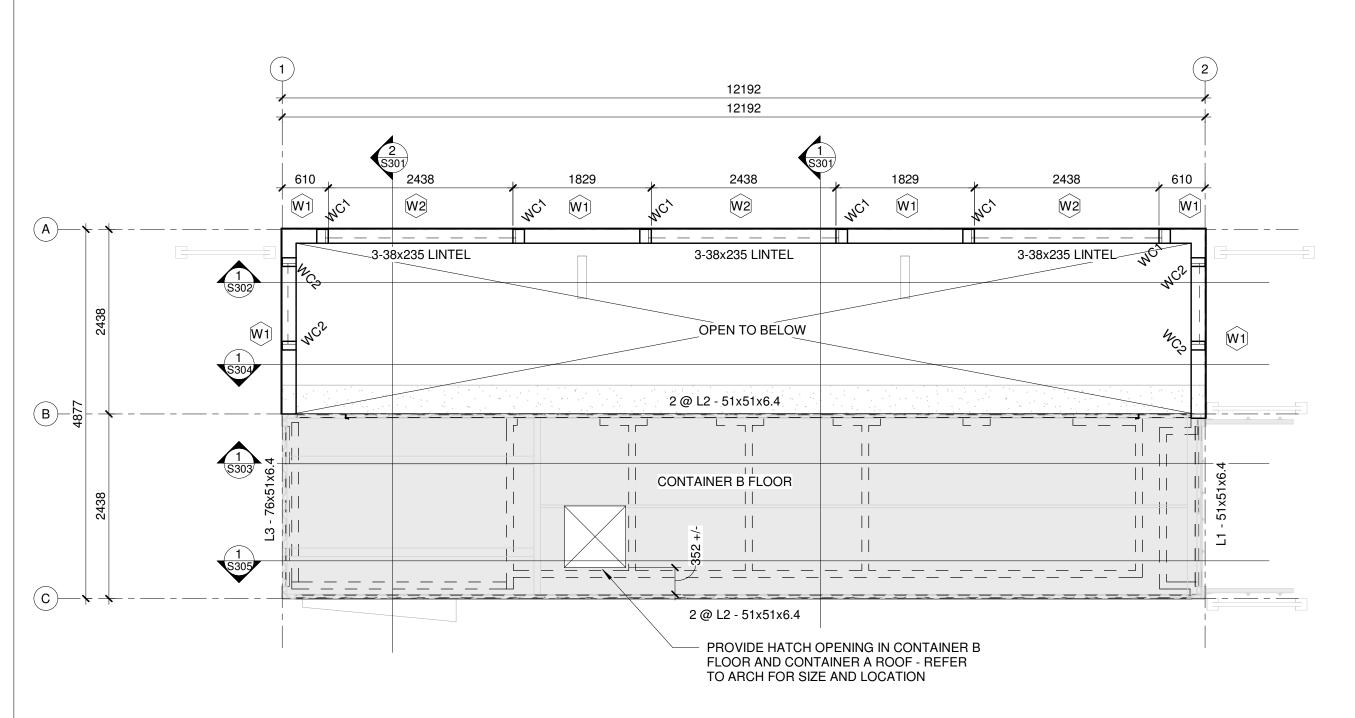
THE CITY OF WINNIPEG

**BID OPPORTUNITY 54-2021** 

No.	Description	Date
1	ISSUED FOR CONSTRUCTION	21-03-04

MAIN FLOOR FRAMIN	IG PLAN
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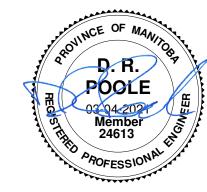
20-104	
2021-03-04	S102
DP	0.02
DP	Scale 1:50
	DP







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### **PLATE LEGEND**

PL1 - 150x200x13 CONTAINER STACK CONNECTOR PLATE WELDED TO CORNER CASTINGS

PL2 - 190x108x6.4 END FRAME OPENING CLOSURE

PL3 - 300x135x6.4 SIDE RAIL FORKLIFT TUNNEL CLOSURE

### **SPECIFIED DESIGN LOADS**

LIVE LOAD 3.6 kPa

DEAD LOAD

CONTAINER - TARE WEIGHT NOT TO EXCEED 4018 kg (9000 lb)

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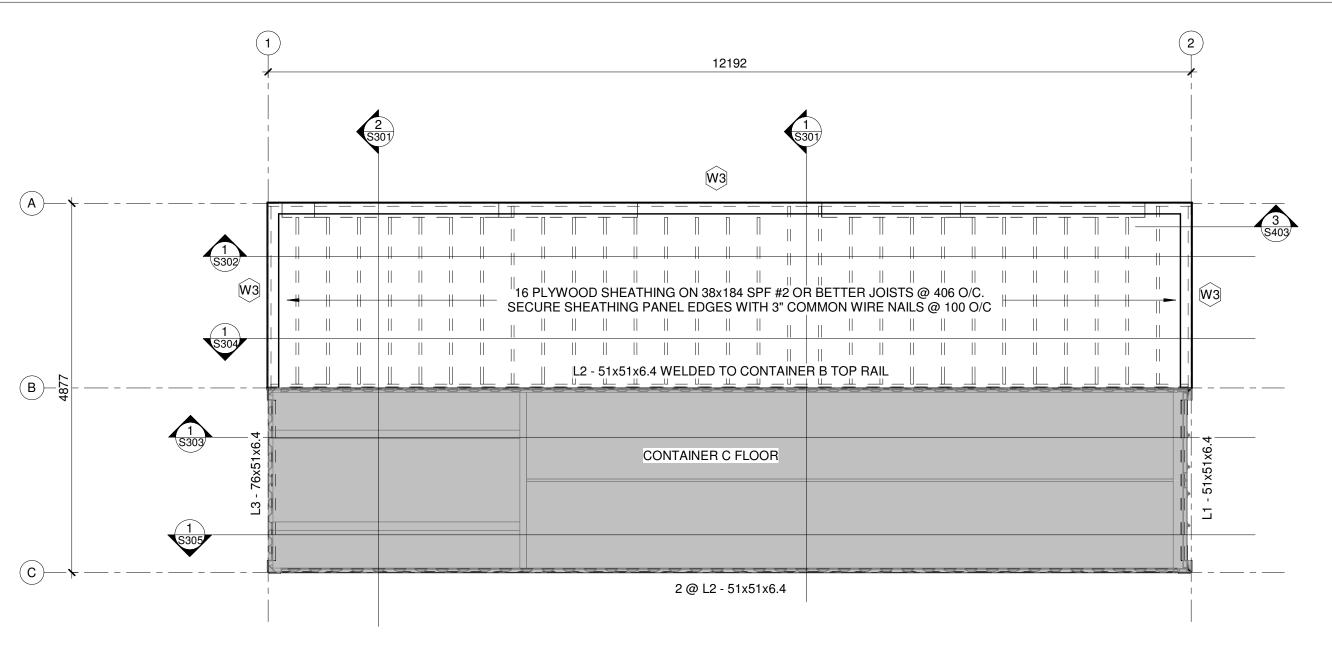
## 715 MAIN STREET PUBLIC TOILET

THE CITY OF WINNIPEG

**BID OPPORTUNITY 54-2021** 

Description Date ISSUED FOR CONSTRUCTION 21-03-04

SECOND LEVEL FRAMING				
PLAN	20-104	0.400		
Date	2021-03-04	S103		
Drawn by	DP			
Checked by	DP	Scale 1:50		






**PROJECT** NORTH

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**MANITOBA** 

### **SPECIFIED DESIGN LOADS**

LIVE LOAD 0.5 kPa (LIMITED ACCESSIBILITY ATTIC) DEAD LOAD CONTAINER - TARE WEIGHT NOT TO EXCEED 4018 kg (9000 lb) WOOD FLOOR/CEILING SYSTEM - 0.75 kPa



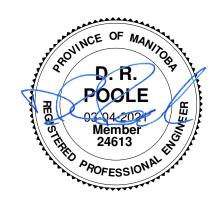

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### 715 MAIN STREET PUBLIC TOILET


THE CITY OF WINNIPEG

**BID OPPORTUNITY 54-2021** 


No. Description Date ISSUED FOR CONSTRUCTION 21-03-04

### THIRD LEVEL FRAMING PLAN

Project number	20-104	
Date	2021-03-04	S104
Drawn by	DP	
Checked by	DP	Scale 1:50

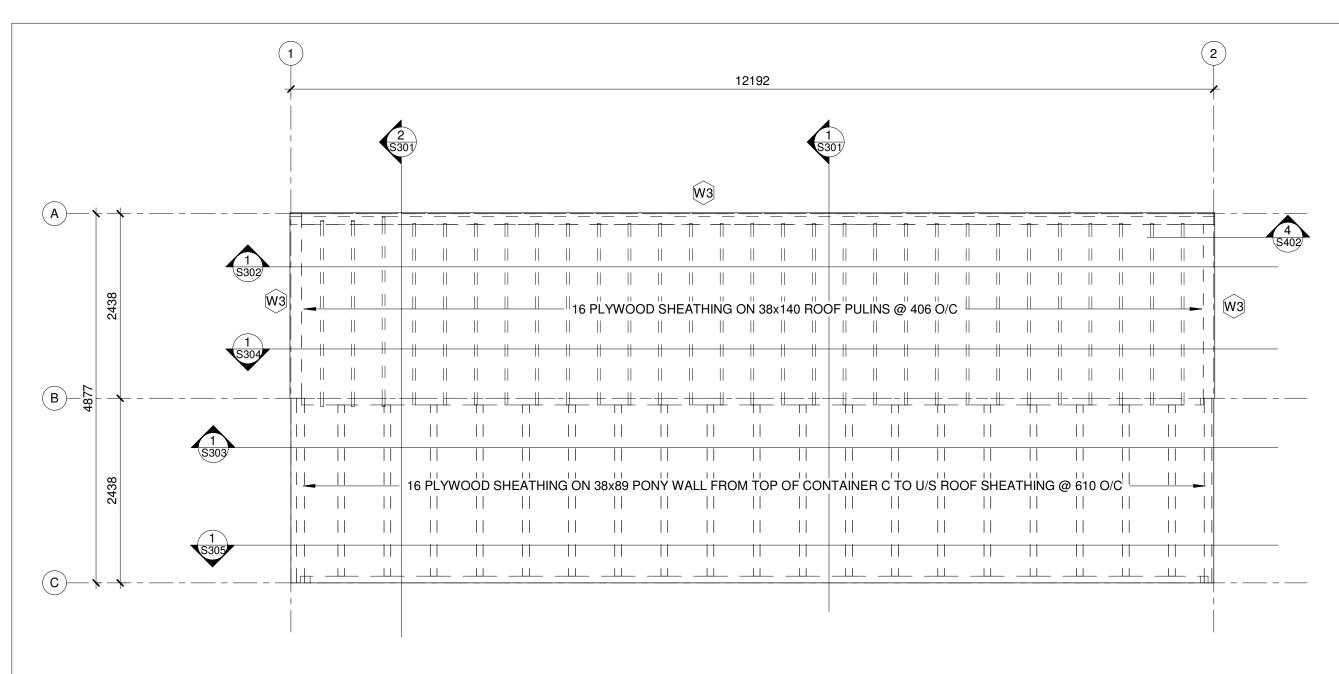

SPECIFIED DESIGN LOADS SNOW LOADS - 1.72 kPa ULS / 1.56 kPa SLS DEAD LOAD CONTAINER - TARE WEIGHT NOT TO EXCEED 4018 kg (9000 lb) WOOD ROOF SYSTEM - 0.5 kPa

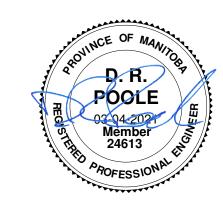

**PROJECT** NORTH



## **SWP PROJECTS LTD.**

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## 715 MAIN STREET PUBLIC TOILET


THE CITY OF WINNIPEG

**BID OPPORTUNITY 54-2021** 

No.	Description	Date

## **ROOF FRAMING PLAN**

Project number	20-104	0.4.0.
Date	2021-03-04	S105
Drawn by	Author	0.00
Checked by	Checker	Scale 1:50

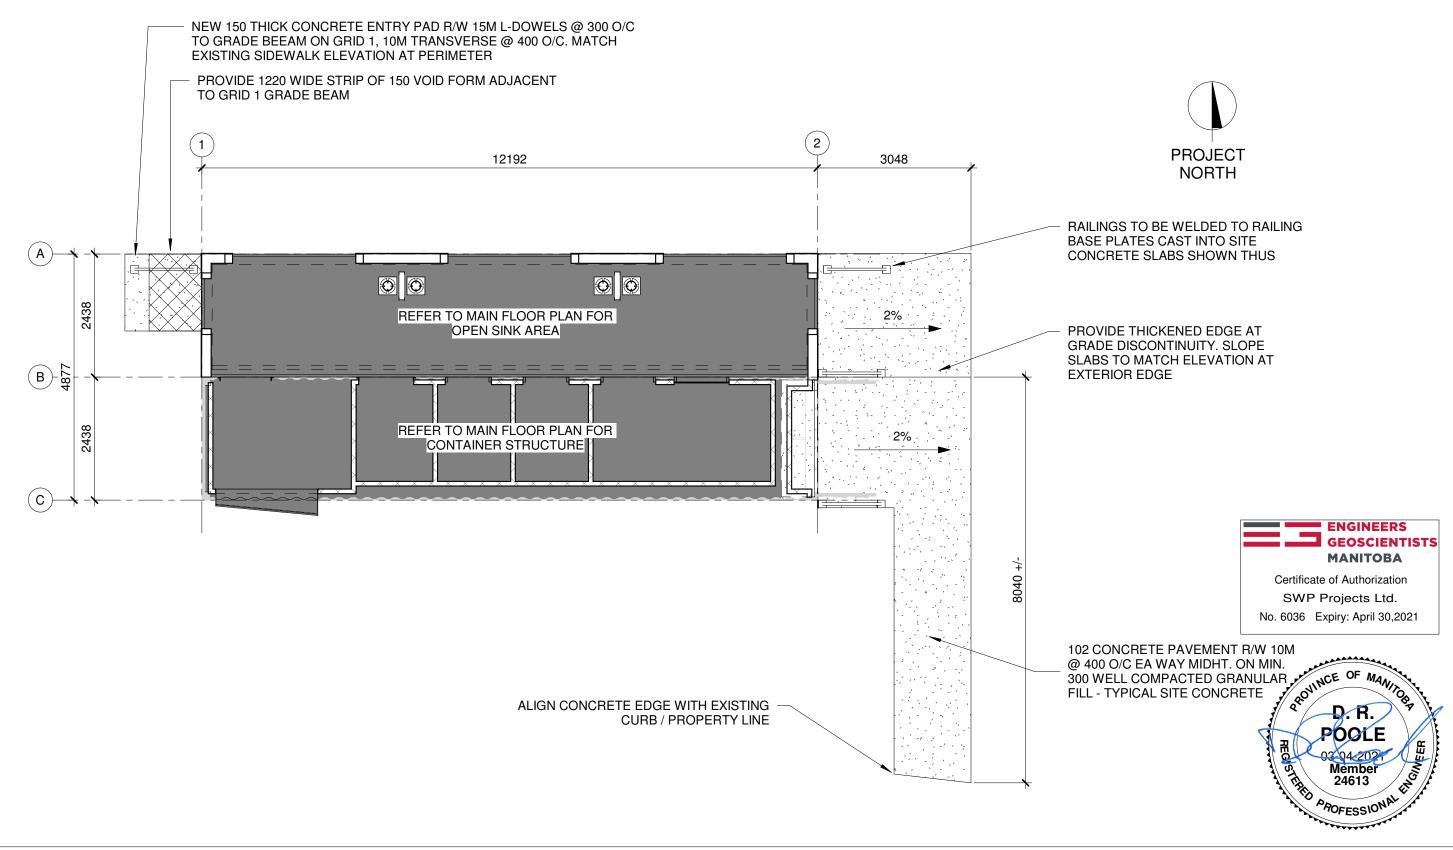



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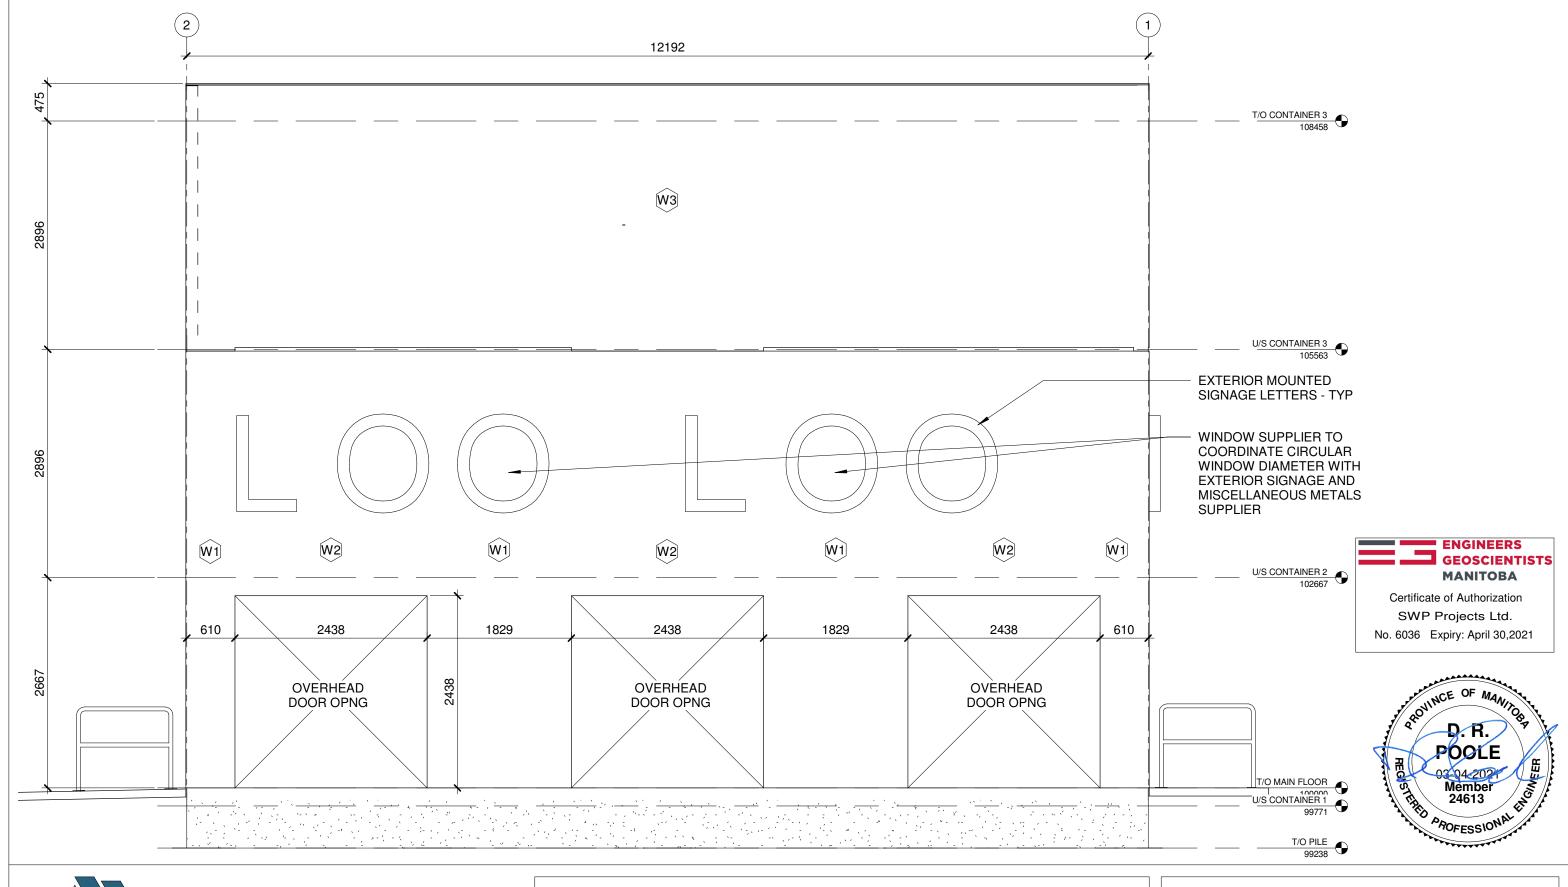
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### 715 MAIN STREET PUBLIC TOILET

THE CITY OF WINNIPEG	No.	Description	Date
	1	ISSUED FOR CONSTRUCTION	21-03-04
BID OPPORTUNITY 54-2021			

### SITE CONCRETE PLAN

Project number	20-104	0.4.0.0
ate	2021-03-04	S106
rawn by	DP	
Checked by	DP	Scale 1:75





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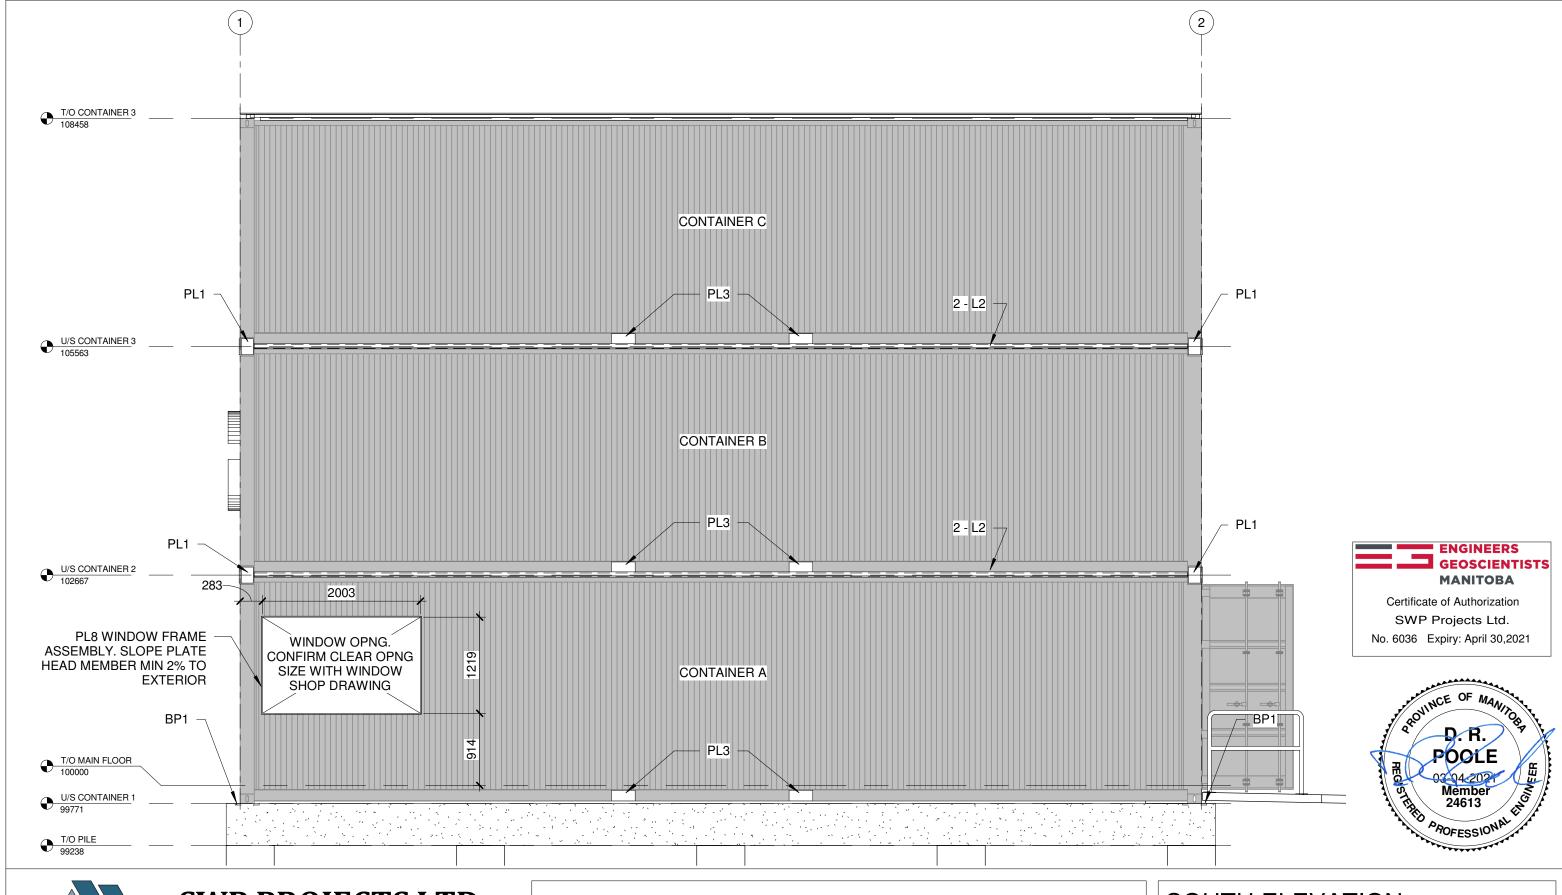
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### 715 MAIN STREET PUBLIC TOILET

THE CITY OF WINNIPEG	No.	Description	Date
	1	ISSUED FOR CONSTRUCTION	21-03-04
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BID OPPORTUNITY 54-2021			

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Project number	20-104	
Date	2021-03-04	S201
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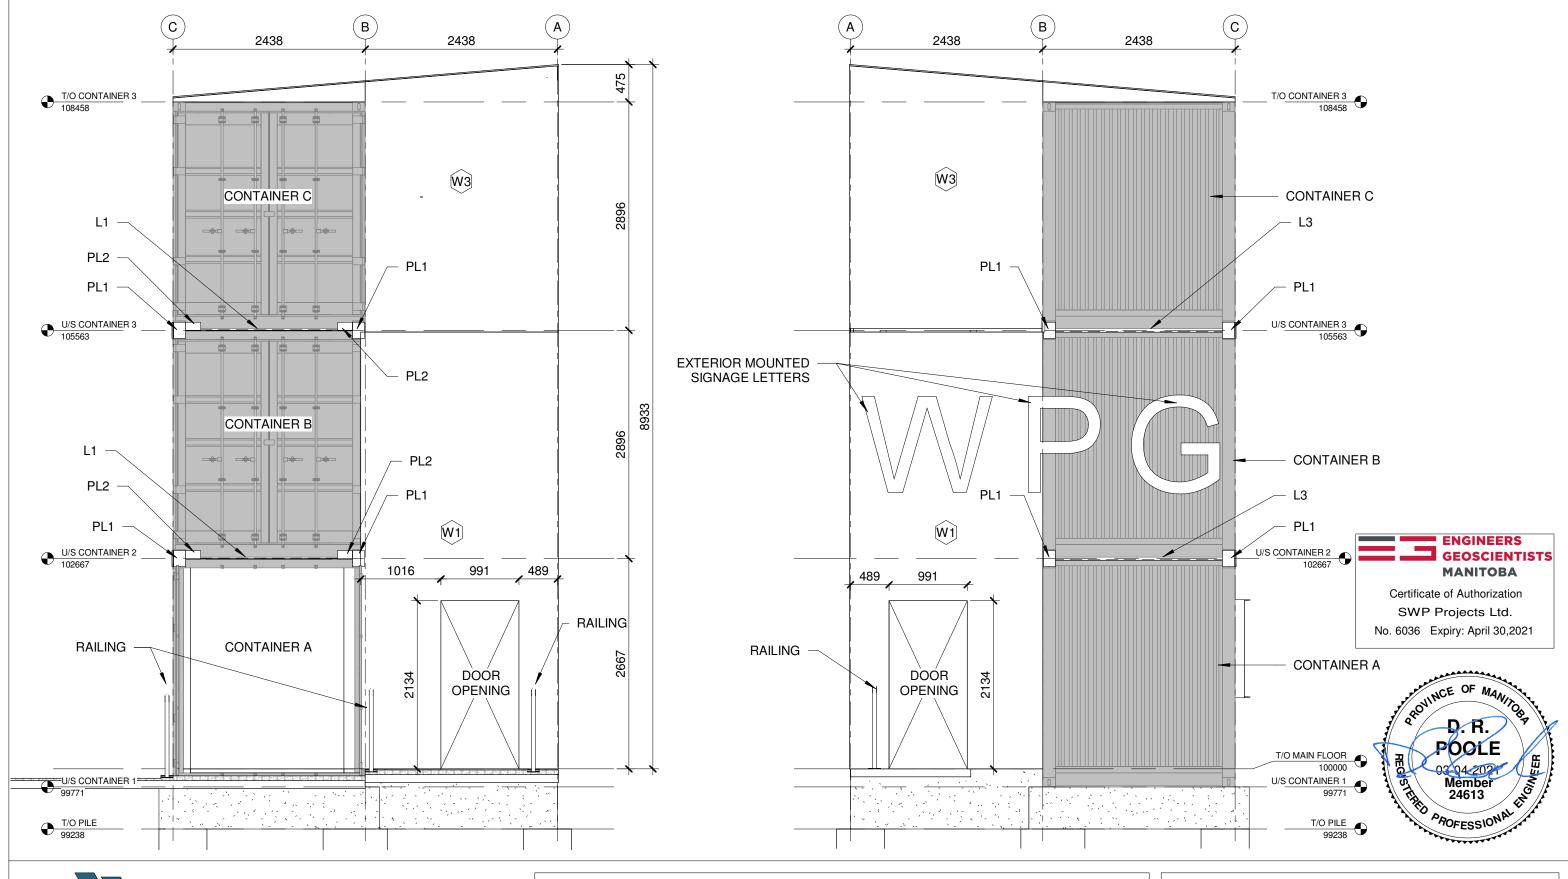
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## 715 MAIN STREET PUBLIC TOILET

THE CITY OF WINNIPEG Description Date ISSUED FOR CONSTRUCTION 21-03-04 **BID OPPORTUNITY 54-2021** 

## **SOUTH ELEVATION**

Project number	20-104	0000
Date	2021-03-04	S202
Drawn by	DP	0202
Checked by	DP	Scale 1 : 48





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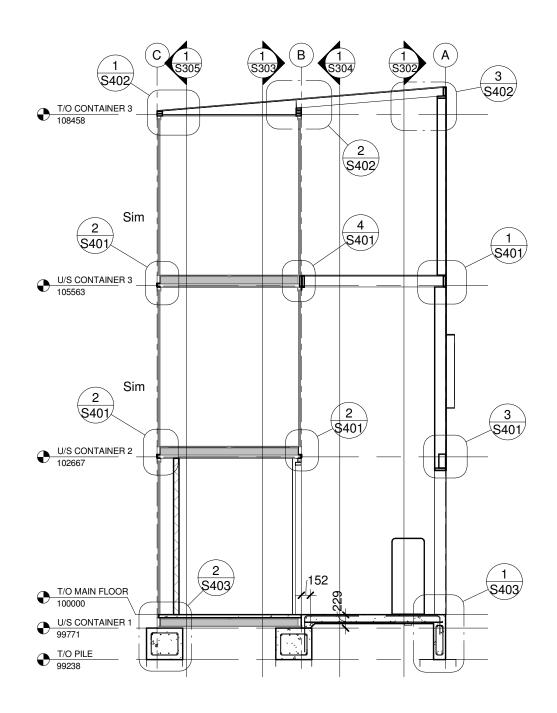
## 715 MAIN STREET PUBLIC TOILET

THE CITY OF


THE CITY OF WINNIPEG	No.	Description	Date
	1	ISSUED FOR CONSTRUCTION	21-03-04
BID OPPORTUNITY 54-2021			

## **EAST AND WEST ELEVATIONS**

Project number	20-104	0000
Date	2021-03-04	S203
Drawn by	DP	0_00
Checked by	DP	Scale 1 : 48






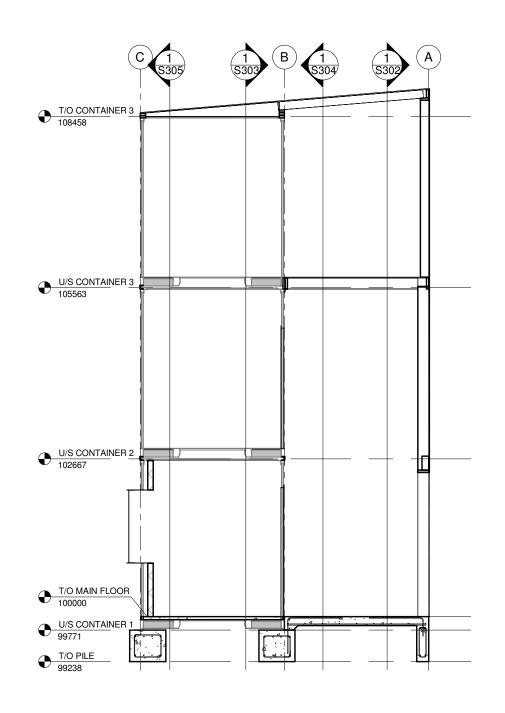





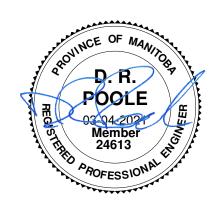

## **SWP PROJECTS LTD.** 678 MAIN STREET - 2ND FLR WINNIPEG, MB R3B 1E4

(P) 204.586.3636 (C) 204.330.2611


(É) david@totalprojectmgmt.ca

## 715 MAIN STREET PUBLIC TOILET

THE CITY OF WINNIPEG

THE CITY OF WINNIPEG	No.	Description	Date
	1	ISSUED FOR CONSTRUCTION	21-03-04
BID OPPORTUNITY 54-2021			

Project number	20-104	
Date	2021-03-04	S301
Drawn by	DP	
Checked by	DP	Scale 1 : 64

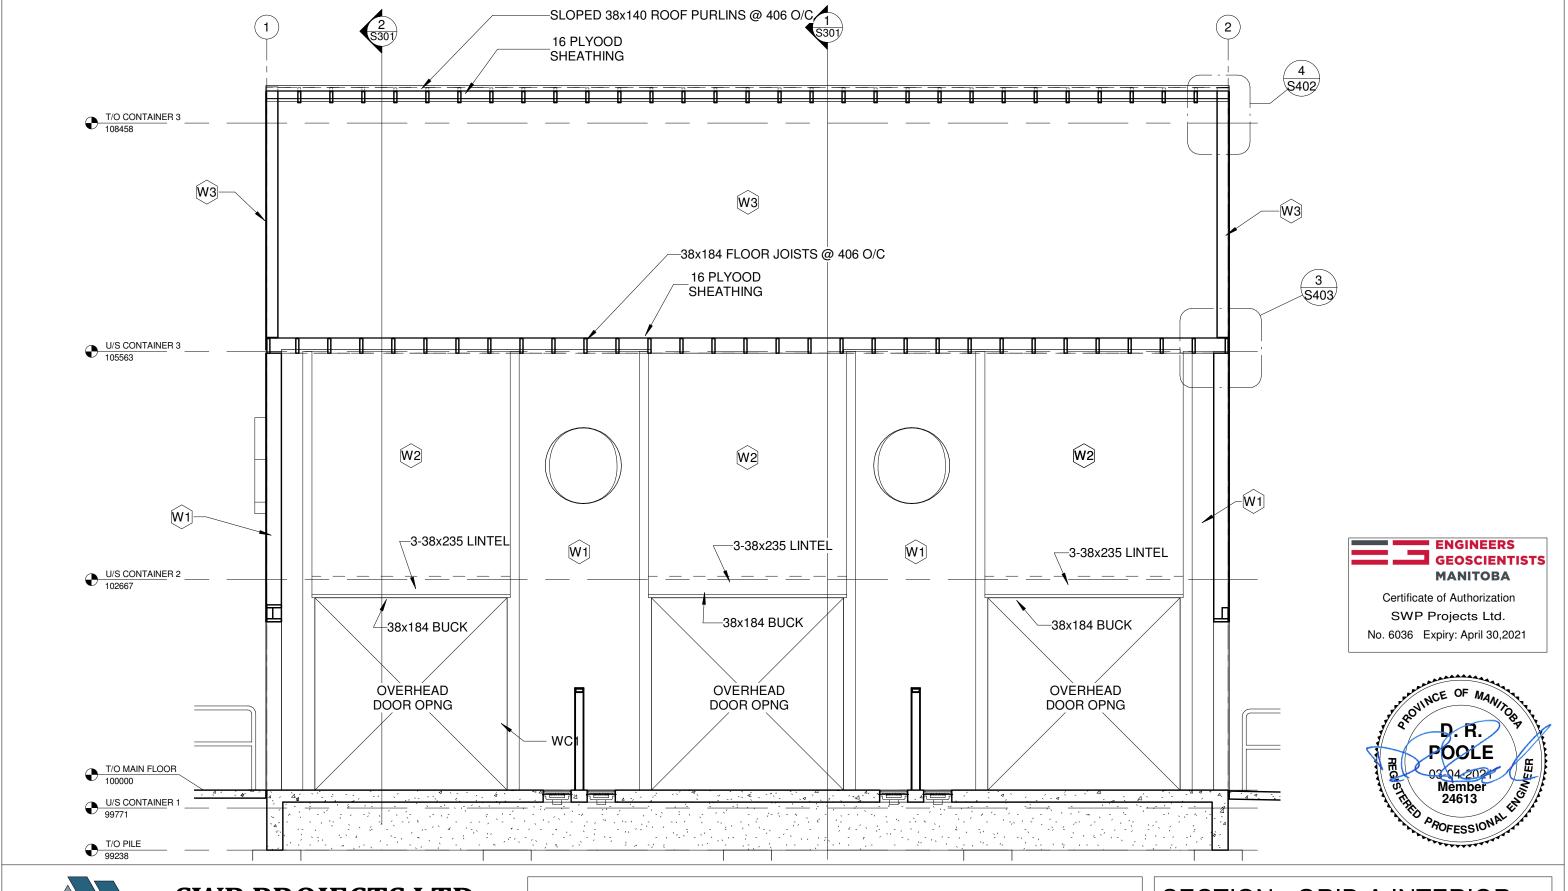



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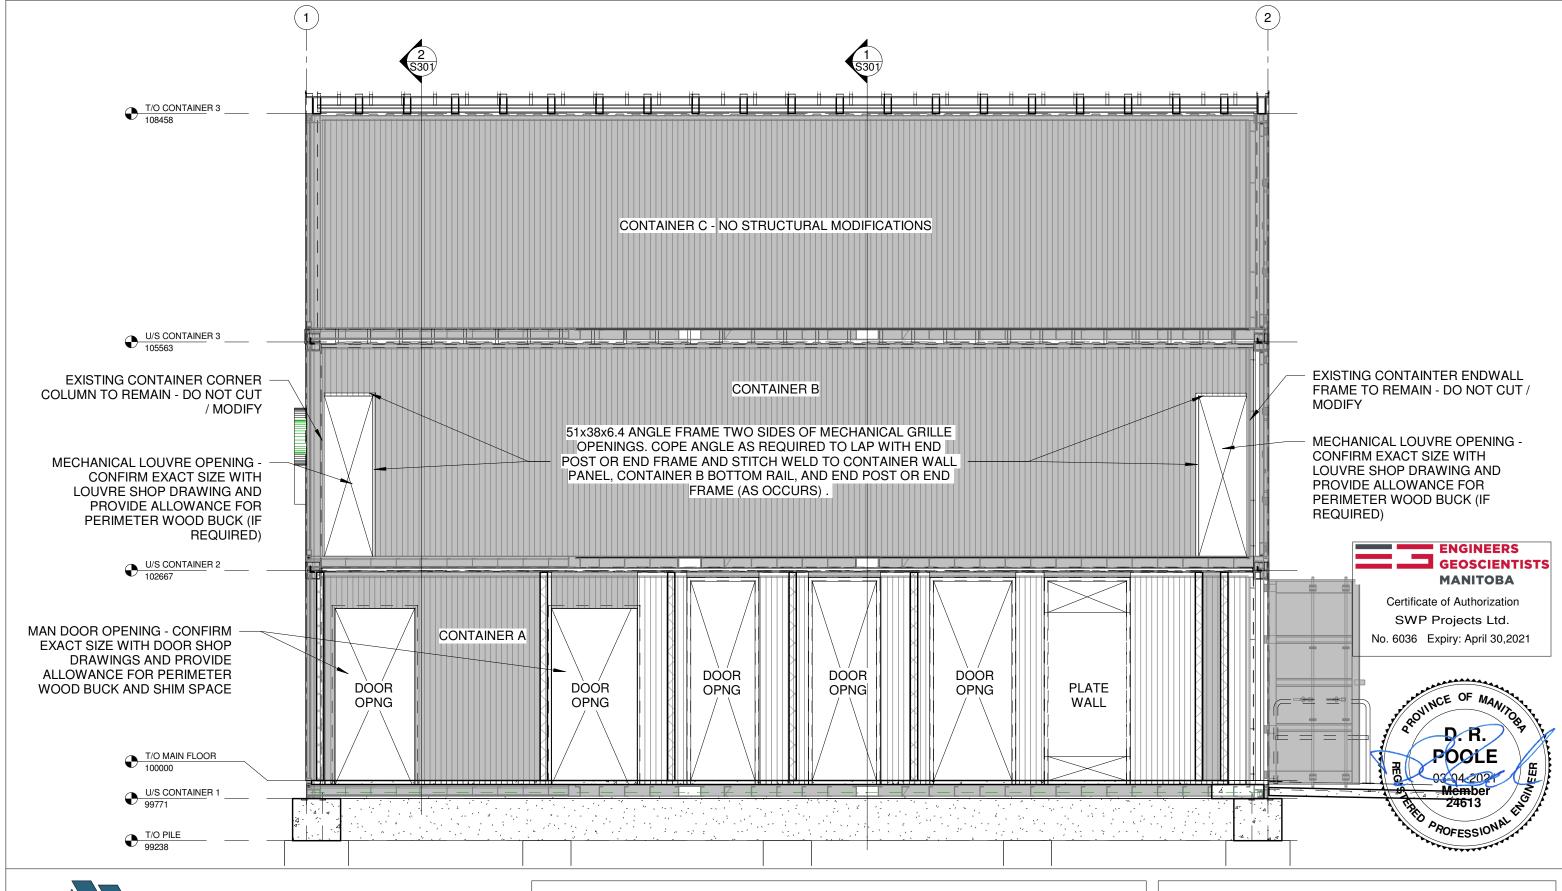
## 715 MAIN STREET PUBLIC TOILET

THE

THE CITY OF WINNIPEG	No.	Description	Date
	1	ISSUED FOR CONSTRUCTION	21-03-04
BID OPPORTUNITY 54-2021			

## **SECTION - GRID A INTERIOR**

Project number	20-104	
Date	2021-03-04	S302
Drawn by	DP	<b>333</b>
Checked by	DP	Scale 1:48





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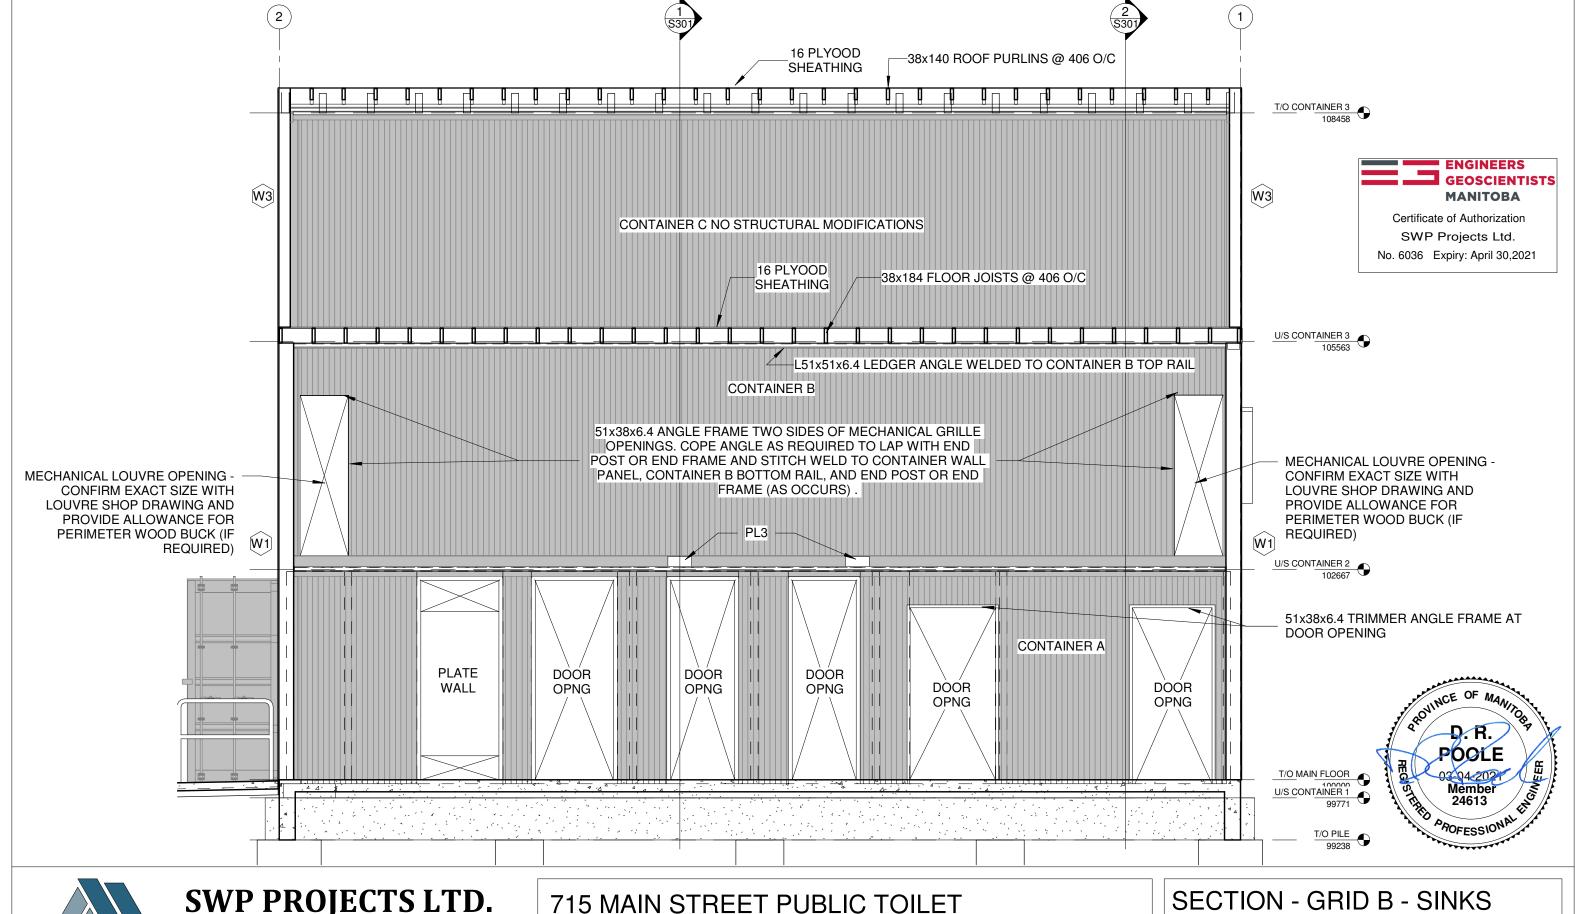
### 715 MAIN STREET PUBLIC TOILET

THE CITY OF WINNIPEG

No. Description Date ISSUED FOR CONSTRUCTION 21-03-04 **BID OPPORTUNITY 54-2021** 

### SECTION - GRID B - MECH.

Project number	20-104	
Date	2021-03-04	S303
Drawn by	DP	
Checked by	DP	Scale 1 : 48





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(P) 204.586.3636

(C) 204.330.2611


(É) david@totalprojectmgmt.ca

THE CITY OF WINNIPEG

**BID OPPORTUNITY 54-2021** 

No. Description Date ISSUED FOR CONSTRUCTION 21-03-04

Project number	20-104	
Date	2021-03-04	S304
Drawn by	DP	
Checked by	DP	Scale 1 : 48

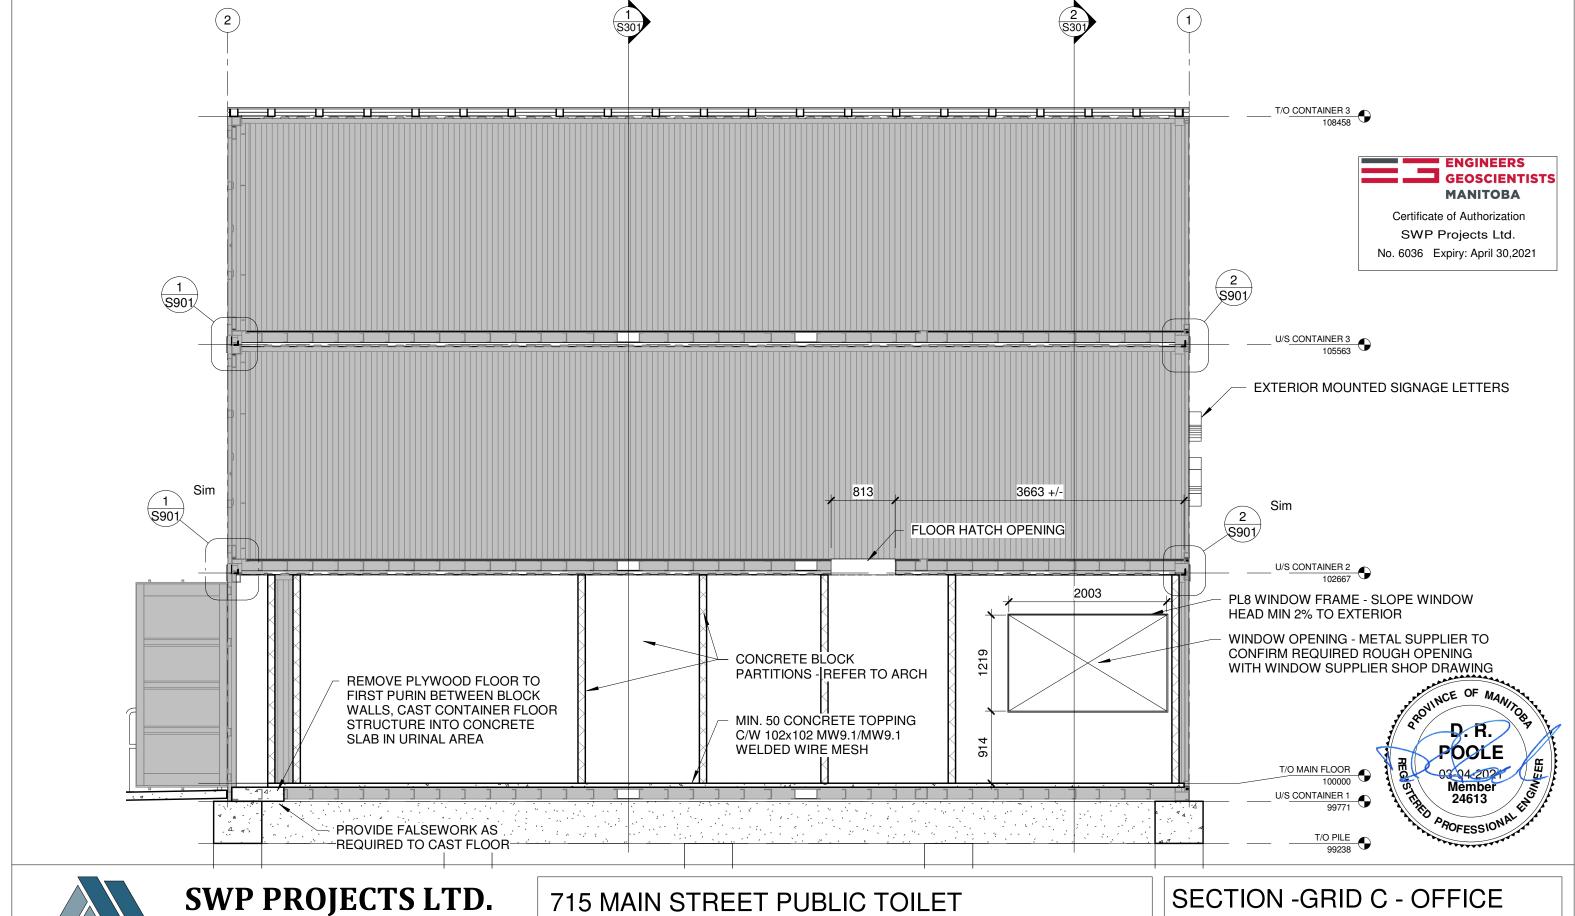

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(P) 204.586.3636


(C) 204.330.2611


(E) david@totalprojectmgmt.ca


THE CITY OF WINNIPEG

No. Description Date ISSUED FOR CONSTRUCTION 21-03-04 **BID OPPORTUNITY 54-2021** 

Project number	20-104	
Date	2021-03-04	S305
Drawn by	DP	
Checked by	DP	Scale 1 : 48

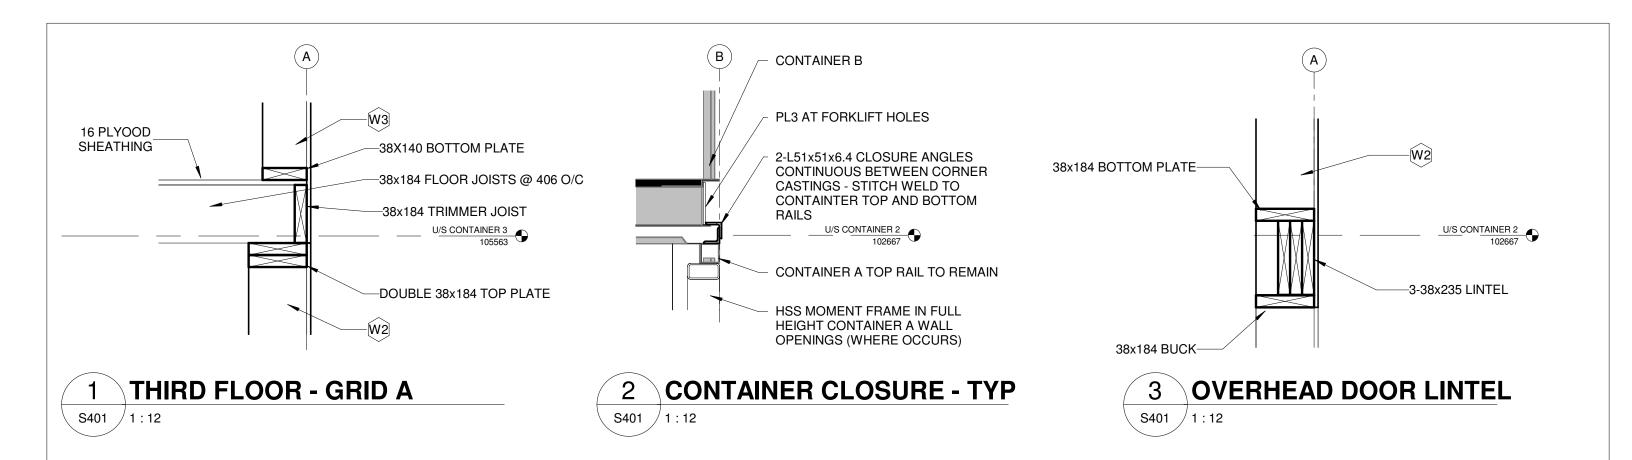

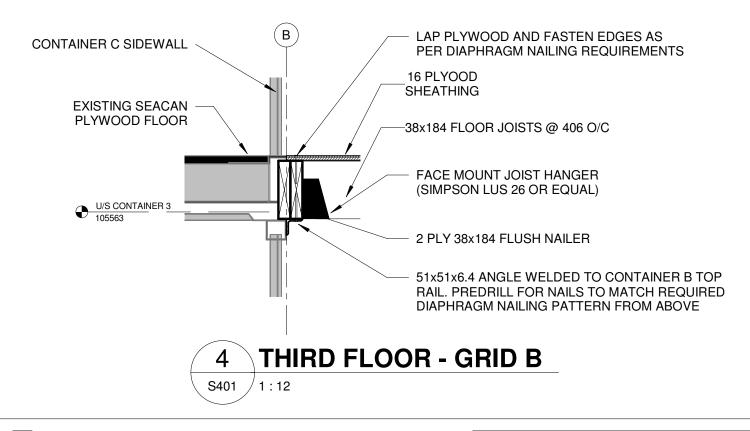

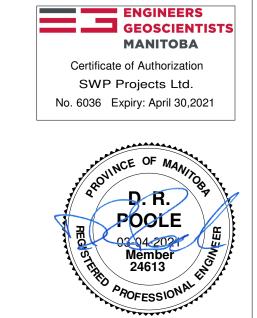



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(C) 204.330.2611

(E) david@totalprojectmgmt.ca


### 715 MAIN STREET PUBLIC TOILET

THE CITY OF WINNIPEG

No. Description Date ISSUED FOR CONSTRUCTION 21-03-04 **BID OPPORTUNITY 54-2021** 

SECTIONS		DETAILS	
	$\neg$		

Project number	20-104	0.404
Date	2021-03-04	S401
Drawn by	DP	
Checked by	DP	Scale 1 : 12

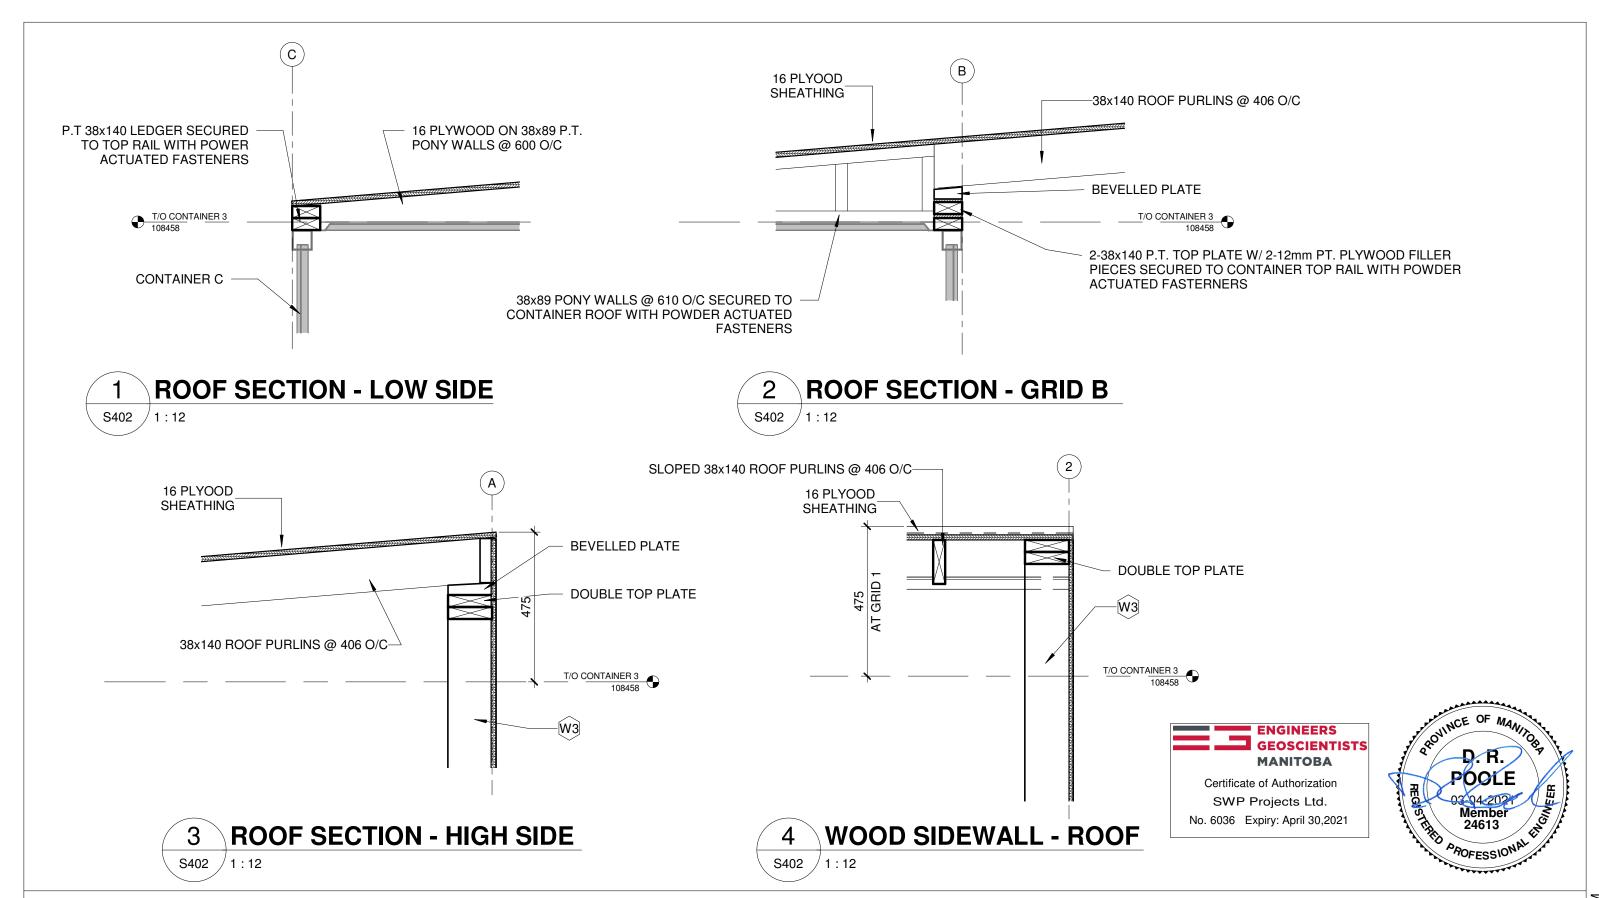



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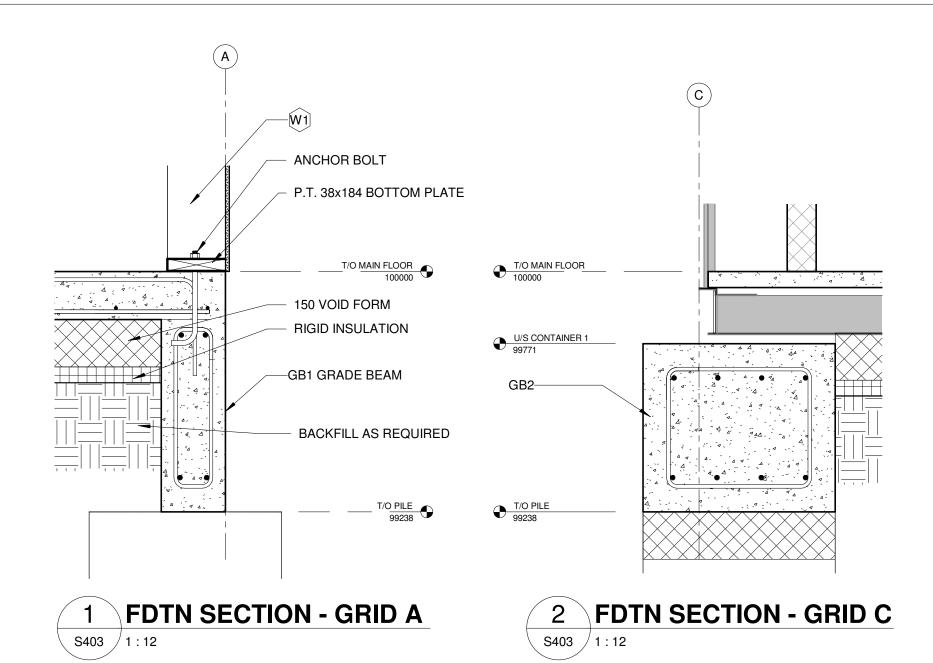
### 715 MAIN STREET PUBLIC TOILET


THE

THE CITY OF WINNIPEG	No.	Description	Date
	1	ISSUED FOR CONSTRUCTION	21-03-04
BID OPPORTUNITY 54-2021			


## **SECTIONS AND DETAILS**

Project number	20-104	0.400	
Date	2021-03-04	S402	
Drawn by	DP	<b>0</b> .0 <b>–</b>	
Checked by	DP	Scale 1 : 12	



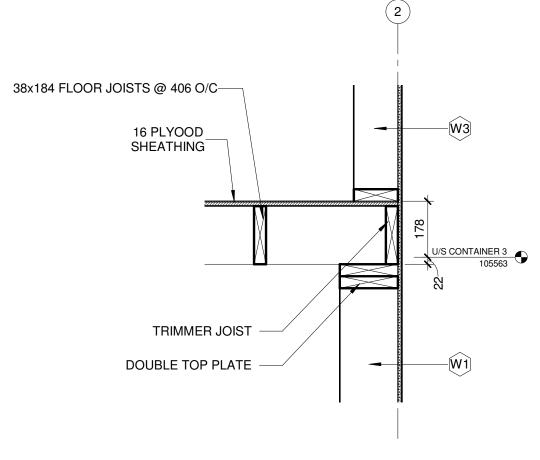

**WOOD SIDEWALL - 3RD FLOOR** S403

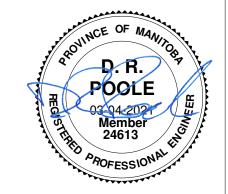

## **SWP PROJECTS LTD.**

678 MAIN STREET - 2ND FLR WINNIPEG, MB R3B 1E4

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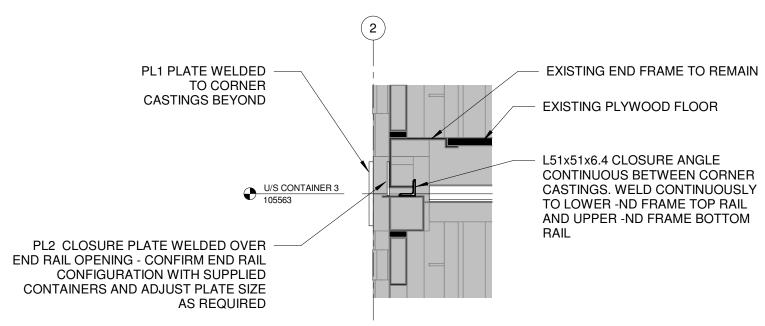
## 715 MAIN STREET PUBLIC TOILET

THE CITY OF WINNIPEG

**BID OPPORTUNITY 54-2021** 


No.	Description	Date

Project number	20-104	0.400
Date	2021-03-04	S403
Drawn by	Author	
Checked by	Checker	Scale 1 : 12




1 GRID 2 - CONTAINER CLOSURE

S901 1:12

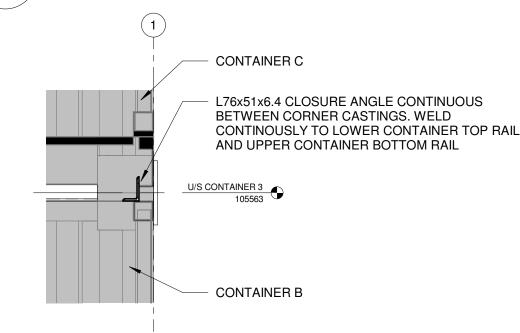


2 GRID 1 - CONTAINER CLOSURE

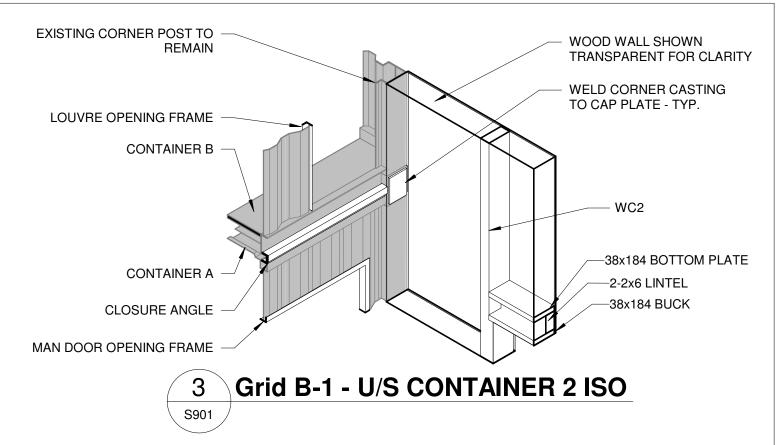



Certificate of Authorization SWP Projects Ltd. No. 6036 Expiry: April 30,2021

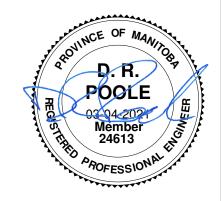

## SWP PROJECTS LTD.

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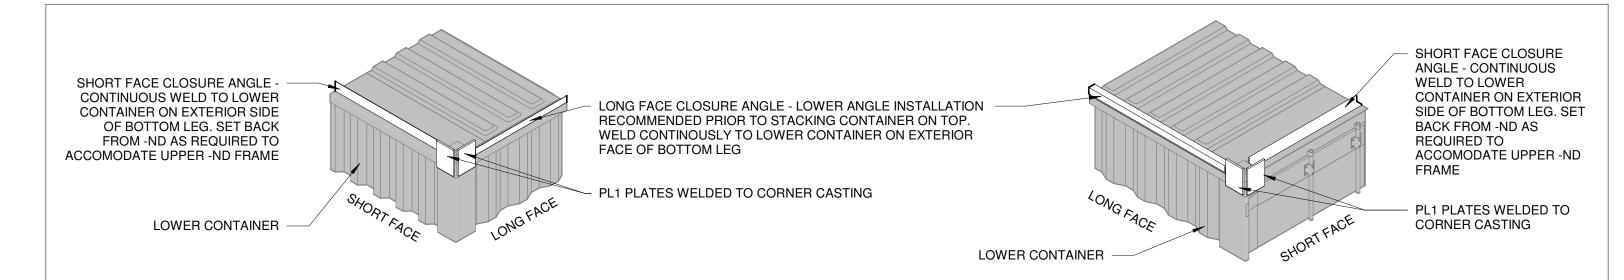
### 715 MAIN STREET PUBLIC TOILET


THE CITY OF WINNIPEG

**BID OPPORTUNITY 54-2021** 

No.DescriptionDate1ISSUED FOR CONSTRUCTION21-03-04

Project number	20-104	
Date	2021-03-04	S901
Drawn by	DP	
Checked by	DP	Scale 1 : 12



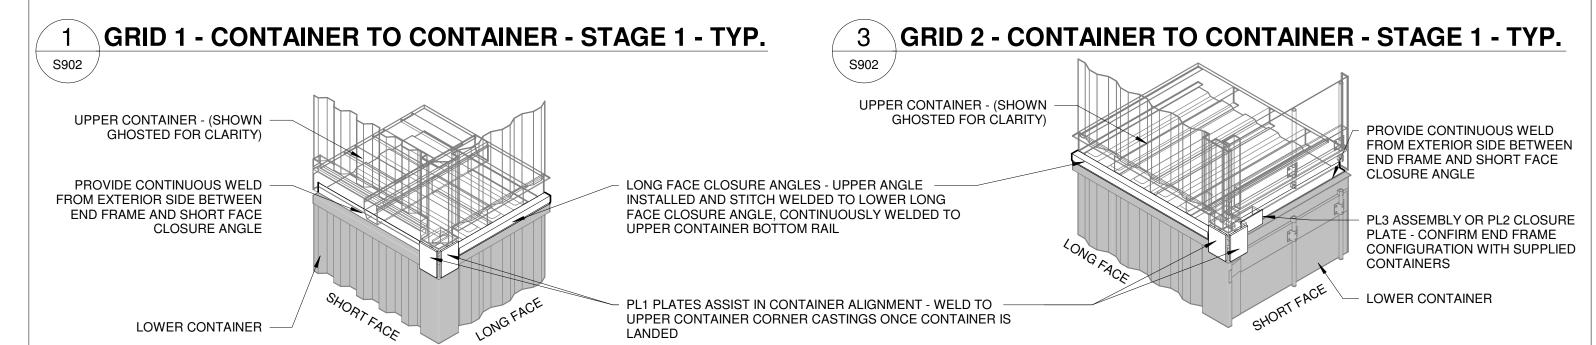


GRID 1 - CONTAINER TO CONTAINER - STAGE 2 - TYP.

4 GRID 2 - CONTAINER TO CONTAINER - STAGE 2 - TYP.

S902 /

ENGINEERS
GEOSCIENTISTS
MANITOBA

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No. 6036 Expiry: April 30,2021

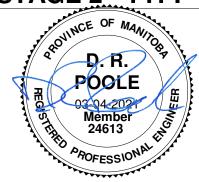

# SWP PROJECTS LTD. 678 MAIN STREET - 2ND FLR WINNIPEG, MB R3B 1E4

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S902

(E) david@totalprojectmgmt.ca


## 715 MAIN STREET PUBLIC TOILET

THE CITY OF WINNIPEG

**BID OPPORTUNITY 54-2021** 

No.	Description	Date
1	ISSUED FOR CONSTRUCTION	21-03-04

3-D DETAILS		
Project number	20-104	
Date	2021-03-04	S902
Drawn by	DP	_ 3332
Checked by	DP	Scale

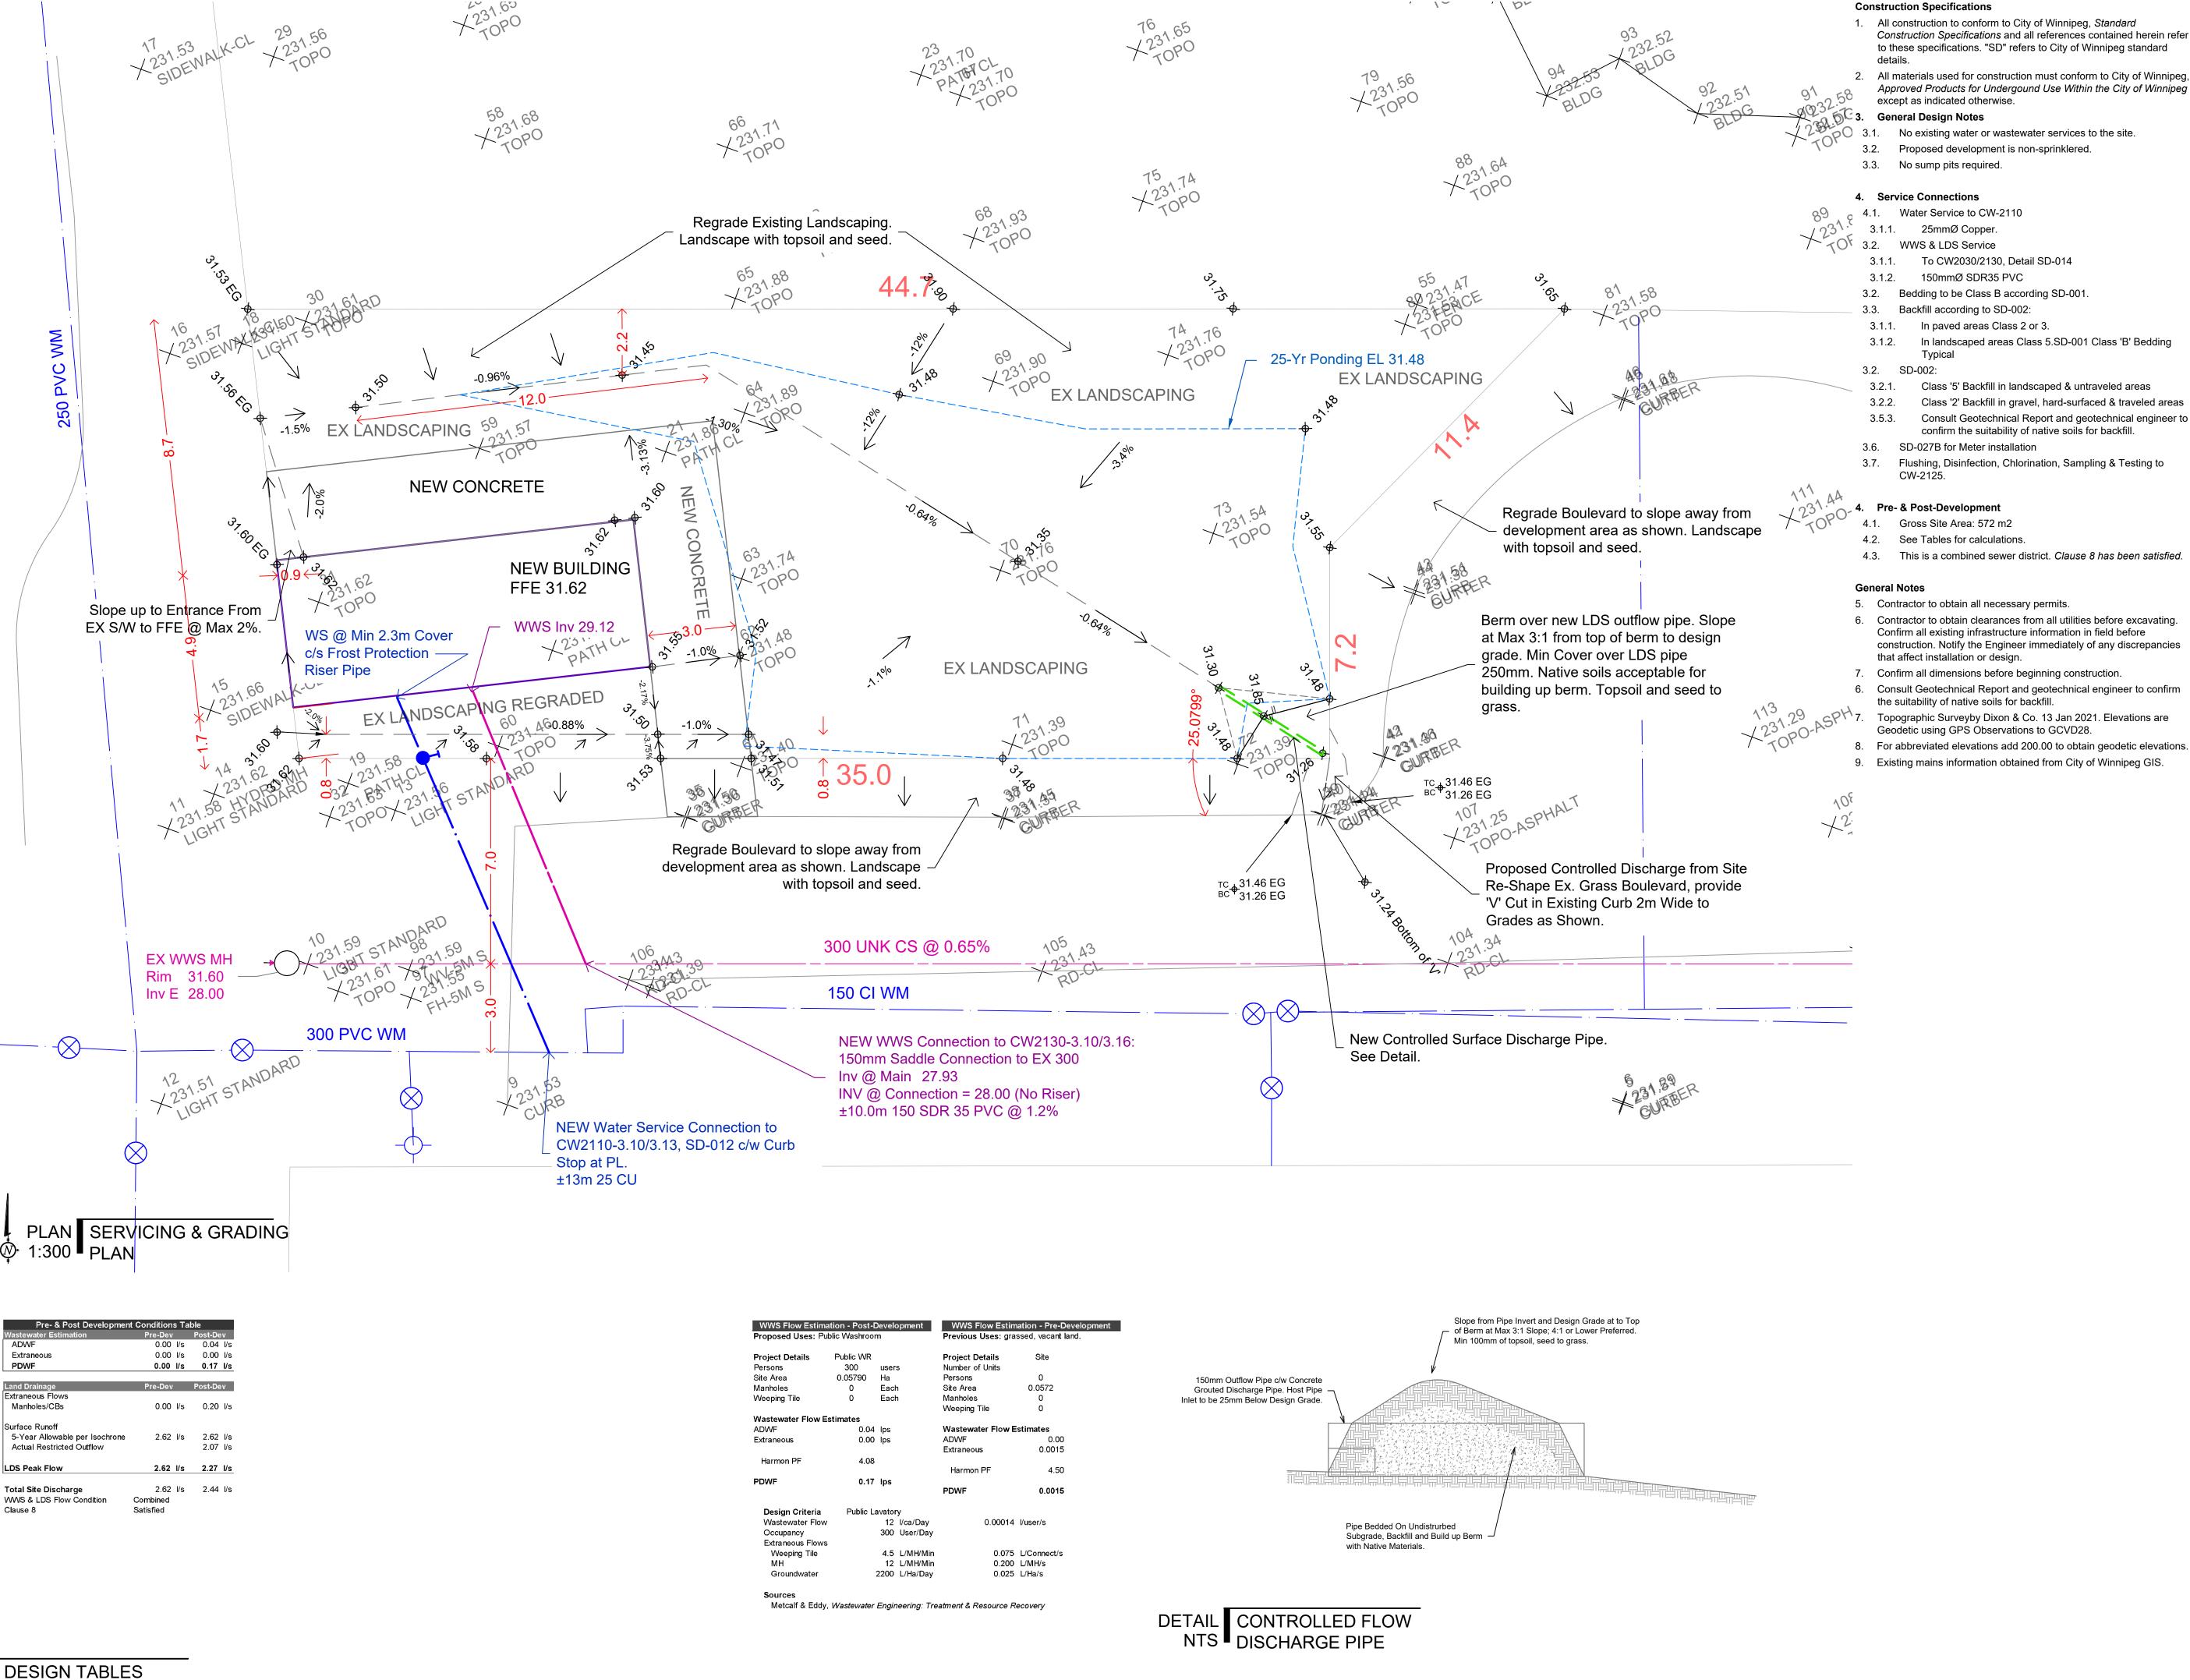

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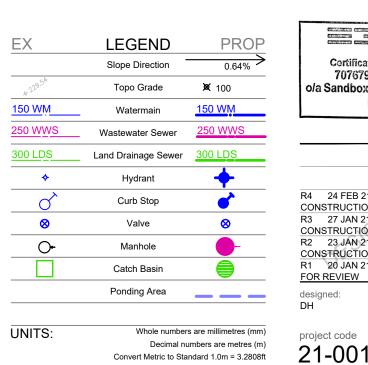


ENGINEERS
GEOSCIENTISTS
MANITOBA

Certificate of Authorization

7076798 Manitoba Inc.

da Sandbox Design & Consulting No. 7281



Lot Grading & Servicing Plan As Shown

R4 24 FEB 21

CONSTRUCTION

R3 27 JAN 21

R2 23 JAN 21

FOR REVIEW

designed:

CONSTRUCTION R1 20 JAN 21