

## THE CITY OF WINNIPEG

# **APPENDIX B**

Drawings of Existing Public Washroom Building (For Information Only)

**TENDER NO. 930-2023** 

MAIN AND HENRY COMMUNITY CORNER PLAZA - 715 MAIN STREET

# 715 MAIN STREET PUBLIC TOILET

## 715 Main Street, Winnipeg, MB

## ABBREVIATIONS

A/VR Air/Vapour Barrier (Fully Adhered) ACT ADB Acoustic Ceiling Tile Auto Door Bottom AFF Above Finished Floor B/O Bottom Of B/U Built-Up BTW Betweer CB Catch Basin Canada Government Standards Board CGSB CIP Cast In Plan CL Door Closer CLR Clear CLNG Ceiling CMU CONC Concrete Masonry Unit Concrete CONST Construction CONT Continuous CPT Carpet Tile СТ Ceramic Tile C/W Complete With DIA Diameter DB Dead Bolt DO Door Opener DP Door Pull DS Door Sweep EQ Egual FI FC Electrical EXIST Existing Flush Bolt FB FE Fire Extinguisher Fire Extinguisher Cabinet FEC Fusible Link FL FLH Fixed Lever Handle F.R.R. Fire Rated FS Floor Stop G1S Good One Side G1 Grade One G2 Grade Two GA Gauge GAL V Galvanized Glass Fibre-Beinforced GFR GL Glazing GWB Gypsum Wall Board HM Hollow Meta HORIZ Horizontal INS Insulated KMM Key to Master KP Kick Plate LH Lever Handle LAM Laminate MAR Marmoleum MAX Maximum MECH Mechanical MIN Minimum MTL Metal MR Moisture Resistant N/A Not Applicable NIC Not In Contract OSB Oriented Strand Board PC Precast PH Panic Hardware PLAM Plastic Laminate PLWD Plywood PLSH Polished PP Push Plate PREFIN Pre-finished PS Privacy Set PSF Pressed Steel Frame PT Pressure Treated PTD Painted PTG Pressure Treated Green

RS Reverse Swing RSF RB Resilient Sheet Flooring Rubber Wall Base RWL Rain Water Leader 
 HWL
 Hain Water

 SBM
 Supplied by

 SBO
 Supplied by

 SC
 Self Cove E

 SIM
 Similar

 SS
 Stainless S

 STL
 Steel

 STRUCT Structural
 STC

 Struct Stain
 STC
 Supplied by Manufacture Supplied by Owner Self Cove Base Stainless Steel Stain Grade STG SVC Sheet Vinyl Cove SVF Sheet Vinyl Floor SWD Solid Wood Door TH T/O TYP Threshold Top Of Typical U/S Underside VB VCT Vapor Retarder/Barrier Vinyl Composite Tile VERT Vertical Vinyl Sheet Good VSG W/ With W/C Washroom WD Wood Wired Glass WG Wall Mounted Fire Extinguisher WMFF Wall Stop WS

Weather Stripping

WSP

## CONSULTANTS

## ARCHITECTURAL

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## LISTS OF DRAWINGS

ARCHITECTURAL COVER SHEET ASSEMBLIES AND GENERAL NOTES A000 A001 A002 3D AXO VIEWS A100. SITE CONTEXT PLAN SITE PLAN A100.2 FOUNDATION PLAN A101 MAIN CONTAINER LEVEL PLAN SECOND CONTAINER LEVEL PLAN Δ102 A103 THIRD CONTAINER LEVEL PLAN A104 A105 ROOF PLAN MAIN FLOOR RCP A151 A201 EXTERIOR ELEVATIONS A202 EXTERIOR ELEVATIONS EXTERIOR ELEVATIONS A203 EXTERIOR ELEVATIONS A204 A301 BUILDING SECTION **BUILDING SECTION** A302 **BUILDING SECTION** A303 A304 **BUILDING SECTION** PLAN DETAILS PLAN DETAILS A501 A502 SECTION DETAILS A551 A552 SECTION DETAILS SECTION DETAILS A553 A554 SECTION DETAILS PLUMBING PEDESTAL DETAILS **Δ555** INTERIOR FLEVATIONS A701 A901 DOOR SCHEDULE A902 SANDBLASTING CONTAINERS (BY OTHERS) STRUCTURAL GENERAL NOTES - PAGE 1 GENERAL NOTES - PAGE 2 S001 S002 FOUNDATION FRAMING PLAN \$003 S004 MAIN FLOOR FRAMING PLAN SECOND LEVEL FRAMING PLAN S103 THIRD LEVEL FRAMING PLAN S104 S106 SITE CONCRETE PLAN S201 NORTH ELEVATION S202 SOUTH ELEVATION EAST AND WEST ELEVATIONS S203 S301

- BUILDING SECTIONS
- S302 SECTION - GRID A INTERIOR
- SECTION GRID B MECH S303 S304 SECTION - GRID B - SINKS
- S305 SECTION - GRID C - OFFICE
- S401 SECTIONS AND DETAILS SECTIONS AND DETAILS \$402
- S901 **3-D DETAILS**
- S902 3-D DETAILS S903 3-D DETAILS

## MECHANICAL M-1 LEGEND & SCHEDULE

- INFLOOR HEATING FLOOR PLAN M-2
- MAIN FLOOR PLAN HVAC
- UPPER LEVEL FLOOR PLAN MECHANICAL M-5 MAIN FLOOR PLAN - PLUMBING
- M-6 SPECIFICATION & EQUIPMENT LIST

ELECTRICAL


- TITLE SHEET E01
- E01. SITE PLAN E02.1
- MAIN LEVEL POWER LAYOUT MAIN LEVEL - LIGHTING LAYOUT
- E02.3 MAIN LEVEL - LOW VOLTAGE SYSTEMS
- SECOND LEVEL POWER LAYOUT SECOND LEVEL LIGHTING LAYOUT E03 1
- E03.2
- EQUIPMENT & PANEL SCHEDULES E06 E08 INSTALLATION SPECIFICATIONS - PART 1
- **INSTALLATION SPECIFICATIONS PART 2** E08.2

CIVIL C1 LOT GRADING & SERVICING PLAN

## **GENERAL NOTES**

- 1. THESE DRAWINGS SHALL NOT BE SCALED

- FRAMING
- CONSTRUCTION.
- TO BE PRESSURE-TREATED.
- DECK IS TO BE PRESSURE-TREATED.
- CLARIFICATION REFORE PROCEEDING WITH WORK
- PROCEEDING.

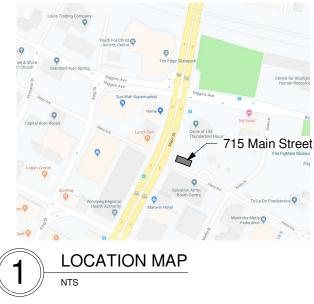

2. THE CONTRACTOR IS RESPONSIBLE FOR THE VERIFICATION OF MEASUREMENTS AND QUANTITIES OF MATERIALS REQUIRED

3. DIMENSIONS ARE TO GRID LINES, FACE OF STUD, CONCRETE OR EXISTING WORK TO REMAIN UNLESS NOTED OTHERWISE

4. PERFORM WORK IN STRICT ACCORDANCE WITH THE 2012 MANITOBA BUILDING CODE AND ANY OTHER CODE OF PROVINCIAL APPLICATION. OBSERVE ALL LOCAL ORDINANCES AND REGULATIONS.

5. CONTRACTOR TO REVIEW ALL ARCHITECTURAL, MECHANICAL, AND ELECTRICAL DRAWINGS FOR ALL OPENINGS THROUGH FLOOR, WALLS, AND ROOF ASSEMBLIES. REFER TO STRUCTURAL DETAILS FOR

6. CONTRACTOR TO VERIFY ALL EXISTING SITE CONDITIONS AND REPORT ALL DISCREPANCIES TO THE CONTRACT ADMINISTRATOR PRIOR TO

7. ALL PLYWOOD AND/OR WOOD BLOCKING USED AT OR BELOW GRADE IS


8. ALL PLYWOOD OR WOOD BLOCKING USED ABOVE PLANE OF ROOF

9. IN CASE OF DOUBT; CONFLICT OR DISCREPANCIES ON THE DRAWINGS AND/OR SPECIFICATIONS; OR QUESTIONS REGARDING MATERIALS OR SUITABLE METHOD OF CONSTRUCTION. CONSULT ARCHITECT FOR

10. CONTRACTOR TO SUBMIT APPLICATIONS FOR EQUAL IN WRITING. ALONG WITH SUPPORTING DATA, FOR APPROVAL PRIOR TO

11. COMPENSATION WILL NOT BE MADE BECAUSE OF FAILURE TO MAKE PROPER SITE INVESTIGATIONS AND REPORT OF ANY DISCEPANCIES TO THE CONTRACT ADMINISTRATOR PRIOR TO TENDER CLOSING OR BECAUSE OF FAILURE TO UNDERSTAND FULL NATURE OF WORK

12. GENERAL CONTRACTOR TO COORDINATE AND PROVIDE ALL SOLID BLOCKING WITHIN THE WALL AND CEILING AREAS TO SUPPORT SUBFACE MOUNTED FIXTURES AND FITTINGS INCLUDING, BUT NOT LIMITED TO APPLIANCES. HANDRAILS, SIGNS AND ACCESSORIES -INCLUDING ITEMS NOTED AS N.I.C. IN COORDINATION WITH THE OWNER

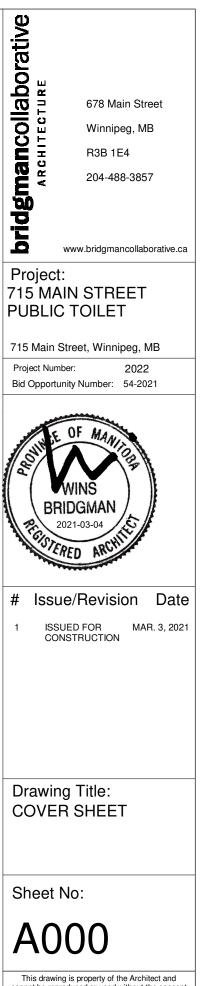

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## **ASSEMBLY LEGEND**

## WALL TYPES

EW1 METAL CLADDING ON WOOD STUD FRAMING - PLYWOOD INTERIOR • 22mm PREFINISHED 22 GA. CORRUGATED METAL CLADDING • SPUN POLYOLEFIN WATER RESISTIVE BARRIER MEMBRANE • 16mm GLASS FIBRE REINFORCED EXTERIOR SHEATHING • 184mm WOOD STUD FRAMING @ 203MM O.C. (REFER TO STRUCT) (FILL STUD CAVITY W/ 6" MIN. BATT INSULATION) • 6 MIL POLYETHYLENE VAPOUR BARRIER MEMBRANE • 13mm BALTIC BIRCH PLYWOOD - CLEAR SEALED (SEE GENERAL NOTE #6) EW2 METAL CLADDING ON WOOD STUD FRAMING - GWB INTERIOR • 22mm PREFINISHED 22 GA. CORRUGATED METAL CLADDING SPUN POLYOLEFIN WATER RESISTIVE BARRIER MEMBRANE • 16mm GLASS FIBRE REINFORCED EXTERIOR SHEATHING • 184mm WOOD STUD FRAMING @ 203MM O.C. (REFER TO STRUCT) (FILL STUD CAVITY W/ 6" MIN. BATT INSULATION) • 6 MIL POLYETHYLENE VAPOUR BARRIER MEMBRANE • 1/2" GYPSUM BOARD - PAINTED (ABOVE ELEVATION U/S CONTAINER 2) EW3 METAL CLADDING ON WOOD STUD FRAMING - NO INSULATION • 22mm PREFINISHED 22 GA. CORRUGATED METAL CLADDING SPUN POLYOLEFIN WATER RESISTIVE BARRIER MEMBRANE • 16mm GLASS FIBRE REINFORCED EXTERIOR SHEATHING • 92mm WOOD STUD FRAMING @ 203MM O.C. (REFER TO STRUCT) IW1 CONCRETE BLOCK • 92mm CONCRETE BLOCK - SEALED NOTE: REFER TO FLOOR PLAN FOR AREAS OF 76mm MIN. SPRAYFOAM INSULATION BETWEEN SHIPPING CONTAINER AND CONC BLOCK IW2 92mm STEEL STUD PARTITION • 92mm STEEL STUDS @ MAX 406mm O.C. • 16mm ABUSE-RESISTANT GYPSUM BOARD IW3 92mm STEEL STUD PARTITION - SPRAYFOAM INSULATION 13mm CONSTRUCTION GRADE PLYWOOD • 92mm STEEL STUDS @ MAX 406mm O.C. (FILL CAVITY SPACE BETWEEN STUDS & SHIPPING CONTAINER WALL WITH 76mm MIN. SPRAYFOAM) IW3a 92mm STEEL STUD PARTITION - BATT INSULATION 13mm CONSTRUCTION GRADE PLYWOOD • 92mm STEEL STUDS @ MAX 406mm O.C. (FILL STUD CAVITY SPACE WITH 89mm MINERAL WOOL BATT INSULATION) • VAPOUR BARRIER, TAPPED ALL SIDES & CONTINUOUS WITH ADJACENT WALLS

## **ROOF TYPES**

- R1 SLOPED WOOD ROOF
  - 2 PLY MOD. BIT. HEAT WELDED CAP SHEET
  - ICE & WATER SHIELD TO COVER ENTIRE ROOF

NOTE: CONSTRUCT WALL TO BE REMOVABLE WHEN ACCESS IS REQUIRED THROUGH CONTAINER DOORS

- 3mm PROTECTION COVER BOARD (BASIS OF DESIGN: IKO PROTECTOBOARD)
- FULLY ADHERED SBS MODIFIED BITUMEN AIR/VAPOUR BARRIER
- 16mm PLYWOOD SHEATHING
- P.T. WOOD BLOCKING AS REQUIRED FOR SLOPE (REFER TO STRUCTURAL)
- 89mm P.T. WOOD STUDS ON FLAT @ 406mm O.C. ACROSS TOP OF CONTAINERS NOTE: SECURE ROOF TO CONTAINER TOP CHANNEL FRAMES ONLY (NO
- PENETRATIONS ALLOWED INTO CONTAINER CORRUGATED ROOF)

## **GENERAL NOTES:**

- 1. SHIPPING CONTAINERS & SANDBLASTING OF CONTAINERS PROVIDED BY CLIENT
- 2. PROVIDE SEPARATE PRICE FOR 2 URINALS ON EAST ELEVATION
- 3. PROVIDE SEPARATE PRICE FOR 'LOO LOO' & 'WPG' 1220mm x 152mm LETTERING ON STANDOFFS (LOCATED ON WEST & NORTH ELEVATIONS)
- ALL SHIPPING CONTAINER WALLS WHERE SPRAYFOAM INSULATION IS INDICATED ON DRAWINGS TO BE A MINIMUM THICKNESS OF 76mm (REFER TO PLANS AND SECTIONS FOR LOCATIONS)
- 5. ALL CAVITIES WHERE SPRAYFOAM IS INDICATED TO BE COMPLETELY FILLED WITH NO VOIDS ALLOWED. IF VOIDS ARE DISCOVERED, THE CONTRACT ADMINISTRATOR MAY REQUEST A FULL INSPECTION OF SPRAYFOAM APPLICATION AT THE GC'S EXPENSE
- 6. BALTIC BIRCH PLYWOOD INTERIOR FINISH TO BE FULL SIZE 1220x2434mm SHEETS OF PLYWOOD ALIGNED WITH ELEVATION U/S CONTAINER 2. CUT BALTIC BIRCH PLYWOOD, SIZE TO SUIT, BELOW FULL SHEET AS WALL BASE - CLEAR SEALED.
- 7. ALL GLAZING, UNLESS OTHERWISE NOTED, TO BE TEMPERED TYPICAL
- 8. ALL EXPOSED STEEL FABRICATED EDGES TO BE GROUND SMOOTH
- 9. ALL EXPOSED WELDING TO BE CONTINUOUS AND GROUND SMOOTH
- 10. MAKE GOOD ANY DAMAGE DONE TO EXISTING CITY SIDEWALK
- 11. CONFIRM FINISHES OF ALL STEEL WORK WITH CONTRACT ADMINISTRATOR
- 12. WATERPROOF RUBBER MEMBRANE TO BE: Blue Seal Waterproofing Rubber Membrane Model # BE185169 Home Depot
- ALL EXPOSED CONCRETE BLOCK TO BE SEALED WITH: Quikrete Acrylic Concrete Sealer 3.8L – Model 880003 SKU 1000 142722 Home Depot
- 14. ALL CONCRETE FLOORS AND TOPPING TO BE SEALED. CONCRETE SEALER TO BE AN EPOXY-BASED LIQUID COATING SYSTEM. INSTALLED AS PER MANUFACTURER'S INSTRUCTIONS OVER ALL INTERIOR CONCRETE: PRODUCT TO BE (REFER TO SPEC): Manufacturer: Soprema
  - System Name: Aslan Floor Quartz Colour: Grey OR White ( to be confirmed)

## **FLOOR TYPES**


- F1 CONCRETE STRUCTURAL SLAB ON GRADE
  - CONCRETE SLAB ON GRADE (REFER TO STRUCTURAL)
  - 10mil POLYETHELENE SHEET VAPOUR RETARDER
  - 102mm EPS FOIL-FACE RIGID INSULATION
  - 152mm VOID FORM (REFER TO STRUCTURAL)
  - COMPACTED GRANULAR FILL (REFER TO STRUCTURAL)

### F2 CONCRETE TOPPING

- 51mm CONCRETE TOPPING (REFER TO STRUCTURAL)
- EXISTING CONTAINER PLYWOOD FLOOR
- SPRAYFOAM CAVITY BETWEEN EXISTING CONTAINER FLOOR STEEL MEMBERS
- 10mil POLYETHELENE SHEET VAPOUR RETARDER
- 102mm EPS RIGID INSULATION
- COMPACTED GRANULAR FILL (REFER TO STRUCTURAL)
- F3 EXISTING CONTAINER FLOOR W/ SPRAYFOAM FLOOR CAVITY
  - EXISTING CONTAINER PLYWOOD FLOOR
  - SPRAYFOAM INSULATION IN CAVITY BETWEEN CONTAINER FLOOR STEEL MEMBERS

### F4 WOOD JOIST FLOOR - INSULATED

- 16mm PLYWOOD SHEATHING (REFER TO STRUCTURAL)
- 184mm WOOD JOISTS @ 406mm O.C. (REFER TO STRUCTURAL)
- (FILL FULL JOIST CAVITY W/ BATT INSULATION)
- 6 MIL POLYETHYLENE VAPOUR BARRIER MEMBRANE
- 1/2" GYPSUM BOARD PAINTED

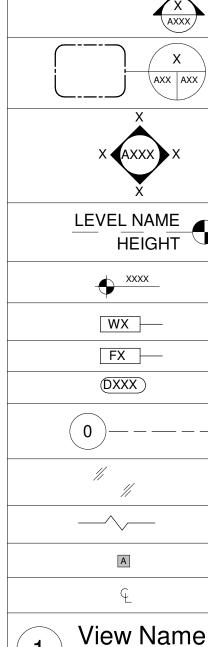


**SYMBO** 


View Scale




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	SECTION DETAILS & BUILDING SECTION TAG	Winnipeg, MB           Winnipeg, MB           R3B 1E4           204-488-3857
)	CALLOUT TAG	ridgn
	ELEVATION TAG	www.bridgmancollaborative.ca Project: 715 MAIN STREET PUBLIC TOILET
	LEVEL TAG	715 Main Street, Winnipeg, MBProject Number:2022Bid Opportunity Number:54-2021
	SPOT ELEVATION	SOUTH OF MANIFER
	WALL TAG	
	FLOOR TAG	WINS
	DOOR TAG	BRIDGMAN 2021-03-04
	GRID LINE	GOTERED ARCHIT
	INDICATES GLAZING	<ul> <li># Issue/Revision Date</li> <li>1 ISSUED FOR MAR. 3, 2021</li> </ul>
	BREAK LINE	CONSTRUCTION
	DOOR ACTUATOR	
	CENTRE LINE	
9	DRAWING TITLE	Drawing Title: ASSEMBLIES AND
	NORTH ARROW	GENERAL NOTES
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		A001 This drawing is property of the Architect and cannot be reproduced or used without the consent


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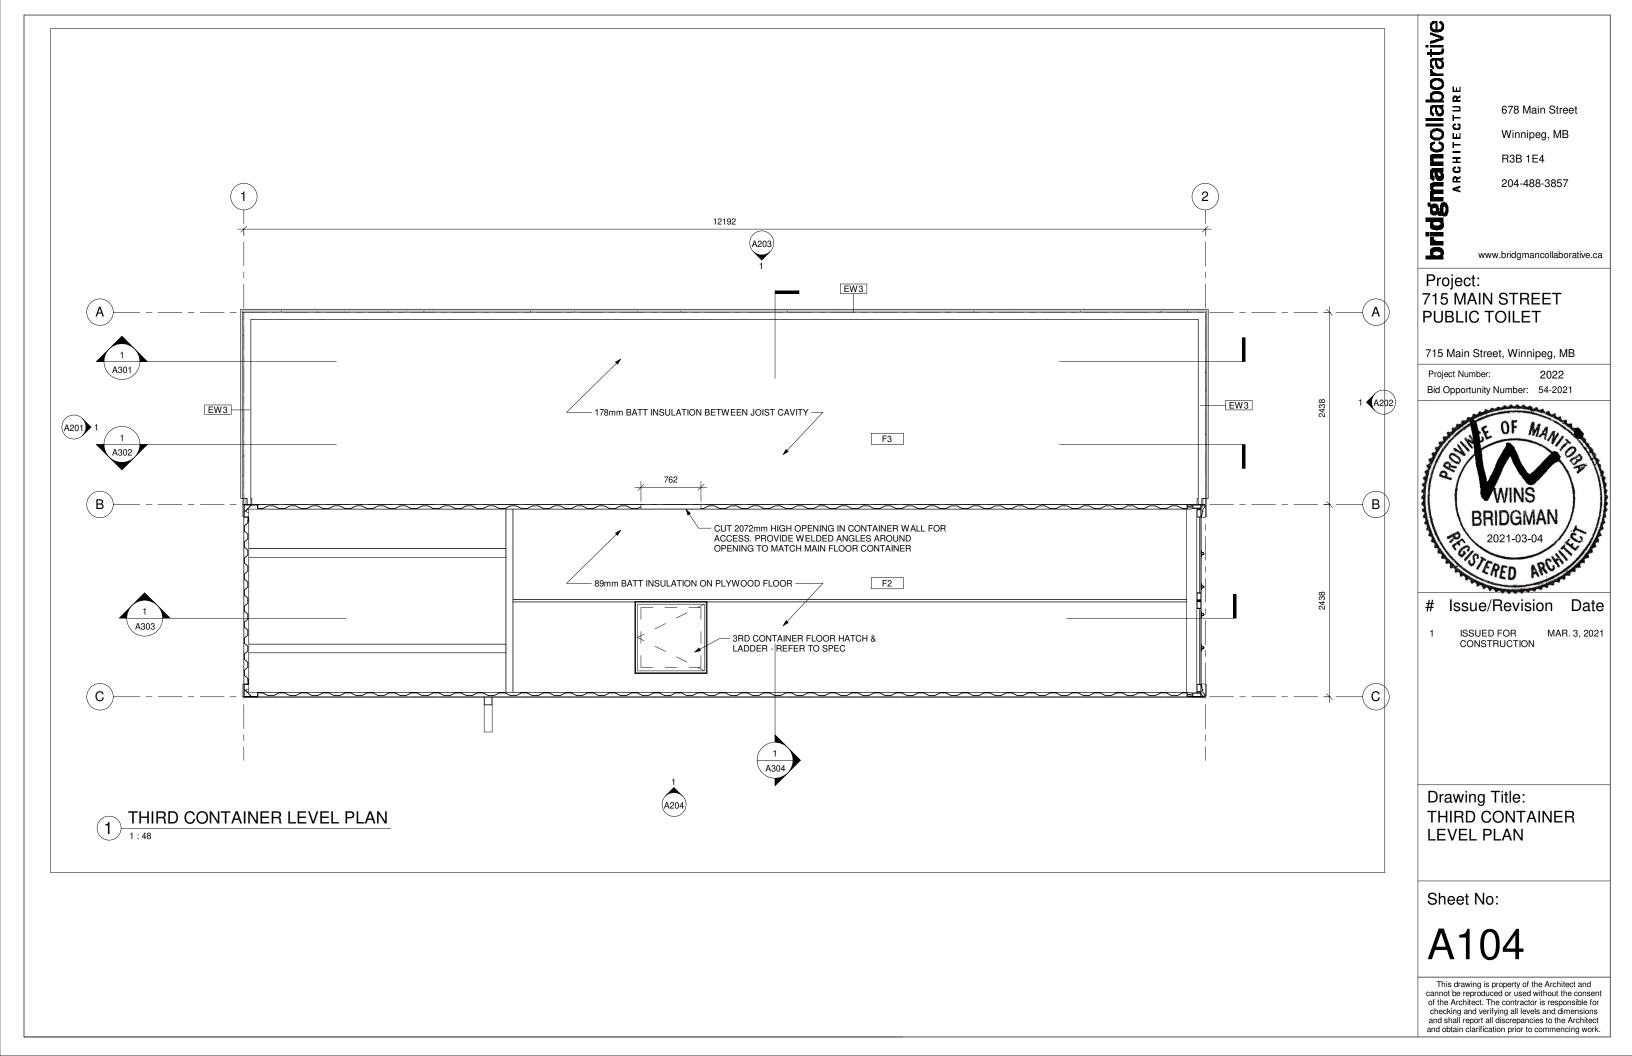


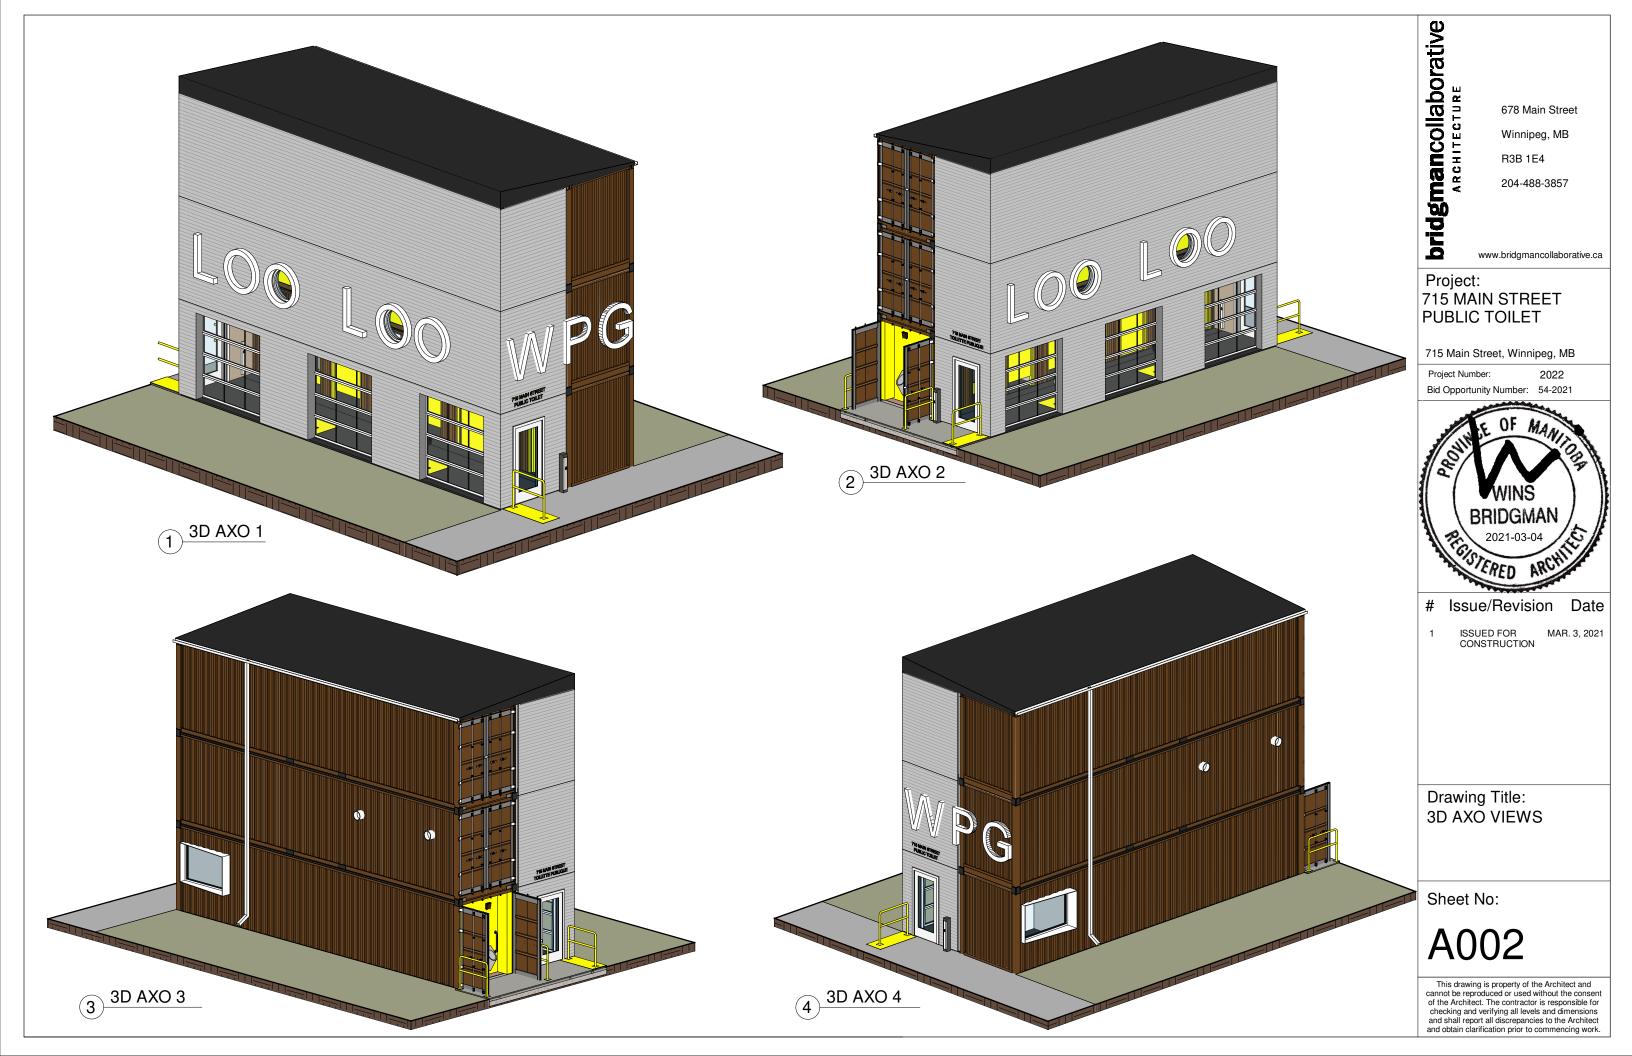


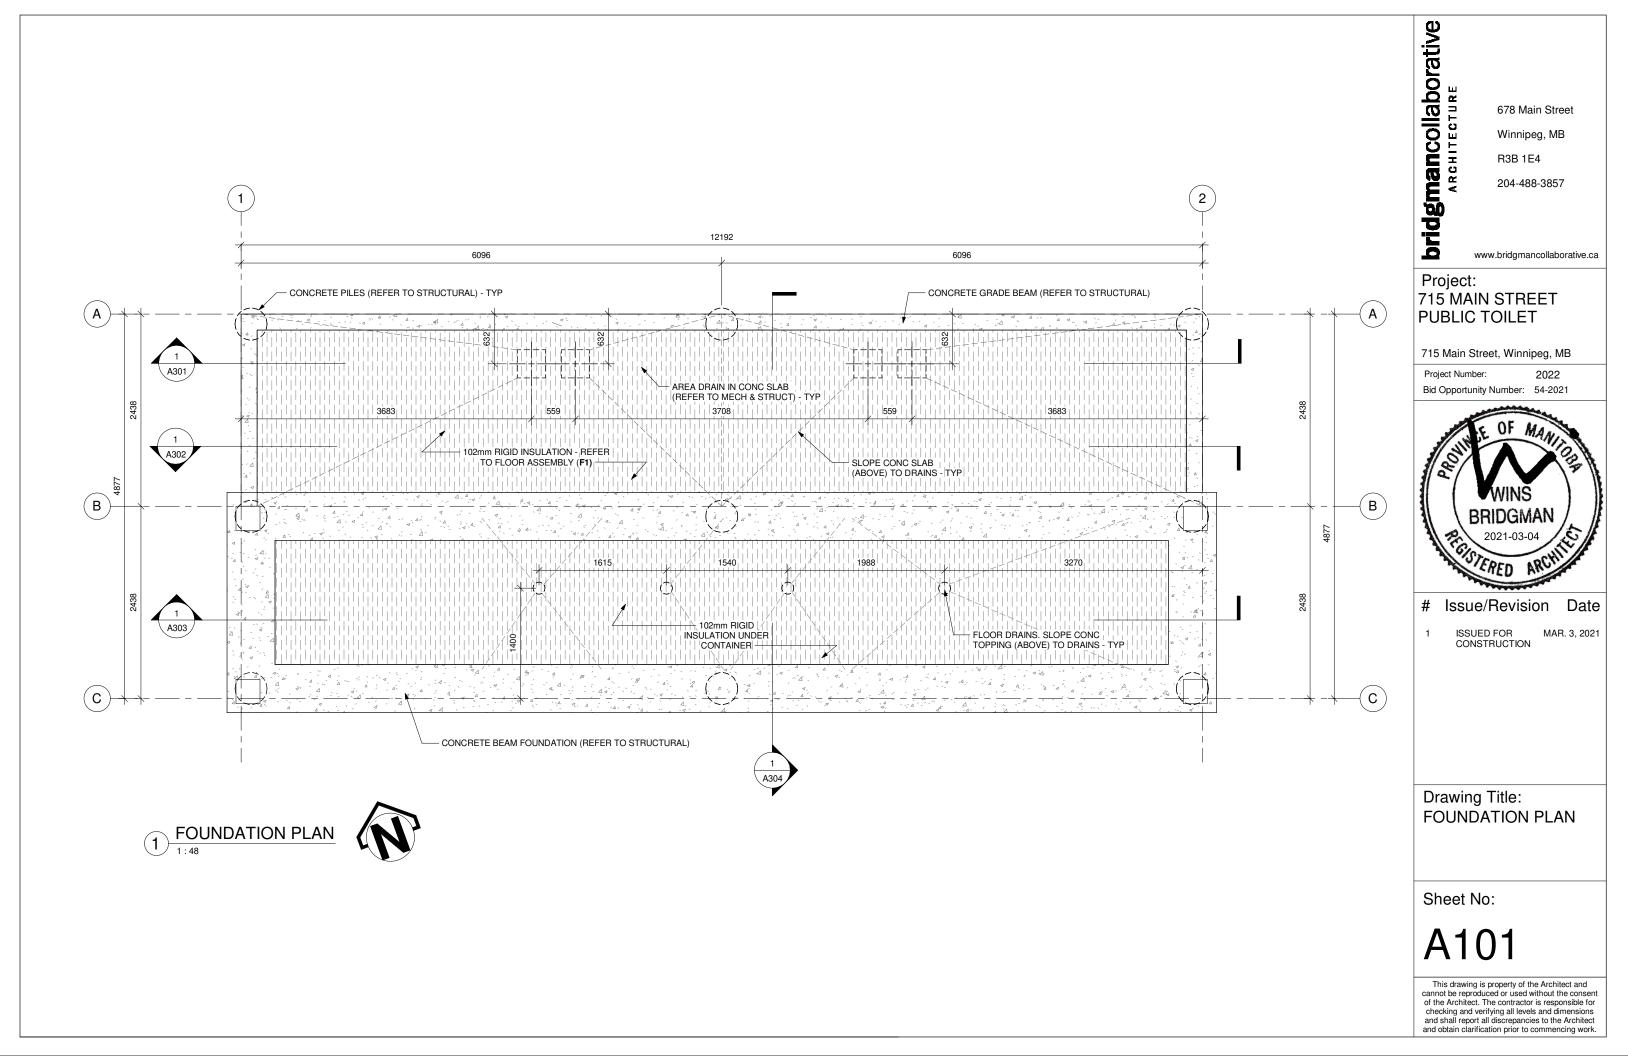


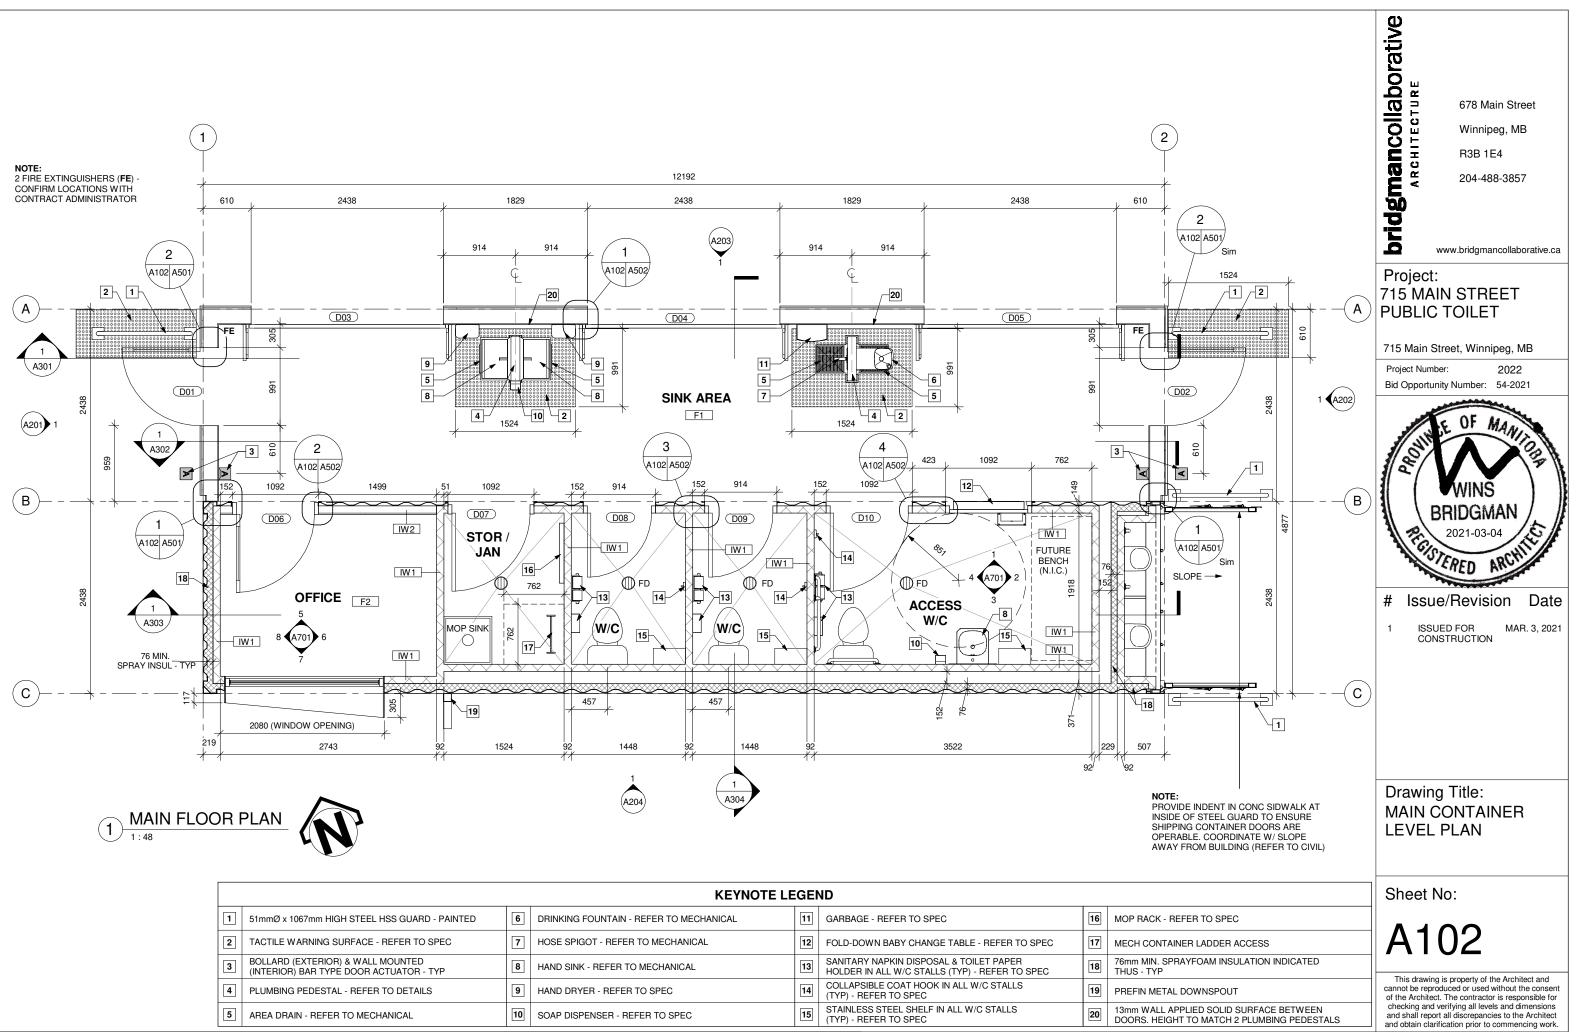	KEYNOTE LEGEND						
1	51mmØ x 1067mm HIGH STEEL HSS GUARD - PAINTED	6	DRINKING FOUNTAIN - REFER TO MECHANICAL	11	GARBAGE - REFER TO SPEC	16	MOP RACK - F
2	TACTILE WARNING SURFACE - REFER TO SPEC	7	HOSE SPIGOT - REFER TO MECHANICAL	12	FOLD-DOWN BABY CHANGE TABLE - REFER TO SPEC	17	MECH CONTA
3	BOLLARD (EXTERIOR) & WALL MOUNTED (INTERIOR) BAR TYPE DOOR ACTUATOR - TYP	8	HAND SINK - REFER TO MECHANICAL	13	SANITARY NAPKIN DISPOSAL & TOILET PAPER HOLDER IN ALL W/C STALLS (TYP) - REFER TO SPEC	18	76mm MIN. SP THUS - TYP
4	PLUMBING PEDESTAL - REFER TO DETAILS	9	HAND DRYER - REFER TO SPEC	14	COLLAPSIBLE COAT HOOK IN ALL W/C STALLS (TYP) - REFER TO SPEC	19	PREFIN META
5	AREA DRAIN - REFER TO MECHANICAL	10	SOAP DISPENSER - REFER TO SPEC	15	STAINLESS STEEL SHELF IN ALL W/C STALLS (TYP) - REFER TO SPEC	20	13mm WALL A DOORS. HEIG




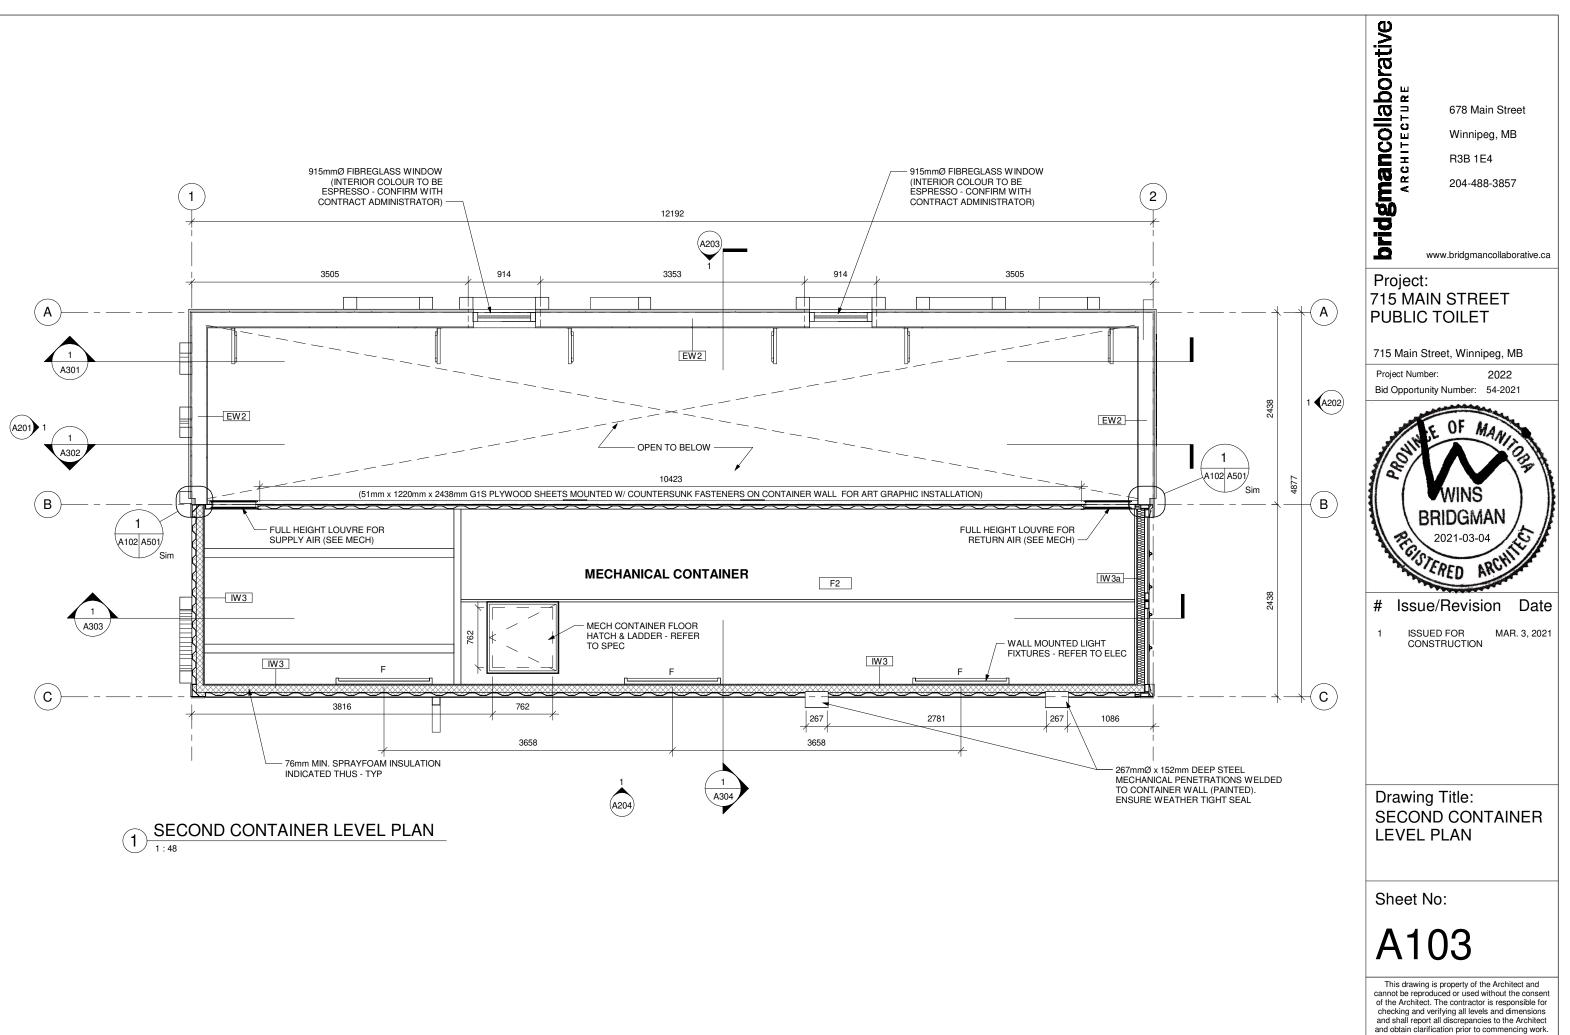


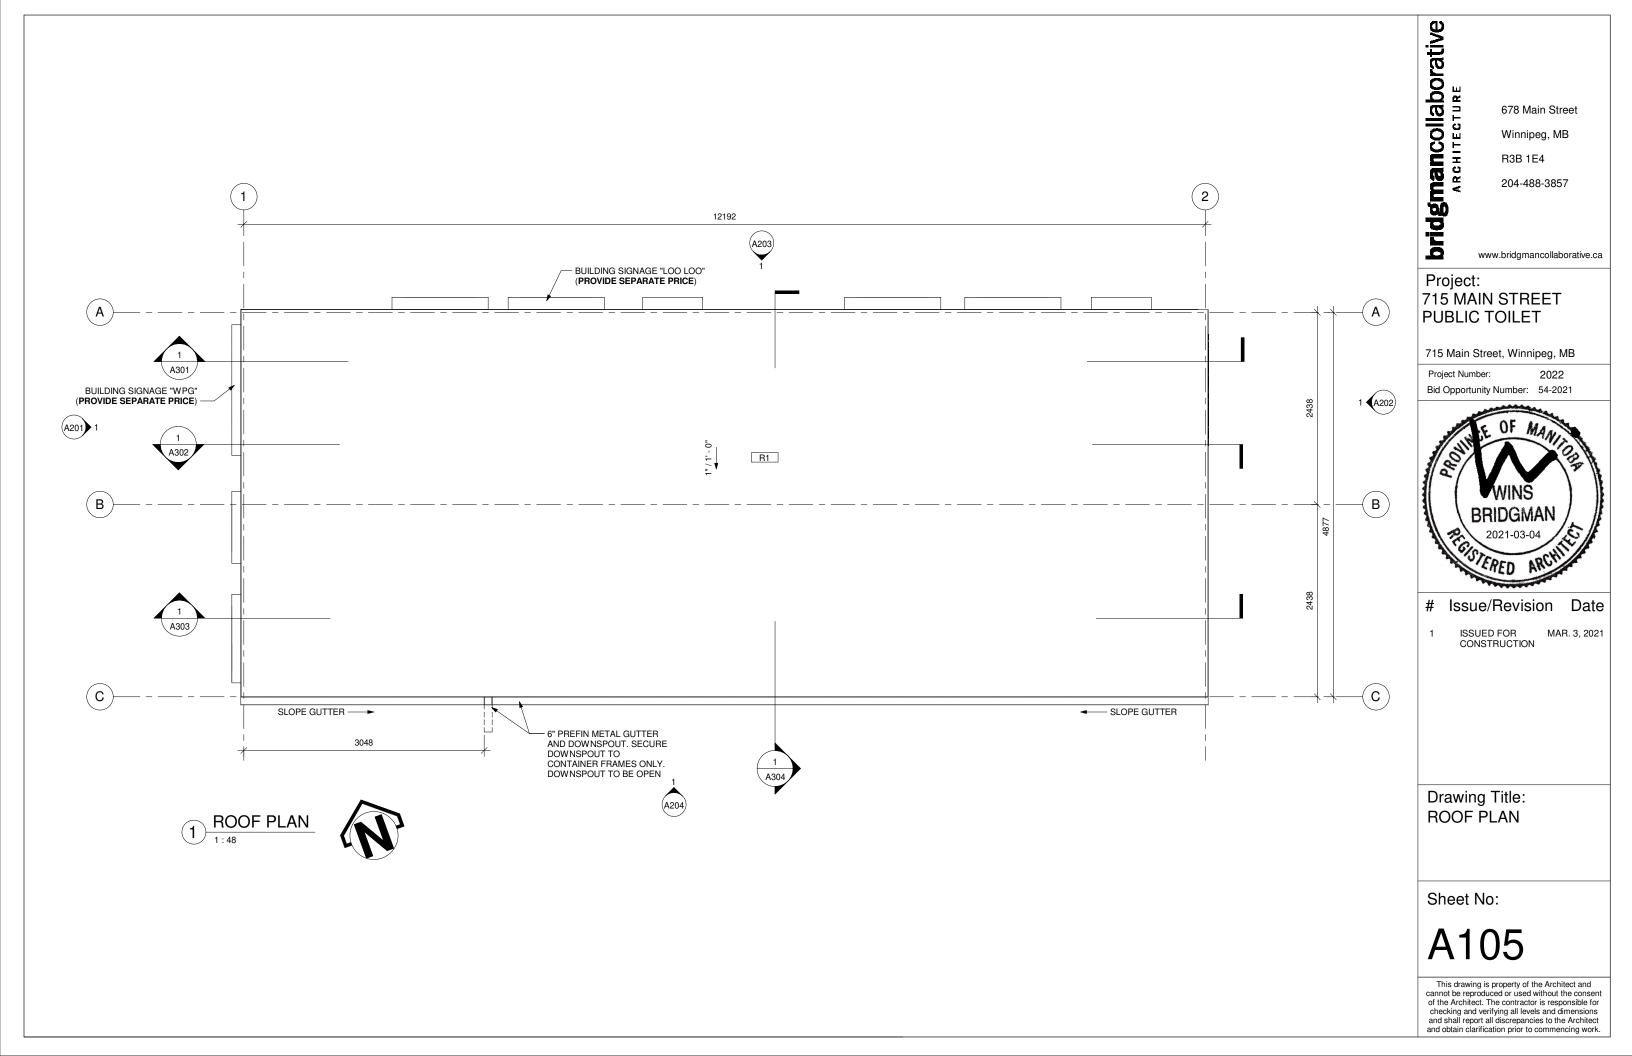


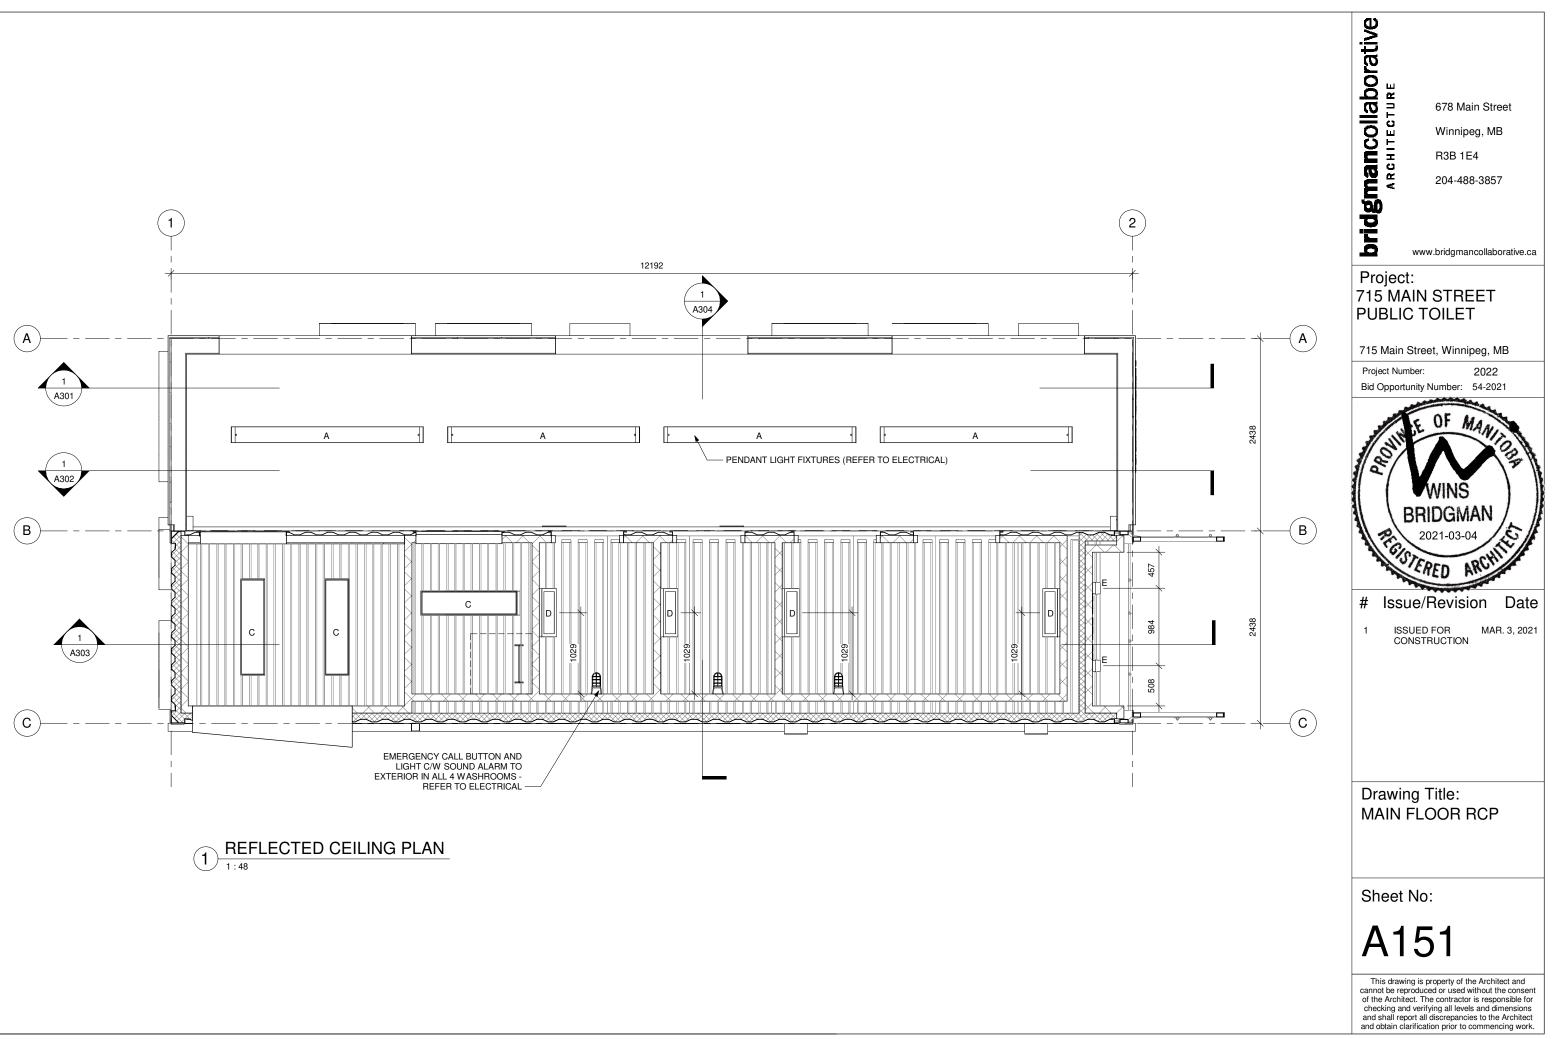





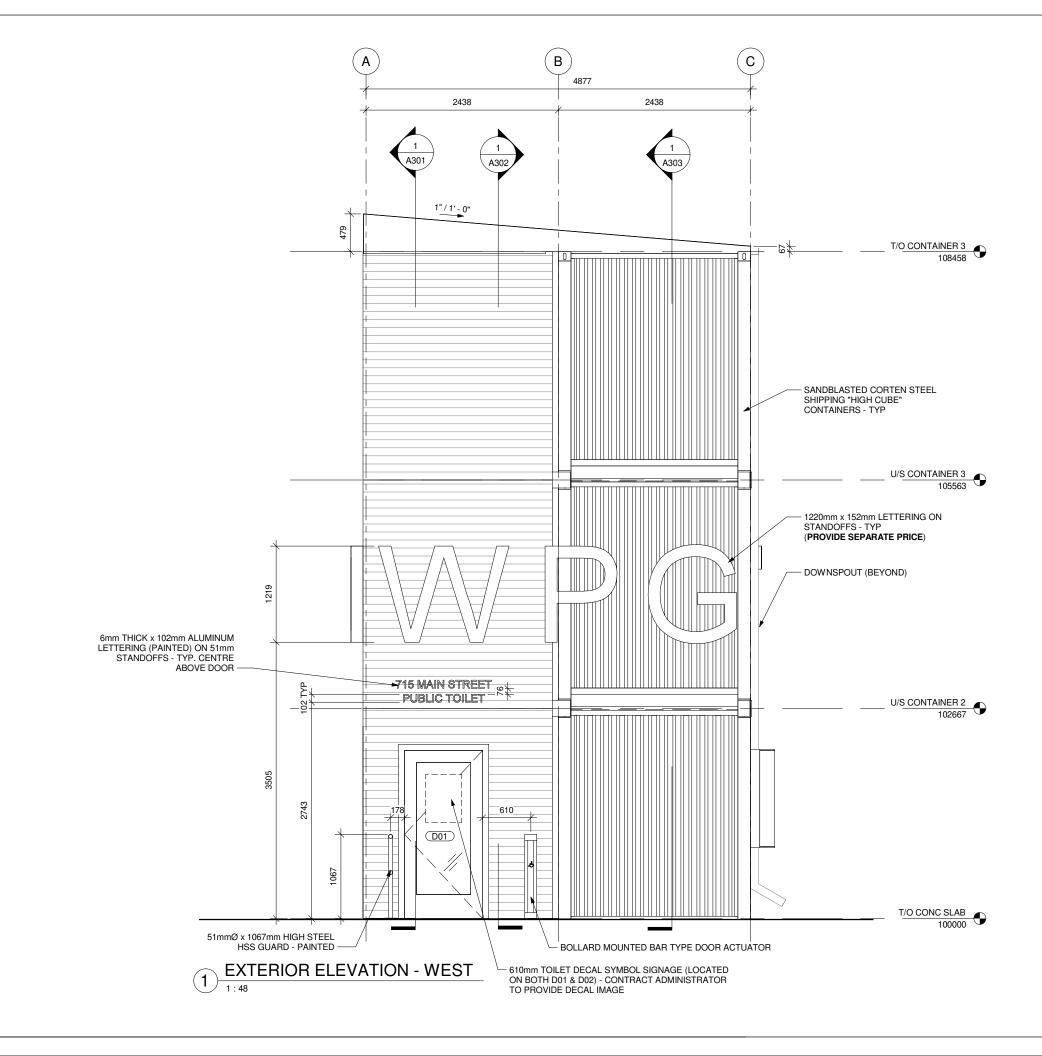


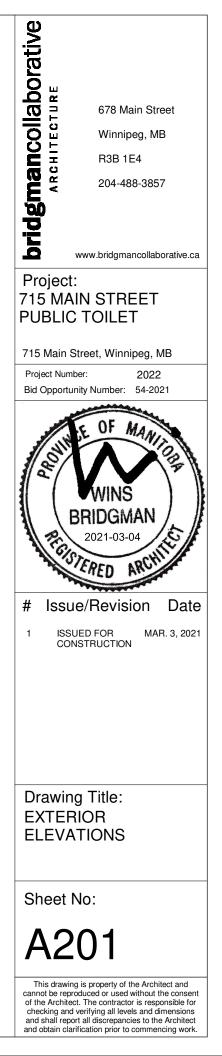


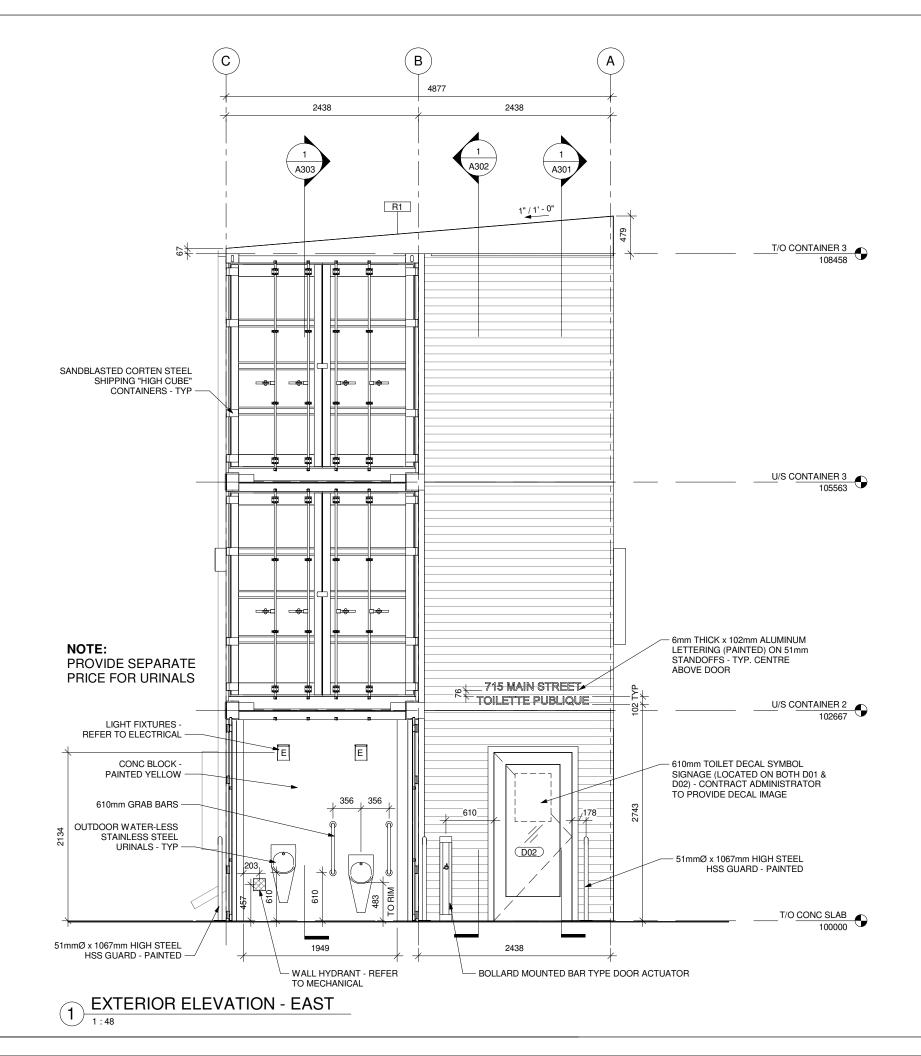


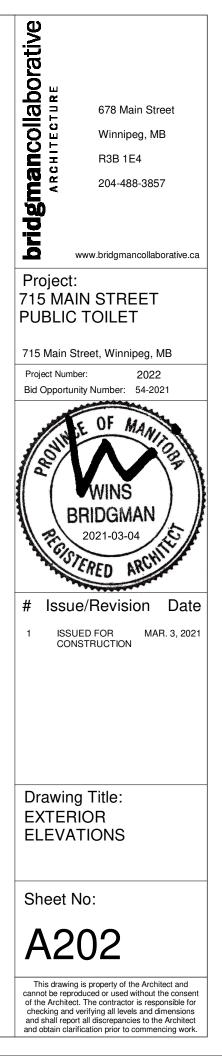


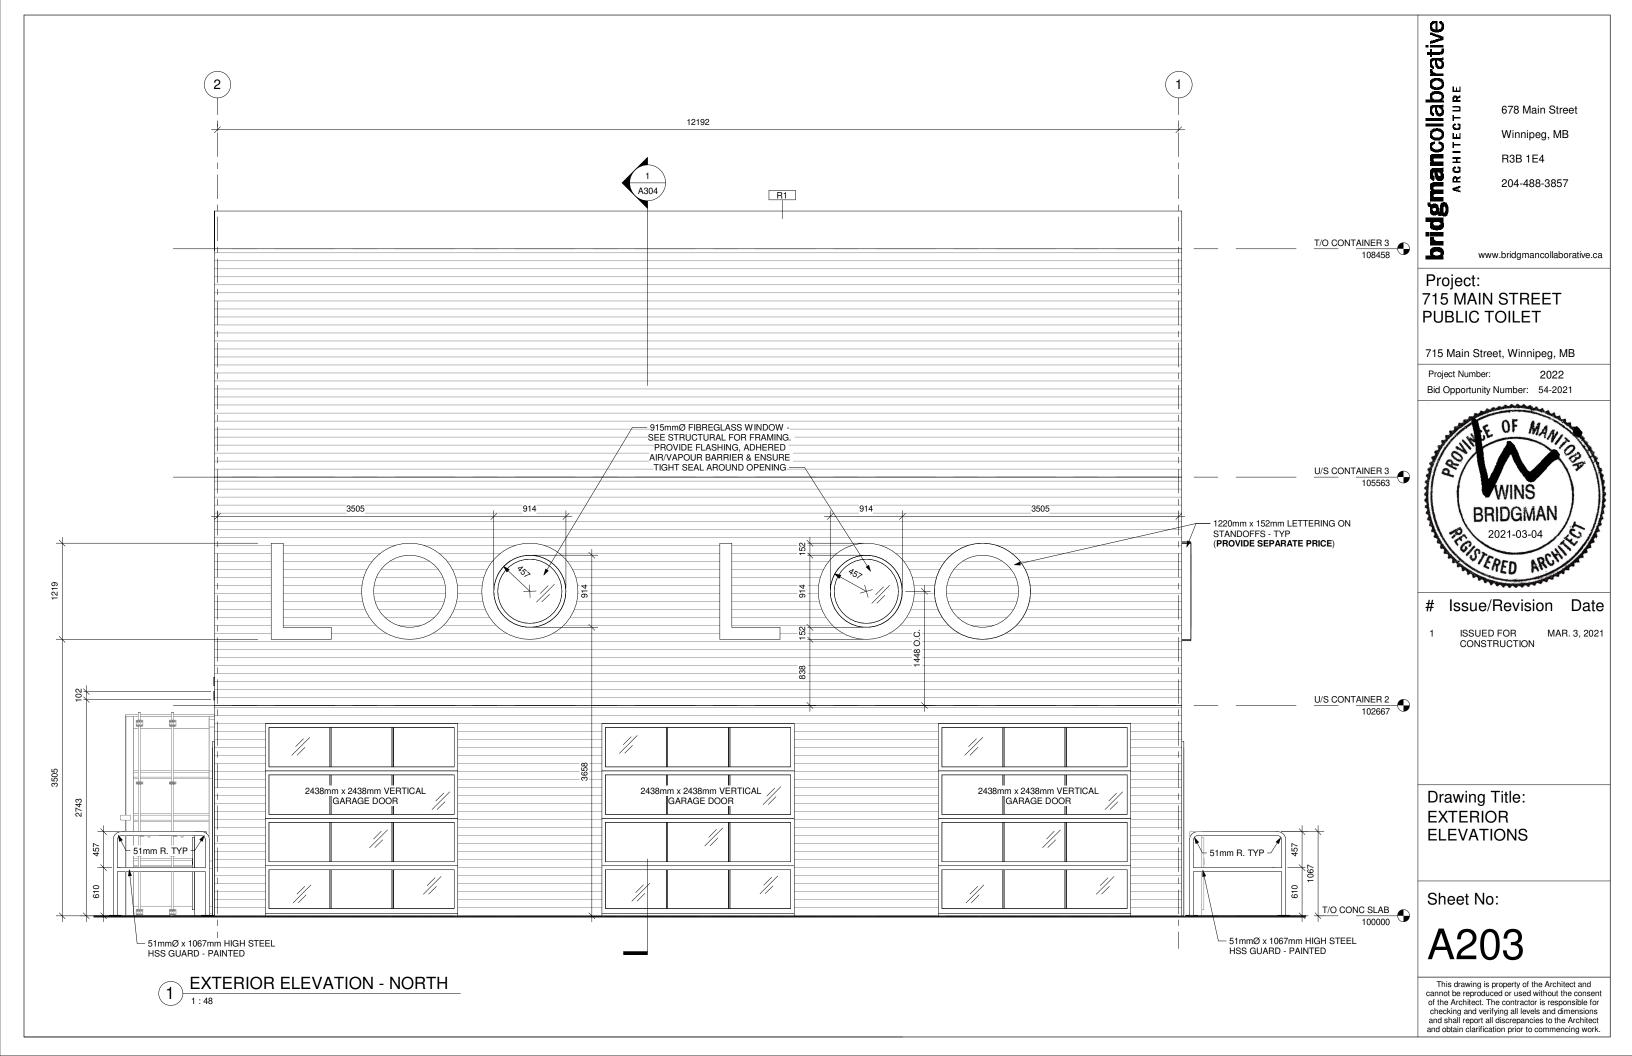


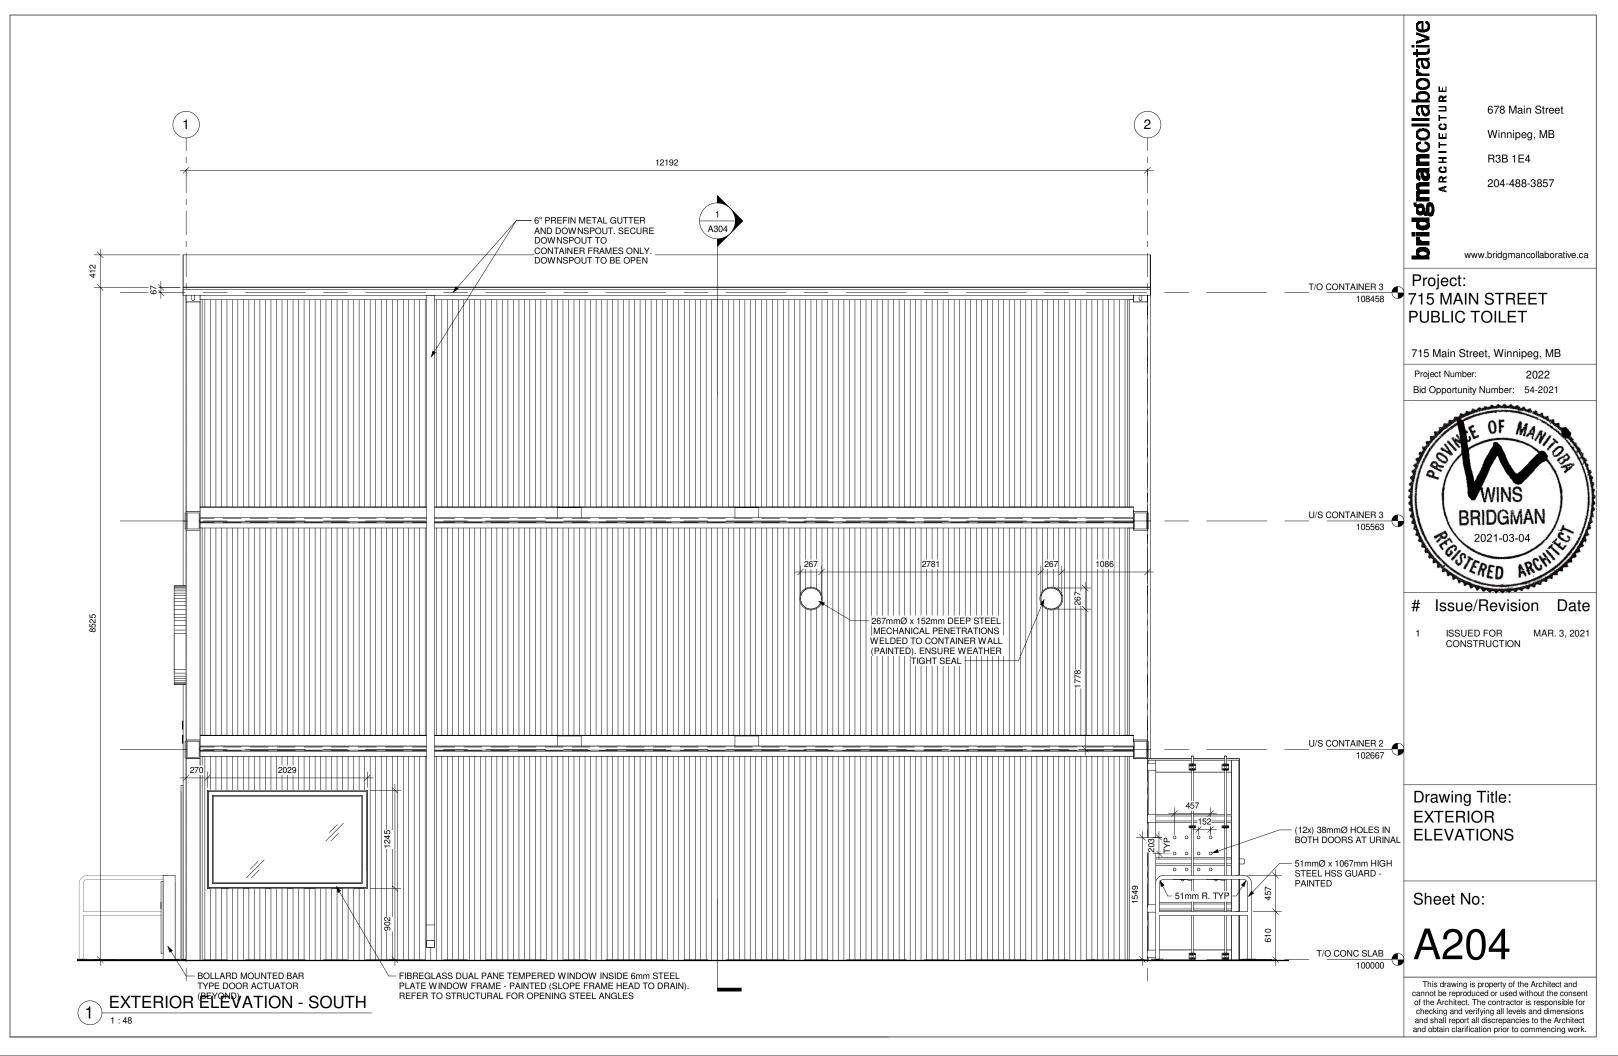

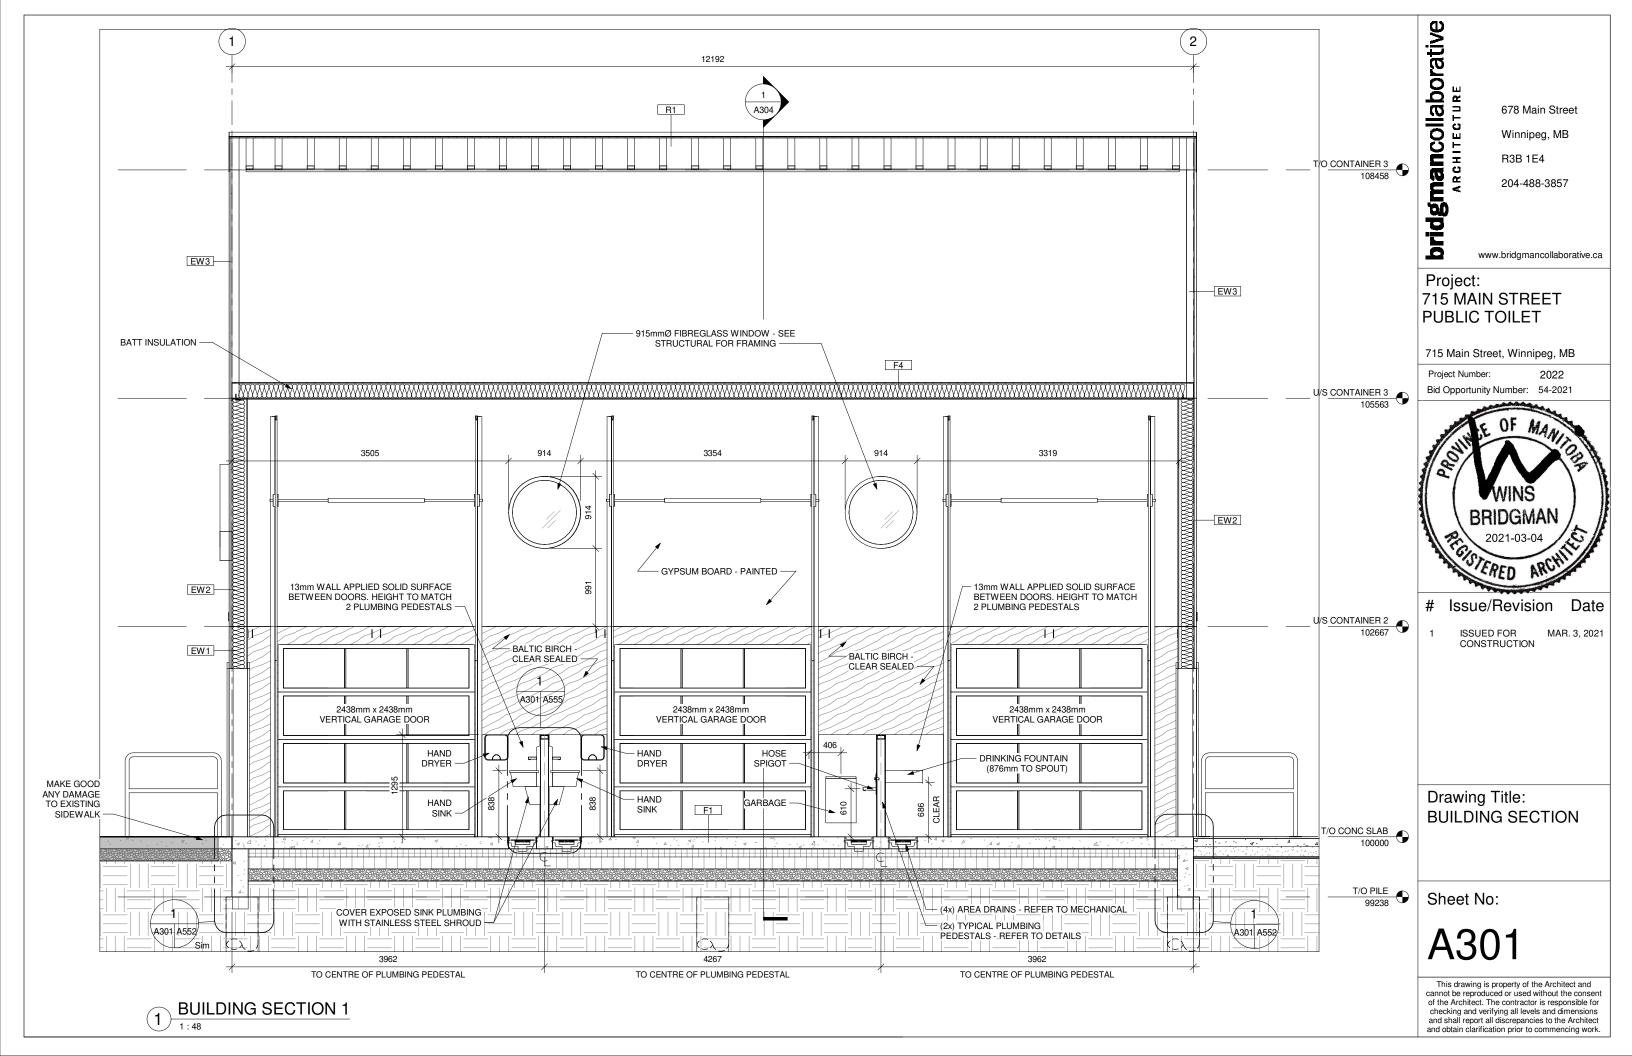

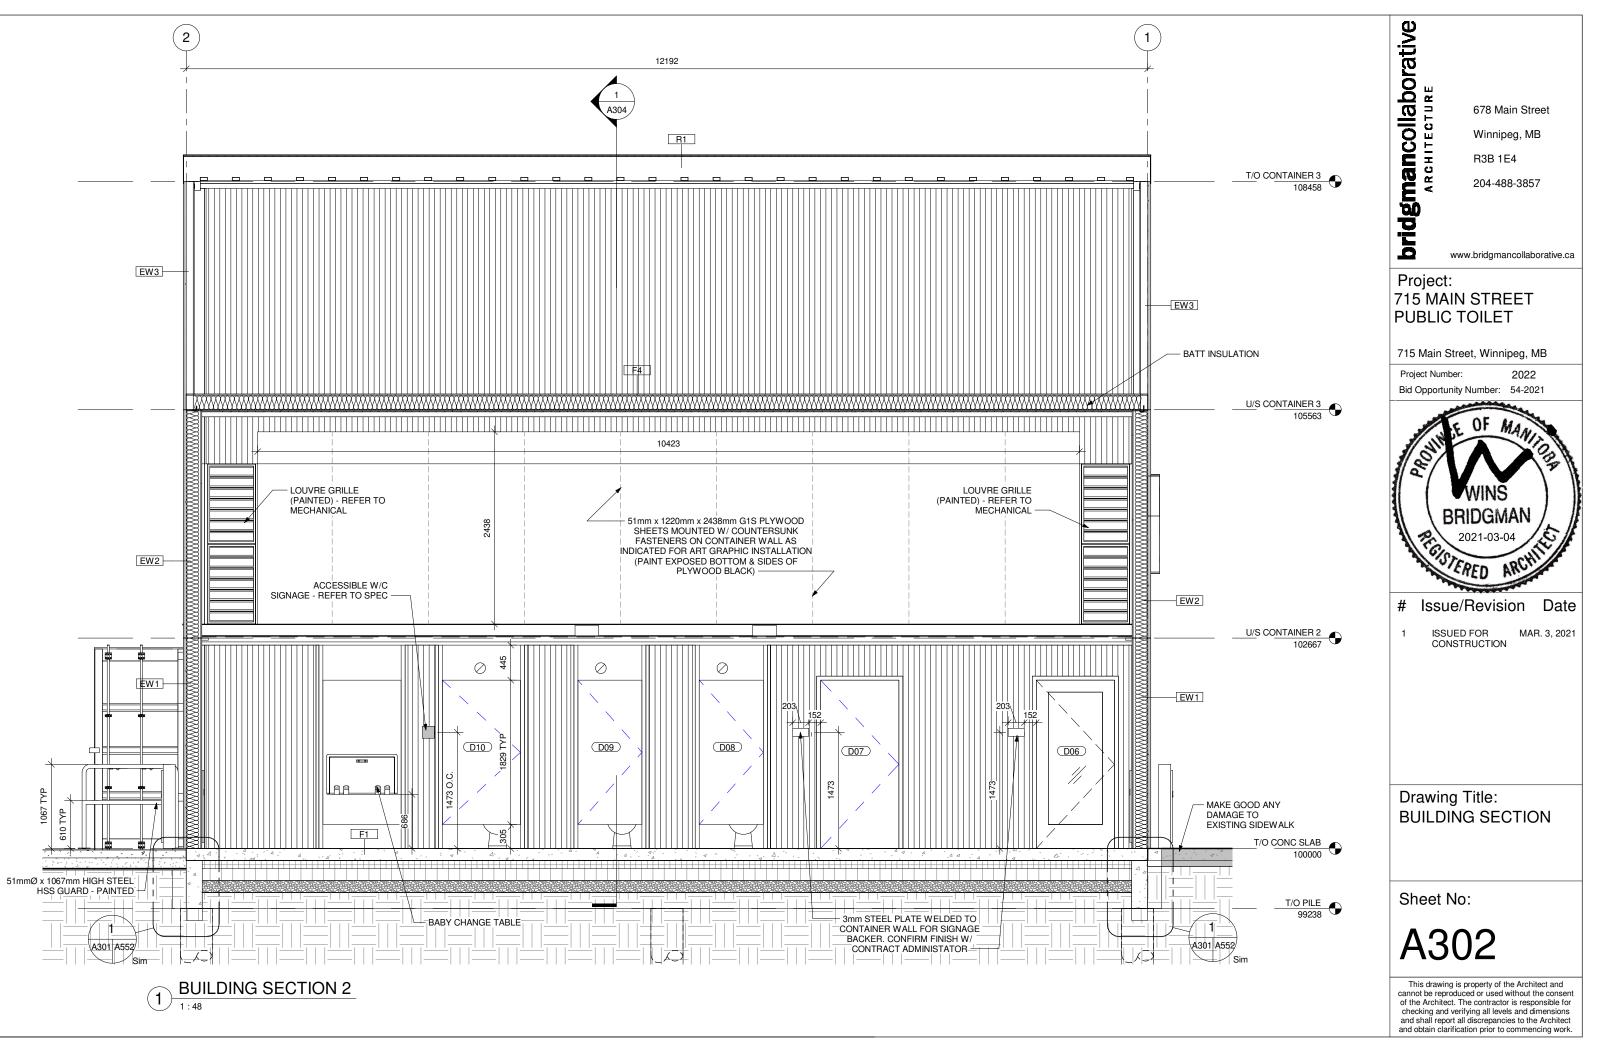


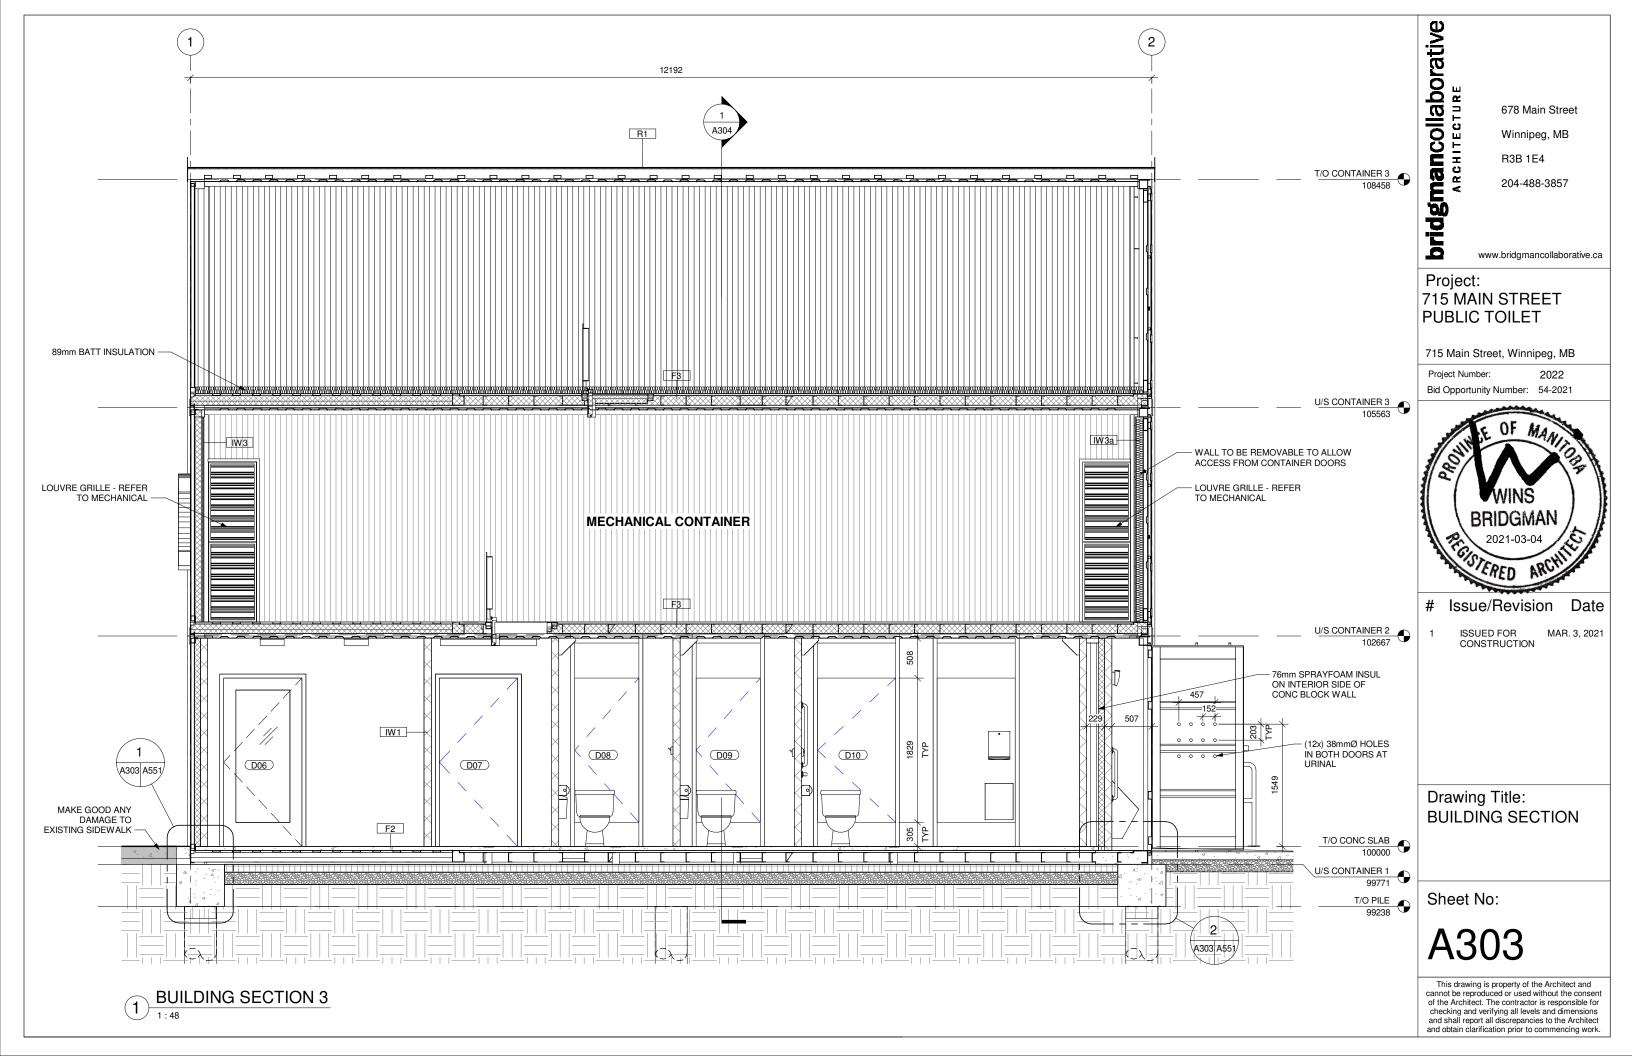


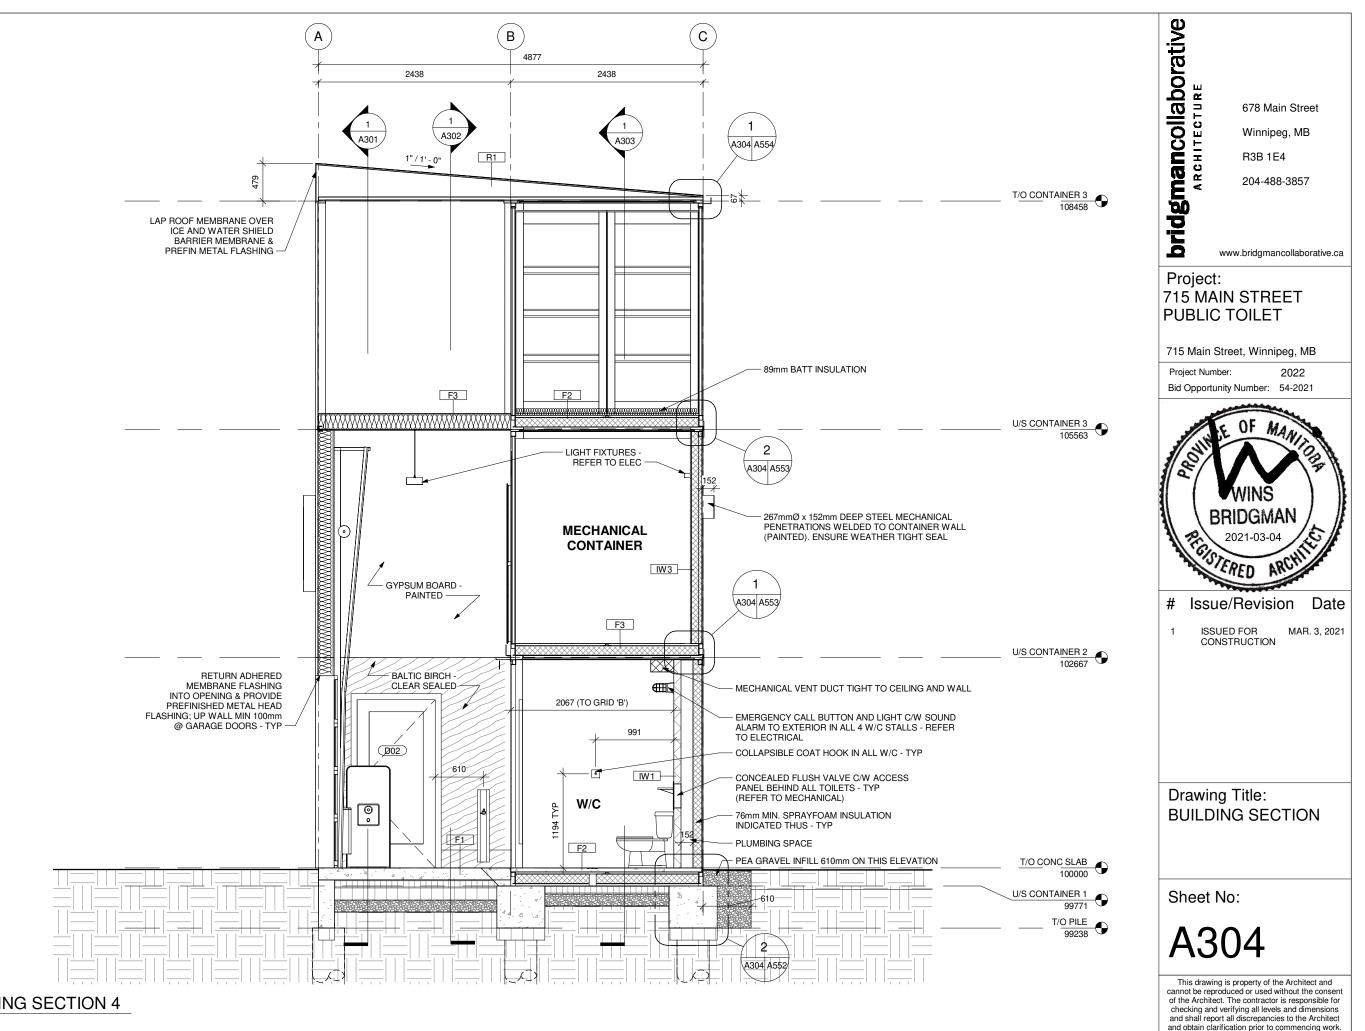


**BUILDING SECTION 4** (1)


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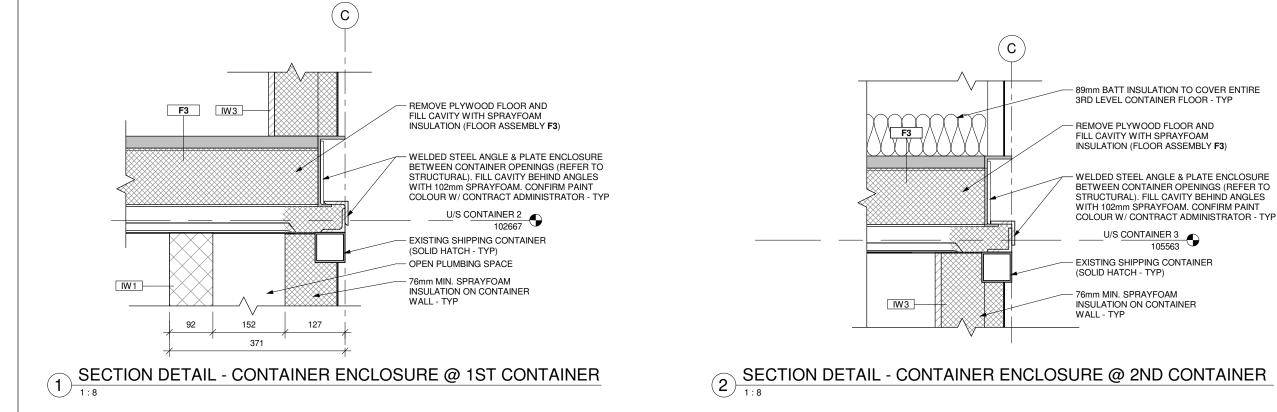


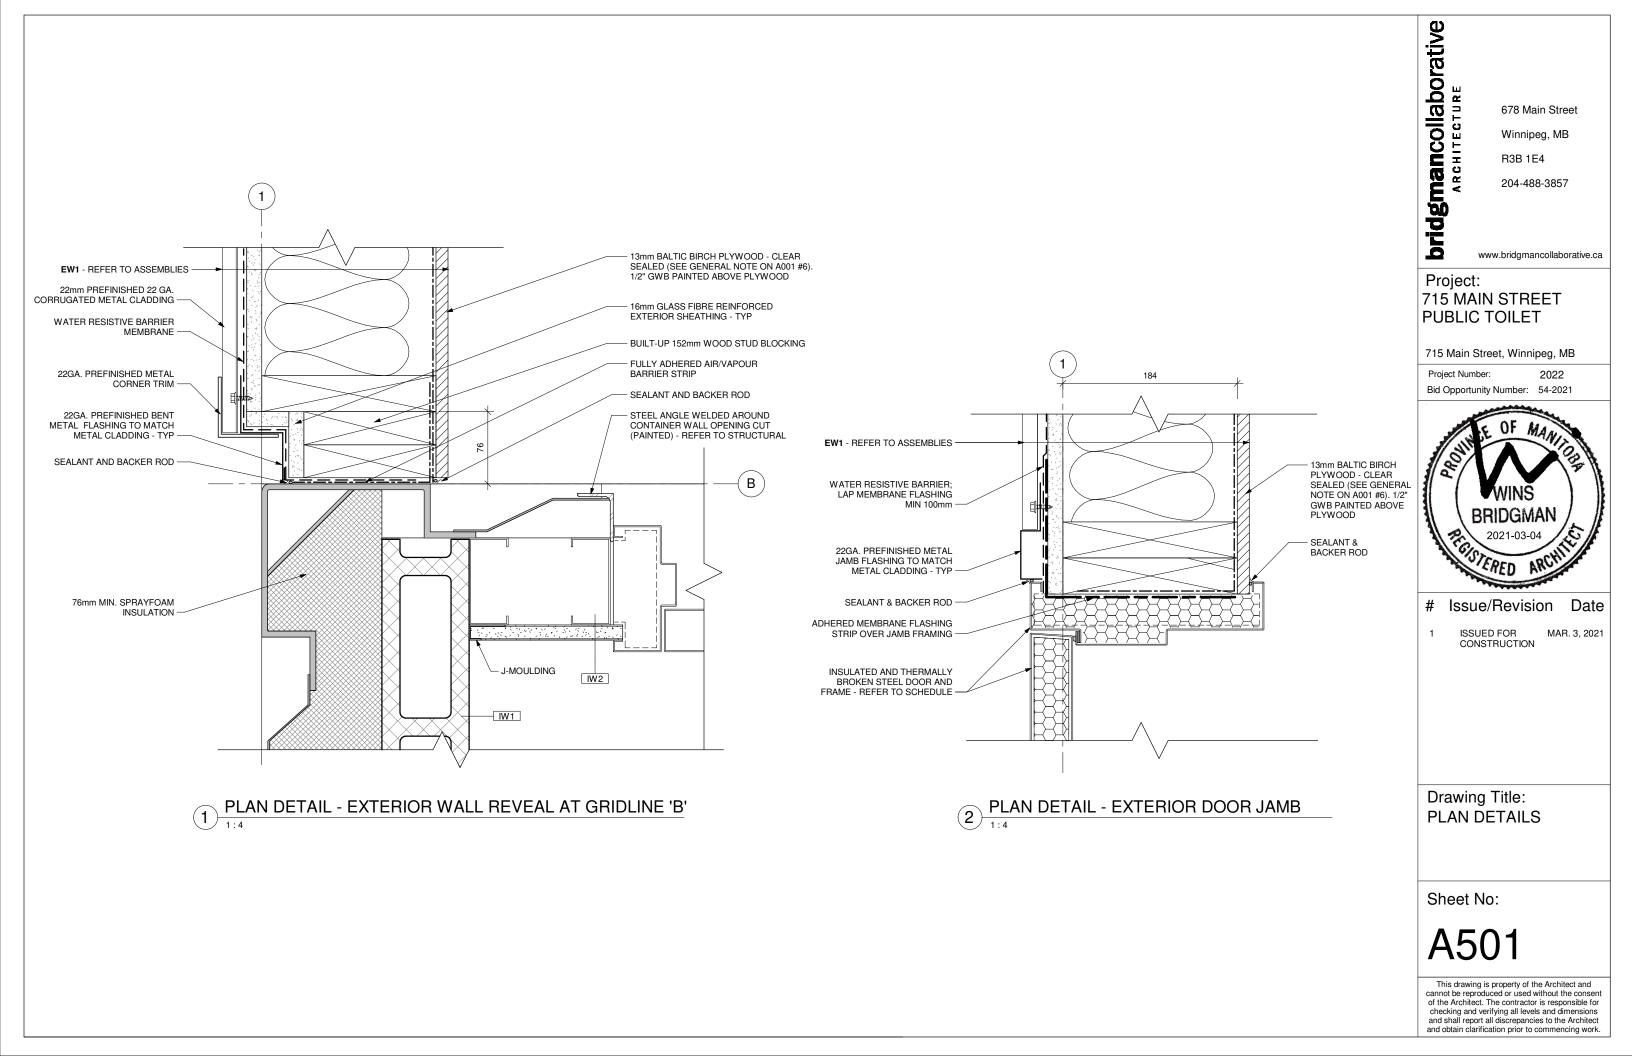

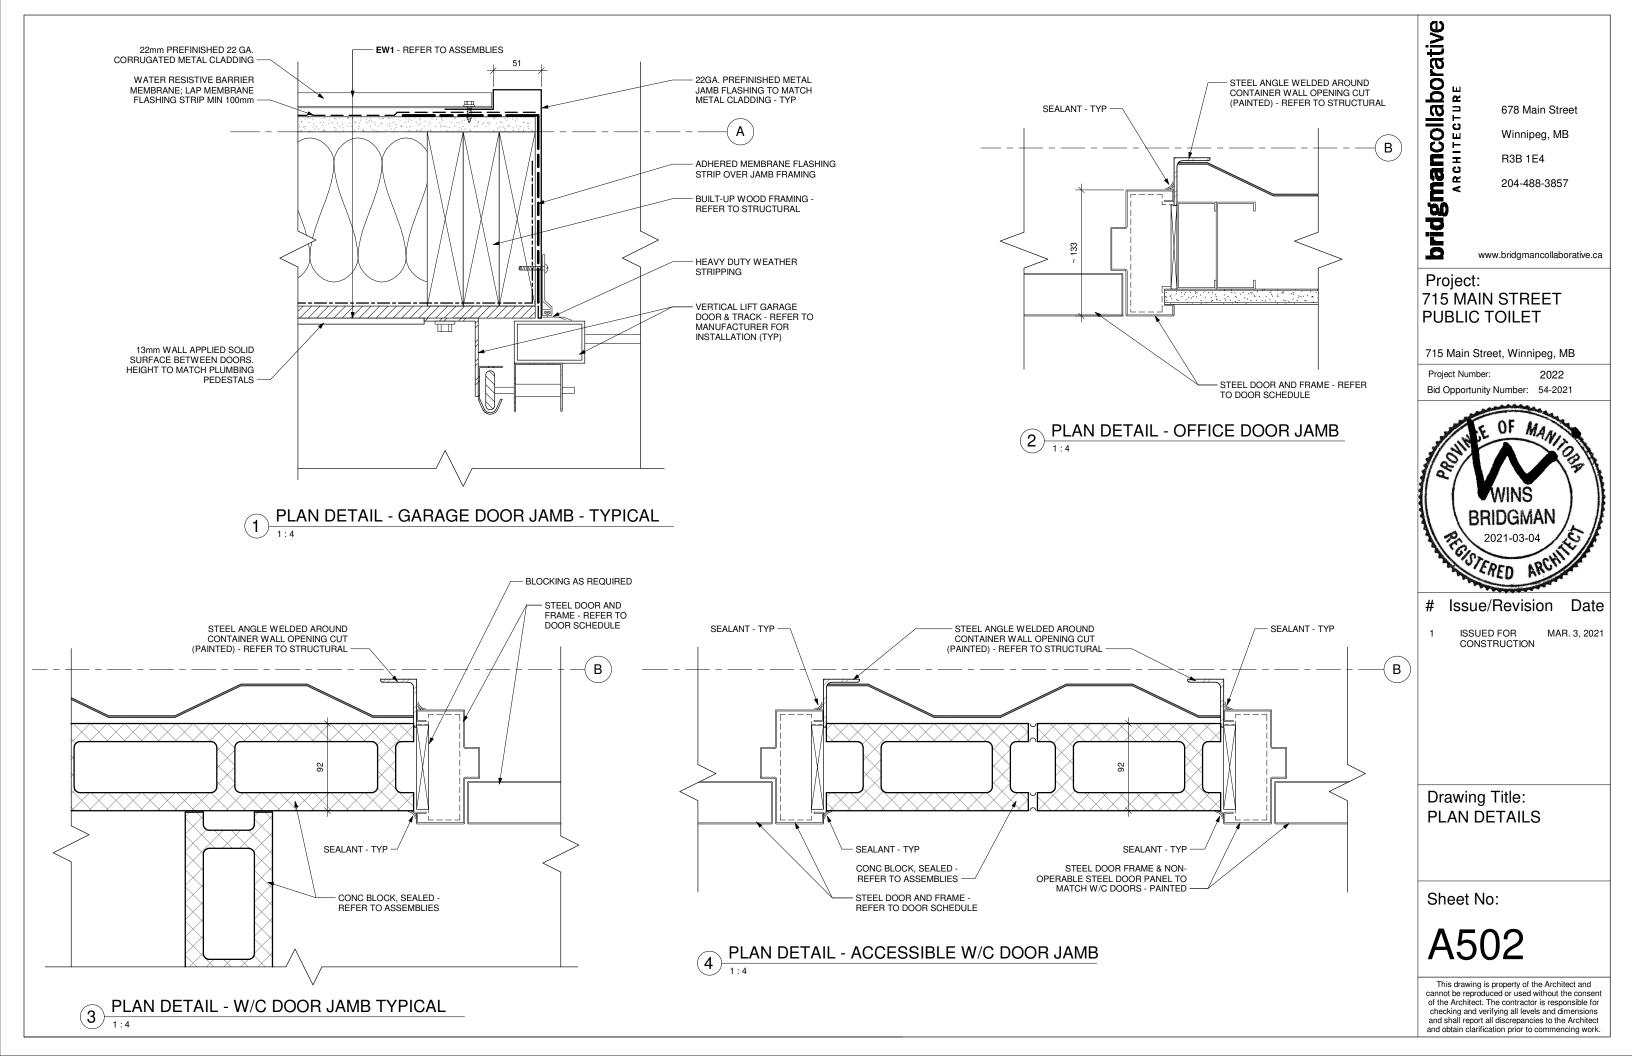


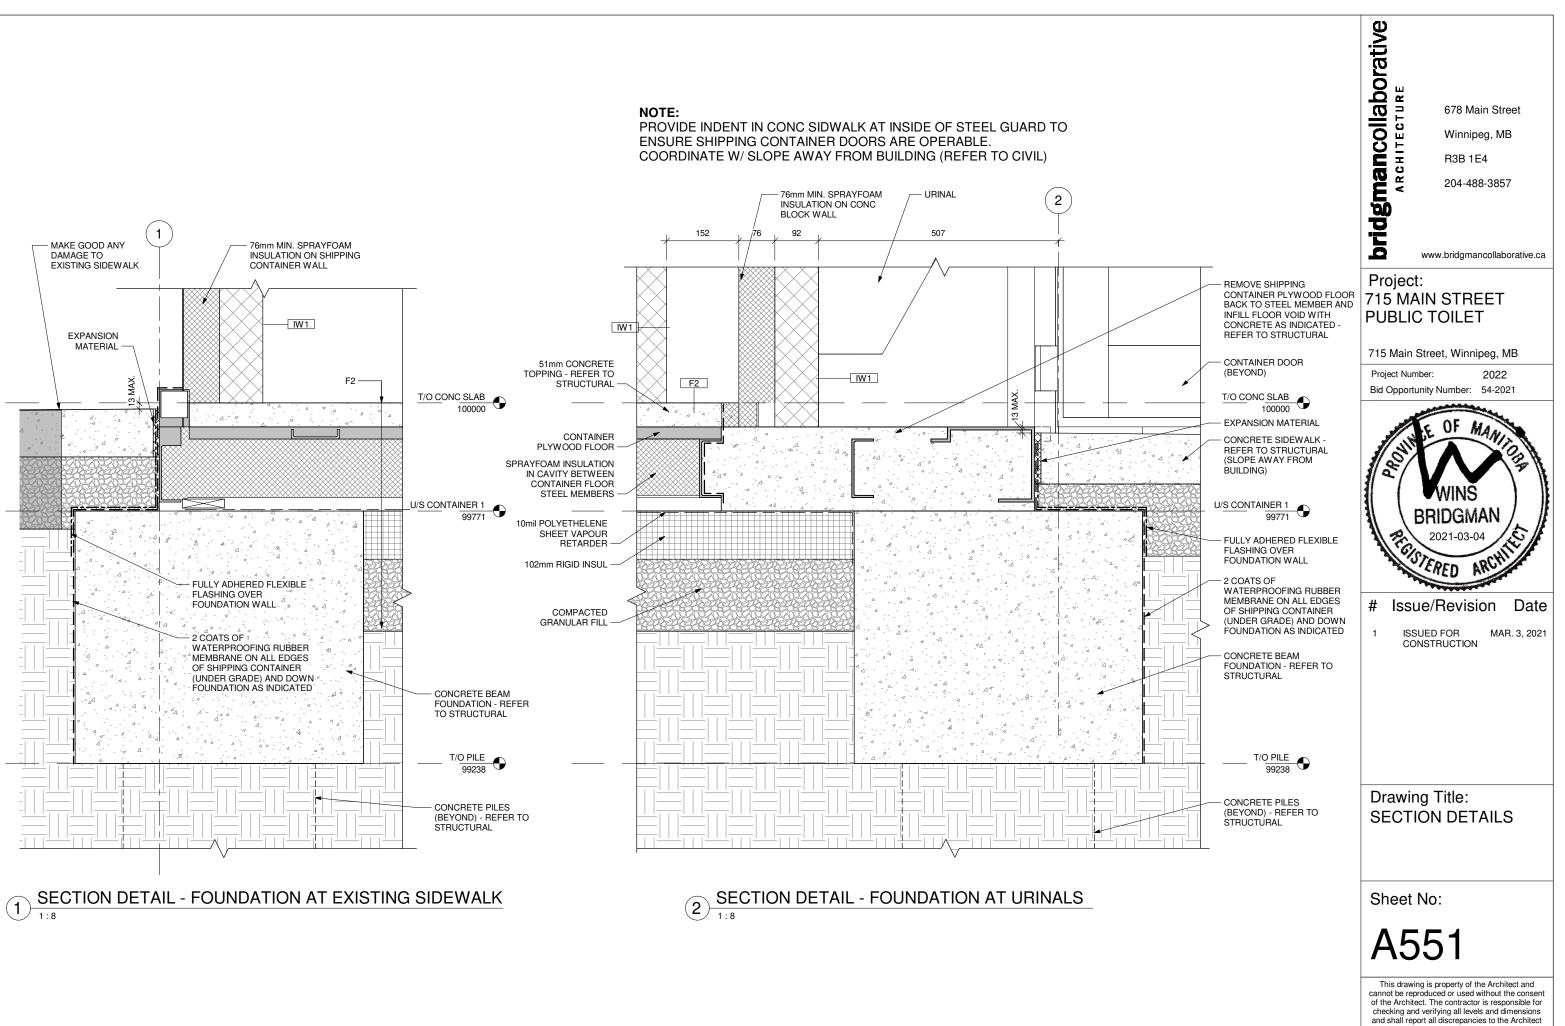and obtain clarification prior to commencing work.




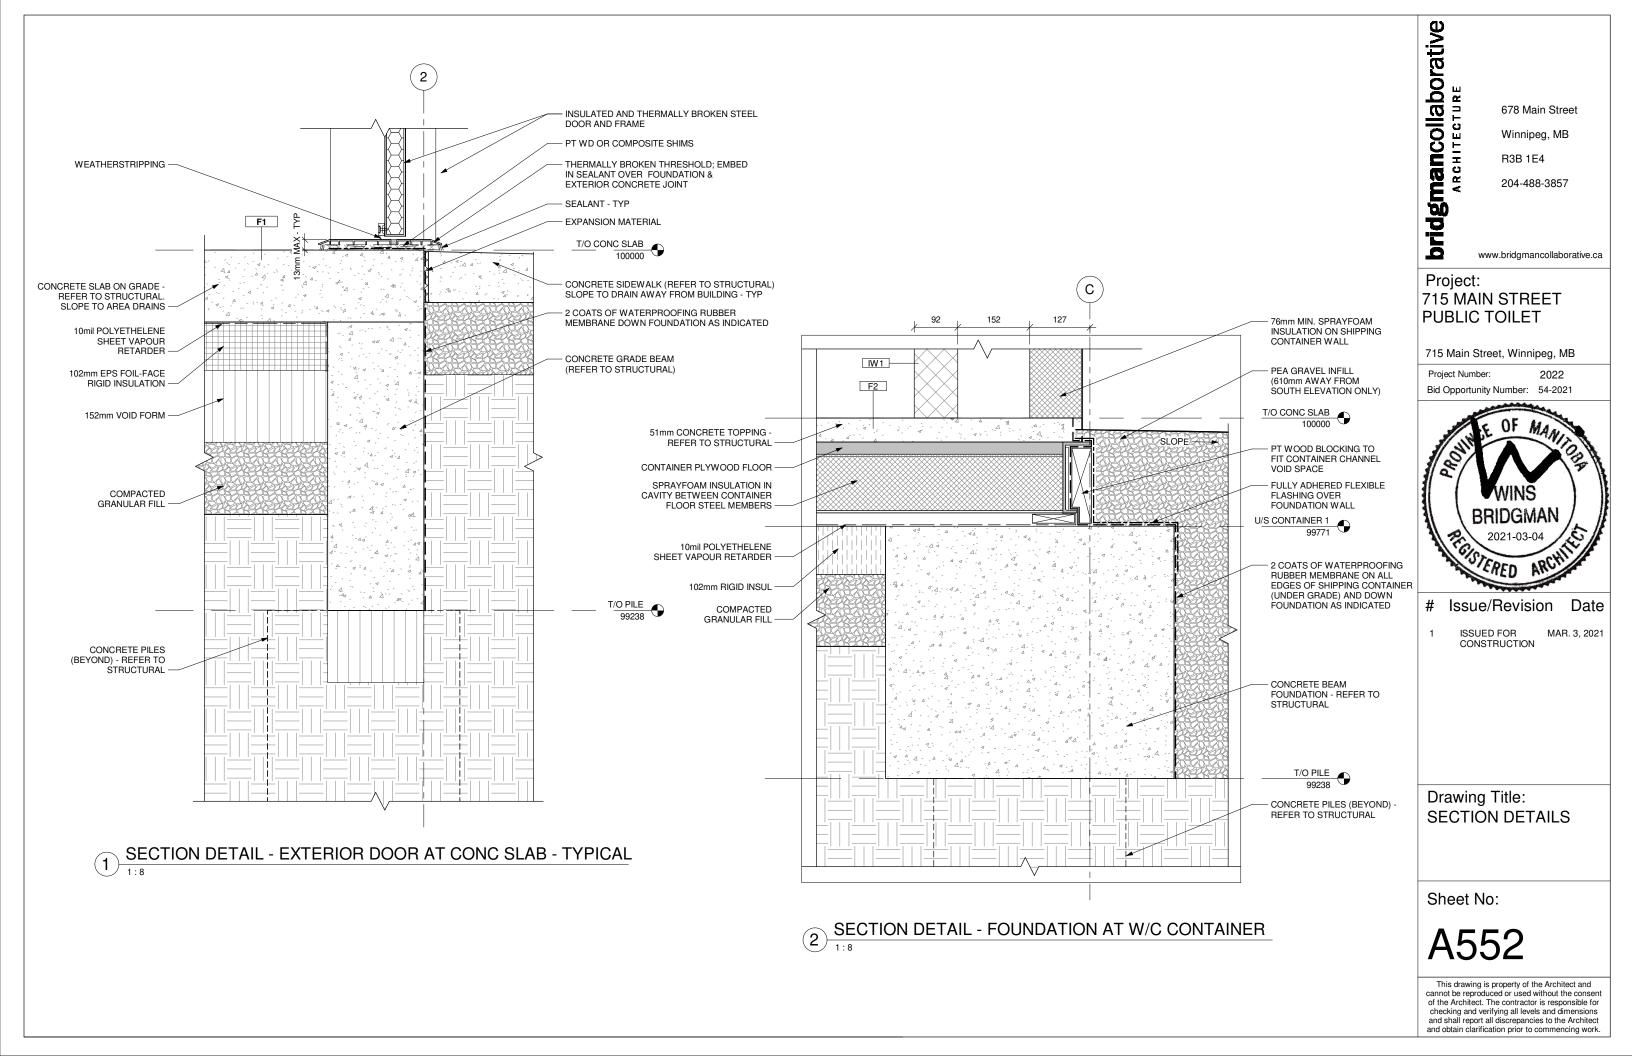





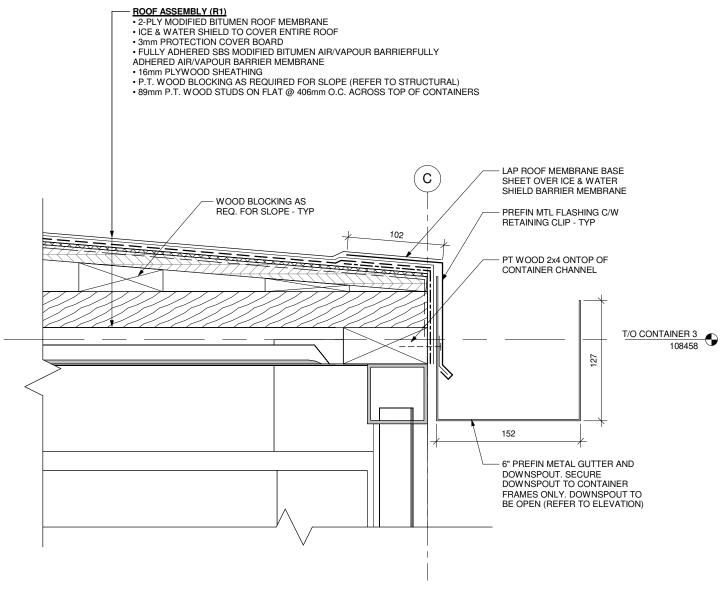


1 SECTION DETAIL - ROOF @ SOUTH ELEV GUTTER

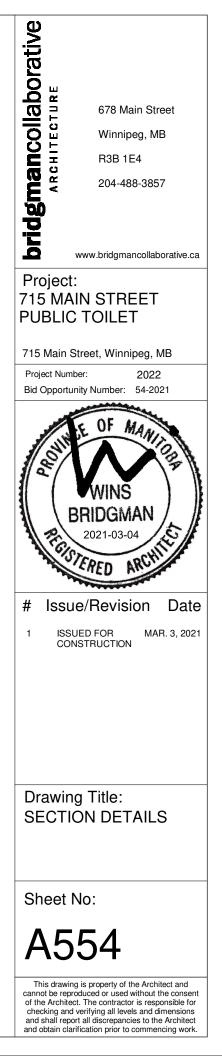


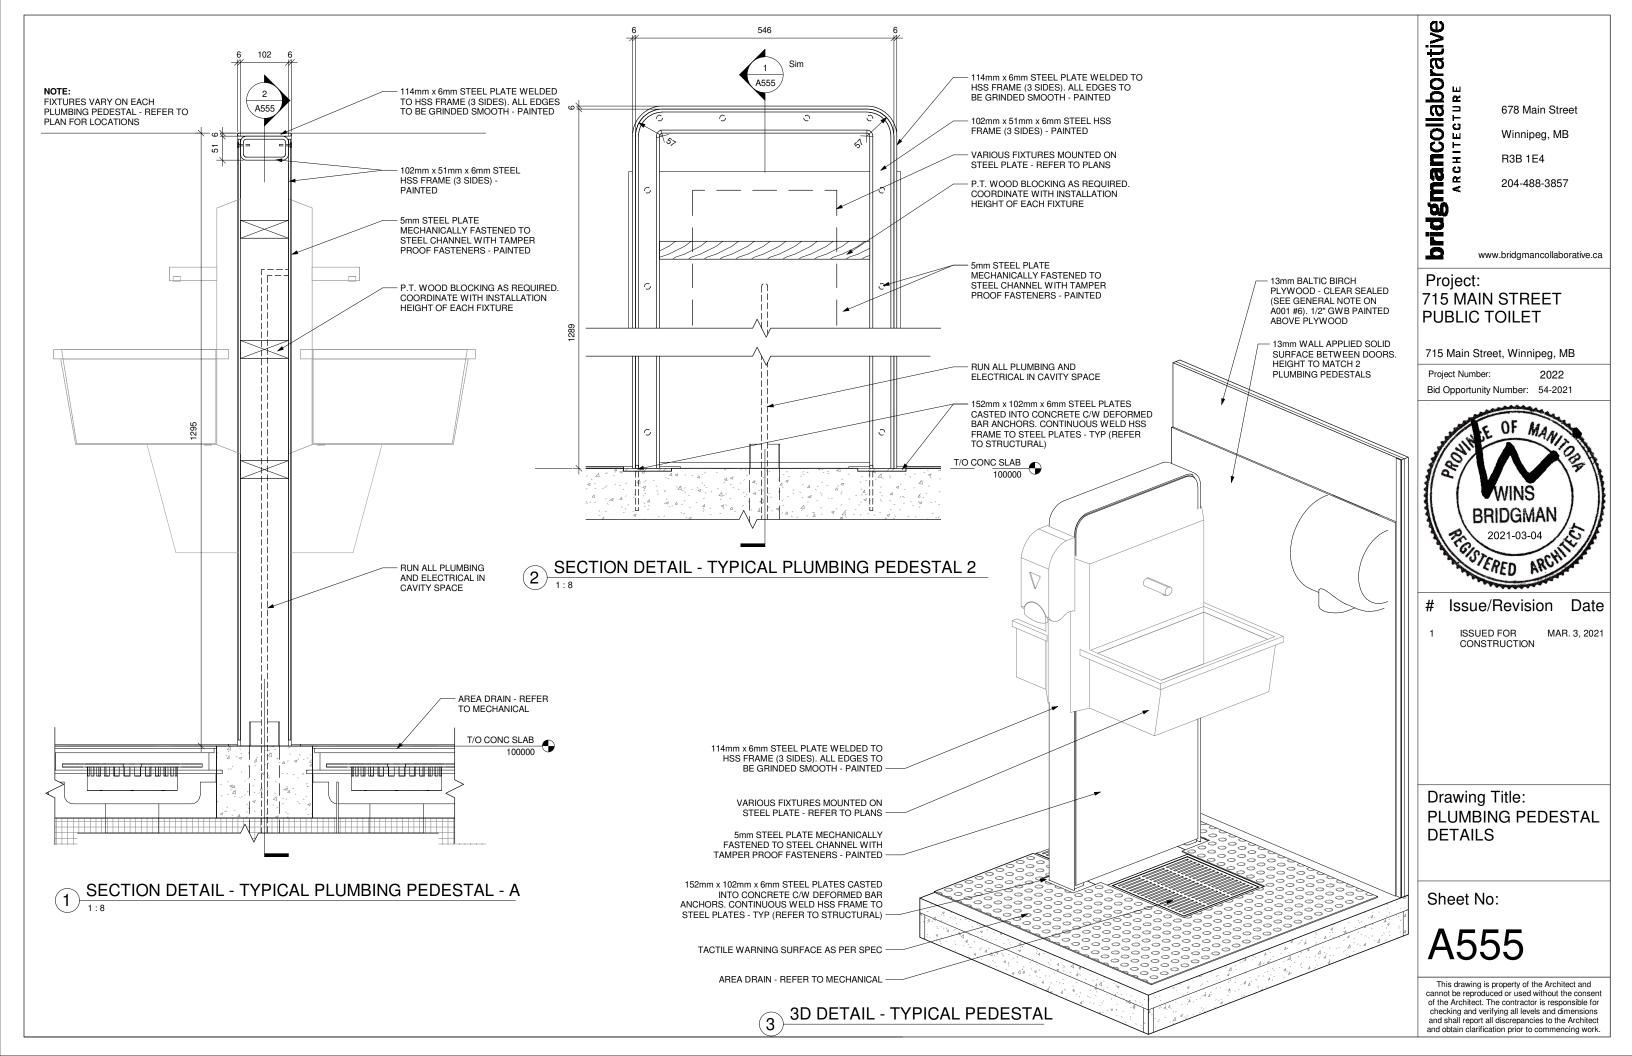


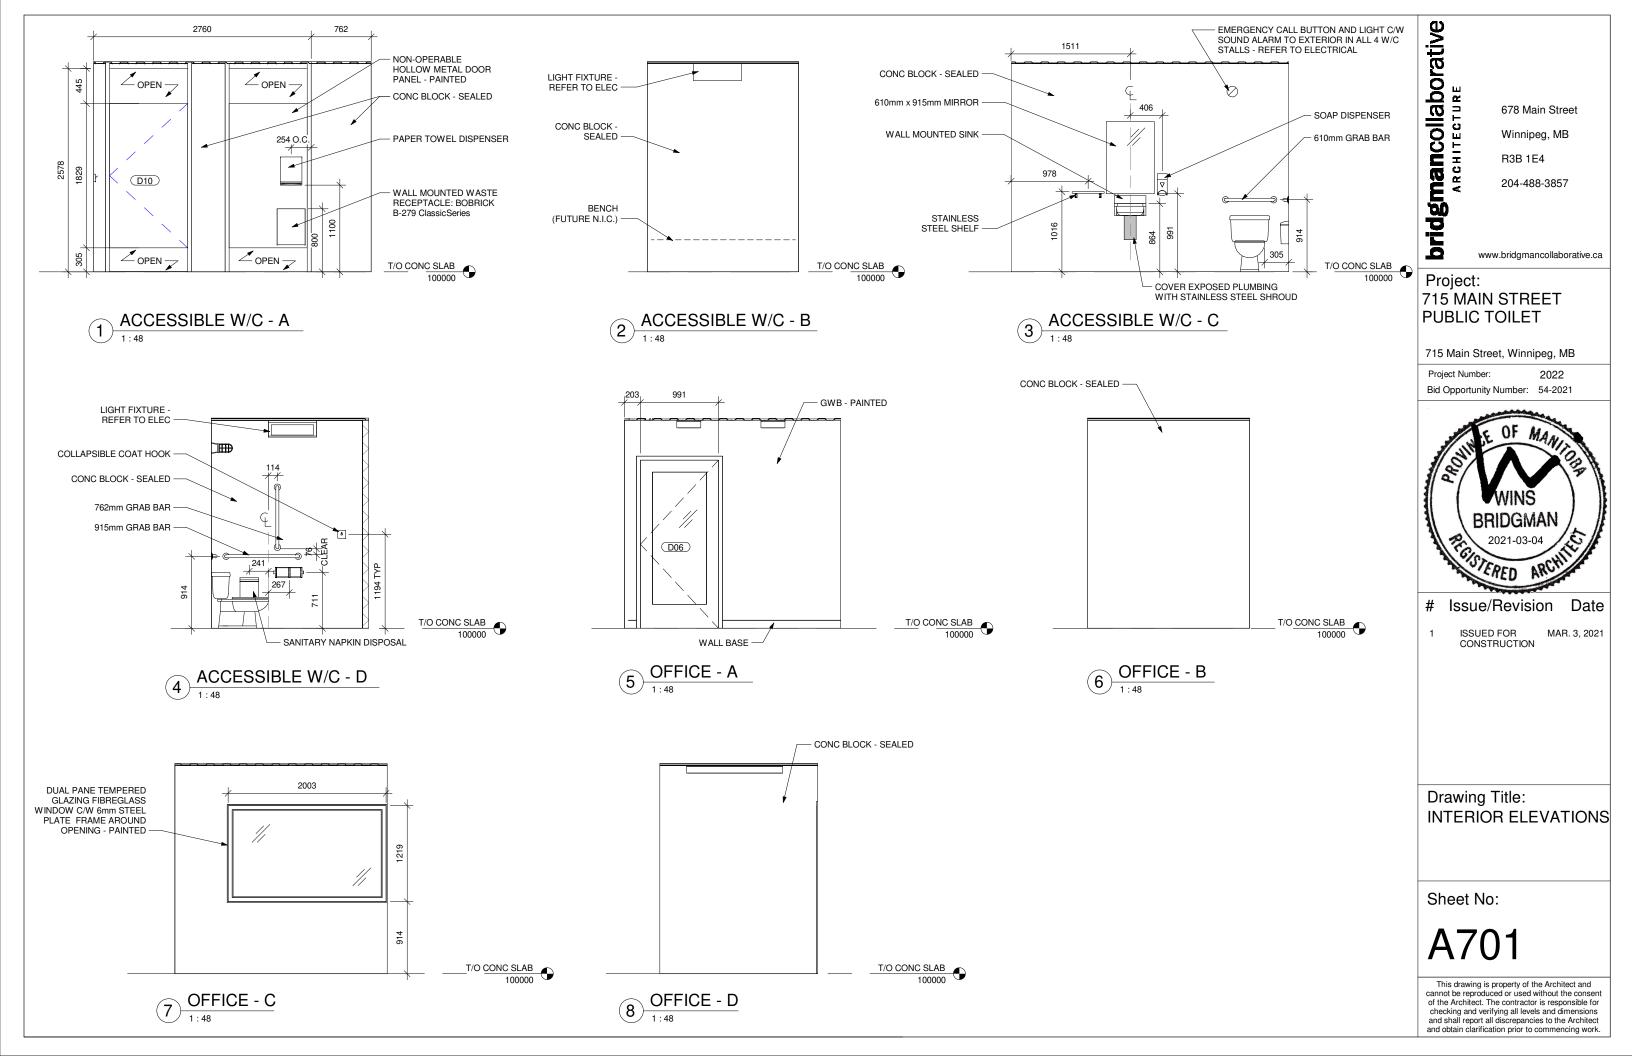

								DOOF	R SCHE	DULE					
DOOF NUMBE		HARWARE SET	DOOR TYPE	WIDTH	HEIGHT		DOOR MATERIAL	DOOR FINISH	DOOR FIRE RATING	INSULATED	FRAME TYPE	FRAME MATERIAL	FRAME FINISH	FRAME FIRE RATING	GLAZING TYPE
INUIVIDE	ROOM NAME	SEI	DOOR TYPE	WIDTH	HEIGHT	THICKINESS	DOOR MATERIAL	DOOR FINISH	RATING	INSULATED	TTPE	MATERIAL	FRAME FINISH	HATING	GLAZING TYPE
D01	SINK AREA	1	DT1	991	2134	51	HOLLOW METAL	PAINTED	N/A	YES	FT1	HOLLOW METAL	PAINTED	N/A	DUAL, TEMPERED, LAMINATE
D02	SINK AREA	1	DT1	991	2134	51	HOLLOW METAL	PAINTED	N/A	YES	FT1	HOLLOW METAL	PAINTED	N/A	DUAL, TEMPERED, LAMINATE
D03	SINK AREA	MANUFAC	DT5	1829	2438	AS PER MFG	ALUMINUM	ANODIZED CLEAR ALUM	N/A	YES		ALUMINUM	ANODIZED CLEAR ALUM	N/A	SINGLE, TEMPERED
D04	SINK AREA	MANUFAC	DT5	2438	2438	AS PER MFG	ALUMINUM	ANODIZED CLEAR ALUM	N/A	YES		ALUMINUM	ANODIZED CLEAR ALUM	N/A	SINGLE, TEMPERED
D05	SINK AREA	MANUFAC	DT5	2438	2438	AS PER MFG	ALUMINUM	ANODIZED CLEAR ALUM	N/A	YES		ALUMINUM	ANODIZED CLEAR ALUM	N/A	SINGLE, TEMPERED
D06	OFFICE	3	DT2	991	2134	44	HOLLOW METAL	PAINTED	N/A	NO	FT1	HOLLOW METAL	PAINTED	N/A	SINGLE PANE TEMPERED, LA
D07	STOR / JAN	3	DT3	991	2134	44	HOLLOW METAL	PAINTED	N/A	NO	FT1	HOLLOW METAL	PAINTED	N/A	N/A
D08	W/C	4	DT4	813	1829	44	HOLLOW METAL	PAINTED	N/A	NO	FT2	HOLLOW METAL	PAINTED	N/A	N/A
D09	W/C	4	DT4	813	1829	44	HOLLOW METAL	PAINTED	N/A	NO	FT2	HOLLOW METAL	PAINTED	N/A	N/A
D10	ACCESS W/C	4	DT4	991	1829	44	HOLLOW METAL	PAINTED	N/A	NO	FT2	HOLLOW METAL	PAINTED	N/A	N/A

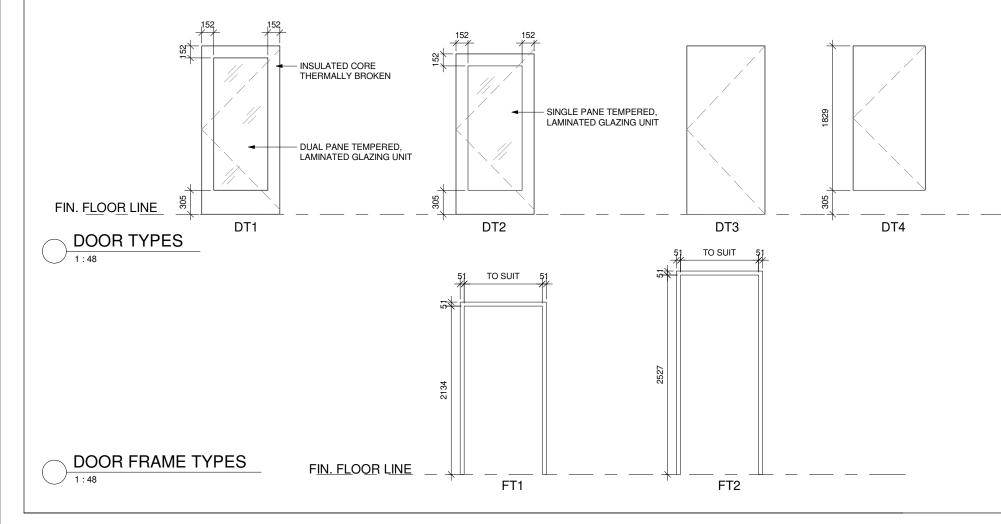

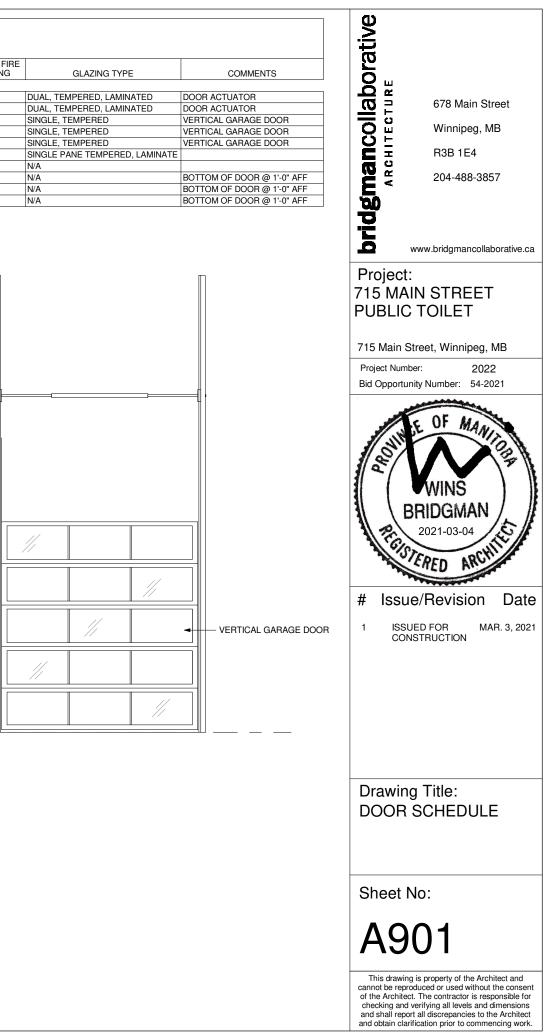

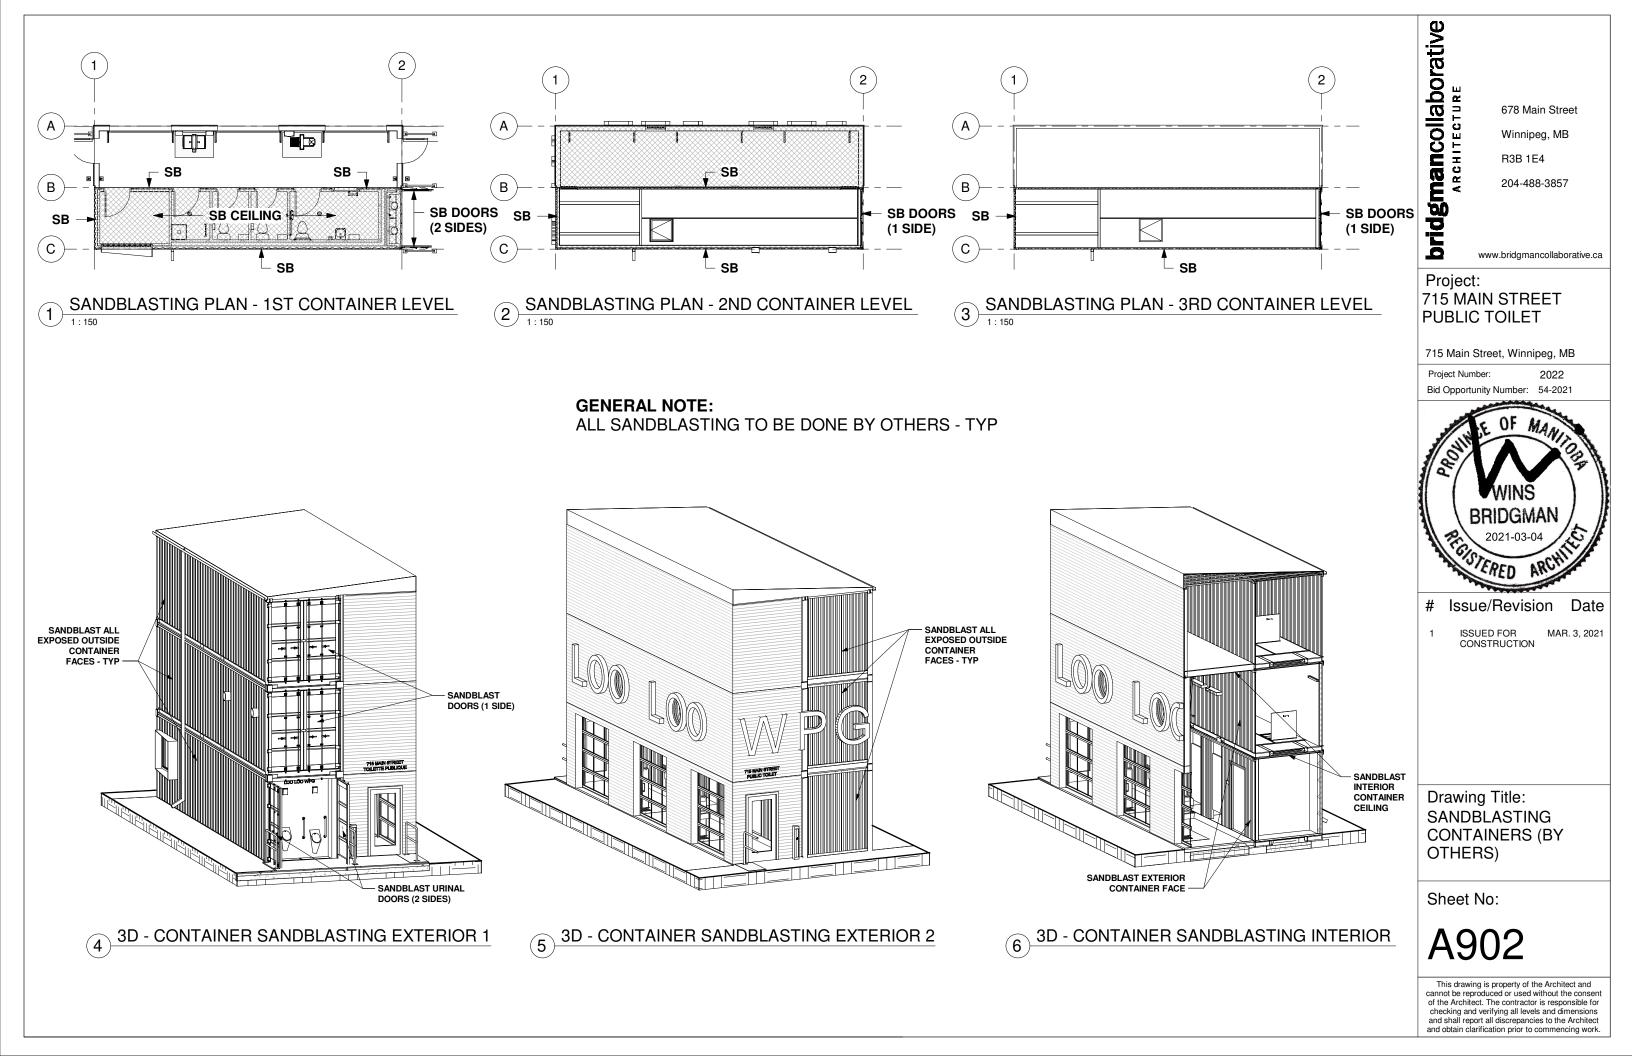

## 1. CIVIC ADDRESS:

### LOO LOO WINNIPEG 715 MAIN ST., WINNIPEG, MB

## 2. DRAWING INDEX:

- E01.0 TITLE SHEET E01.1 - SITE PLAN E02.1 - MAIN LEVEL - POWER LAYOUT
- E02.2 MAIN LEVEL LIGHTING LAYOUT
- E02.3 MAIN LEVEL LOW VOLTAGE SYSTEMS E03.1 - SECOND LEVEL - POWER LAYOUT
- E03.2 SECOND LEVEL LIGHTING LAYOUT
- E06.0 SINGLE LINE DIAGRAM & SCHEDULES E08.1 - INSTALLATION SPECIFICATIONS - PART 1
- E08.2 INSTALLATION SPECIFICATIONS PART 2

### 3. WARNING:

THIS DRAWING MUST BE READ IN CONJUNCTION WITH THE LATEST ARCHITECTURAL, STRUCTURAL, CIVIL, MECHANICAL, AND LANDSCAPE DRAWINGS.

BEFORE ROUGH-IN WIRING, REFER TO ARCHITECTURAL DRAWING FOR EXACT LAYOUT, DIMENSIONS AND ELEVATIONS.

ANY CHANGES TO DRAWINGS SHALL BE IN WRITING & AUTHORIZED BY THE CONTRACT ADMINISTRATOR.

ELECTRICAL CONTRACTOR TO SUPPLY & INSTALL ELECTRICAL EQUIPMENT NOTED ON PLANS FOR A WORKING SYSTEM UNLESS OTHERWISE NOTED.

DO NOT SCALE OFF DRAWINGS.

## 4. ELECTRICAL CONTRACTOR TENDER NOTES

## 4.1. EQUIPMENT:

- ALL WORK MUST SATISFY THE REQUIREMENTS OF THE CURRENT THE WINNIPEG ELECTRICAL 4.1.1. BYLAW, MANITOBA BUILDING CODE, AND ALL AUTHORITIES HAVING JURISDICTION.
- 4.1.2. THE ELECTRICAL CONTRACTOR SHALL NOT UNDER ANY INSTANCE REDUCE THE STANDARD ESTABLISHED BY THE CONTRACT DOCUMENTS BY ANY OF THESE CODES OR REGULATIONS REFEREED TO IN (3).
- ANY PROPOSED RELOCATION(S) BY THE ELECTRICAL CONTRACTOR OF ELECTRICAL EQUIPMENT 4.1.3. AND OTHER EQUIPMENT THAT REQUIRES ELECTRICAL POWER/CONNECTIONS (FROM THAT SHOWN ON THE DRAWINGS) MUST BE APPROVED BY THE CONTRACT ADMINISTRATOR/CLIENT IN WRITING.

### 4.2. DOCUMENTS:

- 4.2.1. CONTRACTORS PRICING/TENDERING MUST OBTAIN A COMPLETE SET OF CURRENT DOCUMENTS INCLUDING ARCHITECTURAL, MECHANICAL, PLUMBING, SPRINKLER, STRUCTURAL, SURVEY AND ALL OTHER DRAWINGS/SPECIFICATIONS FOR THIS PROJECT.
- CERTAIN INFORMATION REQUIRED TO PROPERLY PRICE WORK INDICATED ON THE ELECTRICAL 4.2.2. DRAWINGS MAY BE FOUND IN OTHER CONSULTANTS DRAWINGS.

## 5. UTILITY:

POWER/TELERHONE/CABLEVISION INCOMING SERVICE (LOCATION OF EOUIPMENT/DUCT ROUTING) INFORMATION TO BE CONFIRMED. (INFORMATION SHOWN IS TO FACILITATE DISCUSSION WITH AUTHORITY ON PROPOSED SERVICE ENTRY PREFERRED LOCATION AND ARE FOR THAT PURPOSE ONLY).

## 6. <u>NOTES:</u>

6.1. UTILITIES:

**IBASA** ENTERPRISES Design & Consulting

490 Paul Blvd. Winnipeg, MB R2N 4C8 T. 204-515-1158

www.ibasa.ca

info@ibasa.ca

- 6.1.1. ALL UNDERGROUND UTILITY SLEEVES/DUCTS ARE TO BE INSTALLED AS PER CEC 12-012, ELECTRICAL & COMMUNICATION UNDERGROUND INSTALLATION TO RUN IN JOINT TRENCH WHERE POSSIBLE TO THE BUILDING. BENDS MUST BE OF MINIMUM BEND RADIUS OF 36".
- 6.1.2. ELECTRICAL CONTRACTOR MUST CO-ORDINATE ROUTING AND INSTALLATION OF ALL UNDERGROUND DUCTS WITH:
- 6.1.2.1. UTILITIES (HYDRO, TELEPHONE, GAS, CABLE) REGARDING EXACT ROUTING, DEPTH OF BURIAL AND OTHER REQUIREMENTS.
- 6.1.2.2. MECHANICAL AND GENERAL CONTRACTOR REGARDING INTERFERENCE WITH STORM SEWER, SANITARY SEWER, GAS LINES, CATCHBASINS, AND SIMILAR UNDERGROUND SITE/CITY SERVICES.
- 6.1.3. SEAL THE DUCTS FROM UTILITY SIDE TO PREVENT WATER ACCUMULATION IN DUCTS. IF THAT CANNOT BE ENSURED, PROVIDE SERVICE DUCTS WITH A DRAIN CONNECTION BEFORE ENTRY TO THE BUILDING. THIS DRAIN IS INTENDED FOR RELIEF OF INCIDENTAL WATER ENTERING THE DUCT. THE DRAIN MUST NOT BE USED TO HANDLE ANY FORM OF AREA DRAINAGE.
- 6.1.4. ALL SERVICE DUCTS MUST BE SEALED AT POINT OF ENTRY INTO BUILDING THROUGH WALLS. THE SEAL SHALL PREVENT WATER ENTRY INTO THE BUILDING THROUGH THE WALL PENETRATION AND IN ADDITION, THE INSIDE OF THE DUCTS (WHERE POSSIBLE) MUST ALSO BE SEALED AGAINST WATER ENTRY. ENSURE WATERPROOF MATERIAL DOES NOT OBSTRUCT DUCT DRAIN WHEN PROVIDED.
- WHEN INSTALLED OUTDOORS, ARC PRODUCING ELECTRICAL EQUIPMENT/POWER METER SHALL 6.1.5. NOT BE INSTALLED WITHIN 1 METER OF THE COMBUSTIBLE GAS METER. GAS RELIEF DEVICE OR VENT.
- CO-ORDINATE WITH THE GENERAL CONTRACTOR, HYDRO, ELECTRICAL INSPECTOR AND WITH 6.1.6. ALL AUTHORITIES HAVING THE JURISDICTION FOR THE
- 6.1.6.1. MECHANICAL PROTECTION (STEEL PROTECTION) POSTS UTILITY AND CODE.

- 6.1.6.2. MECHANICAL PROTECTION POSTS TO BE PROVIDED (SUPPLY/INSTALLATION) BY THE GENERAL CONTRACTOR.
- 6.1.6.3. PROTECTION OF EXISTING TREES/SHRUBS: ELECTRICAL CONTRACTOR MUST CO-ORDINATE ROUTING OF ALL UNDERGROUND DUCTS AND ALL UNDERGROUND WIRING WITH ARCHITECT SITE-SUPERVISOR AND LANDSCAPE ARCHITECT TO PROTECT AND MAINTAIN EXISTING TREES AND SHRUBS AS INDICATED ON LANDSCAPE AND ARCHITECTURAL DRAWINGS.

## 6.2. OUTDOOR LIGHTS:

- 6.2.1. THE OUTDOOR LIGHTS (LANDSCAPE, BUILDING PERIMETER, ROADWAY, ETC.) SHALL BE CONTROLLED BY PHOTOCELL AND TIME CLOCK, VIA CONTACTOR(S).
- 6.2.2. REFER TO DRAWINGS FOR LIGHTING LAYOUT AND LUMINAIRE SCHEDULE.
- 6.2. CAUTION: ALL OTHER SUBCONSULTANTS/TRADES ELECTRICAL ROOM:
- 6.3. NO LAVATORIES, BATH TUBS, ETC. ON FLOOR AREA ABOVE THE ELECTRICAL ROOM. IF EQUIPMENT ABOVE HAVE TO BE LOCATED ABOVE TO ELECTRICAL ROOM DUE TO FLOOR AREA
- LIMITATION, PROVIDE ADEQUATE PROTECTION TO ELECTRICAL EQUIPMENT TO PREVENT LEAKED WATER, CONDENSATION WATER, AND ANY OTHER FORM OF WATER FROM ACCIDENTAL AND SUDDEN DISCHARGE ON ELECTRICAL REQUIREMENT.

	ABBREVIATIONS
FFL	FINISH FLOOR LEVEL
AFF	ABOVE FINISH FLOOR
FGL	FINISH GRADE LEVEL
MOUNTING HEIGHTS	TO UNDERSIDE OF THE ROUGH-IN OF THE SAID INSTALLATION
NL	NIGHT LIGHT
FF	FORCE FLOW UNIT
U/G	UNDER GROUND
WP	WEATHER PROOF

VERIFY SHEET	SIZE. BAR TO THE RIGHT	
IS 1" IF THIS	IS A FULL SIZE DRAWING.	0


	LEGEND		VOICE / DATA OUTLET
		>	TV/CABLE OUTLET
D)	DOOR ASSISTS ACTIVATOR PUSH BUTTON		POWER PANELBOARD – FLUSH MOUNT/SURFACE MOUNT
NL		et al	COMMUNICATION BOARD
\$3	SINGLE POLE SWITCH (3 DENOTE 3 WAY SWITCH, D DENOTE DIMMER, OS DENOTE OCCUPANCY SENSOR)	••• •	HARDWIRED CONNECTION
	DUPLEX RECEPTACLE-C DENOTES UNDER COUNTER, M DENOTES MICROWAVE DESIGNATED, F DENOTES	0	MOTOR CONNECTION
φ	FLOOR, IPLC DENOTES IPLC BLOCK HEATER CONTROLLER, GFI GROUND FAULT CIRCUIT INTERRUPTER, C		DISCONNECT SWITCH-NUMBER OF POLES PER CIRCUIT DESIGNATION
	CEILING MOUNTED, M FOR MICROWAVE, ARC FOR ARC FAULT, S SURFACE MOUNTED		BATTERY PACK C/W EMERGENCY LIGHTS
$\ominus$	208/240V RECEPTACLE - CONFIGURATION BY AMPERAGE	A D	EMERGENCY LIGHTS - DUAL HEADS
#	QUAD RECEPTACLE	<b>É</b> ⊗	EMERGENCY LIGHT AND EXIT COMBO – ARROWS AS REQUIRED
J	JUNCTION BOX - CEILING/WALL	н⊗	EMERGENCY EXIT SIGN
⊠⊲	STROBE/HORN UNIT – FIRE ALARM SYSTEM (1 DENOTE TYPE, C DENOTE CEILING MOUNTED)	FA	FIRE ALARM PANEL
×	STROBE UNIT (1 DENOTE TYPE, C DENOTE CEILING MOUNTED)	ANN	FIRE ALARM ANNUNCIATION PANEL
F	PULL STATION - FIRE ALARM SYSTEM		
R	RELAY MODULE - FIRE ALARM SYSTEM	ЕМТ	ROUTING & GENERA
M	MONITOR MODULE - FIRE ALARM SYSTEM		INSTALLATION
0	CARBON MONOXIDE DETECTOR - FIRE ALARM SYSTEM		REQUIREMENTS
99	SMOKE DETECTOR	E	LECTRICAL CONTRACTOR TO SUPPLY & INSTALL MT CONDUITS ALL EMT & ELECTRICAL
DSD	SMOKE DETECTOR - DUCT MOUNTED	Al Ti	ISTALLATIONS FROM OFFICE & SECOND LEVEL REAS DESTINED TO SINK AREA TO BE ROUTED HROUGH THIRD LEVEL CONTAINER/WOOD. NO
Θ	HEAT DETECTOR - (D DENOTES DUCT MOUNTED, MP DENOTES MOISTURE PROOF)	R	ORIZONTAL EMT CONDUITS ALLOWED TO BE OUTED IN CEILING OF SINK AREA.
0	CARBON MONOXIDE ALARM - CONNECTED TO 120V NON-SWITCHED CIRCUIT C/W BATTERY BACKUP	AI	LECTRICAL CONTRACTOR TO ARRANGE & CARRY LL COSTS INVOLVED TO DRILL, WELD, RECTIFY, EPAIR, SUPPORT, SECURE, & PAINT TO RCHITECTURAL SPECIFICATIONS' CONDITION OF
□	HORN UNIT – FIRE ALARM SYSTEM (1 DENOTE TYPE, C DENOTE CEILING MOUNTED)	FI Ci SI	INISH ALL PENETRATIONS REQUIRED FOR EMT ONDUITS. ROUGH EDGES EDGES SHALL BE MOOTHED, DEBURRD, & SEALED WITH PRINTABLE
		S	EALANT AS REQUIRED BY ARCHITECTURAL

	HE JURISDICTION FOR THE FOL STEEL PROTECTION) POSTS AN	LOWING: ID REQUIREMENTS OF POSTS PER						
J	COPY RIGHT RESERVED: THE CONTRACTOR SHALL VERITY AND BE RESPONSIBLE FOR ALL DIMENSIONS. DO NOT SCALE THE DRAWING – ANY ERRORS OR OMISSIONS SHALL BE REPORTED TO IBASA ENTERPRISES INC.	E D RE-ISSUED FOR CONSTRUCTION C RE-ISSUED FOR CONSTRUCTION	AK AK AK AK	21 02 26 21 02 04		AA.K KASEM	CLIENT: BRIDGMAN COLLABORATIVE ARCHITECTURE 678 MAIN STREET WINNIPEG, MB R3B 1E4 (204)488–3857	SHI
	THE COPYRIGHTS TO ALL DESIGNS AND DRAWINGS ARE THE PROPERTY OF IBASA ENTERPRISES INC. REPRODUCTION OR USE FOR ANY PURPOSE OTHER THAN THAT AUTHORIZED BY IBASA ENTERPRISES INC. IS FOREIDDEN.	B ISSUED FOR CONSTRUCTION A ISSUED FOR REVIEW	AK AK AK AK	21 01 30 21 01 21	Ibasa Enterprises Inc.	Rember 5 35704 S Procession	PROJECT TITLE: LOO LOO WINNIPEG 715 MAIN ST., WINNIPEG, MB	PR
		ISSUED	BY APPR.	DATE		January 30, 2021	BID OPPORTUNITY 54–2021	SC

# ٩L

- I F SPECIFICATIONS.
- 3 USE STAINLESS STEEL OR GALVANIZED FASTENERS TO SECURE EMT CONDUIT'S SUPPORTS & ELECTRICAL ITEMS, & PARTS TO CONTAINERS' STEEL SURFACES. USE SELF-TAPPING SCREWS FOR ITEMS ABOVE 7', USE BOLT & STAINLESS STEEL NUTS WITH NYLON INSERTS COMBINATIONS FOR ITEMS BELOW 7'. SELF-TAPPING SCREWS SHALL NOT PROTRUDE MORE THAN  $\frac{1}{2}$ " BEYOND EXTERIOR OF CONTAINER'S WALLS. TORQUE PER CODE.

RE	SHEET TITLE: TITLE	SHEET	SHEET NO:
_	PROJECT NO: 201231 SCALE: NTS	DESIGNED BY: AK DRAWN BY: AK REVIEWED BY: AK	E01

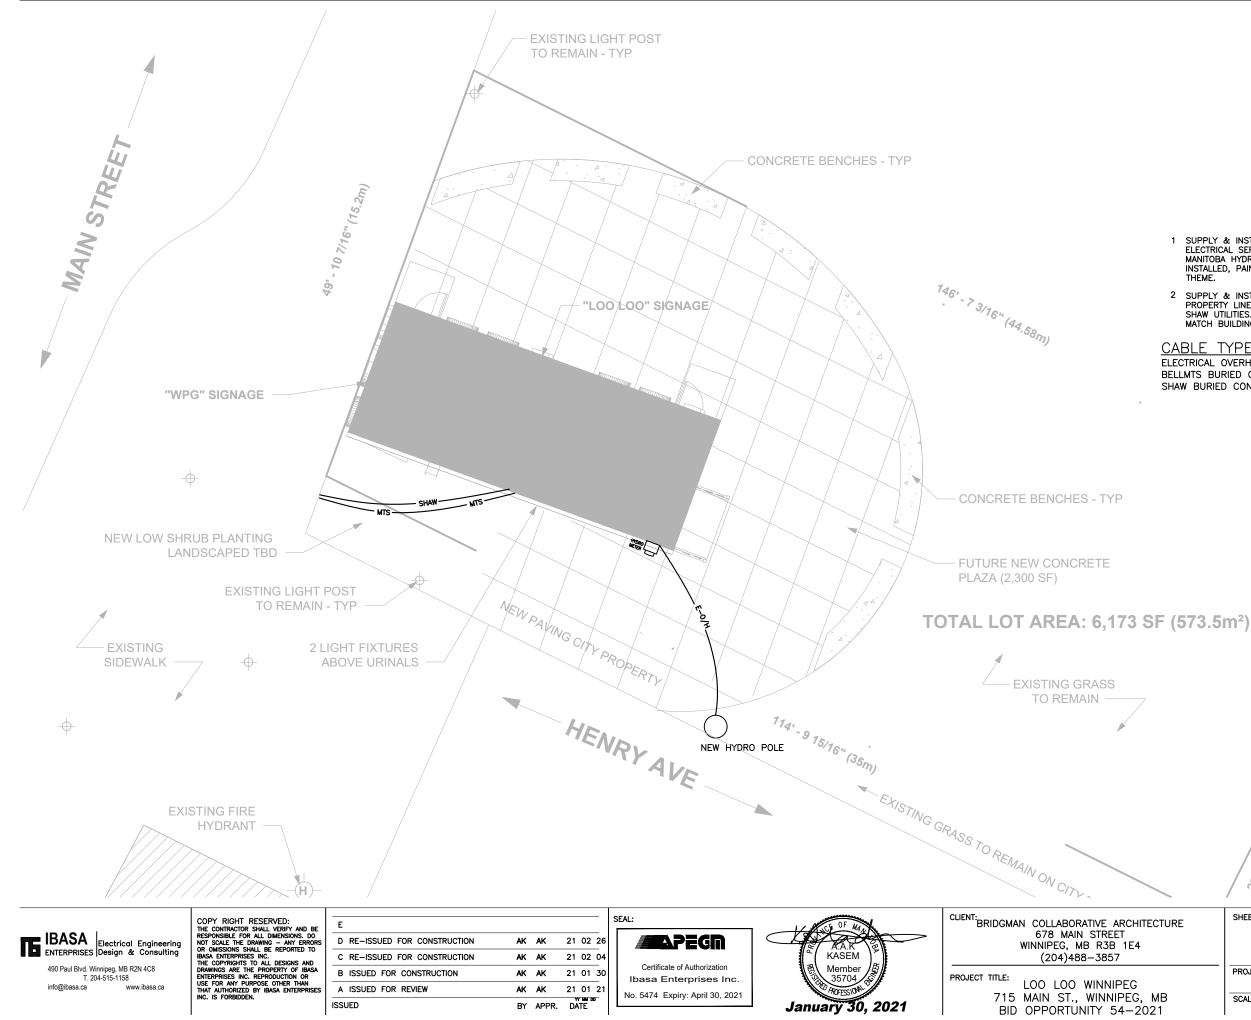






SUPPLY & INSTALL 3 POINT OVERHEAD RACK FOR ELECTRICAL SERVICE. COORDINATE LOCATION WITH MANITOBA HYDRO. USE EMT TUBING SURFACE INSTALLED, PAINT TO MATCH BUILDING COLOR & THEME.

SUPPLY & INSTALL 2" PVC CONDUIT(S) TO PROPERTY LINE AS REQUIRED BY BELLMTS & SHAW UTILITIES. SURFACE INSTALLED, PAINT TO MATCH BUILDING COLOR & THEME.

CABLE TYPES: ELECTRICAL OVERHEAD CABLE \_ BELLMTS BURIED CONDUIT SHAW BURIED CONDUIT

 E-0/H	
 MTS	
 SHAW-	

	22'- 77 976" ( <sup>7</sup> 17)	37' - 3 1/4" (11.314m)	
RE	SHEET TITLE: SITE	E PLAN	SHEET NO:
	PROJECT NO: 201231 SCALE: 3/32"=1'-0"	designed by: AK drawn by: AK reviewed by: AK	E01.1

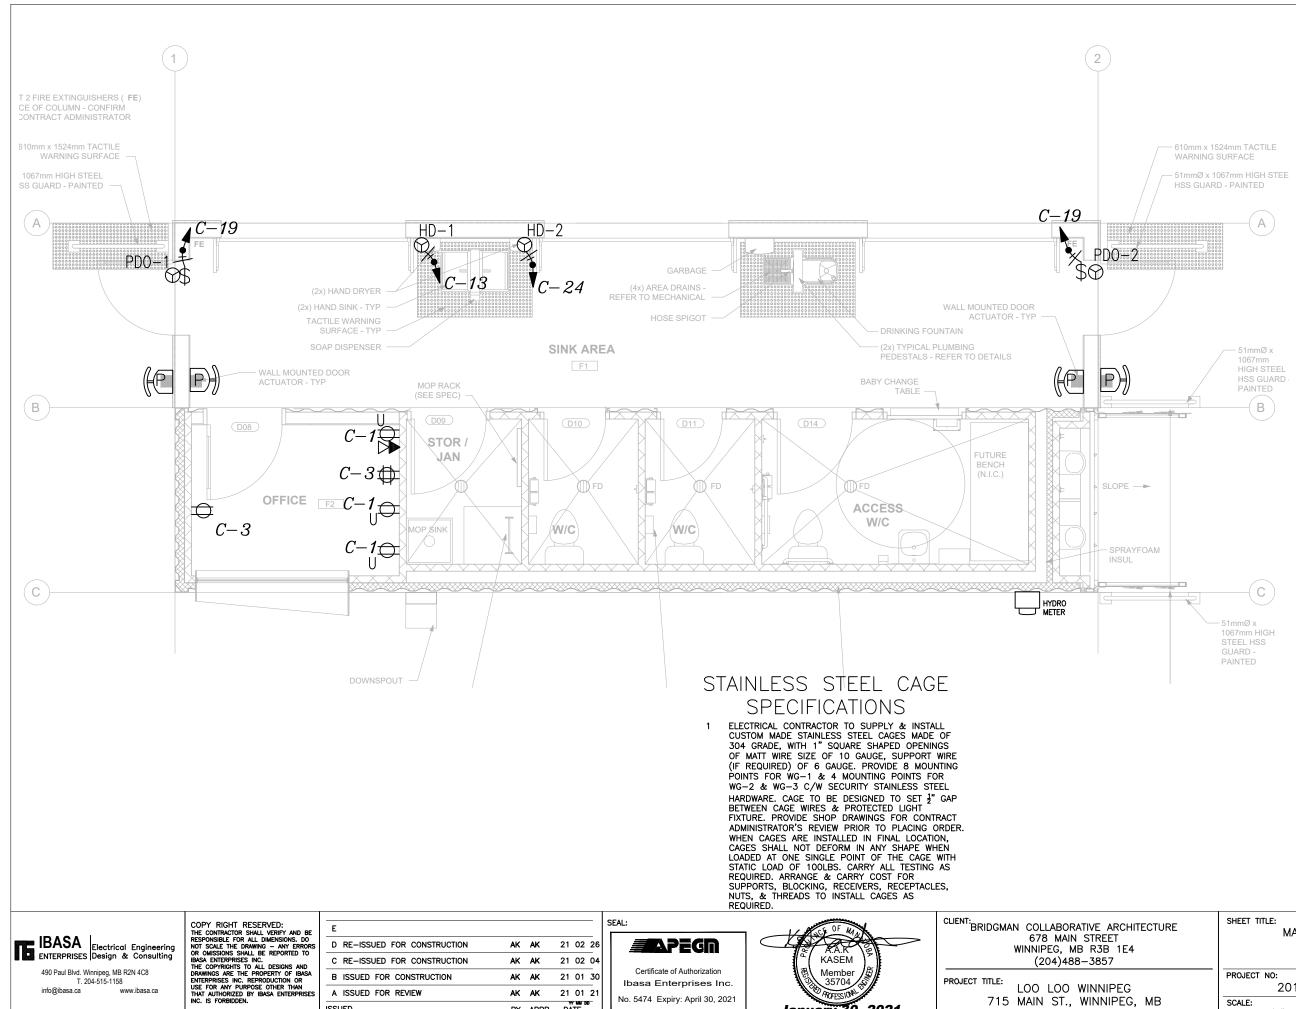

BY APPR. DATE

ISSUED

715 MAIN ST., WINNIPEG, MB BID OPPORTUNITY 54-2021


January 30, 2021




## GENERAL NOTES

- ELECTRICAL CONTRACTOR TO REFER TO 1 ARCHITECTURAL DRAWINGS & MILLWORK LAYOUTS FOR COORDINATION OF LOCATION OF RECEPTACLES & OUTLETS.
- SUPPLY & INSTALL PHONE & DATA OUTLET BOXES 2 C/W CONDUITS & PULL ROPES FROM OUTLETS TO COMMUNICATION BOARD NEXT TO PANEL P-C. LABEL EACH END OF THE PULL ROPE FOR IDENTIFICATION.
- INTERLOCK EMERGENCY LIGHTING WITH LIGHT 3 CIRCUIT IN AREA OF SERVICE.
- ELECTRICAL CONTRACTOR TO COORDINATE WITH COMMUNICATION SUPPLIER FOR INSTALLATION OF COMMUNICATION BOARD AS SPECIFIED. SUPPLY & INSTALL GROUND WIRE AS REQUIRED.
- ELECTRICAL CONTRACTOR TO INSTALL ELECTRICAL CONTROL EQUIPMENT FOR MECHANICAL EQUIPMENT, PROVIDE CONTROL WIRING, & ELECTRICAL SERVICE 5 TO MECHANICAL EQUIPMENT.
- MAINTAIN 1.0 METER IN FRONT OF ELECTRICAL EQUIPMENT. COORDINATE WITH OTHER TRADES ON 6 SITE
- 7 SUPPLY & INSTALL STAINLESS STEEL COVER PLATES IN PUBLIC AREAS OF THE BUILDING C/W STAINLESS STEEL SECURITY HARDWARE.
- 8 SUPPLY & INSTALL STAINLESS STEEL SECURITY HARDWARE FOR ALL CAGES.
- SUPPLY & INSTALL EXPOSED ELECTRICAL TO BE IN EMT. PAINT ALL EMT ELECTRICAL INSTALLATION TO MATCH EXISTING FINISH & COLOR SPECIFIED ON ARCHITECTURAL DRAWINGS.
- 10 SUPPLY & INSTALL GROUND BONDING CONDUCTOR TO SOLIDLY CONNECT EACH CONTAINER IN THE BUILDING TO ELECTRICAL GROUND SYSTEM IN THE BUILDING USE #6 AWG -GREEN INSULATED GROUND CONDUCTORS INSTALLED IN EMT TURING CONNECTED TO A STEEL BOLT WELDED IN EACH CONTAINER LOCATED IN A VISIBLE PLACE. SUPPLY & INSTALL WALL MOUNTED LAMACOID LABELS TO IDENTIFY EACH GROUND POINT WITH 2' OF THE BOLT.

RE	SHEET TITLE: MAIN LEVEL-	-POWER LAYOUT	SHEET NO:
	PROJECT NO: 201231 SCALE: 1/4"=1'-0"	DESIGNED BY: AK DRAWN BY: AK REVIEWED BY: AK	E02.1

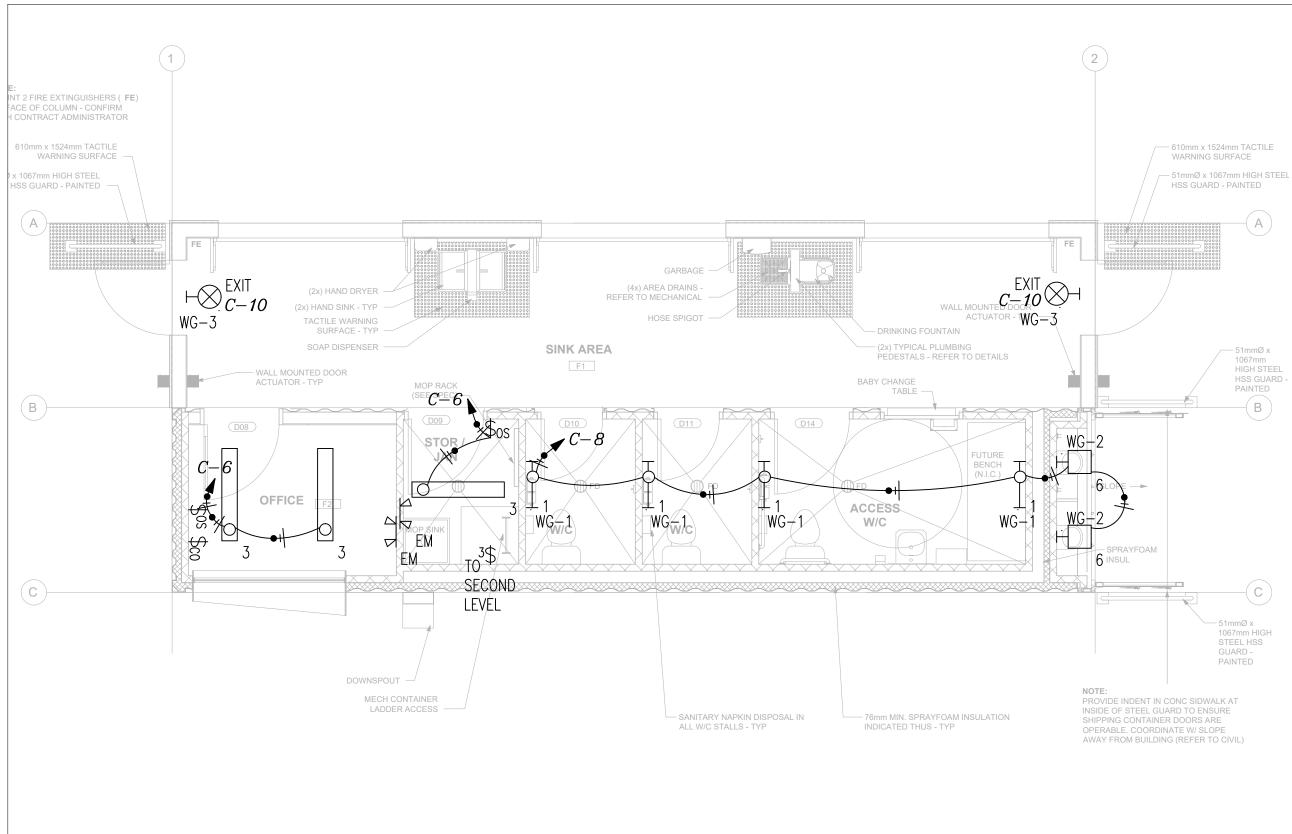

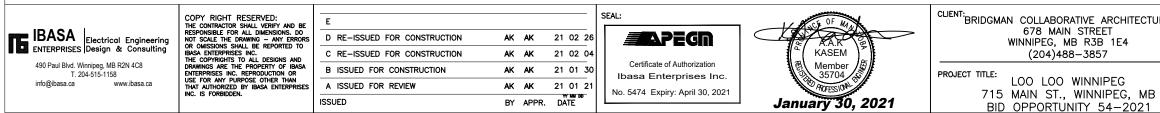




## GENERAL NOTES

- ELECTRICAL CONTRACTOR TO REFER TO ARCHITECTURAL DRAWINGS FOR INSTALL LOCATIONS 1 OF LIGHT FIXTURES.
- 2 INTERLOCK EMERGENCY LIGHTING WITH LIGHT CIRCUIT IN AREA OF SERVICE.
- SUPPLY & INSTALL 3/4" THICKNESS BACKING FOR POT LIGHT TO EXTEND AT LEAST A MINIMUM OF 12" 3 IN ALL DIRECTIONS. BACKING TO BE PLYWOOD, HARDIBOARD OR EQUIVALENT MATERIAL.
- 4 SUPPLY & INSTALL STAINLESS STEEL SECURITY HARDWARE FOR ALL LIGHT FIXTURES & CAGES WITHIN 10' OF FFL OR FGL.
- 5 SUPPLY & INSTALL EXPOSED ELECTRICAL TO BE IN EMT. PAINT ALL EMT ELECTRICAL INSTALLATION TO MATCH EXISTING FINISH & COLOR SPECIFIED ON ARCHITECTURAL DRAWINGS.


SWITCH SCHEDULE				
CALLOUT	SYMBOL	NOTE 1		
CO Switch	\$ <sub>@</sub>	LEVITON, PART#VPOSR-10 FOR WIRING TO PART# VPT24-1PZ. FULLY PROGRAM & SETUP.		
0S	\$ <sub>05</sub>	LEVITON, PARTI/OSSMT-MDW, ADJUST BLINDS TO PREVENT EXTENDED ACTIVATION		
TIME—LOCK Switch	\$ <sub>14</sub>	LEVITON, PART# VPT24-1PZ. FULLY PROGRAM & SETUP. IF LOAD EXCEEDS 80% OF TIME LOCK CAPACITY USE CONTACTOR TO CONTROL CIRCUIT		

IRE	SHEET TITLE: MAIN LEVEL—I	LIGHTING LAYOUT	SHEET NO:
	PROJECT NO: 201231 SCALE: 1/4"=1'-0"	DESIGNED BY: AK DRAWN BY: AK REVIEWED BY: AK	E02.2

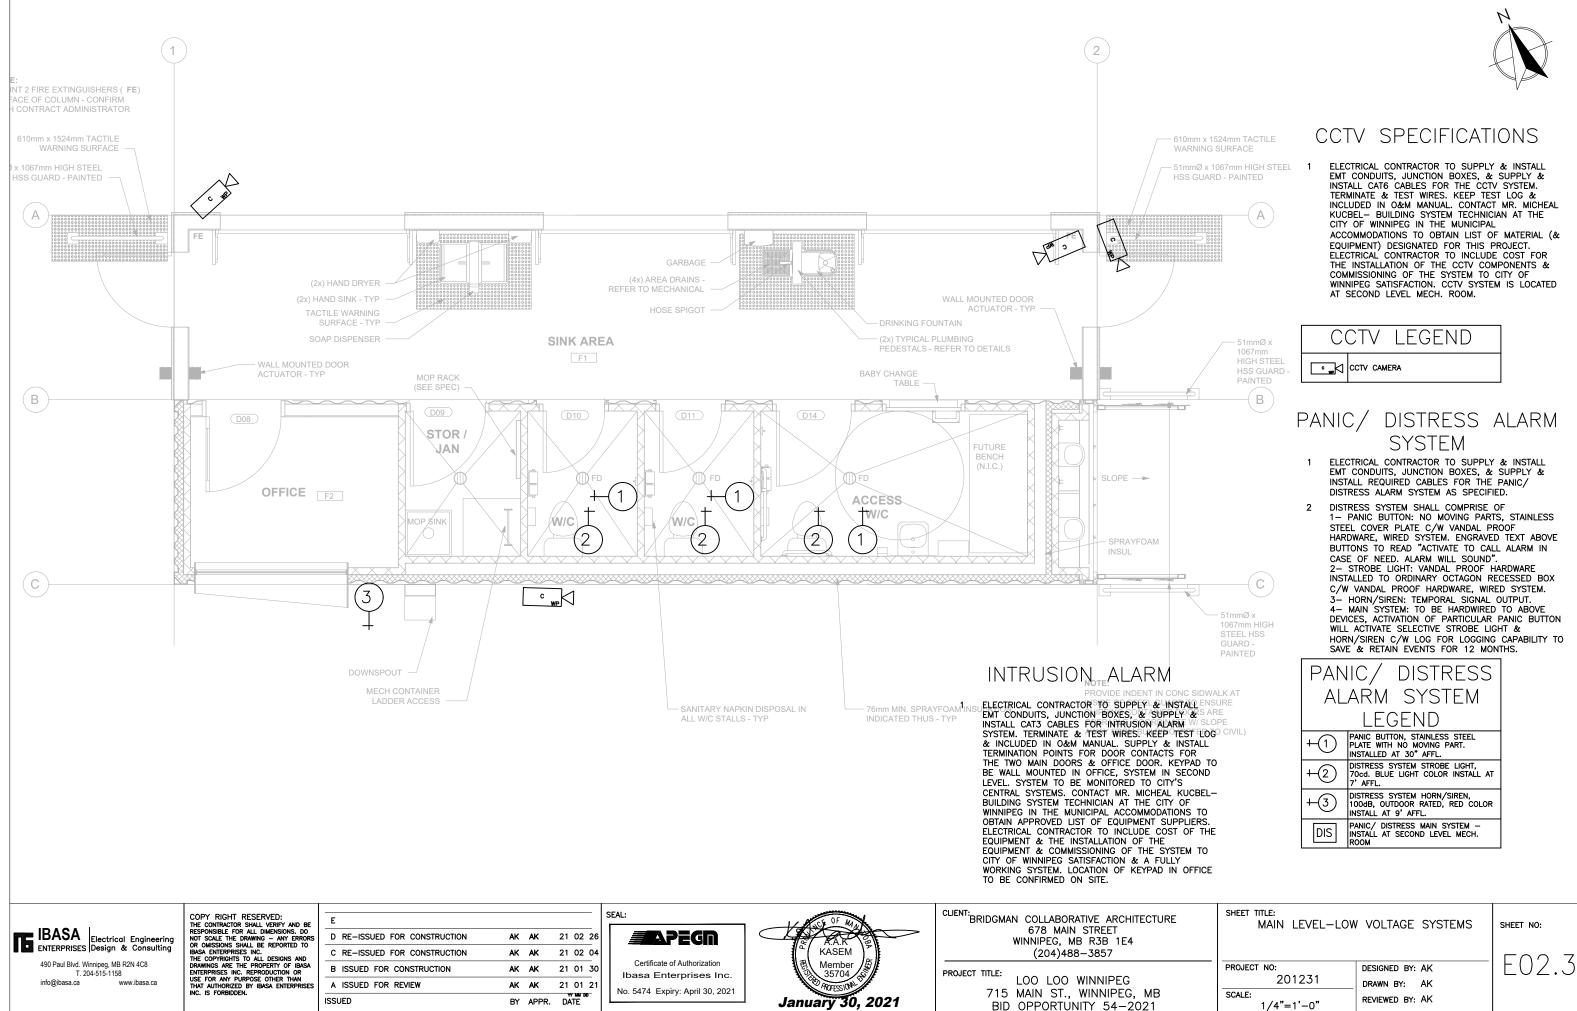



	PROJECT NO:	DESIGNED BY: AK	I EUZ
	201231	DRAWN BY: AK	
}	SCALE: 1/4"=1'-0"	REVIEWED BY: AK	

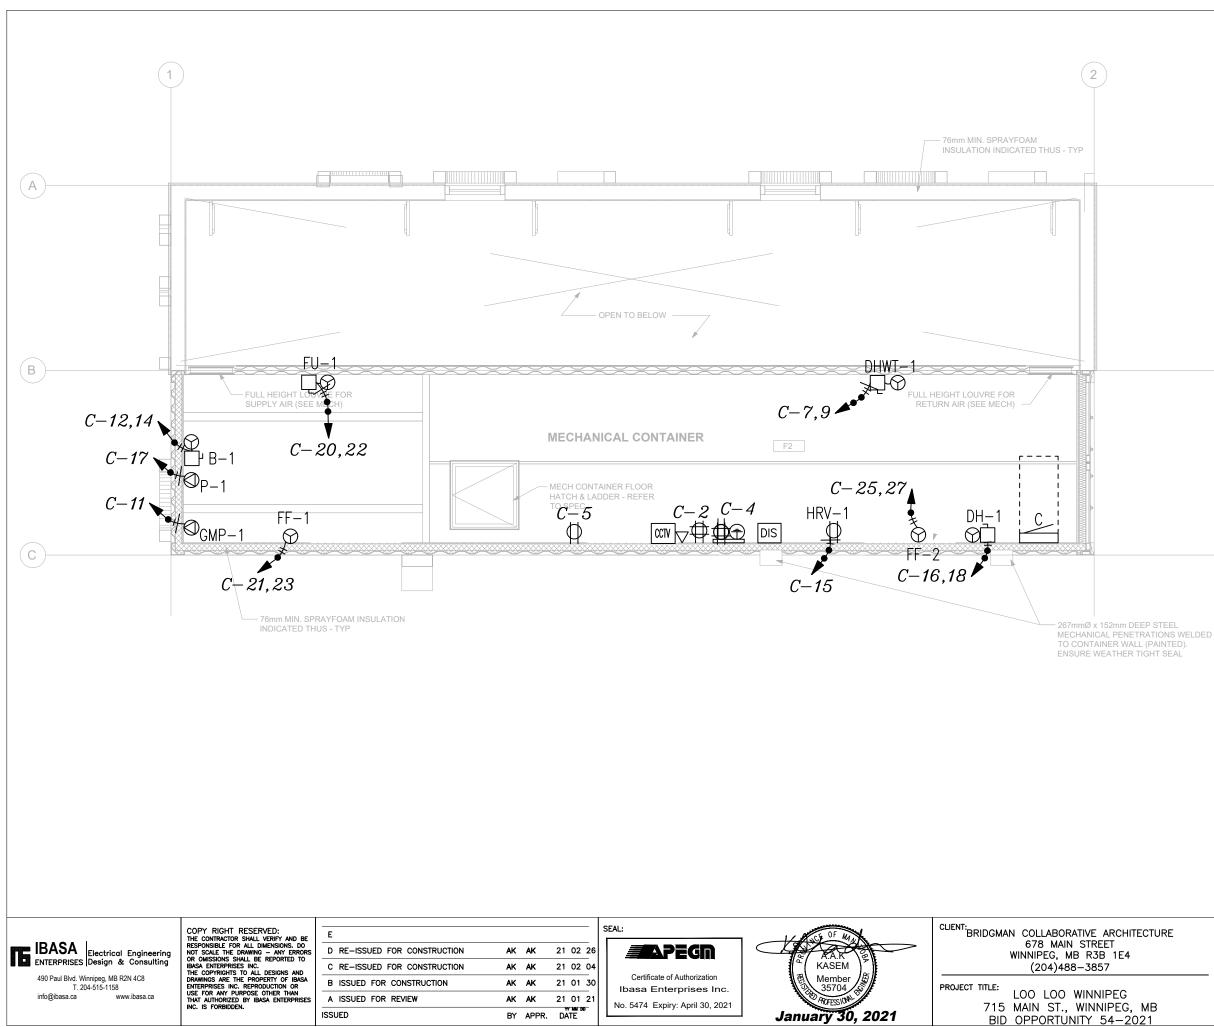



## GENERAL NOTES


- ELECTRICAL CONTRACTOR TO REFER TO ARCHITECTURAL DRAWINGS & MILLWORK LAYOUTS 1 FOR COORDINATION OF LOCATION OF RECEPTACLES & OUTLETS.
- 2 SUPPLY & INSTALL PHONE & DATA OUTLET BOXES C/W CONDUITS & PULL ROPES FROM OUTLETS TO EXISTING COMMUNICATION BOARD IN THE BUILDING. LABEL EACH END OF THE PULL ROPE FOR IDENTIFICATION.
- INTERLOCK EMERGENCY LIGHTING WITH LIGHT CIRCUIT IN AREA OF SERVICE. 3
- ELECTRICAL CONTRACTOR TO INSTALL ELECTRICAL CONTROL EQUIPMENT FOR MECHANICAL EQUIPMENT, PROVIDE CONTROL WIRING, & ELECTRICAL SERVICE 4 TO MECHANICAL EQUIPMENT.
- COORDINATE WITH OTHER TRADES ON SITE FOR 5 INSTALLATION OF LIGHT FIXTURES IN THE SPACE.
- SUPPLY & INSTALL EXPOSED ELECTRICAL TO 6 BE IN EMT.
- 7 SUPPLY & INSTALL ALL EMT TUBING DESTINED FROM MECHANICAL AREA/ROOM AT SECOND LEVEL TO SINK AREA LIGHTS & ALL OTHER WALL MOUNTED SYSTEMS IN THE SINK AREA, INCLUDING BUT NOT LIMITED TO CCTV, POWER FOR DOOR OPERATORS TO BE ROUTED THROUGH THIRD LEVEL CONTAINERS WITH MINIMUM OCCUPANCY OF SINK ROOM CEILING.

RE	SHEET TITLE: SECOND LEVEL	POWER LAYOUT	SHEET NO:
	PROJECT NO: 201231 SCALE: 1/4"=1'-0"	DESIGNED BY: AK DRAWN BY: AK REVIEWED BY: AK	E03.1

( A )

-(в)

-( C )

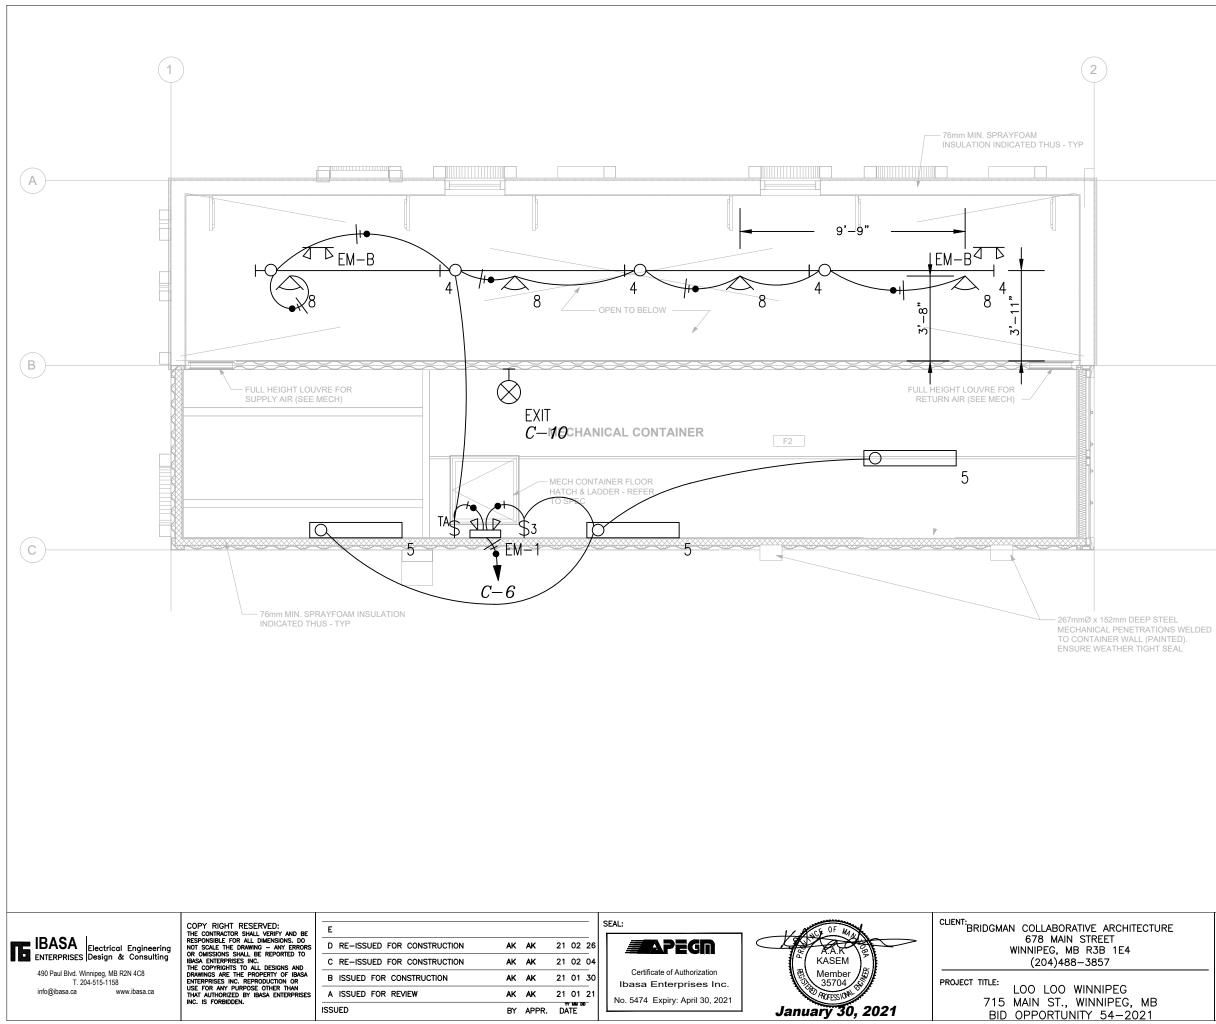



00	Switch	\$	LEVITON, PART/VPOSR-10	FOR WIRING TO PART# VPT24-1PZ. FULLY	]
<i>c.</i>	ALLOUT	SYMBOL		NOTE 1	1
5	SWIT	CH SC	HEDULE		
					-
	BE	IN EM	Г.		
4	SU	PPLY &	INSTALL E	XPOSED ELECTRICAL	то
	EME			ATTERY BANK IN THE	NG
3				OTE EMERGENCY LIGHT	
2			EMERGENCY AREA OF SE	LIGHTING WITH LIGHT RVICE.	
			IRAL DRAWING	S FOR INSTALL LOCATI	UNS
1				TO REFER TO	
		GEN	IERAL	NOTES	
— (B)					

-(A)

## PROGRAM & SETUP. LEVITON, PART**i**ossmit-mow, adjust blinds to prevent extended activation \$<sub>05</sub> TIME-LOCK Switch LEVITON, PART# VPT24-1PZ. FULLY PROGRAM & SETUP. IF LOAD EXCEEDS 80% OF TIME LOCK CAPACITY USE CONTACTOR TO CONTROL \$\_

RE	SHEET TITLE: SECOND LEVEL	-LIGHTING LAYOUT	SHEET NO:
	PROJECT NO: 201231 SCALE: 1/4"=1'-0"	DESIGNED BY: AK DRAWN BY: AK REVIEWED BY: AK	E03.2

ALLOUT	SYMBOL	LAMP	DESCRIPTION	MOUNTING	MODEL	INPUT WATTS	VOLTS	NOTE 1	QUANTITY		TING SU		BUS A	240/12 MPS 200	0	3W	N	IC 22,000 IAIN BKR 200 .UGS STANDARD
	ющ	(1) LED-3500K	VISCOR – LCOMN Square – Intellect-LED Linear Type N – Architectural Lighting	CEILING	LCOM-N-24- LED8-35K-020L-UNV- P95-V99(LV02) C/W INTEGRAL OCCUPANCY SENSOR	18	120V 1P 2W	C/W Remote Controller, ELC00368, ONE UNIT FOR SITESET OCCUPANY TIMEOUT TO 10MIN.	4			-P1aB4A2-42ED-C/W		REAKER		скт	скт	DESCRIPTION
		(1) LED-3000K	AERALUX LIGTING-LED LINEAR	SURFACE	AE-SF-ER-ECO-UV-4- 32-N-30	32	120V 1P 2W		3	3		USB OUTLET CHARGER RECEPTACLE		0.54	0.36		15/1 RECEPTACLE 15/1 RECEPTACLE	
	юі	(4) LED-3500K	VISIONEERING 8' LED INDOOR STRIP LUMINAIREWITH WHITE INTERIOR AND NO LENS	CEILING	LCOM96-LED835K140LUNV	103.62	120V 1P 2W	C/W STEM KIT PART#KIT00050	4	5 7 9		RECEPTACLE DHWT-1		0.18	2.25	6 8 10	15/1 LIGHTING 15/1 LIGHTING 15/1 LIGHTING	
		(1) LED-3000K	AERALUX LIGTING-LED LINEAR	WALL	AE-SF-ER-ECO-UV-4- 32-N-30	32	120V 1P 2W	INSTALL AT 7' AFFL.	3	11 13 15	15/1	GMP-1 HD-1 HRV-1		1.6	0.1	12 14 16	60/2   B-1   20/2   DH-1	
	Ю	(1) LED-4000K	ORACLE LIGHTING LED Die-Cast Aluminum Slim Full Cut-Off Wall	WALL	0WP-FC-116-LED- 3500L- MVOLT-30K-**-WPPHC	27	120V 1P 2W	C/W INTEGRAL PHOTOCELL-INSTALL AT 7.5' AFGL- CONFIRM FINISH PRIOR TO ORDER	2	17 19 21	15/1 15/1	P-1 PD0-1, PD0-2		0.1	0.6	18 20 22	 80/2   FU-1 	
	4	(1) LED-4000K	ORACLE LIGHTING - LED Mini Slimline Floodlight Series	SURFACE	ELITE, OFL-SL-202-LED- 3000L-MVOLT-40K-BZ	30	120V 1P 2W	INSTALL ON 2.0' EMT STEM BELOW CEILING SURFACE	4	23 25 27	15/2	FF-2		1	1	24 26 28	15/1   HD-2 15/1   SPACE 15/1   SPACE	
	3 2	(2) LED	EMERGI LITE-REMOTE HEAD	WALL/CEILING	EMERGI LITE EF9DMLG	8	12V 1P 2W		2	31	15/1	SPACE SPACE SPACE		0	0	30 32 34	15/1 SPACE 15/1 SPACE 15/1 SPACE	
-1		(2) LED	EMERGENCY LIGHTING C/W BATTERY & TWO HEADS	WALL	EMERGI-LITE 12ESL-144-/2LG	100	120V 1P 2W		1	35	15/1 15/1	SPACE SPACE		0	0	36	15/1 SPACE 15/1 SPACE	
-8	<u>4</u>	(2) LED	EMERGI LITE-REMOTE HEAD	WALL/CEILING	EMERGI LITE EF9DMLG	8	12V 1P 2W	BLACK COLOR	2			SPACE SPACE		0	0	40 42	15/1 SPACE 15/1 SPACE	
п	⊦⊗	(1) LED	EMERGENCY EXIT LIGHT	WALL/CEILING	EMERGI-LITE EA1WI	2.5	120V 1P 2W	GREEN PICTOGRAMC/W CAGE	3			CONN K	VA CALC KVA				TOTA	L CONNECTED K
i–1		(1) -	WIRE GUARD-CUSTOM PART	CEILING	STAINLESS STEEL MESH, 1" X 1" OPENINGS & 8 SECURITY SCREWS - TO SUIT		120V 1P 2W	C/W HARDWARE INSTALLED IN WALLS AS SPECIFIED TO COVER FIXTURE TYPE 1	4		LAR	ITING 0.96 GEST MOTOR 0.3 IER MOTORS 0.8	1.2 0.075 0.8	(125%) (25%) (100%)			CONTINUOUS HEATING COOLING	4.5 28.3 0.3
<b>⊖</b> -2	•	(1) -	WIRE GUARD-CUSTOM PART	CEILING	STAINLESS STEEL MESH, 1" X 1" OPENINGS & 4 SECURITY SCREWS		120V 1P 2W	C/W HARDWARE INSTALLED IN WALLS AS SPECIFIED TO COVER FIXTURE TYPE 6	2		REC	EPTACLES 1.44 CHEN EQUIP 0	1.44 0	(50%>1 (N/A)			NONCONTINUO DIVERSE METERED DEM	US 0 7.2
<b>}−</b> 3		(1) -	WIRE GUARD-CUSTOM PART	CEILING	STAINLESS STEEL MESH, 1" X 1" OPENINGS & 4 SECURITY SCREWS		120V 1P 2W	C/W HARDWARE INSTALLED IN WALLS AS SPECIFIED TO COVER FIXTURE EXIT SIGN	2				3 PA				TOTAL KVA BALANCED AM	43.2 PS

FROM UTILITY POLE

OUTDOOR INDOOR -ELEC. ROOM SECOND LEVEL 3

4

1

2

200/2J.B

PANEL C 200A MCB

240/120V 2P 3W

## EQUIPMENT & MOTORS EQUIPMENT SCHEDULE

CALLOUT	DESCRIPTION	SYMBOL	VOLTS	AMPS	KW	CIRCUIT	NOTE 1
DHWT-1	DOMESTIC HOT WATER TANK-ELECTRIC	8°D	240/120V 2P 3W	18.75	4.5	C-7,9	Supplied by others
GMP-1	IN-FLOOR HEATING MAKE-UP PACKAGE	Ø	120V 1P 2W	0.83	0.1	C-11	supplied by others
HD-1	HAND DRYER	Ø	120V 1P 2W	13.33	1.6	C-13	Supplied by others
HD-2	HAND DRYER	Ø	120V 1P 2W	13.33	1.6	C-24	SUPPLIED BY OTHERS
HRV-1	HEAT RECOVERY VENTILATOR	ф	120V 1P 2W	2.5	0.3	C-15	Supplied by others
P-1	IN-FLOOR HEATING RE-CIRCULATING PUMP	Ø	120V 1P 2W	0.83	0.1	C-17	supplied by others
PD0-1	POWER DOOR OPERATOR	\$ \$	120V 1P 2W	2.5	0.3	C-19	SUPPLIED BY OTHERS
PDO-2	POWER DOOR OPERATOR	<i>©</i> \$	120V 1P 2W	2.5	0.3	C-19	Supplied by others

## ELECTRIC HEATERS EQUIPMENT SCHEDULE

CALLOUT	DESCRIPTION	SYMBOL	VOLTS	AMPS	KW	CIRCUIT	ORDERING INFORMATION
B-1	IN-FLOOR HEATING BOILER-ELECTRIC	8°D	240V 2P 2W	41.67	10	C-12,14	SUPPLIED BY OTHERS
DH-1	DUCT HEATER	ണ	240/120V 2P 3W	12.5	3	C-16,18	SUPPLIED BY OTHERS
FF—1	FORCE FLOW HEATER-BACKUP ONLY	Φ	240V 2P 2W	8.33	2	C-21,23	OUELLET, PART#OACO2000 WITH TAMPERPROOF THERMOSTAT SET TO 5 DEG. C. NO ACCESS SHALL BE AVAILABLE TO USER TO ADJUST TEMPERATURE
FF-2	FORCE FLOW HEATER-BACKUP ONLY	Φ	240V 2P 2W	8.33	2	C-25,27	OUELLET, PART#OAC02000 WITH TAMPERPROOF THERMOSTAT SET TO 5 DEG. C. NO ACCESS SHALL BE AVAILABLE TO USER TO ADJUST TEMPERATURE
FU–1	ELECTRIC FURNACE	ഔദ	240/120V 2P 3W	62.5	15	C-20,22	Supplied by others

FU-1	ELECTRIC FURNACE	<b>8</b> -D	240/120V 2P 3W	62.5	15	C-20,22	SUPPLIED BY OTHERS		UTILITY REQUIREMENTS.	COMMUNICATION OUTLETS
			1 '	_	-				4 ELECTRICAL SERVICE EQUIPMENT INSTALLED	EMERGENCY LIGHTING MANUAL LIGHT CONTROLS
									OUTDOOR SHALL BE RATED NEMA/CSA 3R.	OCCUPANCY SENSORS 47.3
		<u>1ENT</u>	SCHEDU	ILES					E LINE DIAGRAM — RICAL SERVICE	• EXCEPT CEILING MOUNTED ON ES     • EXCEPT OTHERWISE NOTE OON FLANS     •• THEIGHTS ARE MEASURED FROM FINISH FLOOR LEVEL TO B     •••• THEIGHTS ARE MEASURED FROM FINISH FLOOR LEVEL TO B     ••••••••••••••••••••••••••••••••
	BASA Electrical Engir	neerina	COPY RIGHT RI THE CONTRACTOR S RESPONSIBLE FOR A NOT SCALE THE DR	SHALL VERIFY AN ALL DIMENSIONS AWING - ANY E	ERRORS D	RE-ISSUED	FOR CONSTRUCTION A	<b>KAK</b> 21 02 :		CLIENT: BRIDGMAN COLLABORATIVE ARCHITECTU 678 MAIN STREET WINNIPEG, MB R3B 1E4
E FN	ITERPRISES Design & Cons	sultina	OR OMISSIONS SHAL	LL BE REPORTE	D TO					WINNIFES, MD KJD IE4

ENTERPRISES Design & Consulting 490 Paul Blvd. Winnipeg, MB R2N 4C8 T. 204-515-1158 www.ibasa.ca info@ibasa.ca

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	ISSUED	BY	APPR.	DATE

<b>APEGN</b>
Certificate of Authorization Ibasa Enterprises Inc.

No. 5474 Expiry: April 30, 2021

	A.A.K KASEM	
HU SHE	Member 35704	
Janua	ary 30,	2021

<sup>ENT:</sup> BRIDGMAN COLLABORATIVE ARCHITECT 678 MAIN STREET
WINNIPEG, MB R3B 1E4 (204)488–3857

PROJECT TITLE: LOO LOO WINNIPEG 715 MAIN ST., WINNIPEG, MB BID OPPORTUNITY 54-2021

XFMR HYDRO 50 KVA 240/120V T0 240/120V OVERHEAD MAST - SERVICE MOUNTED TRANSFORMER

## NOTES

1 CIRCUIT BREAKER PROTECTION: 1. FULLY RATED OR USING SERIES RATED COMBINATIONS

COMBINATIONS 2. INTEGRATED EQUIPMENT RATED (IER) WHEN USING SERIES-RATED SYSTEMS, THEY SHALL BE TESTED/LABELED AS A SERIES-RATED COMBINATION 3. LABEL/NAMEPLATE TO BE INSTALLED IN A CONSPICUS AND LEGIBLE MANNER TO INDICATE THAT THEY SHOULD ONLY BE REPLACED WITH COMPONENTS OF THE SAME TYPE AND RATING REFER TO CEC 14-014 DOWNSTEAM OVERUPERAL DRUGGES AND F

REFER TO CEC 14-014 2 DOWNSTREAM OVERCURRENT DEVICES MUST BE SERIES RATED COMBINATIONS WITH THE UPSTREAM PROTECTIVE DEVICE. FOR SERIES RATED COMBINATIONS, EACH DEVICE MUST BE LABELED TO INDICATE: 1. THAT REPLACEMENT COMPONENTS MUST BE OF THE SAME TYPE AND RATING ONLY 2. TESTED IER KA RATING 3. SPECIFIC UPSTREAM PROTECTIVE DEVICE 4. PERMISSIBLE BRANCH DEVICES 5. PANELBOARD DESIGNATION

- 5. PANELBOARD DESIGNATION
- 6. VOLTAGE
- 3 ELECTRICAL SERVICE EQUIPMENT SHALL MEET

200/2J.B 200 SIZING METHOD: N FOR NEUTRAL, G FOR GROUND. C FOR CONDUIT. NUMBER BETWEEN ( ) INDICATES NUMBER OF LINE & NEUTRAL PARALLEL RUNS PANEL SCHEDULE

ID


CALLOUT	VOLTS	BUS AMPS	MAIN DISCONNECT TYPE	MAIN DISCONNECT AMPS	MOUNTING	POLES	NOTE 1	AIC RATING
C	240/120V 2P 3W	200	BREAKER	200	SURFACE	42	EATON-P1AB4A2-42ED-C/W 200AMP MAIN BREAKER	22,000

HEIGHTS ARE IN INCHE

FEEDER SCHEDULE

FEEDER AMPS

TYPE	AREA/ROOM					
	PUBLIC AREAS	OFFICE	MECH. ROOM	WASHROOMS	COUNTERS	
RECEPTACLE *	18	18	40	-		
HVAC CONTROLS	47.3 (1200mm)				COORDINATE	
COMMUNICATION OUTLETS	40				WITH	
EMERGENCY LIGHTING	96"				MILLWORK	
MANUAL LIGHT CONTROLS	43			LAYOUTS		
OCCUPANCY SENSORS	47.3 (1200mm)			1		

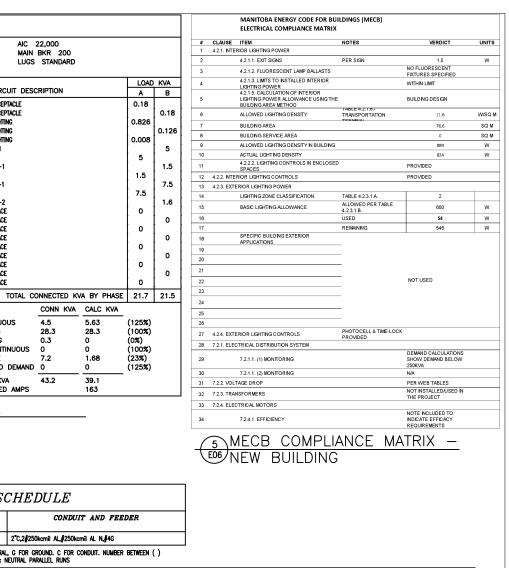

ELECTRICAL CONTROLS, OUTLETS, & SWITCHES INSTALLATION

TO BOTTOM OF OUTLET BOX

<u> DN HEIGHTS-</u> CONTROLS

IRE	SHEET TITLE: EQUIPMENT & F	PANEL SCHEDULES	SHEET NO:
	PROJECT NO: 201231 SCALE: NTS	DESIGNED BY: AL DRAWN BY: AL REVIEWED BY: AL	E06

### 1. GENERAL

- 1.1. REQUIREMENTS, INSTRUCTIONS TO BIDDERS, THIS SPECIFICATIONS AND ANY ADDENDA HERETO FORM PART OF THE CONTRACT DOCUMENTS AND SHALL BE READ IN CONJUNCTION WITH THEM. WORK TO INCLUDE THE FURNISHING OF ALL LABOR AND MATERIALS UNLESS OTHERWISE SPECIFIED OTHERWISE TO COMPLETE AND PUT INTO OPERATING CONDITIONS ALL ELECTRICAL SYSTEMS AS INDICATED ON THE DRAWINGS AND SPECIFIED HEREIN
- 1.2. RESPONSIBILITY AS TO WHICH TRADES PROVIDES REQUIRED ARTICLES OR MATERIAL RESTS SOLELY WITH THE GENERAL CONTRACT TRADE. EXTRAS WILL NOT BE CONSIDERED BASED ON GROUNDS OF DIFFERENCE OF INTERPRETATION OF SPECIFICATIONS AS TO WHICH TRADE INVOLVED SHALL PROVIDE CERTAIN SPECIALITIES OR MATERIALS.
- 1.3. EXAMINE SITE, LOCAL CONDITIONS, DRAWINGS FOR FACTORS AFFECTING WORK TO WHICH DRAWINGS APPLY TO ENSURE THAT WORK CAN SATISFACTORY BR CARRIED OUT WITHOUT CHANGES TO DRAWINGS. NO ALLOWANCES WILL BE MAKE LATER FOR ANY EXPENSE INCURRED THROUGH FAILURE TO MAKE THIS EXAMINATION. START OF WORK WILL DEEMED EVIDENCE OF, ACCEPTANCE OF, AND SATISFACTION WITH SITE, LOCAL CONDITIONS, AND DRAWINGS.
- 1.4. MUST: THIS WORD, OR THE TERMS "REQUIRED" OR "SHALL", MEAN THAT THE DEFINITION IS AN ABSOLUTE REQUIREMENT OF THE SPECIFICATION. PROVIDE TO MEAN "SUPPLY & INSTALL."

### 2. DRAWINGS AND SPECIFICATIONS

- 2.1. DRAWINGS AND SPECIFICATIONS ARE COMPLEMENTARY TO EACH OTHER AND WHAT IS CALLED FOR BY ONE TO BE BINDING AS IF CALLED FOR BY OTHER.
- 2.2. SHOULD ANY DISCREPANCY APPEAR BETWEEN DRAWINGS AND SPECIFICATIONS WHICH LEAVES ELECTRICAL CONTRACTOR IN DOUBT AS TO TRUE INTENT AND MEANING, OBTAIN RULING BEFORE SUBMITTING TENDER. IF THIS IS NOT DONE, IT WILL BE ASSUMED THAT THE MOST EXPENSIVE ALTERNATE HAS BEEN FIGURED.

### 3. EXAMINATION OF OTHER DRAWINGS

3.1. THIS CONTRACTOR TO EXAMINE CAREFULLY STRUCTURAL, ARCHITECTURAL AND MECHANICAL DRAWINGS AND WORK OF OTHER TRADES AND SATISFY HIMSELF THAT THE WORK UNDER THIS CONTRACT CAN BE SATISFACTORY CARRIED OUT WITHOUT CHANGES TO THE BUILDING AS SHOWN ON THE PLANS. SHOULD ANY DIFFICULTY ARISE SHOWING CONFLICT WITH, OR REQUIRING ADDITIONAL WORK BEYOND THE WORK OF THESE DRAWINGS, BRING THIS MATTER TO THE ATTENTION OF THE CONTRACT ADMINISTRATOR BEFORE SUBMITTING TENDER.

### 4. UNIFORMITY OF EQUIPMENT

4.1. UNLESS OTHERWISE SPECIFIED, UNIFORMITY OF MANUFACTURER TO BE MAINTAINED FOR ANY PARTICULAR ITEM THROUGHOUT.

### 5. STANDARDS OF MATERIAL AND WORKMANSHIP

- 5.1. ALL MATERIALS TO BE NEW AND OF THE QUALITY SPECIFIED AND CONFORM TO THE STANDARDS OF THE CSA. WHERE EQUIPMENT OR MATERIALS ARE SPECIFIED BY TECHNICAL DESCRIPTION ONLY, THEY SHALL BE OF THE BEST COMMERCIAL QUALITY OBTAINABLE FOR THE PURPOSE.
- 5.2. ALL WORK TO BE EXECUTED IN A NEAT AND WORKMANLIKE MANNER BY QUALIFIED TRADESMEN. ELECTRICAL CONTRACTOR TO KEEP A COMPETENT FOREMAN AND NECESSARY ASSISTANTS ON THE JOB DURING THE PROGRESS OF THE WORK.
- 5.3. ALL MATERIAL AND INSTALLATION SHALL MATCH BUILDING STANDARD UNLESS IT IS NOTED ON THE DRAWINGS.

### 6. RECORD PLANS & DIGITAL PHOTOGRAPHS

- 6.1. THE CONTRACT ADMINISTRATOR WILL FURNISH TO THE ELECTRICAL CONTRACTOR A PORTABLE DOCUMENT FORMAT "PDF" DRAWING SET TO BE USED FOR RECORD PURPOSES. ALL REVISIONS MADE ON SITE DURING CONSTRUCTION TO BE ACCURATELY RECORDED.
- 6.2. ELECTRICAL CONTRACTOR TO PRODUCE AT HIS OWN EXPENSE A SET OF AUTOCAD DRAWINGS INCLUDING ALL CHANGES TO THE ORIGINAL TENDER DRAWINGS COVERED BY ADDENDA, CHANGE ORDER, FIELD CHANGES, JOB CONDITIONS ETC., AND TURN THESE OVER TO THE CONTRACT ADMINISTRATOR IN ELECTRONIC AND HARD COPY FORM. COMPLETED RECORD DRAWINGS TO BE CLEARLY MARKED "RECORD DRAWINGS".
- SHOW ALL MAJOR, JUNCTION BOXES, CORE HOLES, CONDUIT HOME RUNS AND CIRCUIT NUMBERS 6.3. ON AS-BUILT DRAWINGS.
- PROVIDE THREE COPIES OF MAINTENANCE MANUALS TO INCLUDE ALL NEW ELECTRICAL EQUIPMENT 6.4. SUCH AS: LIGHT FIXTURES, EXIT LIGHTS, BATTERY UNITS, LIGHTING CONTROLS, PANELS, TRANSFORMERS
- 6.5. INCLUDE COPIES OF COMPUTER PRINTED PANEL DIRECTORIES FOR ALL PANELS.
- PROVIDE AS-BUILT DRAWINGS AND MANUALS TO BUILDING MANAGEMENT AT TIME OF COMPLETION. 66 DRAWINGS AND MANUALS SHALL BE REVIEWED FOR ACCURACY BY CONTRACT ADMINISTRATOR AT COMPLETION.
- 6.7. ELECTRICAL CONTRACTOR TO MAINTAIN DIGITAL PHOTOGRAPH RECORDS OF ALL ELECTRICAL INSTALLATION PRIOR TO CONCEALMENT. DIGITAL PHOTOGRAPHS TO HAVE LEGIBLE BUILDING REFERENCE POINTS FOR IDENTIFICATION. PROVIDE THE DIGITAL PHOTOGRAPHS AS PART OF THE AS-BUILT DRAWINGS IN ORIGINAL DIGITAL FORMAT.
- 7. SHOP DRAWINGS
- 7.1. ELECTRICAL CONTRACTOR TO SUBMIT TO THE CONTRACT ADMINISTRATOR FOR REVIEW, SHOP DRAWINGS OF ELECTRICAL COMPONENTS INDICATED ON DRAWINGS IDENTIFIED AND TO INCLUDE ALL SPECIFIC SITE REQUIREMENTS & INSTALLATION REQUIREMENTS REQUIRED BY THE MANUFACTURER FOR THIS PROJECT.
- 7.2. ALL DRAWINGS TO BE SUBMITTED IN ELECTRONIC FORMAT. ALLOW AT LEAST FOR TEN WORK DAYS

FOR SHOP DRAWINGS REVIEW.

- CONTRACT ADMINISTRATOR'S REVIEW OF SHOP DRAWINGS TO BE FOR GENERAL DESIGN ONLY AND WILL NOT RELIVE ELECTRICAL CONTRACTOR OR SUPPLIERS FROM RESPONSIBILITY FOR ERRORS. PROPER FITTING, CONSTRUCTION OF WORK AND FURNISHING OF MATERIALS. REVIEW WILL NOT BE CONSTRUED AS APPROVING DEPARTURES FROM CONTRACT DOCUMENT REQUIREMENTS IF SUCH DEPARTURES ARE NOT SPECIFICALLY NOTED. ELECTRICAL CONTRACTOR TO BE RESPONSIBLE FOR VERIFYING ALL DIMENSIONS.
- ALL EXTRA COSTS ASSOCIATED WITH AN ALTERNATE PRODUCT THAT IS SPECIFIED IS THE 7.4. RESPONSIBILITY OF THE ELECTRICAL CONTRACTOR. EXTRAS RESULTING FROM THE LACK OF AN ALTERNATIVE PRODUCT TO MATCH SPECIFIED PRODUCT WILL NOT BE CONSIDERED.

### 8 GUARANTEE WARRANTY

- 8.1. FURNISH A WRITTEN GUARANTEE WARRANTY COUNTERSIGNED AND GUARANTEED BY GENERAL CONTRACT TRADE STATING:
- THAT ALL WORK EXECUTED UNDER THIS CONTRACT WILL BE FREE FROM DEFECTS OF MATERIALS AND WORKMANSHIP FOR A PERIOD OF ONE YEAR FROM THE DATE OF FINAL ACCEPTANCE.
- 8.1.2. THE ABOVE PARTIES FURTHER AGREE TO, AT THEIR OWN EXPENSE, REPAIR AND REPLACE ALL SUCH DEFECTIVE WORK AND OTHER WORK DAMAGED THEREBY WHICH FAILS OR BECOMES DEFECTIVE DURING THE TERM OF GUARANTEE WARRANTY PROVIDED THAT SUCH FAILURE IS NOT DUE TO IMPROPER USAGE.
- PERIOD OF THE GUARANTEE SPECIFIED TO BE IN NO WAY SUPPLANT ANY OTHER GUARANTEE 813 OF A LONGER PERIOD BUT BE BINDING ON WORK NOT OTHERWISE COVERED.

### 9. SETTING OUT OF THE WORK

- 9.1. ELECTRICAL CONTRACTOR TO BE RESPONSIBLE FOR CORRECTING ALL WORK COMPLETED CONTRARY TO INTENT OF DRAWINGS AND SPECIFICATIONS AND BEAR ALL COST FOR THE SAME. WHERE INTENT OF DRAWINGS AND SPECIFICATIONS IS NOT CLEAR, OBTAIN CLARIFICATION BEFORE PROCEEDING WITH WORK
- ELECTRICAL CONTRACTOR TO GIVE WORK HIS PERSONAL SUPERVISION LAY OUT HIS OWN WORK, DO 92 ALL NECESSARY LEVELING AND MEASURING OR EMPLOY A COMPETENT CONTRACT ADMINISTRATOR TO DO SO, FIGURES, FULL SIZE AND DETAIL DRAWINGS TO TAKE PRECEDENT OVER SCALE MEASUREMENTS
- 9.3 WHERE ANY EQUIPMENT SUPPLIED BY ELECTRICAL CONTRACTOR MUST BE BUILT IN WITH WORK OF OTHER CONTRACTOR, THIS CONTRACTOR TO BE RESPONSIBLE FOR SUPPLYING THE EQUIPMENT TO BE BUILT IN OR MEASUREMENTS TO ALLOW NECESSARY OPENING TO BE LEFT SO AS NOT TO HOLD UP WORK
- ELECTRICAL CONTRACTOR TO BE RESPONSIBLE FOR ANY DAMAGE CAUSED BY THEM AND/OR BY 9.4. ANY OTHER ELECTRICAL SUB-TRADE BY IMPROPER LOCATION OR CARRYING OUT OF HIS WORK
- ELECTRICAL CONTRACTOR IN SETTING OUT OF HIS WORK, TO MAKE REFERENCE TO ARCHITECTURAL, STRUCTURAL, AND MECHANICAL DRAWINGS. CONSULT WITH RESPECTIVE TRADES IN SETTING OUT LOCATIONS FOR CONDUIT RUNS, LIGHTING FIXTURES, PANEL ASSEMBLIES, AND THE LIKE, SO THAT CONFLICTS ARE AVOIDED AND SYMMETRICAL SPACING IS MAINTAINED.
- 9.6. WHERE RECEPTACLES ARE MOUNTED ABOVE COUNTERS, BENCHES, SPLASHBACKS, AND THE LIKE, LOCATION AND MOUNTING HEIGHTS TO BE COORDINATED WITH BUILT-IN UNITS. REFER TO ARCHITECTURAL DETAILS, WHERE RECEPTACIES OCCUR IN OUTSIDE WALLS WHERE HEATING UNITS OCCUR. RECEPTACLE HEIGHT TO BE ADJUSTED TO COORDINATE WITH THE HEATING UNIT.
- 9.7. ELECTRICAL CONTRACTOR TO COORDINATE ANY INTERRUPTIONS TO ADJOINING TENANTS IN ORDER TO AVOID ANY INCONVENIENCES TO SAID TENANT. IF NECESSARY ELECTRICAL CONTRACTOR TO DO ANY REQUIRED CONNECTIONS ON OFF HOURS.
- SWITCH MOUNTING HEIGHTS TO BE COORDINATED WITH ARCHITECTURAL DETAILS AND TO BE ADJUSTED IF REQUIRED, TO COORDINATE WITH PANELING, MASONRY COURSE LINES AND THE LIKE.
- WHERE OUTLETS OCCUR IN EXTERIOR WALLS, ELECTRICAL CONTRACTOR TO ENSURE THAT THERE IS 9.9. INSULATION BEHIND THE OUTLET BOXES TO PREVENT CONDENSATION THROUGH THE BOXES.

### 10. EXAMINATION OF SITE

10.1. PRIOR TO SUBMITTING TENDER, ELECTRICAL CONTRACTOR TO CAREFULLY EXAMINE THE SITE AND ASCERTAIN ALL CONDITIONS WHICH MAY AFFECT HIS TRADE. NO EXTRAS WILL BE ALLOWED FOR WORK RESULTING FROM CONDITIONS WHAT WOULD HAVE BEEN EVIDENT UPON A THROUGH EXAMINATION OF SITE.

### 11 CLEANUP

- 11.1. ELECTRICAL CONTRACTOR AND HIS SUBTRADES AT ALL TIMES DURING CONSTRUCTION, KEEP SITE FREE OF ALL DEBRIS, BOXES, PACKING AND THE LIKE RESULTING FROM WORK OF THIS TRADE. 11.2. UPON COMPLETION OF WORK, ELECTRICAL INSTALLATION TO BE LEFT IN A CLEAN AND FINISHED
- CONDITION TO SATISFACTION OF THE CONTRACT ADMINISTRATOR.

### 12. ACCESS DOORS

12.1. ELECTRICAL CONTRACTOR TO SUPPLY AND INSTALL ACESS DOORS REQUIRED FOR PROPER SERVICING OF ALL ELECTRICAL WORK. ACCESS DOORS TO BE COMPLETE WITH NECESSARY FRAMES AND HINGED DOORS HELD CLOSED WITH CAPTIVE STUDS. ACCESS PANELS TO BE OF NOT LESS THAN 14 GAUGE STEEL, PRIME COATED FINISHED AND PAINTED ON THE JOB TO MATCH THE WALL OR CEILING FINISH.

### 13. CODES, PERMITS AND INSPECTION

- 13.1. INSTALLATION TO COMPLY WITH REQUIREMENTS OF BUILDING CODES AND CANADIAN ELECTRICAL CODE AND REGULATIONS OF THE INSPECTION DEPARTMENT.
- 13.2. ELECTRICAL CONTRACTOR TO OBTAIN ALL PERMITS REQUIRED AND AFTER COMPLETION OF THE WORK

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490 Paul Blvd. Winnipeg, MB R2N 4C8 T. 204-515-1158	DRAWINGS ARE THE PROPERTY OF IBASA ENTERPRISES INC. REPRODUCTION OR	B ISSUED FOR CONSTRUCTION	AK AK 21 01 30	Certificate of Authorization Ibasa Enterprises Inc.	商 Member 5 35704 よう	PROJECT TITLE:
info@ibasa.ca www.ibasa.ca	USE FOR ANY PURPOSE OTHER THAN THAT AUTHORIZED BY IBASA ENTERPRISES INC. IS FORBIDDEN.	A ISSUED FOR REVIEW	AK AK 21 01 21		POPESSION STATES	715 MAIN ST., WINNIPEG, MB
		ISSUED	BY APPR. DATE		January 30, 2021	BID OPPORTUNITY 54-2021

15. TESTS 15.1. ALL PORTIONS OF ELECTRICAL WORK TO BE TESTED AND CHECKED FOR SATISFACTORY INSTALLATION AND OPERATION. USE STANDARD INDUSTRY FORMS. PRESENT TEST RECORDS TO THE CONTRACT ADMINISTRATOR UPON REQUEST. 15.2. BEFORE ENERGIZING ANY PORTION OF ELECTRICAL SYSTEM, PERFORM MEGGER TESTS ON ALL FEEDERS AND BRANCH CIRCUITS. RESULTS OF SUCH TESTS TO CONFORM TO REQUIREMENTS OF CANADIAN ELECTRICAL CODE AND BE TO SATISFACTION OF AUTHORIZED INSPECTION AGENCY AND THE CONTRACT ADMINISTRATOR. KEEP DATED TEST LOGS AND PRESENT TO THE CONTRACT ADMINISTRATOR UPON REQUEST.

16. COMMISSIONING

16.1. PLAN, ORGANIZE, AND HIRE A THIRD PARTY TO IMPLEMENT A CONTRACTOR PREPARED COMMISSIONING PLAN WITH A DEFINED SCHEDULE FOR ALL ELECTRICAL AND RELATED MECHANICAL SYSTEMS.

- 16.3

- 17. PAINTING AND FINISHES

# 18. CONDUIT

- IN CONCRETE.

- ELECTRICAL CODE.

FURNISH TO THE CONTRACT ADMINISTRATOR A CERTIFICATE OF FINAL INSPECTION AND APPROVAL FROM ELECTRICAL INSPECTION DEPARTMENT.

### 14. MECHANICAL EQUIPMENT

14.1. UNLESS OTHERWISE, ELECTRICAL CONTRACTOR TO SUPPLY AND INSTALL ALL CONDUIT AND WIRE. FITTINGS AND CONNECTIONS FOR ALL MECHANICAL EQUIPMENT. MOTOR PROTECTION SWITCHES COMPLETE WITH OVERLOAD RELAYS, AND OTHER REQUIRED PARTS TO COMPLETE THE JOB TO BE SUPPLIED AND INSTALLED BY ELECTRICAL CONTRACTOR. ELECTRICAL CONTRACTOR TO CONFIRM WITH MECHANICAL TRADE SIZE, CHARACTERISTICS AND LOCATIONS OF ALL MECHANICAL EQUIPMENT BEFORE INSTALLATION OF CONDUIT, OUTLETS, HEATERS, AND THE LIKE. ELECTRICAL CONTRACTOR TO EXAMINE MECHANICAL DRAWINGS FOR ALL MECHANICAL EQUIPMENT REQUIRES ELECTRICAL CONTRACTOR RELATED INSTALLATIONS. NOT ALL MECHANICAL REQUIREMENT ARE NOTED ON ELECTRICAL DRAWINGS.

15.3. UPON COMPLETION AND IMMEDIATELY PRIOR TO FINAL INSPECTION AND TAKEOVER, CHECK LOAD BALANCE ON ALL FEEDERS AND AL DISTRIBUTION CENTERS, PANELS, AND THE LIKE. TEST TO BE CARRIED OUT BY TURNING ON ALL POSSIBLE LOADS AND CHECKING LOAD CURRENT BALANCE. IF LOAD UNBALANCE EXCEEDS 15% RECONNECT CIRCUITS TO BALANCE LOAD.

16.2. COMMISSIONING PLAN SHALL INCLUDE AS MINIMUM THE FOLLOWING: INSTALLATION CHECKLISTS. START-UP CHECKLISTS, VERIFICATION, SHEETS AND INTEGRATED TESTING TESTING SHEETS. SUPPLY COMPLETE INSTRUCTIONS AND INFORMATION RELATING TO THE OPERATION AND MAINTENANCE OF ALL EQUIPMENT AND SYSTEMS.

16.4. DELIVER A SYSTEM WHICH PERFORMS IN ACCORDANCE WITH THE CONTRACT DOCUMENTS AND EQUIPMENT MANUFACTURER'S REQUIREMENTS.

17.1. ALL ELECTRICAL FITTINGS, SUPPORT, HANGER RODS, PULLBOXES, CHANNEL FRAMES, CONDUIT RACKS, OUTLET BOXES, BRACKETS, CLAMPS AND ALL OTHER SIMILAR COMPONENTS OF THE ELECTRICAL INSTALLATION TO HAVE GALVANIZED FINISH OR PAINT FINISH OVER CORROSION-RESISTANCE PRIMER.

17.2. ALL PANEL TO BE FACTORY FINISHED WITH SPRAY-ON AIR DRAY ENAMEL. ALL ENAMEL TO BE APPLIED OVER CORROSION-RESISTANCE PRIMER. MATT OR FLAT TYPE FINISH PAINT WILL NOT BE ACCEPTED, ALL PANELS OR SIMILAR FACTORY FINISHED UNITS THAT ARE SCRATCHED OR MARKED DURING INSTALLATION TO BE TOUCHED UP WITH MATCHING SPRY-ON AIR DRY LACQUER AND IF REQUIRED TO PROVIDE SATISFACTORY JOB TO BE COMPLETELY REFINISHED. 17.3. ALL PANELBOARDS, PULLBOXES AND THE LIKE TO BE FINISHED IN GRAY ENAMEL.

17.4. PULLBOXES, JUNCTIONBOXES, TERMINAL PANELS, AND THE LIKE TO BE FINISHED IN ACCORDANCE WITH EXISTING BUILDING.

18.1. ALL WIRE AND CABLE TO BE INSTALLED IN CONDUIT EXCEPT WHERE IS NOTED OTHERWISE ON THE DRAWINGS. BX WIRING MAY BE UTILIZED FOR DROPS FROM JUNCTION BOXES TO OUTLETS AND LIGHTS NOT TO EXCEED 30 FEET IN LENGTH.

18.2. CONDUIT TO BE ELECTRIC METALLIC TUBING, UTILIZE RIGID GALVANIZED STEEL CONDUIT FOR ALL EXPOSED RUNS OUTDOOR ABOVE GRADE AND WHERE IN JUDGMENT BY THE ELECTRICAL INSPECTION AUTHORITY IS SUBJECT TO MECHANICAL DAMAGE.

18.3. PROVIDE HEAVY WALL RIGID PVC CONDUIT FOR BURIED AND FOR BELOW GRADE INSTALLATIONS AND

18.4. SURFACE MOUNTED CONDUITS TO BE INSTALLED PARALLEL OR PERPENDICULAR TO STRUCTURAL

LINES AND WHERE BENDS OCCUR FOR PARALLEL RUNS, THEY SHALL BE CONCENTRIC. 18.5. CONDUITS TO BE INSTALLED FREE FROM DENTS AND HAVE ENDS PLUGGED TO PREVENT ENTRANCE OF DUST OR MOISTURE

18.6. ALL CONDUITS, EXCEPT WHERE OTHERWISE TO BE SIZED IN ACCORDANCE WITH CANADIAN

18.7. FLEXIBLE CONDUIT CONNECTIONS TO MOTORS, CONTROLS, AND THE LIKE TO BE FLEXIBLE PLASTIC JACKETED, SEAL TIGHT OR APPROVED EQUAL. FLEXIBLE CONDUIT CONNECTIONS ARE REQUIRED TO ALL MOTORS FROM STUB-UP OR JUNCTION BOXES.

18.8. APPROPRIATE AND COORDINATED METAL TYPE FITTINGS TO BE USED WITH CONDUITS.

18.9. SUPPLY & INSTALL FLEXIBLE CONDUIT CONNECTIONS FOR PRIMARY AND SECONDARY FEEDS TO DRY TYPE TRANSFORMERS TO REDUCE NOISE TRANSMISSION.

### 19. EXPANSION JOINTS

19.1. WHERE CONDUITS ARE INSTALLED IN CONCRETE SLABS AND CROSS STRUCTURAL EXPANSION JOINTS,

IRE	SHEET TITLE: INSTALLATION SPE	SHEET NO:	
	PROJECT NO: 201231 SCALE: NTS	DESIGNED BY: AK DRAWN BY: AK REVIEWED BY: AK	E08.1

AN APPROVED EXPANSION FITTING COMPLETE WITH BONDING JUMPER AND CLAMPS SHALL BE INSTALLED. ELECTRICAL CONTRACTOR TO USE APPROVED EXPANSION JOINTS.

### 20 WIRE AND CABLE

- 20.1. ALL BUILDING WIRING TO BE APPROVED COPPER OR ALUMINUM.
- 20.2. MINIMUM CONDUCTOR SIZE IS #12 AWG TO BE USED.
- 20.3. SMALL CONDUCTORS FOR CONTROL OR LOW VOLTAGE WORK TO BE USED WHERE CALLED FOR ON DRAWINGS OR IN SPECIFICATIONS.
- 20.4. ALL CONDUCTORS TO BE COLOR CODED THROUGHOUT IN ACCORDANCE WITH THE FOLLOWING TO MATCH EXISTING:

EQUIPMENT GROUNDING CONDUCTOR - GREEN NEUTRAL CONDUCTOR - WHITE

120/208 VOLTS PHASE WIRES - RED, BLACK, AND BLUE

### 21. OUTLET BOXES

- 21.1. BOXES: HOT DIP GALVANIZED, CONFORMING TO CSA REQUIREMENTS.
- 21.2. USE CEILING FIXTURE BOX WITH CEILING GRID BRACKET FOR ALL INSTALLATIONS IN CEILING GRIDS.
- 21.3. BOXES FOR CEILING: #54151 OR #72171 OR SIMILAR APPROVED.
- 21.4. BOXES FOR INDOOR SURFACE MOUNTED EQUIPMENT, USE 4 INCH SQUARE #52151, #52171,
- #58361 OR SIMILAR APPROVED WITH APPROVED COVERS.
- 21.5. ÄLL OUTLET BOXES TO BE FLUSH MOUNTED EXCEPT AS SPECIFIED.
- 21.6. NO DRYWALL PLATES, PLASTER PLATES, BOXES WITH OPEN BACK, SECTIONAL, OR HANDY BOXES ALLOWED.

22. LOCATION OF OUTLETS

- 22.1. THE CONTRACT ADMINISTRATOR RESERVES THE RIGHT TO CHANGE LOCATION OF OUTLETS TO WITHIN THREE METERS OF POINTS INDICATED ON THE PLANS WITHOUT EXTRA CHARGE PROVIDING CONTRACTOR IS ADVISED BEFORE INSTALLATION IS MADE.
- 22.2. ELECTRICAL CONTRACTOR TO REFER TO ARCHITECTURAL ROOM ELEVATIONS FOR POSITION, AND MOUNTING HEIGHTS OF ALL OUTLETS, SWITCHES, INTERCOMMUNICATIONS, TELEPHONES, SPEAKERS, CLOCKS, AND THE LIKE. POSITIONS SHOWN ON ARCHITECTURAL PLANS TO TAKE PRECEDENCE OVER POSITIONS OR MOUNTING HEIGHTS SHOWN ON ELECTRICAL PLANS.

### 23. PULLBOXES

23.1. SUPPLY AND INSTALL PULLBOXES AS REQUIRED TO SUIT JOB CONDITIONS. PULLBOXES TO CONFORM TO CANADIAN ELECTRICAL CODE AND BE FINISHED IN ENAMEL OVER CORRISION-RESISTANCE PRIMER WITH SCREW-ON OR HINGED COVER. IN REMOVABLE CEILING AREAS, PULLBOXES ARE TO BE INSTALLED ABOVE THE CEILING. PULLBOXES IN FINISHED WALLS AND PLASTER OR NON-REMOVABLE CEILINGS TO HAVE OVERLAPPING TYPE TRIM WITH COVERS PRIME COATED AND PAINTED ON JOB TO MATCH WALL OR CEILING FINISH.

### 24. SWITCHES AND RECEPTACIES

- 24.1. LINE VOLTAGE SWITCHES TO BE RATED 15A, 125 VOLTS, OF MATCHING FINISH TO SURROUNDING, EXCEPT WHEN NOTED. TWO POLE, THREE WAY, FOUR WAY SWITCHES TO BE OF MATCHING TYPE. 24.2. STANDARD RECEPTACLES TO MATCH EXISTING OR EQUAL.
- 24.3. ISOLATED GROUND RECEPTACLES TO BE THREE WIRE, ORANGE FACE, STRAIGHT BLADE, COVER PLATE TO BE OF IMPACT RESISTANCE OF MATCHING FINISH TO SURROUNDING, EXCEPT WHEN NOTED.
- 24.4. PLATES FOR ALL FLUSH MOUNTING DEVICES TO BE OF THERMOPLASTIC WITH MATCHING FINISH TO SURROUNDING, EXCEPT WHEN NOTED.
- 24.5. PROVIDE LABELS FOR ALL RECEPTACLES.
- 24.6. FOR ALL RECEPTACLES OTHER THAN STANDARD 15A DUPLEX RECEPTACLES, PROVIDE TAGS GIVING AMP RATING, PHASE, AND VOLTAGE.

### 25. SUPPORTS

- 25.1. ALL SURFACE CONDUITS, ELECTRICAL EQUIPMENT, AND THE LIKE TO BE SECURELY AND ADEQUATELY SUPPORTED.
- 25.2. CABLES INSTALLED ON ROOF SHALL BE INSTALLED MECHANICALLY SECURED & SUPPORTED TO CABLE TRAY SYSTEM. SECURING CABLES TO ROOF RUBBER BLOCKS DIRECTLY IS NOT AN ACCEPTABLE MECHANICAL SUPPORT MEANS.
- 25.3. WHERE INSERTS ARE REQUIRED IN CONCRETE, EXPANSION INSERTS, LEAD INSERTS OR PLASTIC INSERTS TO BE USED IN DRILLED HOLES. SHORT DRIVEN PINS MAY BE USED IN STRUCTURAL CONCRETE ONLY WITH THE PERMISSION OF THE CONTRACT ADMINISTRATOR.
- 25.4. ELECTRICAL CONTRACTOR TO RETAIN THE SERVICES OF STRUCTURAL CONTRACT ADMINISTRATOR LICENCE IN THE PROVINCE OF THE PROJECT TO REVIEW & TO DESIGN SUPPORTS FOR ANY ELECTRICAL ITEMS HUNG FROM CEILING. PROVIDE CERTIFICATION LETTER FROM DESIGN CONTRACT ADMINISTRATOR HEREIN AFTER WORK COMPLETION.
- 25.5. SUPPLY & INSTALL ADEQUATE SOLID BACKING IN WALLS TO EXTEND AT LEAST TWO TIMES THE SQUARE AREA OF THE MOUNTING SURFACE OF THE FIXTURE INSTALLED FOR WALL MOUNTED FOUIPMENT

### 26 GROUNDING

- 26.1. SUPPLY AND INSTALL COMPLETE GROUNDING SYSTEM AS REQUIRED BY THE CANADIAN ELECTRICAL CODE AND THE ELECTRICAL INSPECTION DEPARTMENT. ALL COMPONENTS TO BE SECURELY AND ADEQUATELY GROUNDED AND WHERE REQUIRED TO ACCOMPLISH THIS, GROUNDING JUMPERS, GROUNDING STUDS AND BUSHING TO BE USED.
- 26.2. PROVIDE AN UN-INSULATED ISOLATED GROUND BUS IN NEW ELECTRICAL PANEL AND PROVIDE A #6 AWG INSULATED ISOLATED GREEN GROUND WIRE FROM ISOLATED GROUND BUS TO MAIN GROUND BUS IN BUILDING ELECTRICAL ROOM.

- 26.3. PROVIDE A #12 INSULATED ISOLATED GREEN GROUND WIRE FROM EACH ISOLATED GROUND OUTLET TO INSULATED ISOLATED GREEN GROUND BUS IN PANEL.
- 26.4. PROVIDE BONDING JUMPER ACROSS WATER METER.
- 26.5. ALL GROUND RODS SHALL BE INSTALLED IN LISTED PVC GROUND TEST WELL INSTALLED PER MANUFACTURER SPECIFICATIONS.

### 27. PANELS

- 27.1. NEW PANELS TO BE 120/208 VOLTS, 347/600 VOLTS, OR AS NOTED, 4 WIRE, SOLID NEUTRAL DESIGN WITH SEQUENCE STYLE BUSSING AND FULL CAPACITY NEUTRAL, COMPOSED OF AN ASSEMBLY OF BOLT IN PLACE TO ACCEPT MOLDED CASE CIRCUIT BREAKERS AS INDICATED WITH THERMAL AND MAGNETIC TRIP AND TRIP FREE POSITIONS SEPARATE FROM EITHER THE ON OR THE OFF POSITION. TWO AND THREE POLE BREAKERS TO HAVE A COMMON SIMULTANEOUS TRIP.
- 27.2. UTILIZE EXITING PANELBOARDS AS INDICATED ON THE DRAWING. REUSE EXITING BREAKERS WHERE IS POSSIBLE. PROVIDE NEW BREAKERS AS REQUIRED (FOR PROJECTS WITH EXISTING ELECTRICAL SERVICE AND DISTRIBUTION).
- 27.3. BALANCE PANEL LOAD FOR EACH PHASES, A, B, AND C. ALLOW FOR RELOCATING CIRCUITS WITHIN PANELBOARDS TO BALANCE THE LOAD.
- 27.4. PROVIDE COMPUTER PRINTED PANEL DIRECTORIES FOR ALL PANELS.
- 27.5. USE AFCI (ARC FAULT CIRCUIT INTERRUPTER) CIRCUIT BREAKERS FOR SLEEPING AREA CIRCUITS.

28. LIGHTING LUMINARIES AND LIGHTING CONTROLS

- 28.1. ELECTRICAL CONTRACTOR TO SUPPLY AND INSTALL ALL LIGHTING LUMINARIES COMPLETE WITH LAMPS, MOUNTING BRACKETS, BALLASTS AND ALL NECESSARY ACCESSORIES IN ACCORDANCE WITH THE LUMINARIES TYPES SHOWN.
- 28.2. ALL LIGHT FIXTURES' COLOR TEMPERATURE SHALL BE CONSISTENT.
- 28.3. ELECTRICAL CONTRACTOR TO SUPPLY AND INSTALL ALL LIGHTING CONTROLS WITH LINE VOLTAGE SWITCHES, DIMMER SWITCHES (RATED 1500 WATT), LOW VOLTAGE DIMMER SWITCHES, LOW VOLTAGE SWITCHES, LIGHTING RELAYS, BARRIER AND ALL CONTROL WIRING AND COMPONENTS TO SUIT THE LAYOUT. ALL MATERIAL AND INSTALLATION SHALL BE IN ACCORDANCE WITH THE RECOMMENDATION OF THE MANUFACTURER AND COMPLY WITH CODES.
- 28.4. LOW VOLTAGE MASTER SWITCHES AND BUILDING LIGHTING CONTROL SHALL HAVE THE CAPABILITY TO TURN ON AND OFF ALL LIGHTING (120 AND 347 VOLTS) WITH THE EXCEPTION OF LUMINARIES ON EMERGENCY LIGHTING CIRCUITS OR UN-SWITCHED NIGHT LIGHT CIRCUITS.
- 28.5. COORDINATE LIGHTING CONTROL PROGRAMMING WITH THE BUILDING SUPERVISOR.
- ALL LIGHTING RELAYS SHALL BE LOCATED IN THE ELECTRICAL ROOM. PROVIDE NEW RELAY CABINET 28.6. AS REQUIRED TO SUIT LAYOUT.
- 28.7 INSTALL OUTDOOR LIGHTING LUMINARIES TO BE CONTROLLED BY ASTRONOMICAL TIME-LOCK AND PHOTO SWITCH
- 28.8. LIGHT STANDARD CONCRETE BASES, WHERE LIGHT STANDARD SPECIFIED, ARE TO BE PROVIDED BY GENERAL CONTRACTOR, WITH CONDUIT EMERGING FROM CENTER OF BASE.
- 28.9. LED LIGHT FIXTURES SHALL CARRY A MANUFACTURER WARRANTY FOR FIVE YEARS AT MINIMUM STARTING ONE DAY AFTER THE DATE OF THE FINAL CONTRACT ADMINISTRATOR'S CERTIFICATION I FTTFR.

29. EXIT LIGHTING AND EMERGENCY LIGHTING

- 29.1. PROVIDE NEW EXIT LIGHTS TO MATCH BUILDING STANDARD, EMERGENCY BATTERY UNITS, EMERGENCY REMOTE HEADS AND CONNECT LUMINARIES TO EMERGENCY LIGHTING CIRCUIT AS SHOWN ON THE DRAWINGS
- 29.2. EMERGENCY BATTERY SHALL HAVE A FULL LOAD CAPACITY OF A PERIOD OF MINIMUM 30 MINUTES UNLESS IT IS SPECIFIED OTHERWISE ON THE DRAWINGS.
- 29.3. CHECK CIRCUIT LOADING OF ALL LIGHTING CIRCUITS AND EXIT LIGHTING CIRCUITS PRIOR TO CONNECTION. PROVIDE NEW CIRCUITS IF REQUIRED.
- EMERGENCY LIGHTING SHALL BE INTERLOCKED WITH SPACE LIGHTING IN AREA OF SERVICE. PROVIDE VOLTAGE SENSING RELAY UNITS OR OTHER MEANS OF INTERLOCK ACCEPTABLE TO THE CONTRACT ADMINISTRATOR.

30. FIRE ALARM SYSTEM

- 30.1. PROVIDE NEW DEVICES OR RELOCATE EXISTING DEVICES AS SPECIFIED FOR A COMPLETE OPERATING FIRE ALARM SYSTEM AS REQUIRED BY CODE OR SHOWN ON THE DRAWINGS.
- 30.2. MANUAL PULL STATIONS WITH GLASS RODS USED AS PULL HANDLE RESTRAIN ARE NOT ACCEPTABLE.
- LOCATE STROBE LIGHTS TO OBTAIN GREATEST VISIBILITY IN THE SPACE. USE ADDITIONAL STROBE 30.3 LIGHTS TO ACHIEVE VISIBILITY.
- 30.4. USE LOOP ISOLATORS TO MAINTAIN/PROTECT THE CONTINUITY OF THE FIRE ALARM DETECTION CIRCUIT.
- 30.5. INSTALL FIRE ALARM DETECTORS IN THE OPTIMUM LOCATION TO ACHIEVE THE BEST DETECTION.
- 30.6. UPON COMPLETION OF SYSTEM MODIFICATIONS, ELECTRICAL CONTRACTOR TO HIRE BASE BUILDING FIRE ALARM CONTRACTOR TO PERFORM SYSTEM VERIFICATION, ENCOMPASSING ALL REVISIONS TO THE FIRE ALARM SYSTEM.
- 30.7. FIRE ALARM INSTALLATION TO COMPLY WITH CSA-S524-06 & VERIFIED TO CSA-S537-04.
- 30.8. INCLUDE AND PAY FOR INTEGRATED SYSTEMS TESTING OF ALL FIRE PROTECTION AND ALL LIFE SAFETY SYSTEMS IN THE CONTRACT PER CAN/ULC-S1001 INCLUDING PREPARATION OF TESTING PLAN. SUBMIT PLAN FOR CONTRACT ADMINISTRATOR'S REVIEW PRIOR TO TESTING COMMENCEMENT.

31. COMMUNICATION/DATA

	COPY RIGHT RESERVED: THE CONTRACTOR SHALL VERIFY AND BE	E		SEAL:	OF MARK	CLIENT: BRIDGMAN COLLABORATIVE ARCHITECTUR 678 MAIN STREET
IBASA Electrical Engineering	RESPONSIBLE FOR ALL DIMENSIONS. DO NOT SCALE THE DRAWING - ANY ERRORS OR OMISSIONS SHALL BE REPORTED TO	D RE-ISSUED FOR CONSTRUCTION	AK AK 21 02 26	APEGN		WINNIPEG, MB R3B 1E4
ENTERPRISES Design & Consulting	IBASA ENTERPRISES INC. THE COPYRIGHTS TO ALL DESIGNS AND	C RE-ISSUED FOR CONSTRUCTION	AK AK 21 02 04		° (KASEM ) <sup>≁</sup>	(204)488-3857
490 Paul Blvd. Winnipeg, MB R2N 4C8 T. 204-515-1158	DRAWINGS ARE THE PROPERTY OF IBASA ENTERPRISES INC. REPRODUCTION OR	B ISSUED FOR CONSTRUCTION	AK AK 21 01 30	Certificate of Authorization Ibasa Enterprises Inc.	商 Member 臣 35704 S	PROJECT TITLE:
info@ibasa.ca www.ibasa.ca	USE FOR ANY PURPOSE OTHER THAN THAT AUTHORIZED BY IBASA ENTERPRISES	A ISSUED FOR REVIEW	AK AK 21 01 21	No. 5474 Expiry: April 30, 2021	POFESSION S	LOO LOO WINNIPEG
	INC. IS FORBIDDEN.	ISSUED	BY APPR. DATE	10. 0474 Expiry. April 30, 2021	January 30, 2021	715 MAIN ST., WINNIPEG, MB BID OPPORTUNITY 54–2021

32. FOUIPMENT IDENTIFICATION OR PRIOR TO ORDER.

3.3 GENERAL

33.4. ALLOW AFTER HOUR WORK AND PROVIDE TEMPORARY POWER AND LIGHTING TO SUIT CONSTRUCTIONS SCHEDULE AND PHASES.

CORING

- TO INSTALLATION.

- PROOF HOOD.

31.1. PROVIDE OUTLET BOXES AND EMPTY CONDUITS WITH PULL STRING FOR COMMUNICATION OUTLETS AS SHOWN AND NOTED ON THE DRAWINGS.

31.2. INSTALL 1 INCH CONDUIT FROM EACH COMMUNICATION OUTLET -PHONE/CABLE/ETHERNET- TO COMMUNICATION BOARD/DEMARCATION POINT/NETWORK SERVER.

31.3. USE J-HOOKS IN ACCESSIBLE CEILING SPACES ONLY WHEN PERMITTED BY THE CONTRACT ADMINISTRATOR, USE CONDUITS IN CONCEALED SPACES OR TO PASS THROUGH PARTITIONS/WALLS. 31.4. WHERE WIRING IS INCLUDED IN CONTRACT, TESTING OF ALL WIRING SHALL BE DOCUMENTED AND PRESENTED TO THE CONTRACT ADMINISTRATOR UPON REQUEST.

32.1. PROVIDE COMPUTER PRINTED LABELS OR LAMACOID ENGRAVED PLATES IN INDUSTRY ACCEPTABLE STANDARDS TO THE SATISFACTION OF THE CONTRACT ADMINISTRATOR TO BE SUITABLE FOR INSTALLATION ENVIRONMENT

32.2. IDENTIFICATION TO BE AFFIXED TO EQUIPMENT, PANELS, SAFETY AND DISCONNECT SWITCHES, TRANSFORMERS, PULL BOXES, TERMINAL CABINETS, BATTERY BANKS, RECEPTACLES, AND ALL OTHER EQUIPMENT ON THE DRAWINGS.

32.3. IDENTIFICATION WORDING TO BE APPROVED BY THE CONTRACT ADMINISTRATOR PRIOR TO PRINTING

33.1. COORDINATE AND GET APPROVAL FROM BUILDING OWNER OR HIS REPRESENTATIVE FOR ALL CORING AND CUTTING OF BUILDING STRUCTURE, X-RAY AND COORDINATE LOCATION ON SITE PRIOR TO

33.2. CLEAN UP AND REMOVE ALL UNUSED WIRING AND CONDUITS.

33.3. REWIRE EXISTING LIGHTING AND POWER THAT ARE AFFECTED BY THIS CONSTRUCTION.

33.5. CONFIRM OUTLET LOCATIONS AND MOUNTING HEIGHT WITH PROJECT COORDINATOR ON SITE PRIOR

33.6. FIRE PROOF ALL FIRE RATED PENETRATIONS AFTER INSTALLATION TO COMPLY WITH CODES AND TO PROVIDE EQUAL FIRE SEPARATION RATING.

33.7. ELECTRICAL EQUIPMENT INSTALLED IN SPRINKLERED BUILDING SHALL BE COMPLETE WITH DRIP

33.8. ELECTRICAL CONTRACTOR TO REPAIR TO FULLY WORKING CONDITION ANY ELECTRICAL INSTALLATION AFFECTED BY THIS CONTRACT (FOR WORK IN OR ADJACENT TO EXISTING BUILDINGS.)

33.9. INSTALL BASEBOARD HEATERS 4" ABOVE FINISH FLOOR LEVEL.

33.10. SUPPLY & INSTALL 3/4" PLYWOOD C/W FIRE RETARDANT PAINT BEHIND ELECTRICAL PANEL & FOR COMMUNICATION BOARD. INCLUDE PAINT MANUFACTURER CERTIFICATE OF COMPLIANCE AS PART OF O&M MANUAL

33.11. ELECTRICAL CONTRACTOR TO SUPPLY & INSTALL PAINT & MUD PROTECTION FOR ELECTRICAL ROUGH-IN INSTALLATIONS INCLUDING WIRES, BOXES, AND THE LIKE.

33.12. INSTALL ELECTRICAL WIRING AND CONNECTIONS FOR POWER DOOR OPERATORS AS SPECIFIED ON PROJECT DRAWINGS. COORDINATE WITH MANUFACTURER AND SUPPLIER.

33.13. CAULK ALL PENETRATIONS IN ASSEMBLIES USED FOR ELECTRICAL INSTALLATION TO RESTORE COMPARABLE FINISH AND TO THE SATISFACTION OF THE CONTRACT ADMINISTRATOR.

IRE	SHEET TITLE: INSTALLATION SPE	CIFICATIONS-PART 2	SHEET NO:
	PROJECT NO: 201231 SCALE: NTS	DESIGNED BY: AK DRAWN BY: AK REVIEWED BY: AK	E08.2

## **GENERAL NOTES**

- 1. THIS SET OF DRAWINGS SHOWS THE COMPLETED PROJECT. IT IS TO BE READ IN CONJUNCTION WITH THE NON-STRUCTURAL DRAWING SETS. IT DOES NOT INCLUDE COMPONENTS THAT MAY BE NECESSARY FOR CONSTRUCTION SAFETY. THE CONTRACTOR IS RESPONSIBLE FOR SAFETY IN AND ABOUT THE JOB SITE DURING CONSTRUCTION. AND THE DESIGN AND ERECTION OF ALL TEMPORARY STRUCTURES. FORM WORK, FALSE WORK, SHORING, ETC. REQUIRED TO COMPLETE THE WORK.
- 2 THE USE OF THESE DRAWINGS IS LIMITED TO THAT IDENTIFIED IN THE REVISIONS COLUMN. DO NOT CONSTRUCT FROM THESE DRAWINGS UNLESS MARKED "ISSUED FOR CONSTRUCTION" IN THE REVISIONS COLUMN BY CONTRACT ADMINISTRATOR.
- THE INFORMATION ON THIS DRAWING SHALL NOT BE USED FOR ANYTHING OTHER THAN THE SPECIFIED WORKS OR PART OF THE WORKS FOR WHICH IT HAS BEEN AUTHORIZED BY CONTRACT ADMINISTRATOR.
- SEE ARCHITECTURAL DRAWINGS FOR FLOOR AND ROOF ELEVATIONS, RECESSES, DRAINAGE SLOPES, DETAILED DIMENSIONS FOR DOORS, WINDOWS AND OTHER OPENINGS ETC.
- SEE ARCHITECTURAL, MECHANICAL, AND ELECTRICAL DRAWINGS FOR SLEEVES, NAILERS, INSERTS, ETC. TO BE ENCASED IN 5 CONCRETE.
- THE CONTRACTOR SHALL REVIEW ALL THE DRAWINGS AND CHECK DIMENSIONS BEFORE CONSTRUCTION. REPORT DISCREPANCIES BETWEEN STRUCTURAL AND OTHER DISCIPLINES DRAWINGS FOR CLARIFICATION.
- THE CONTRACTOR SHALL REPORT ANY SITE MODIFICATIONS MADE DURING CONSTRUCTION, THAT DIFFER FROM THE STRUCTURAL DRAWINGS, TO CONTRACT ADMINISTRATOR FOR REVIEW
- DO NOT CUT OR DRILL ANY OPENINGS IN STRUCTURAL MEMBERS WITHOUT THE WRITTEN PERMISSION OF CONTRACT 8. ADMINISTRATOR. CONTRACTOR TO PROVIDE APPROPRIATE ATTACHMENTS AND CONNECTIONS FOR MECHANICAL, ELECTRICAL, AND OTHER SERVICES WITHOUT CUTTING OR DRILLING.
- REFER TO ARCHITECTURAL, MECHANICAL, ELECTRICAL DRAWINGS FOR LOCATIONS, CONFIGURATIONS, EXTENT, AND SIZES OF ALL 9 CURBS, UPSTANDS, DOWNTURNS: AND FOR OPENINGS THROUGH FLOORS AND WALLS FOR DUCTS.
- FIRE RESISTANCE RATINGS: SEE ARCHITECTURAL DRAWINGS AND SPECIFICATION FOR PRECISE LOCATIONS OF REQUIRED FIRE RESISTANCE RATINGS.
- 11. THE CONTRACTOR SHALL BE FAMILIAR WITH THE CONTENT AND RECOMMENDATIONS OF THE GEOTECHNICAL REPORTS.
- THE CONTRACTOR SHALL SUBMIT SHOP DRAWINGS FOR ALL STRUCTURAL COMPONENTS TO CONTRACT ADMINISTRATOR FOR 12. REVIEW PRIOR TO FABRICATION. SHOP DRAWINGS ARE TO INCLUDE SEAL AND SIGNATURE OF A PROFESSIONAL ENGINEER. REGISTERED IN THE PROJECT PROVINCE, FOR DESIGN OF COMPONENTS AND/OR CONNECTIONS AS REQUIRED.

### OWNERSHIP AND COPYRIGHT RESERVED

ALL DRAWINGS, PLANS, MODELS, DESIGNS, SPECIFICATIONS AND OTHER DOCUMENTS PREPARED BY CONTRACT ADMINISTRATOR AND USED IN CONNECTION WITH THE PROJECT ARE INSTRUMENTS OF SERVICE FOR THE EXECUTION OF THE PROJECT, AND ARE AND REMAIN THE PROPERTY OF CONTRACT ADMINISTRATOR, WHETHER THE PROJECT IS EXECUTED OR NOT, AND CONTRACT ADMINISTRATOR RESERVES THE COPYRIGHT THEREIN AND IN THE WORK EXECUTED THEREFROM: SHALL NOT BE USED FOR ANY OTHER PROJECT. EXCEPT ONLY FOR GENERAL REFERENCE PURPOSES FOR ADDITION OF ALTERATION TO THE WORK SHOWN IN THEM, AND SINCE SUCH DOCUMENTS ARE "DESIGN" DOCUMENTS ONLY AND MAY NOT REPRESENT THE ACTUAL PROJECT "AS CONSTRUCTED". USE OF THESE DOCUMENTS FOR GENERAL REFERENCE PURPOSES IS AT THE SOLE RISK OF THE PARTY USING THEM. THEY SHALL NOT BE COPIED WITHOUT THE WRITTEN CONSENT OF AN AUTHORIZED REPRESENTATIVE OF CONTRACT ADMINISTRATOR.


# LIST OF STRUCTURAL DRAWINGS

Sheet No.	Sheet Name	Sheet No.	Sheet Name
S001	GENERAL NOTES - PAGE 1	S301	BUILDING SECTIONS
S002	GENERAL NOTES - PAGE 2	S302	SECTION - GRID A INTERIOR
S101	FOUNDATION FRAMING PLAN	S303	SECTION - GRID B - MECH.
S102	MAIN FLOOR FRAMING PLAN	S304	SECTION - GRID B - SINKS
S103	SECOND LEVEL FRAMING PLAN	S305	SECTION -GRID C - OFFICE
S104	THIRD LEVEL FRAMING PLAN	S401	SECTIONS AND DETAILS
S105	ROOF FRAMING PLAN	S402	SECTIONS AND DETAILS
S106	SITE CONCRETE PLAN	S403	SECTIONS AND DETAILS
S201	NORTH ELEVATION	S901	SECTIONS AND 3D DETAILS
S202	SOUTH ELEVATION	S902	3-D DETAILS
S203	EAST AND WEST ELEVATIONS		

# ABBREVIATIONS

ALT	ALTERNATE
вот	BOTTOM
BR	BRACKET
BTW	BETWEEN
B/W	BOTH WAYS
BLL	BOTTOM LOWER LAYER
BUL	BOTTOM UPPER LAYER
C/W	COMPLETE WITH
CL	CENTRELINE
C/C	CENTRE TO CENTRE
CIP	CAST IN PLACE
CMU	CONCRETE MASONRY UN
DL	DEAD LOAD
LL	LIVE LOAD
SL	SNOW LOAD
E/E	EACH END
E/F	EACH FACE
E/S	EACH SIDE
E/W	EACH WAY
H1E	HOOK ONE END
H2E	HOOK TWO ENDS
H & V	HORIZONTAL AND VERTIC
HOR	HORIZONTAL

## SYMBOL LEGEND

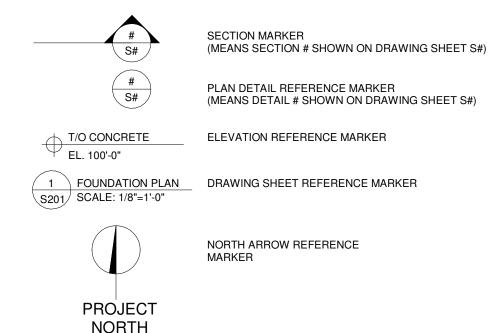



# SWP PROJECTS LTD.

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# 715 MAIN STREET PUBLIC TOILET

No.	Description	Date
1	ISSUED FOR CONSTRUCTION	21-03-04

**BID OPPORTUNITY 54-2021** 


THE CITY OF WINNIPEG

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CAL	

GALV	HOT DIPPED GALVANIZED
MAX.	MAXIMUM
MIN.	MINIMUM
N.T.S.	NOT TO SCALE
O/C	ON CENTER
R/W	REINFORCED WITH
S.D.L.	SUPERIMPOSED DEAD LOAD
SIM.	SIMILAR
S.O.G.	SLAB ON GRADE
STAG.	STAGGER
S.J.	STRUT JOIST
TLL	TOP LOWER LAYER
TUL	TOP UPPER LAYER
TYP.	TYPICAL
T/O	TOP OF
T1E	TIE ONE END
Т&В	TOP AND BOTTOM
T & C	TENSION AND COMPRESSION
U.N.O.	UNLESS NOTED OTHERWISE
U/S	UNDER SIDE OF
VERT.	VERTICAL
OSF	OUTSIDE FACE
ISF	INSIDE FACE



Certificate of Authorization SWP Projects Ltd. No. 6036 Expiry: April 30,2021

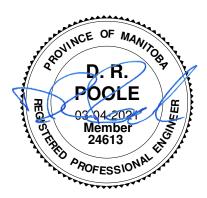

# **GENERAL NOTES - PAGE 1**

Project number	20-104
Date	2021-03-04
Drawn by	DP
Checked by	DP

S001

Scale 1:100

P≥ 2021-03-04 12:45:46

# **DESIGN CRITERIA**

THE DESIGN OF THE STRUCTURE IS IN ACCORDANCE WITH PART 4 OF DIVISION B, NBCC 2010 AND THE 2011 MANITOBA BUILDING CODE AMENDMENTS. IMPORTANCE CATEGORY NORMAL SNOW DESIGN DATA Ss = 1.9 kPa Sr = 0.2 kPa Is = 1.0 ULS / 0.9 SLS WIND DESIGN DATA 0.45 kPa q(1/50) 0.35 kPa q(1/10) lw = 1.0 ULS / 0.75 SLS SITE CLASSIFICATION FOR SEISMIC SITE RESPONSE: SITE NOT CLASSIFIED, SEISMIC DESIGN NOT REQUIRED DUE TO MB CODE AMMENDMENT

REFER TO PLANS FOR DESIGN LOADING CONTRACTOR TO ENSURE THAT CONSTRUCTION LOADS DO NOT EXCEED DESIGN LOADS.

## STRUCTURAL MOVEMENTS/ TOLERANCES

- THIS STRUCTURE WILL UNDERGO NORMAL TYPES OF MOVEMENT AND DEFLECTION AND THE NON-STRUCTURAL COMPONENTS MUST BE DETAILED TO ACCOMMODATE THIS.
- 2. DRYWALL PARTITIONS, MECHANICAL EQUIPMENT, ELECTRICAL EQUIPMENT, BUILDING FIXTURES, GLAZING AND CURTAIN WALLS MUST BE DETAILED AND INSTALLED TO ACCOMMODATE SLAB MOVEMENT.
- ALL STRUCTURES ARE SUBJECT TO CONSTRUCTION TOLERANCES. THIS SHOULD BE ALLOWED FOR IN DETAILING NON-STRUCTURAL 3. COMPONENTS.

### NON-STRUCTURAL ELEMENTS

- "NON-STRUCTURAL" OR "SECONDARY STRUCTURAL" ELEMENTS ARE NOT THE RESPONSIBILITY OF STRUCTURAL 1. ENGINEER. THEY ARE DESIGNED, DETAILED, AND REVIEWED IN THE FIELD BY OTHERS. THEY APPEAR ON DRAWINGS OTHER THAN THE STRUCTURAL ENGINEER. WHERE STRUCTURAL ENGINEERING RESPONSIBILITY IS REQUIRED FOR THESE ELEMENTS, THIS SHALL BE PROVIDED BY SPECIALTY STRUCTURAL ENGINEERS, WHO SHALL ALSO PROVIDE ANY CERTIFICATION REQUIRED BY BUILDING PERMIT AUTHORITIES. SPECIALTY STRUCTURAL ENGINEERS ARE TO DESIGN THESE ELEMENTS ACCORDING TO THE APPLICABLE DESIGN LOADS AS NOTED IN PART 4 OF THE MOST CURRENT NBCC.
- EXAMPLES OF NON-STRUCTURAL OR SECONDARY STRUCTURAL ELEMENTS INCLUDE, BUT ARE NOT LIMITED TO: 2. A. ARCHITECTURAL COMPONENTS SUCH AS GUARDRAILS, HANDRAILS, CEILINGS, MILLWORK ETC. B. LANDSCAPE ELEMENTS SUCH AS BENCHES, LIGHT POSTS, PLANTERS, ETC. C. CLADDING, GLAZING, WINDOW MULLIONS, INTERIOR STUD WALLS AND EXTERIOR STUD WALLS.
  - D. ARCHITECTURAL PRECAST, PRECAST CLADDING.
  - E. MECHANICAL AND ELECTRICAL EQUIPMENT, COMPONENTS, AND THEIR ATTACHMENT DETAILS.
  - F. ELEVATORS, ELEVATOR HOIST BEAMS, ESCALATORS, AND OTHER CONVEYING SYSTEMS.
  - G. BRICK OR BLOCK VENEERS AND THEIR ATTACHMENTS.
  - H. NON-LOAD BEARING MASONRY.
  - I. NON-STRUCTURAL CONCRETE TOPPINGS
  - J. ALUMINUM SKYLIGHTS.
  - K. STAIRS
- З. SHOP DRAWINGS FOR NON-STRUCTURAL ELEMENTS WHICH MAY AFFECT THE PRIMARY STRUCTURAL SYSTEM SHALL BE SUBMITTED TO CONTRACT ADMINISTRATOR THESE DRAWINGS WILL BE REVIEWED ONLY FOR THE EFFECT ON THE PRIMARY STRUCTURAL SYSTEM.

### LUMBER

- FRAMING LUMBER SHALL CONFORM TO THE LATEST EDITION CSA 0141 AND SHALL BE OF THE FOLLOWING MINIMUM GRADES: LINTELS, JOISTS, AND BEAMS: S-P-F No.1/No.2, STUD WALLS: S-P-F No.1/No.2
- 2. ALL SHEATHING MATERIAL TO BE MIN 1/2" THICK PLYWOOD IN ACCORDANCE WITH LATEST EDITION CSA 0325 U.N.O. ALL SHEETS TO BE STAGGERED. FASTEN SHEETS WITH 3" COMMON NAILS AT 12" O/C ALONG ALL STUDS AND AT 6" O/C ALONG EDGES OF SHEET, U.N.O. STAPLES ARE NOT ACCEPTABLE. OSB FOR VERTICAL SHEATHING ONLY
- ALL FLOOR AND ROOF JOISTS TO BE NAILED AND GLUED AND TO HAVE CONTINUOUS CROSS BRIDGING AT 6'-0" MAX. SPACING U.N.O. 3.
- 48" WOOD BLOCKING FULL DEPTH CONTINUOUS FOR STUDS. 4
- EDGE BLOCKING FOR PARALLEL WALLS AT 16", 32" AND 48" IN NEXT BAYS. 5
- WOOD IN CRAWL SPACE OR IN CONTACT WITH STEEL. MASONRY OR CONCRETE IN ITS FINAL INSTALLED CONDITION IS TO BE 6 PRESSURE TREATED U.N.O.
- CONTINUOUS SILL GASKET REQUIRED AT JOIST BEARING POINTS ON CONCRETE.

# CONCRETE

- EDITION CSA STANDARDS A23.1 AND A23.2.
- 2 TABLE 2 OF THE LATEST EDITION CSA A23.1.
- CONCRETE CLASSES OF EXPOSURE (REFER TO TABLE 1, LATEST EDITION CSA A23.1): A. GARAGE SLAB ON GRADE, THICKENED SLAB EDGE
- 4 CRITERIA AND THE CONTRACTOR'S CRITERIA FOR CONSTRUCTION AND PLACEMENT.
- CONCRETE SAMPLING AND TESTING TO BE COMPLETE IN ACCORDANCE WITH THE LATEST EDITION CSA A23.1/A23.2 5.

## **REINFORCING**

REINFORCING STEEL SHALL BE GRADE 400 DEFORMED NEW BILLET STOCK CONFORMING TO THE LATEST EDITION OF CSA SPECIFICATION G30.18. WELDED WIRE MESH SHALL CONFORM TO THE LATEST EDITION CSA A23.1 CLAUSE 6.1.1.1. 2. CONCRETE COVER TO BE AS PER TABLE 17 OF THE LATEST EDITION CSA A23.1

EXPOSURE CONDITION

CAST AGAINST AND PERMANENTLY EXPOSED TO EARTH

BEAMS, GIRDERS, COLUMNS, AND PILES

SLABS, WALLS, JOISTS

- CONCRETE COVER FOR EXPOSURE CLASSES NOT NOTED ABOVE TO BE 40 mm 3.
- SPLICE LENGTHS:
  - SPECIFIED BY SWP PROJECTS LTD.. B. COMPRESSION ZONE SPLICE SHOULD NOT BE LESS THAN 30 BAR DIAMETERS
- CONCRETE COVER FOR FIRE RATING REQUIREMENTS AS PER CURRENT EDITION OF NBCC 5.

## FOUNDATION - CAST IN PLACE SKIN FRICTION PILES

- GEOTECHNICAL AND DATED JANUARY 27, 2021.
- INCLUDING BUT NOT LIMITED TO SITE CLEANING AND GRUBBING, EXCAVATION AND PROTECTION TO SUB GRADE ELEVATION LEVEL, PROOF ROLLING OF SUB-GRADE, PLACEMENT AND COMPACTION OF GRANULAR BASE COURSES
- DESIGN HAS BEEN DONE ASSUMING ULS AND SLS SKIN FRICTION CRITERIA AS FOLLOWS: A. 0 TO 3m BELOW EXISTING GRADE - 0 kPa
- 3 TO 7m BELOW EXISTING GRADE 8 kPa SLS / 10 kPa ULS В.
  - 7 TO 11m BELOW EXISTING GRADE 7 kPa SLS / 8 kPA ULS C.

# SWP PROJECTS LTD.

678 MAIN STREET - 2ND FLR WINNIPEG, MB R3B 1E4

(P) 204.586.3636 (C) 204.330.2611 (E) david@totalprojectmgmt.ca

# 715 MAIN STREET PUBLIC TOILET

No.	Description	Date
1	ISSUED FOR CONSTRUCTION	21-03-04

**BID OPPORTUNITY 54-2021** 

# ALL CONCRETE CONSTRUCTION, COLD WEATHER CONSTRUCTION & CONCRETE TESTING TO BE IN ACCORDANCE WITH THE LATEST

ALL CONCRETE TO BE NORMAL WEIGHT HARD ROCK CONCRETE WITH A MINIMUM 28 DAY COMPRESSIVE STRENGTH AS NOTED IN

CLASS C-2 EXPOSURE (32 MPa @28d) CONCRETE SLUMP TO BE COORDINATED BETWEEN CONTRACTOR AND CONCRETE SUPPLIER CONSIDERING THE PERFORMANCE

EXPOSUR		
		C-XL, C-1, C-3,
Ν	F-1, F-2, S-1, S-2	A-1, A-2, A-3
-	75mm	75mm
30mm	40mm	60mm
20mm	40mm	60mm

TOP STEEL IN GRADE BEAMS TO BE SPLICED AT CENTER SPAN AND BOTTOM STEEL TO BE SPLICED OVER SUPPORTS.

A. TENSION ZONE SPLICE TO BE AVOIDED WHEREVER POSSIBLE, BUT IF REQUIRED, LENGTH SHOULD BE

# FOUNDATION DESIGN FOR HAS BEEN DONE IN ACCORDANCE WITH GEOTECHINCAL REPORT AS PREPARED BY TREK

CONTRACTOR SHALL OBTAIN AND FAMILIARIZE THEMSELVES WITH THE REQUIREMENTS OF THE GEOTECHNICAL REPORT SPECIFICALLY, REPORT PROVIDES INFORMATION ABOUT THE POTENTIAL PRESENCE OF OLD FOUNDATIONS / RUBBLE IN THE GENERAL PROJECT AREA AND THE NEED FOR THE USE OF STEEL SLEEVES DURING PILE INSTALLATION








# **GENERAL NOTES - PAGE 2**

Project number	20-104
Date	2021-03-04
Drawn by	DP
Checked by	DP

# S002

Scale 1:100

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# **SWP PROJECTS LTD.** 678 MAIN STREET - 2ND FLR WINNIPEG, MB R3B 1E4
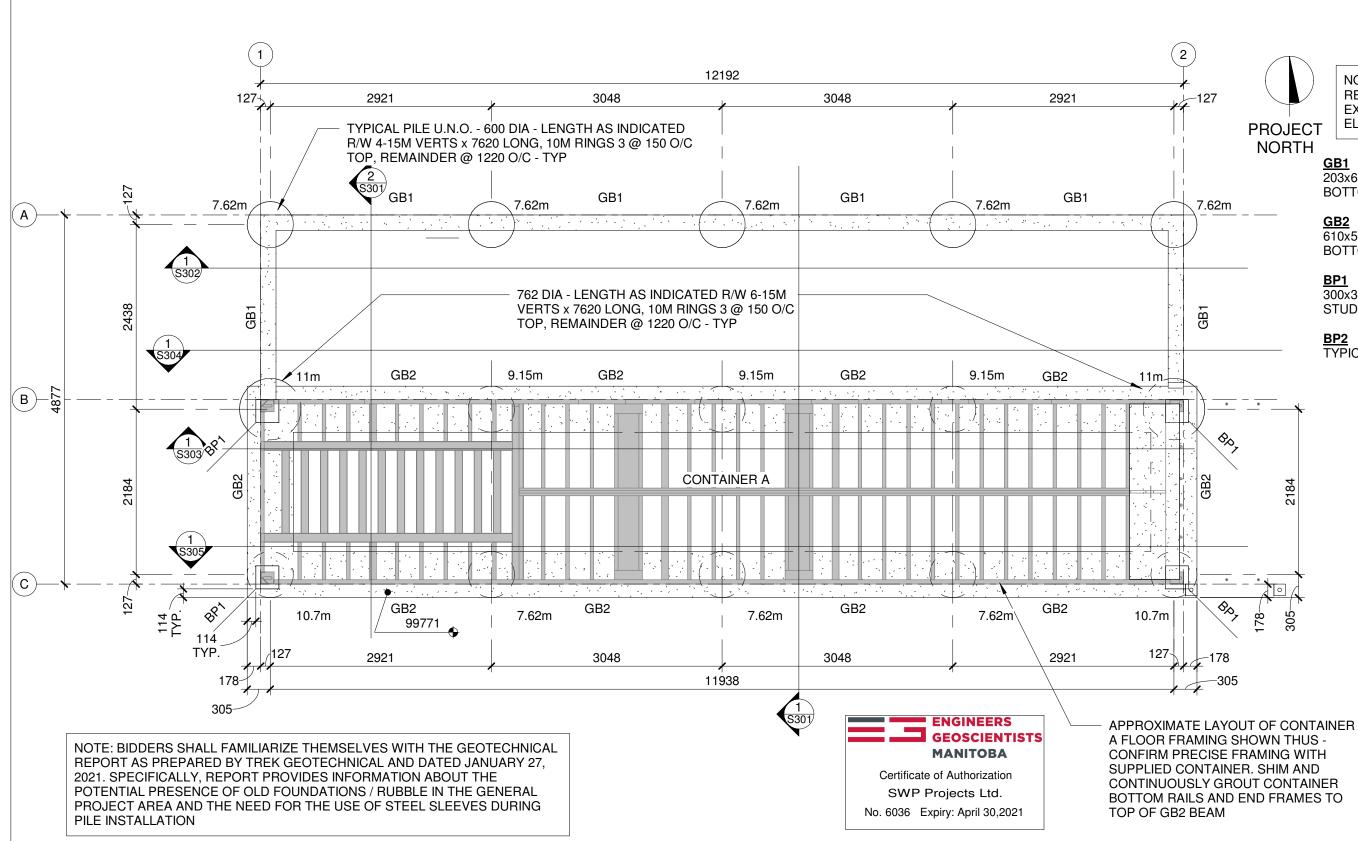
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715 MAIN STREET PUBL		TOILET
THE CITY OF WINNIPEG	No.	De

No.	Description	Date
1	ISSUED FOR CONSTRUCTION	21-03-04

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NOTE: **REFER TO SHEET S106 FOR** EXTENT OF SITE CONCRETE ELEMENTS

203x610 R/W 2-15M TOP AND BOTTOM, 10M STIRRUPS @ 3000/C

610x530 R/W 4-15M TOP AND BOTTOM, 10M STIRRUPS @ 3000/C

300x300x13 C/W 6-13 DIA NELSON STUDS x 150 LONG

TYPICAL RAILING BASE PLATE




FOUNDATION FRAMING PLAN

Project number	20-104
Date	2021-03-04
Drawn by	DP
Checked by	DP

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# 715 MAIN STREET PUBLIC TOILET

THE CITY OF WINNIPEG

No.	Description	Date
1	ISSUED FOR CONSTRUCTION	21-03-04

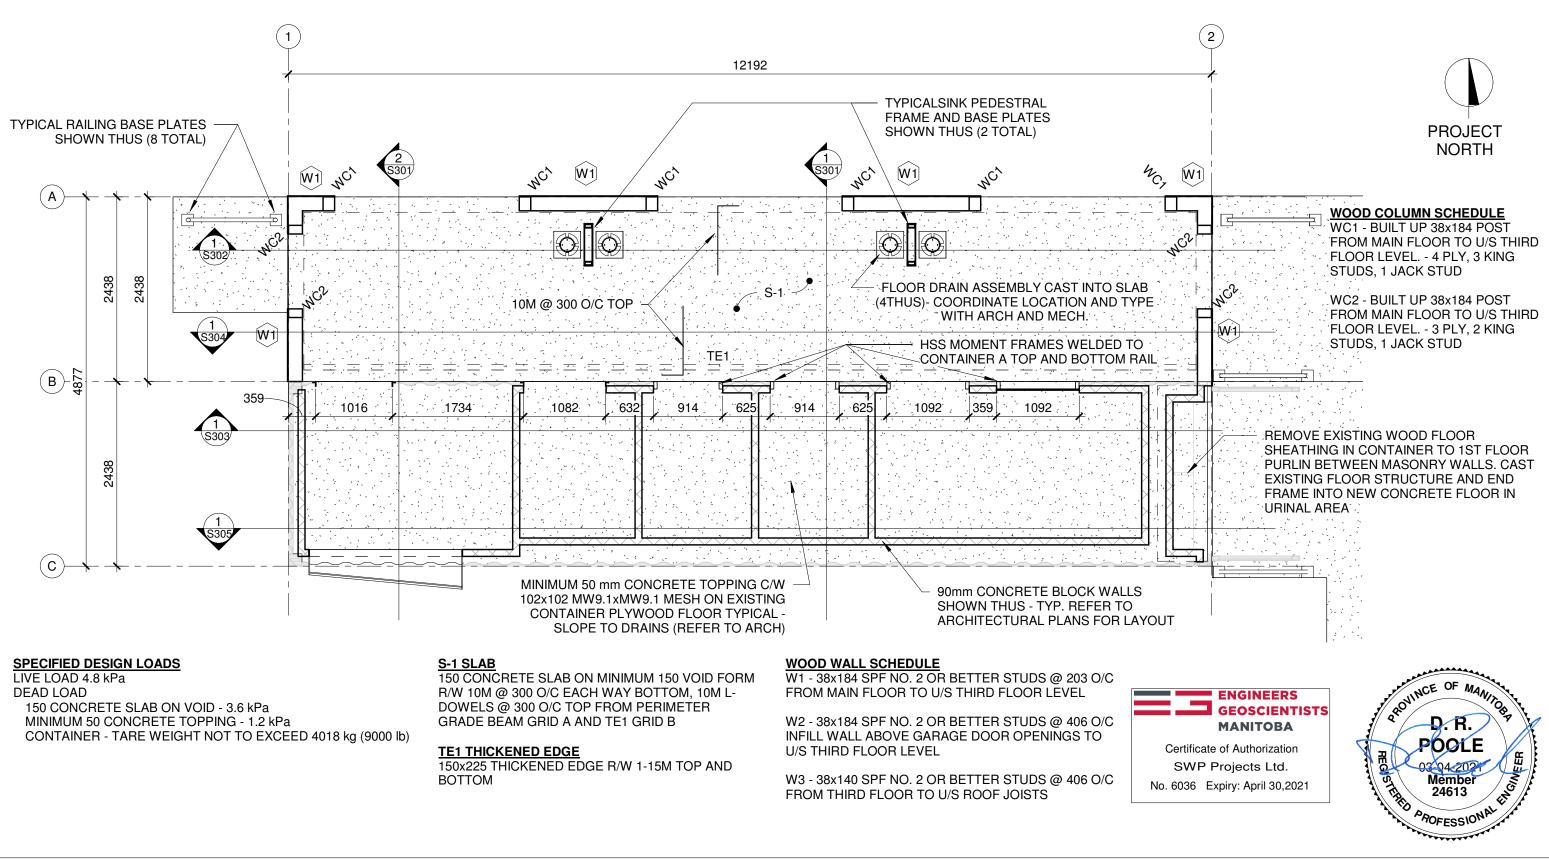**BID OPPORTUNITY 54-2021** 


# MAIN FLOOR FRAMING PLAN

Project number	20-104
Date	2021-03-04
Drawn by	DP
Checked by	DP

S102


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NIPEG, MB R3B 1E4	THE CITY OF WINNIPEG	No.	Description	Date		
		1	ISSUED FOR CONSTRUCTION	21-03-04		
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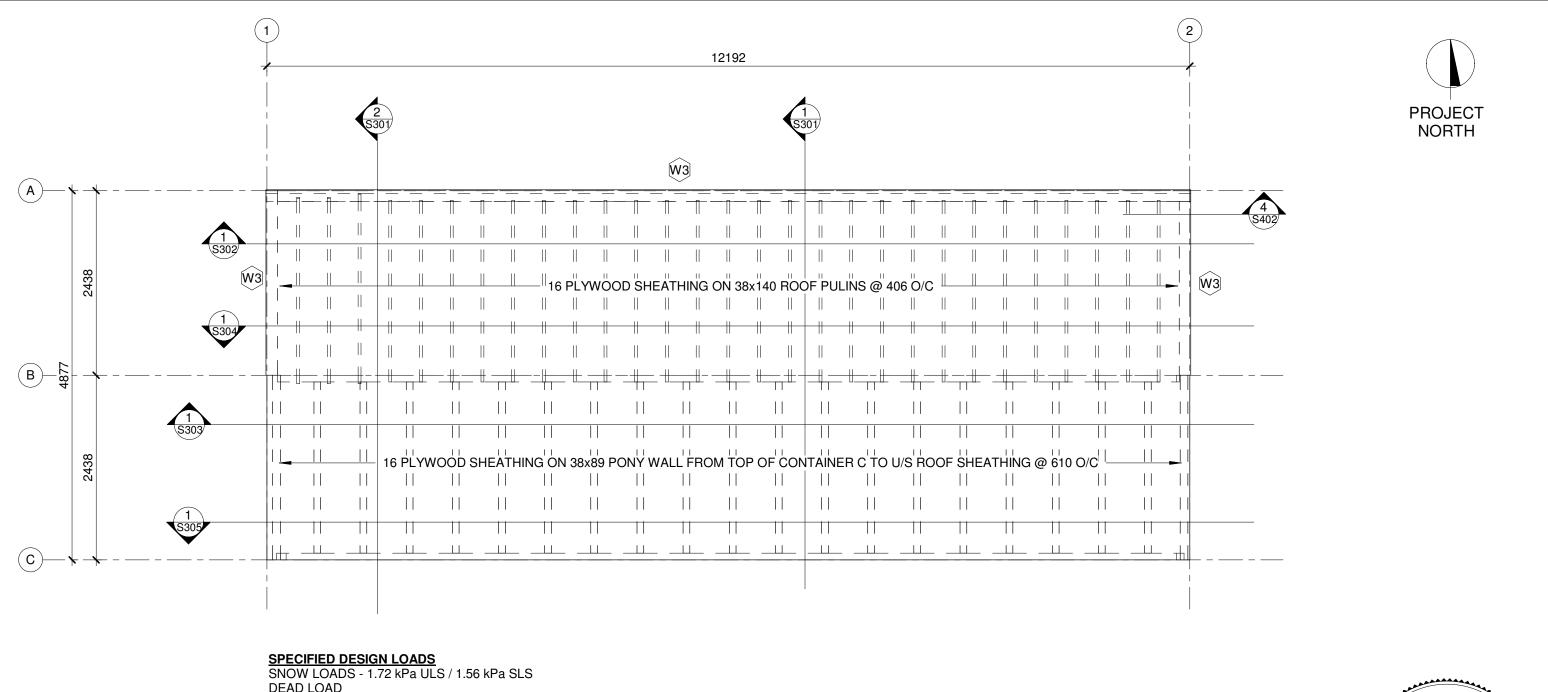
678 MAIN STREET - 2ND FLR WINNI

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20-104 roject number Date 2021-03-04 DP Drawn by Checked by DP
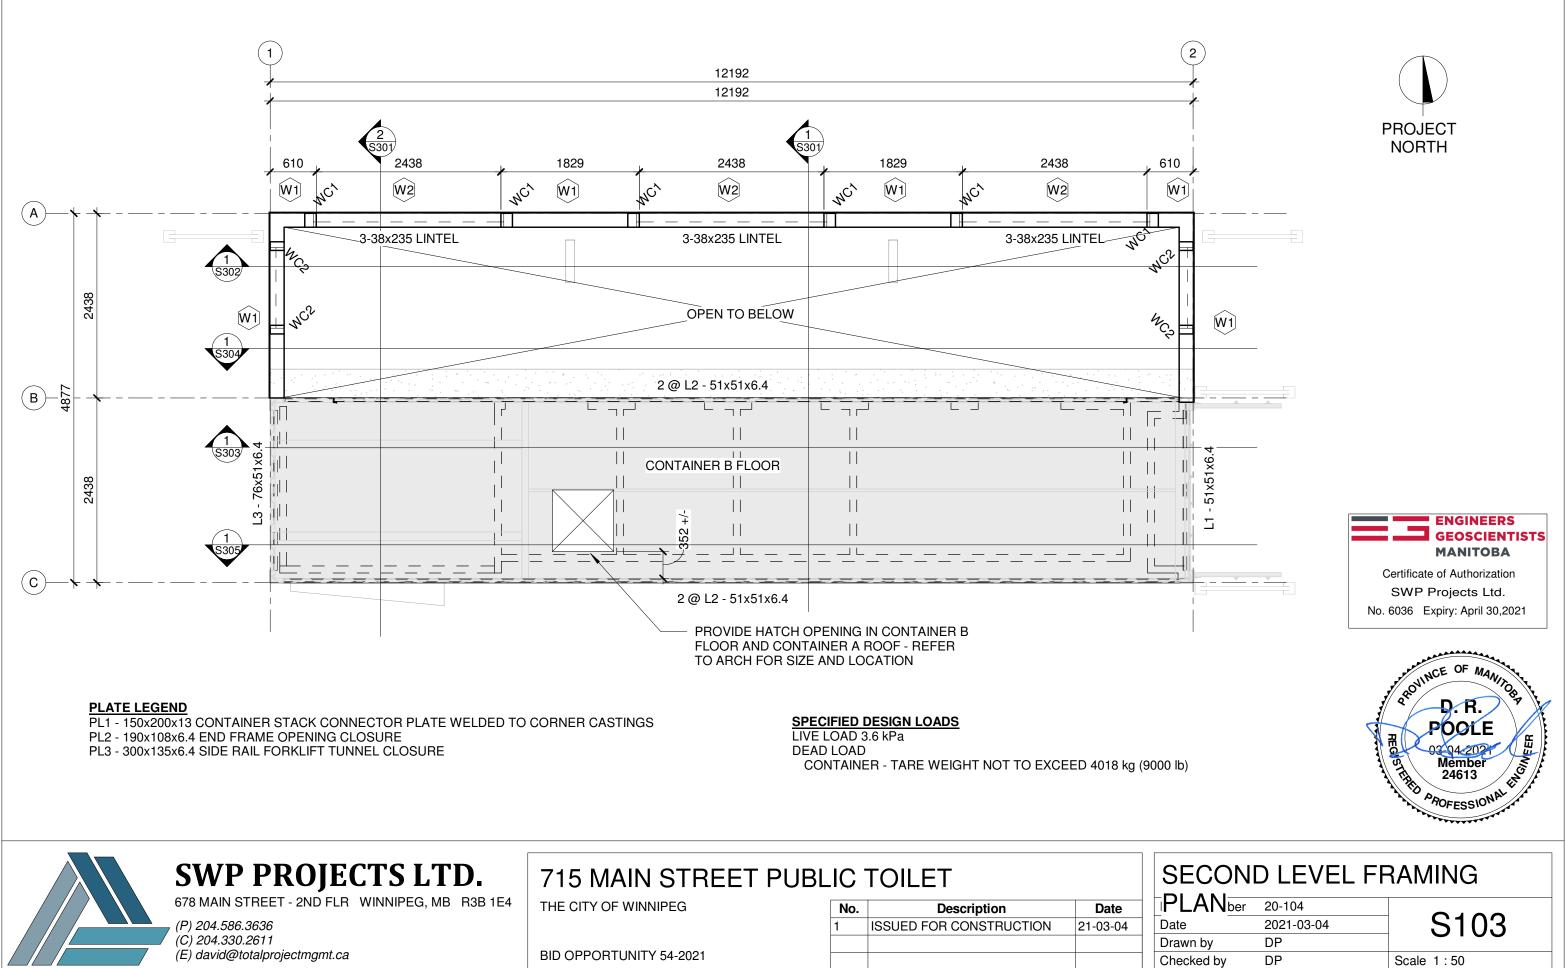
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DEAD LOAD CONTAINER - TARE WEIGHT NOT TO EXCEED 4018 kg (9000 lb) WOOD ROOF SYSTEM - 0.5 kPa



# **SWP PROJECTS LTD.**
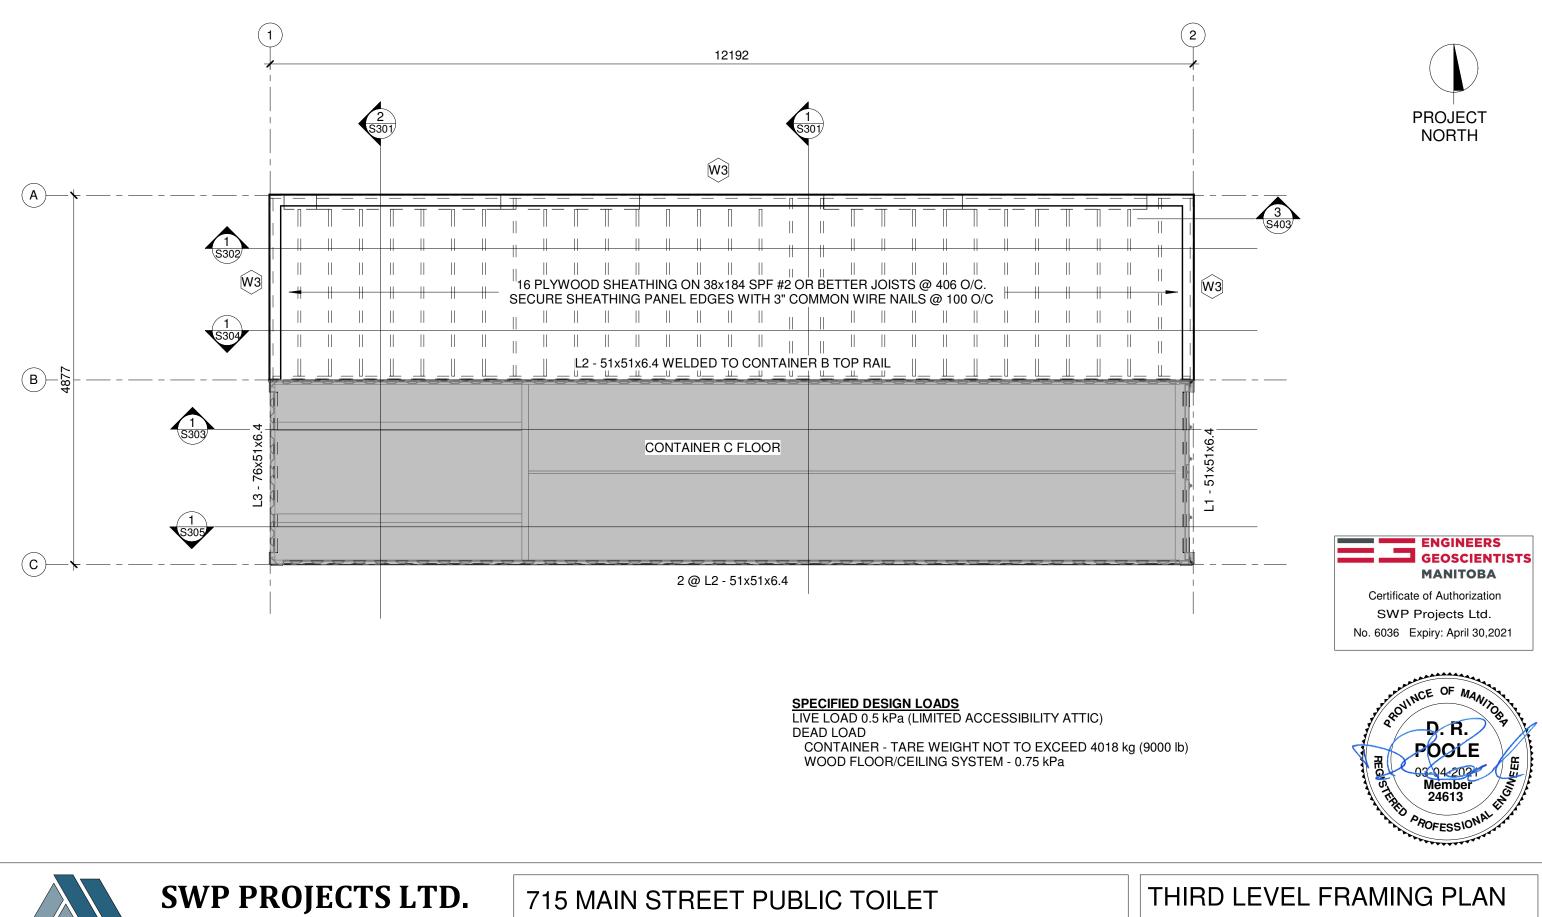
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715 MAIN STREET PUBLIC TOILET			TOILET	
E4	THE CITY OF WINNIPEG	No.	Description	Date

**BID OPPORTUNITY 54-2021** 




# **ROOF FRAMING PLAN**

Project number	20-104
Date	2021-03-04
Drawn by	Author
Checked by	Checker

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# THE CITY OF WINNIPEG

715 MAIN STREET PUBLIC TOILET No. Description Date ISSUED FOR CONSTRUCTION 21-03-04

**BID OPPORTUNITY 54-2021** 

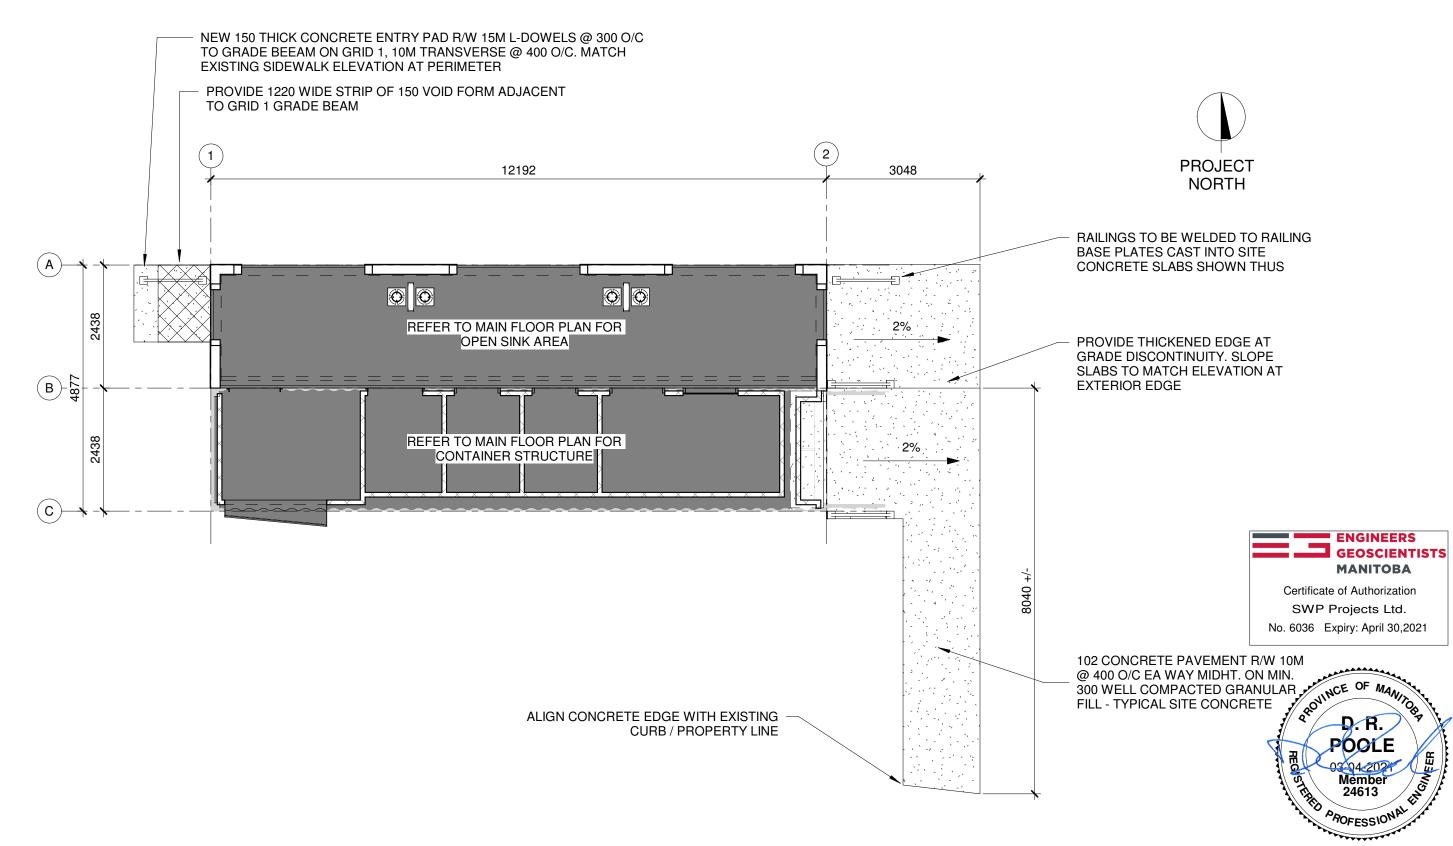





# SITE CONCRETE PLAN

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Date	2021-03-04
Drawn by	DP
Checked by	DP

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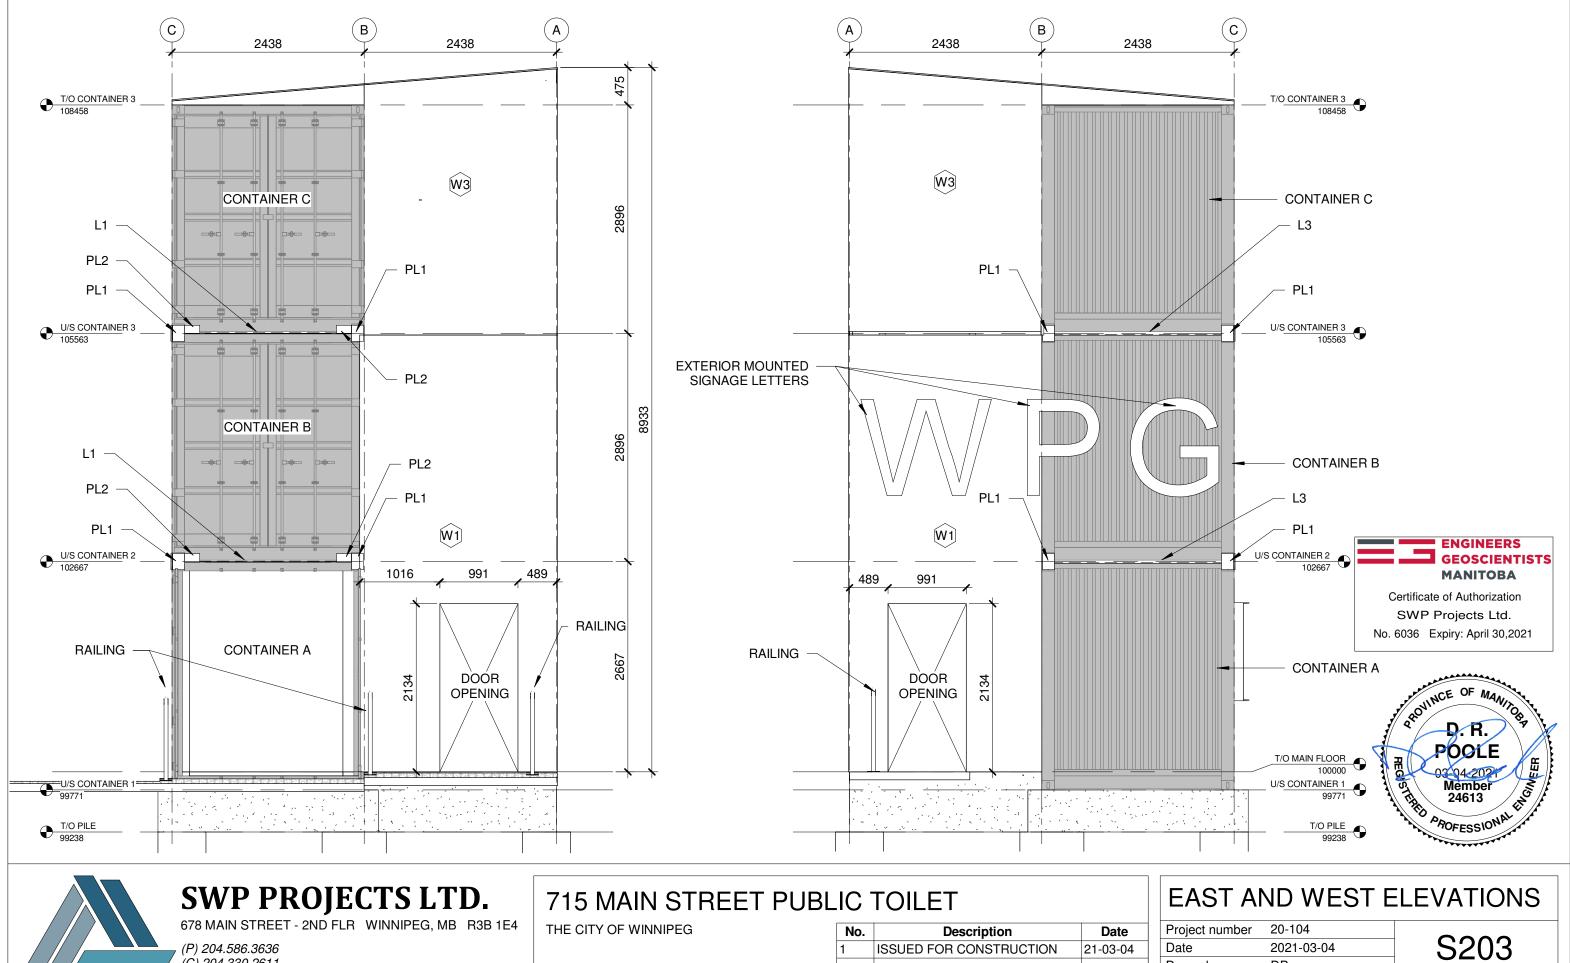
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Project number	20-104	
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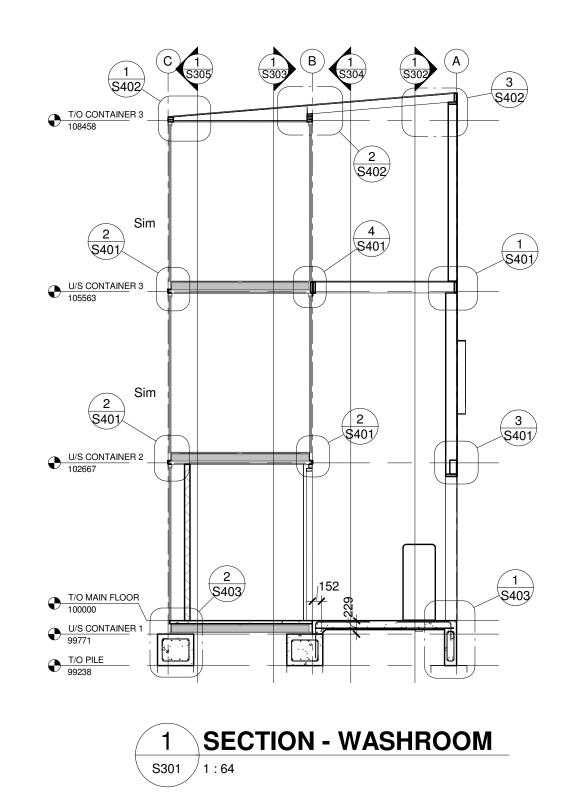
**BID OPPORTUNITY 54-2021** 


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Project number	20-104		
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(E) david@totalprojectmgmt.ca
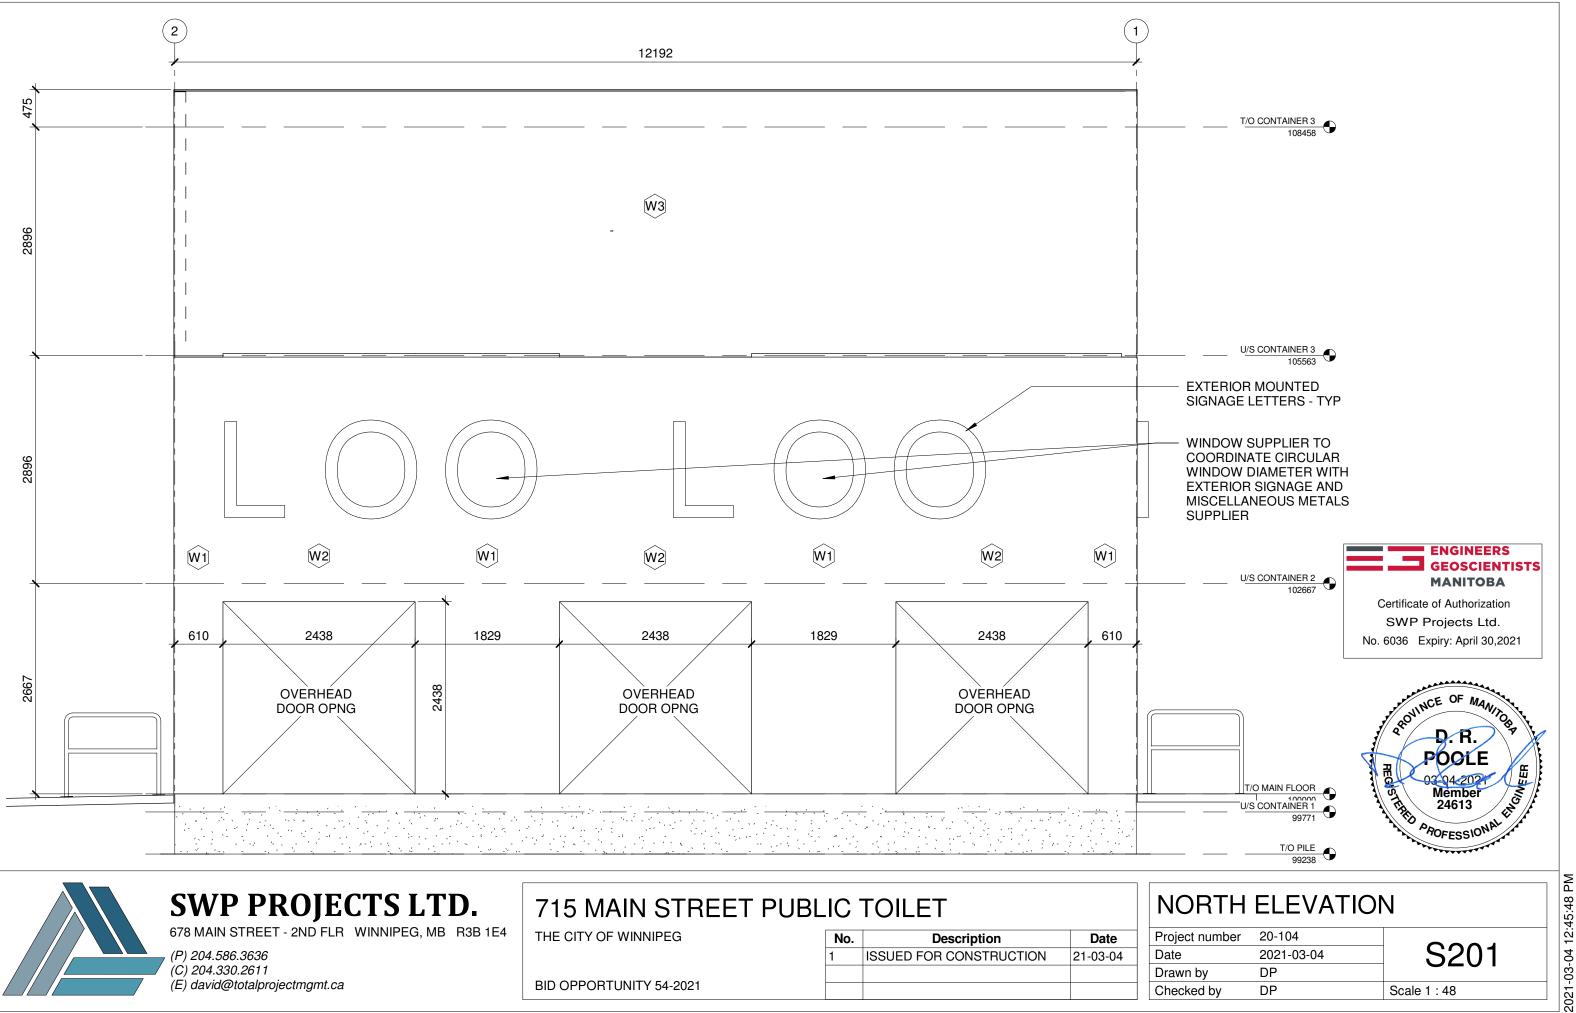
# 715 MAIN STREET PUBLIC TOILET

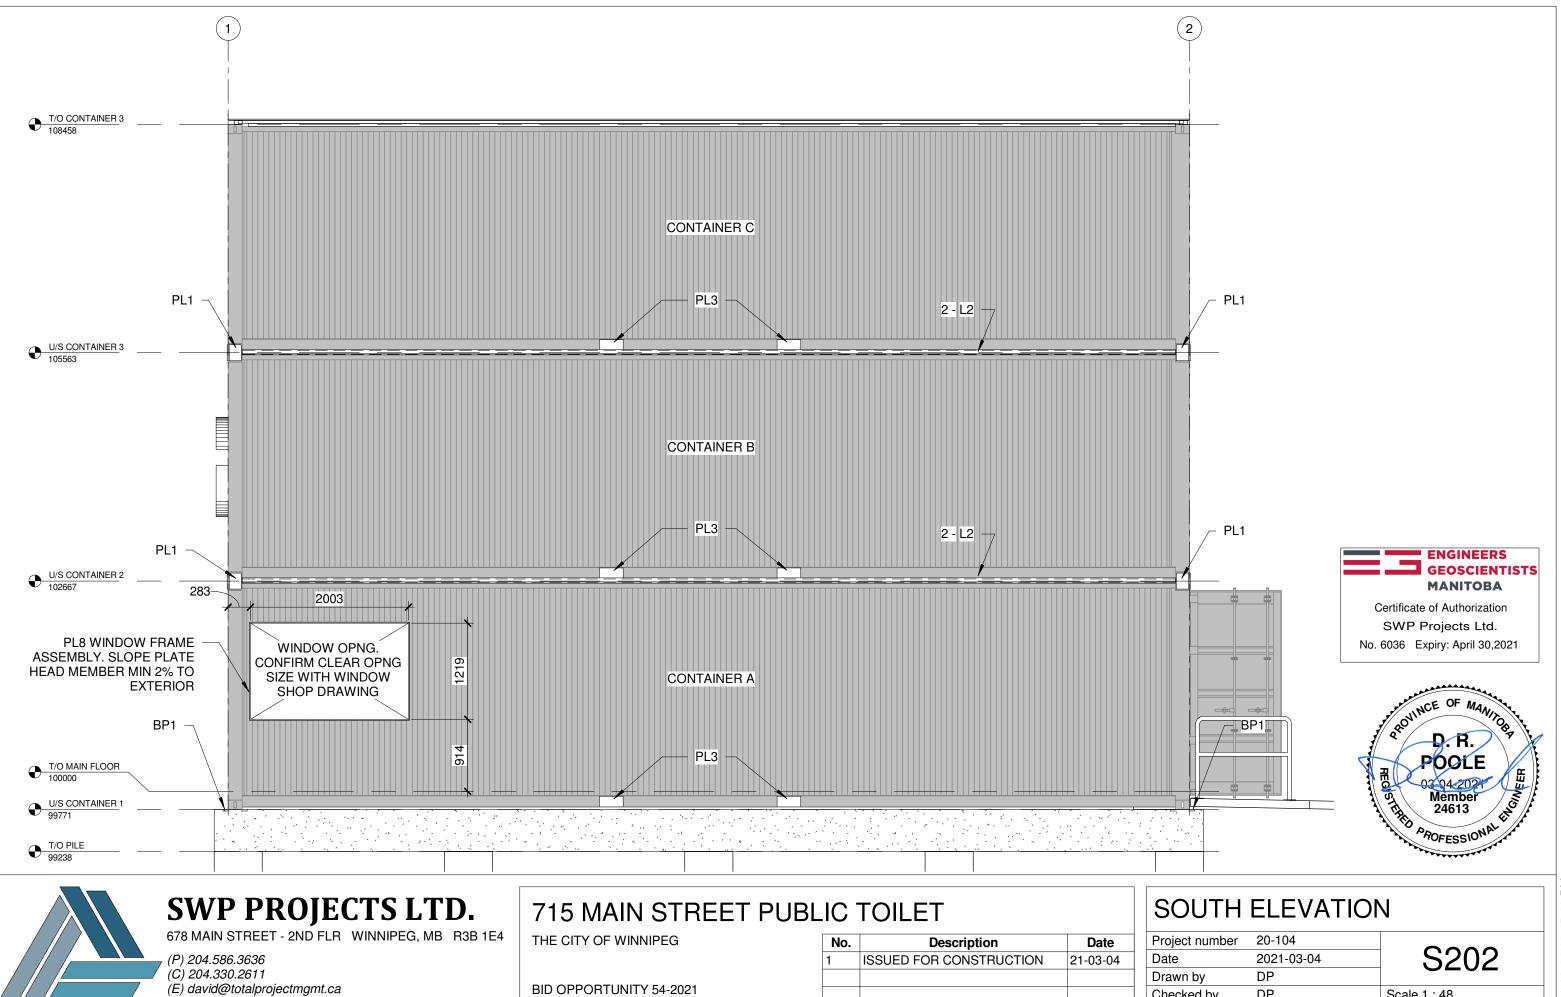
THE CITY OF WINNIPEG

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**BID OPPORTUNITY 54-2021** 

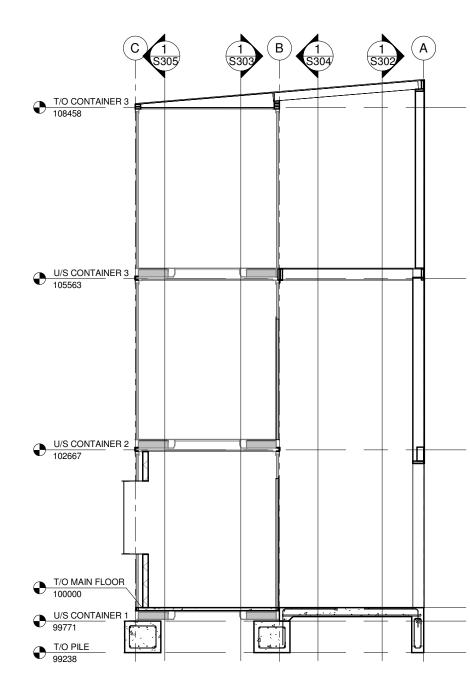

Certificate of Authorization SWP Projects Ltd. No. 6036 Expiry: April 30,2021

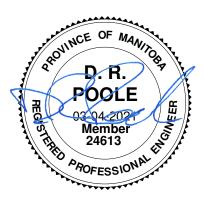


# **BUILDING SECTIONS**

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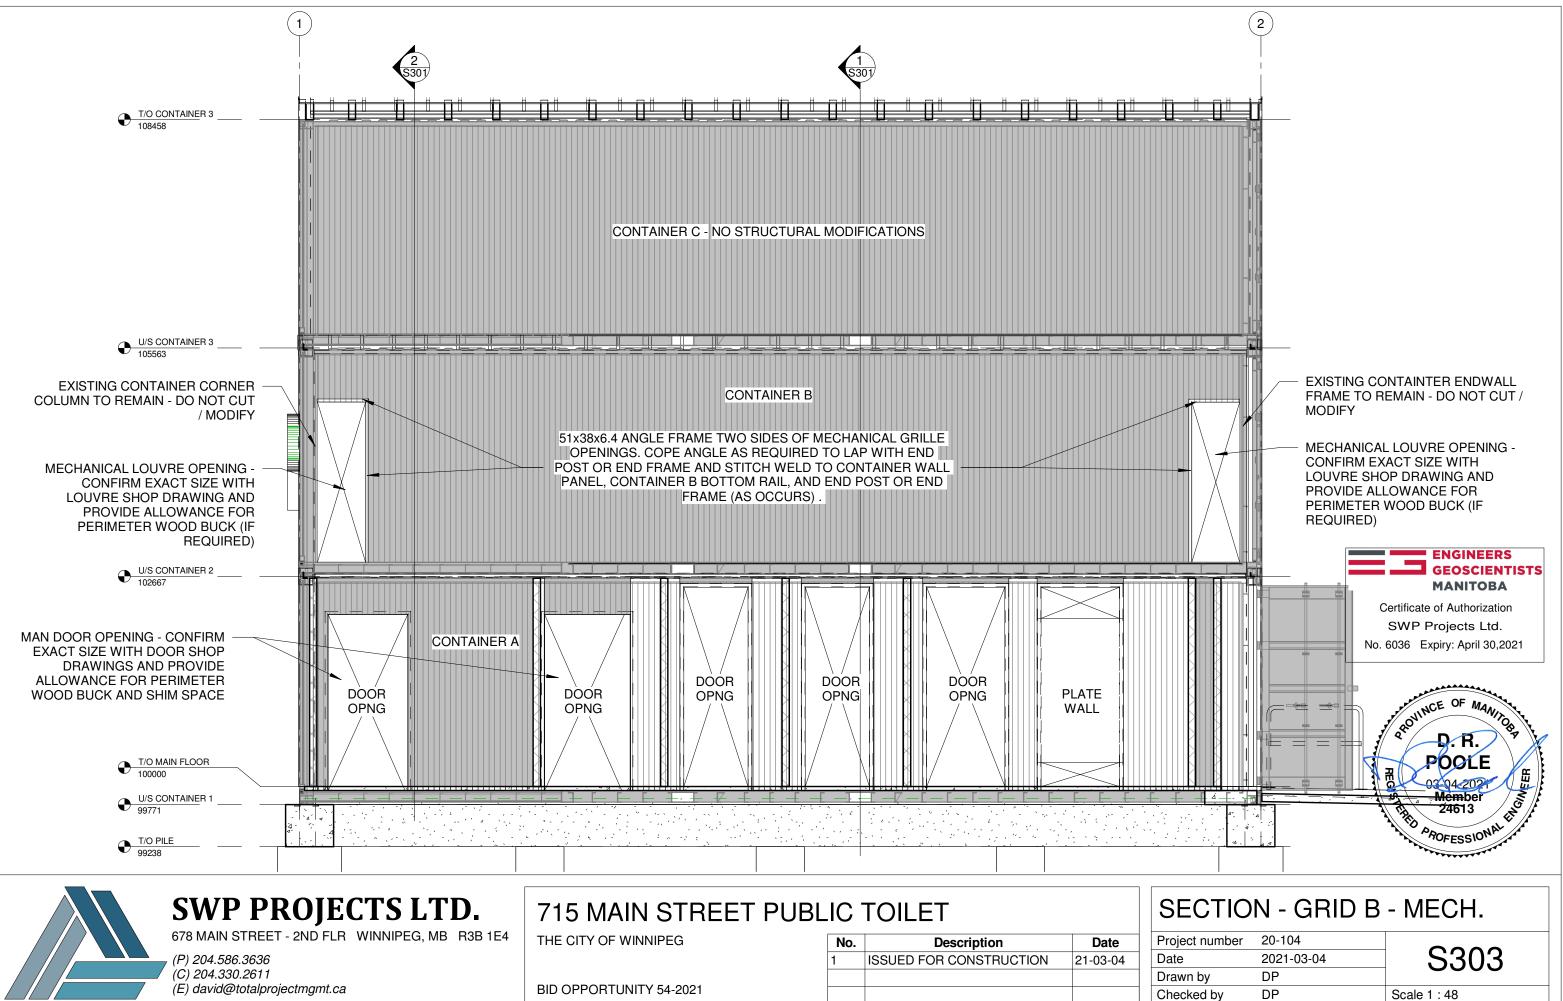
S301

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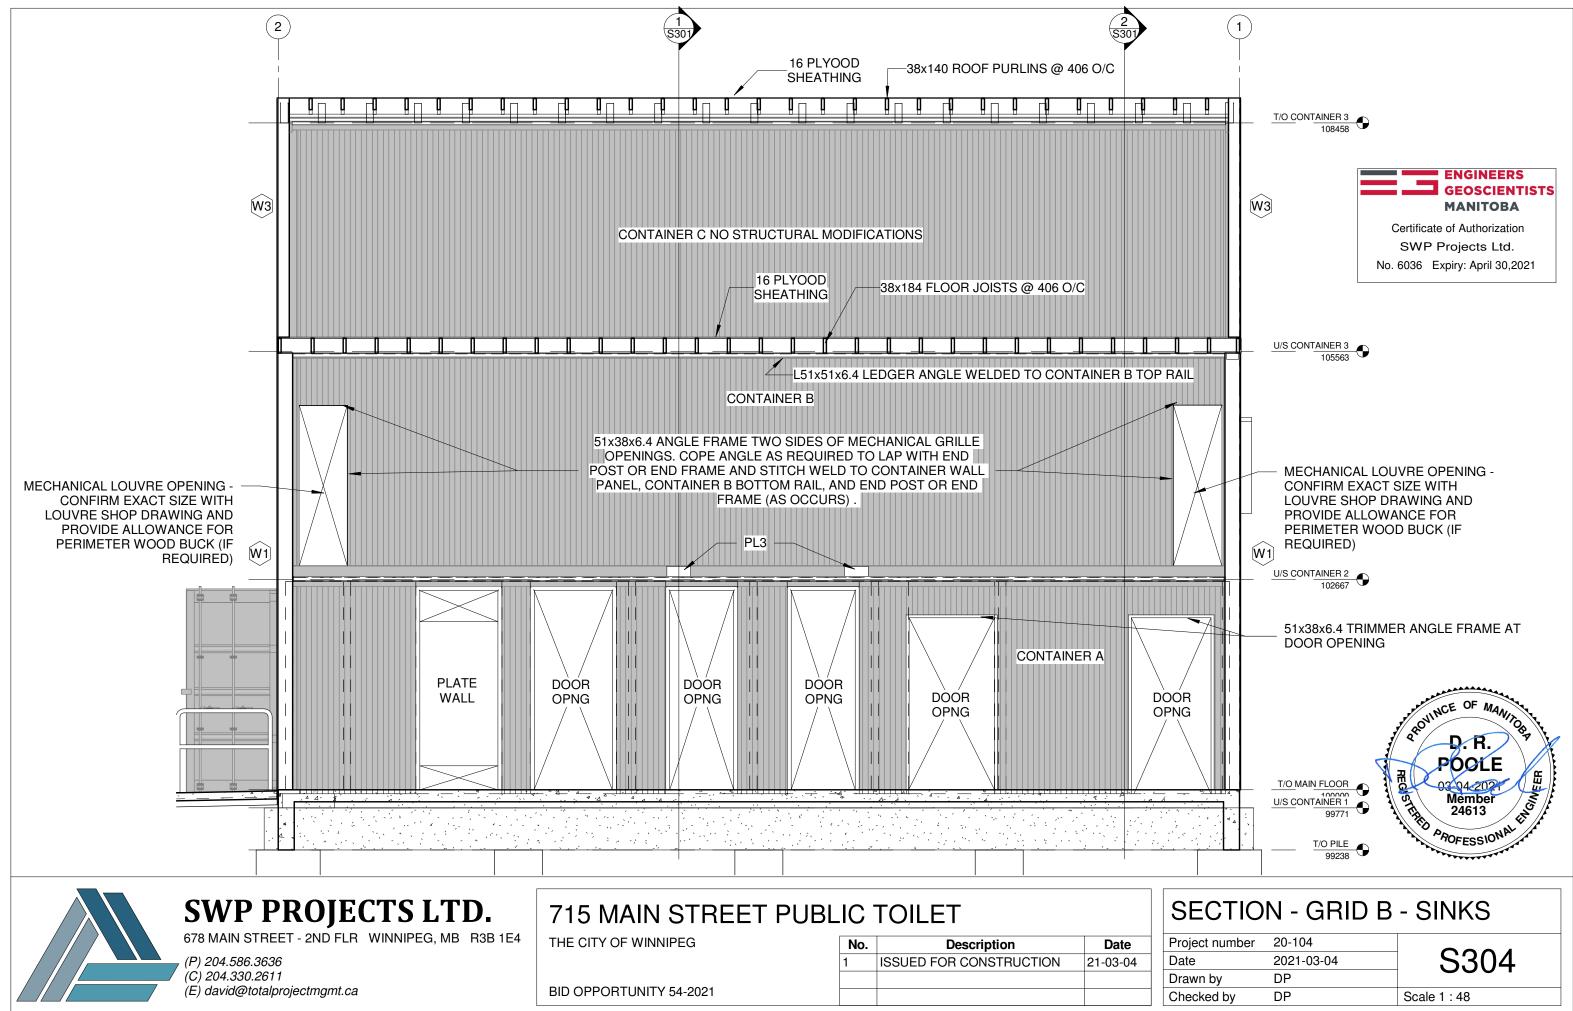
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Date	2021-03-04	S30
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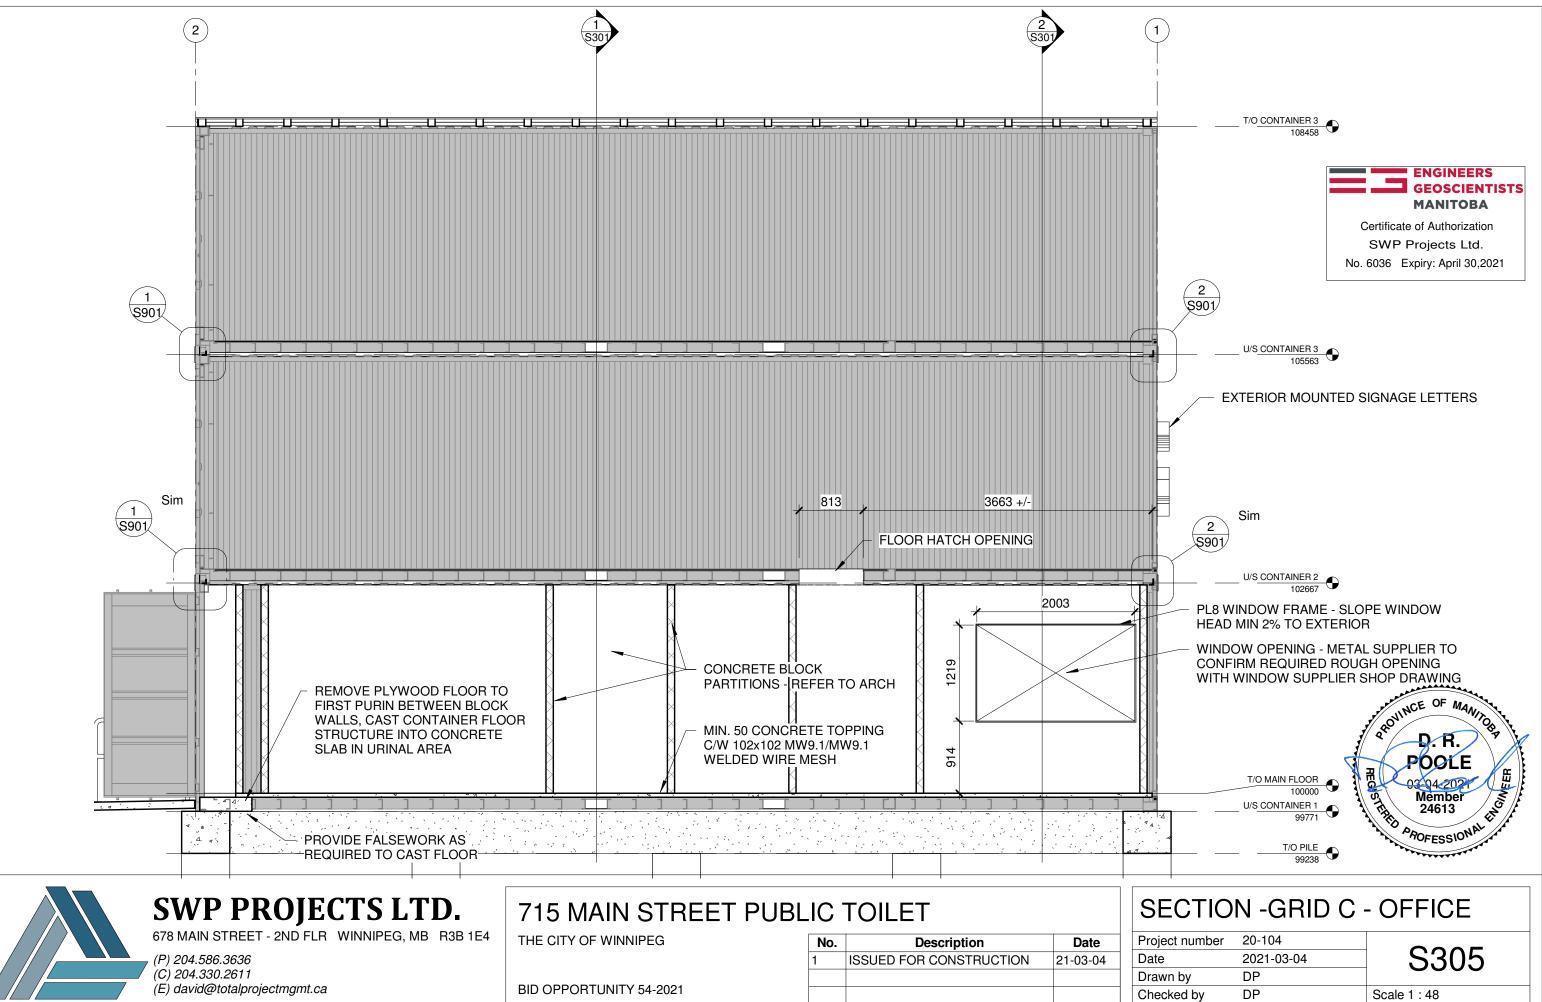
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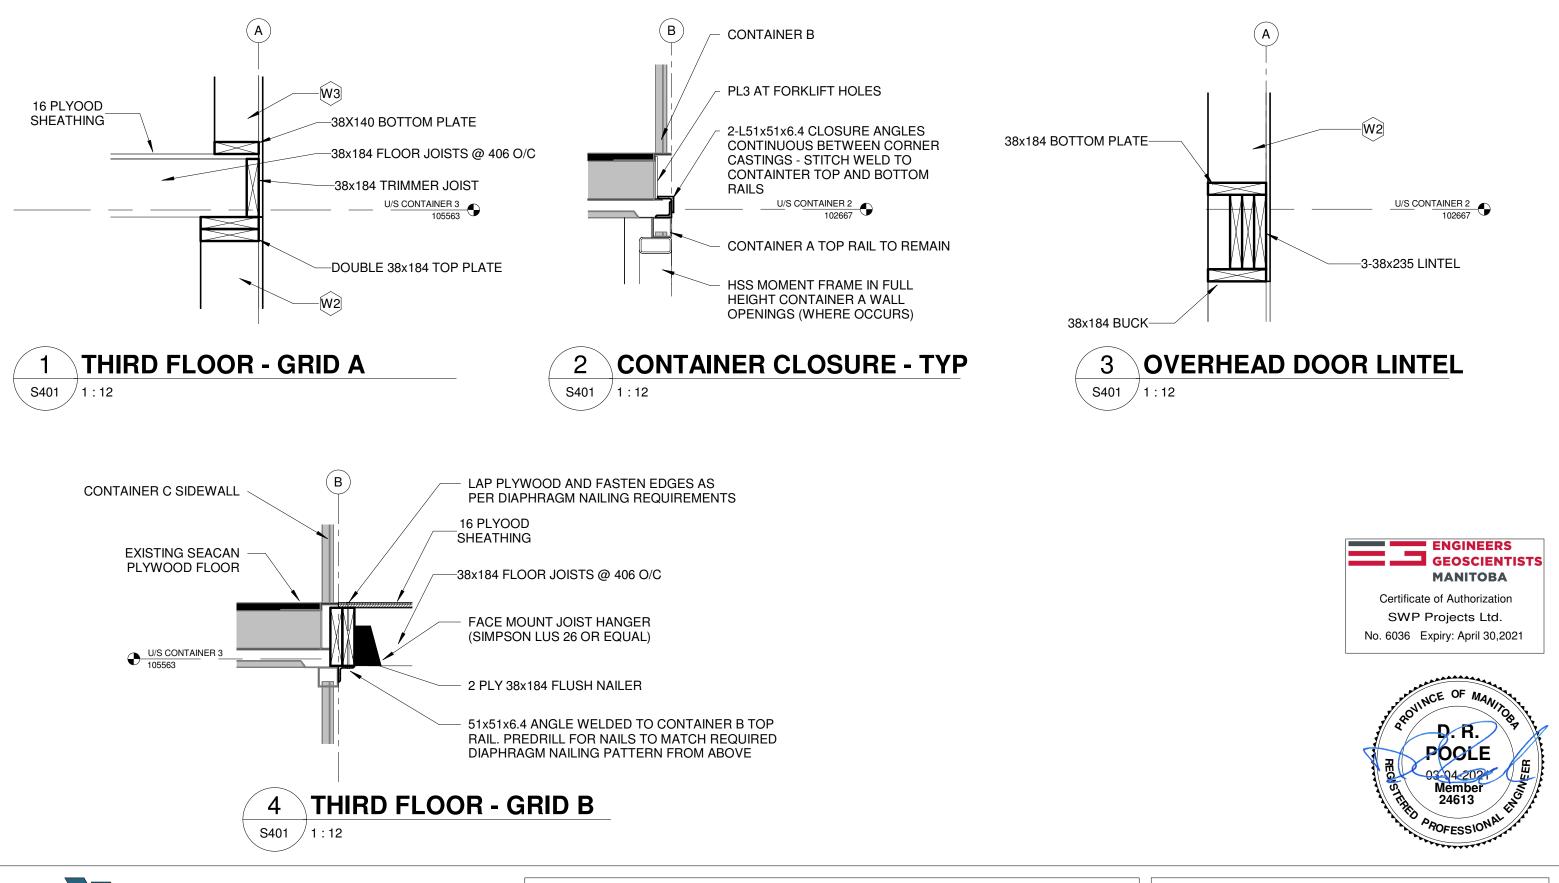


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THE CITY OF WINNIPEG

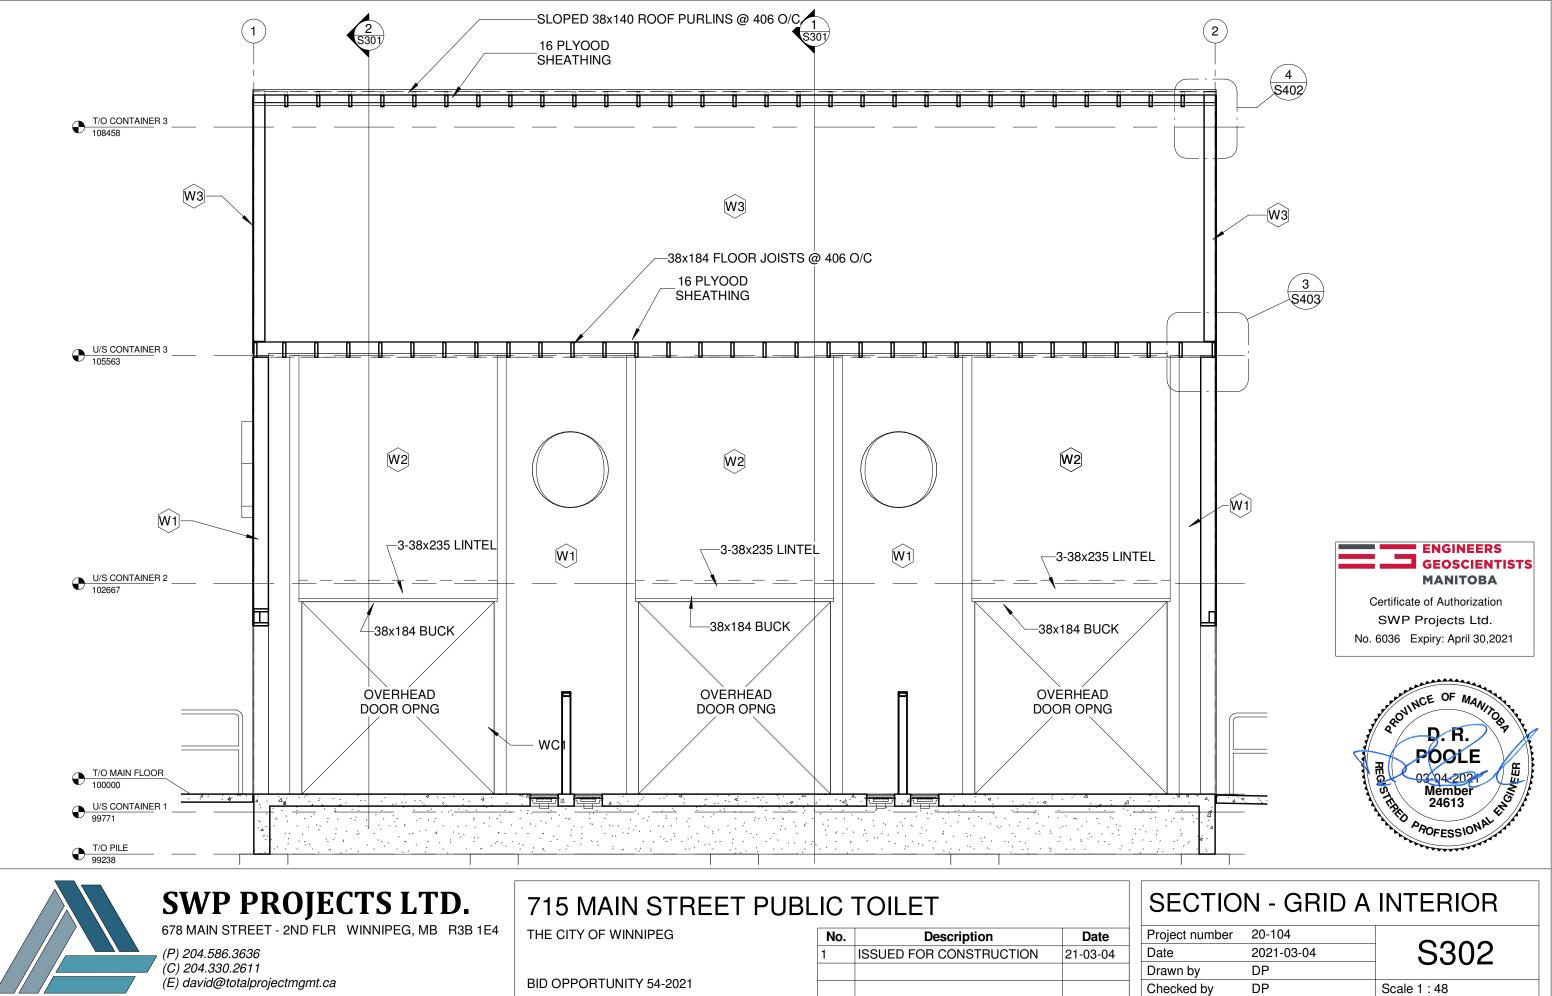No.	Description	Date
1	ISSUED FOR CONSTRUCTION	21-03-04

**BID OPPORTUNITY 54-2021** 


# SECTIONS AND DETAILS

20-104 Project number Date 2021-03-04 DP Drawn by Checked by DP


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PIECES SECURED TO CONTAINER TOP RAIL WITH POWDER




# SECTIONS AND DETAILS
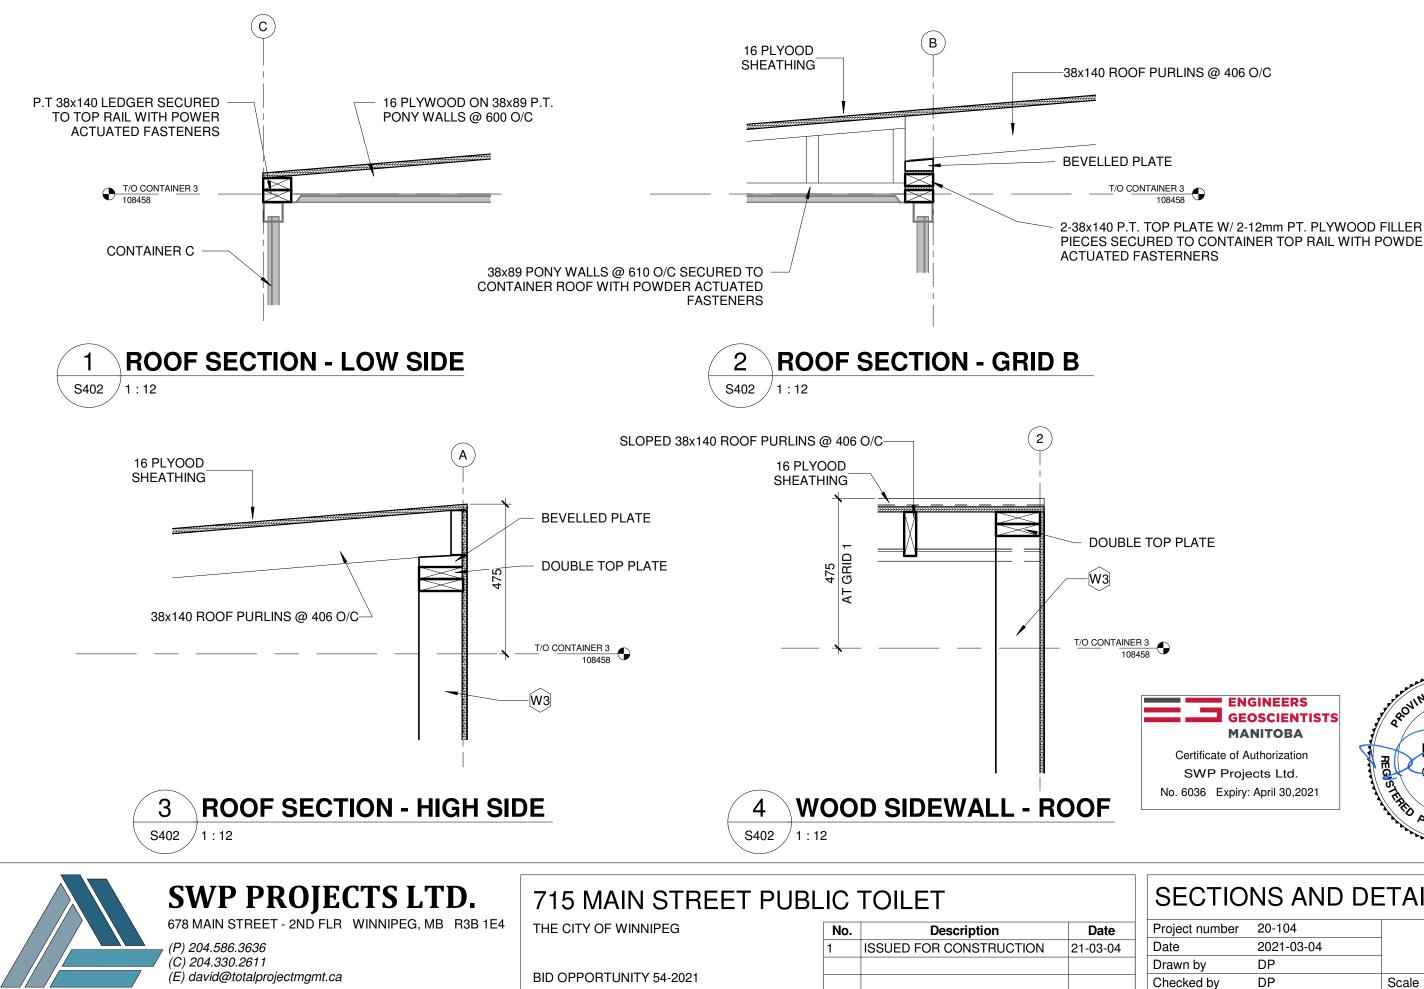
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Date	2021
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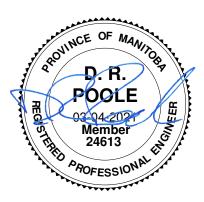
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2ND FLR WINNIPEG, MB R3B 1E4	THE CITY OF WINNIPEG	No.	Description	Date	Project
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678 MAIN STREET -

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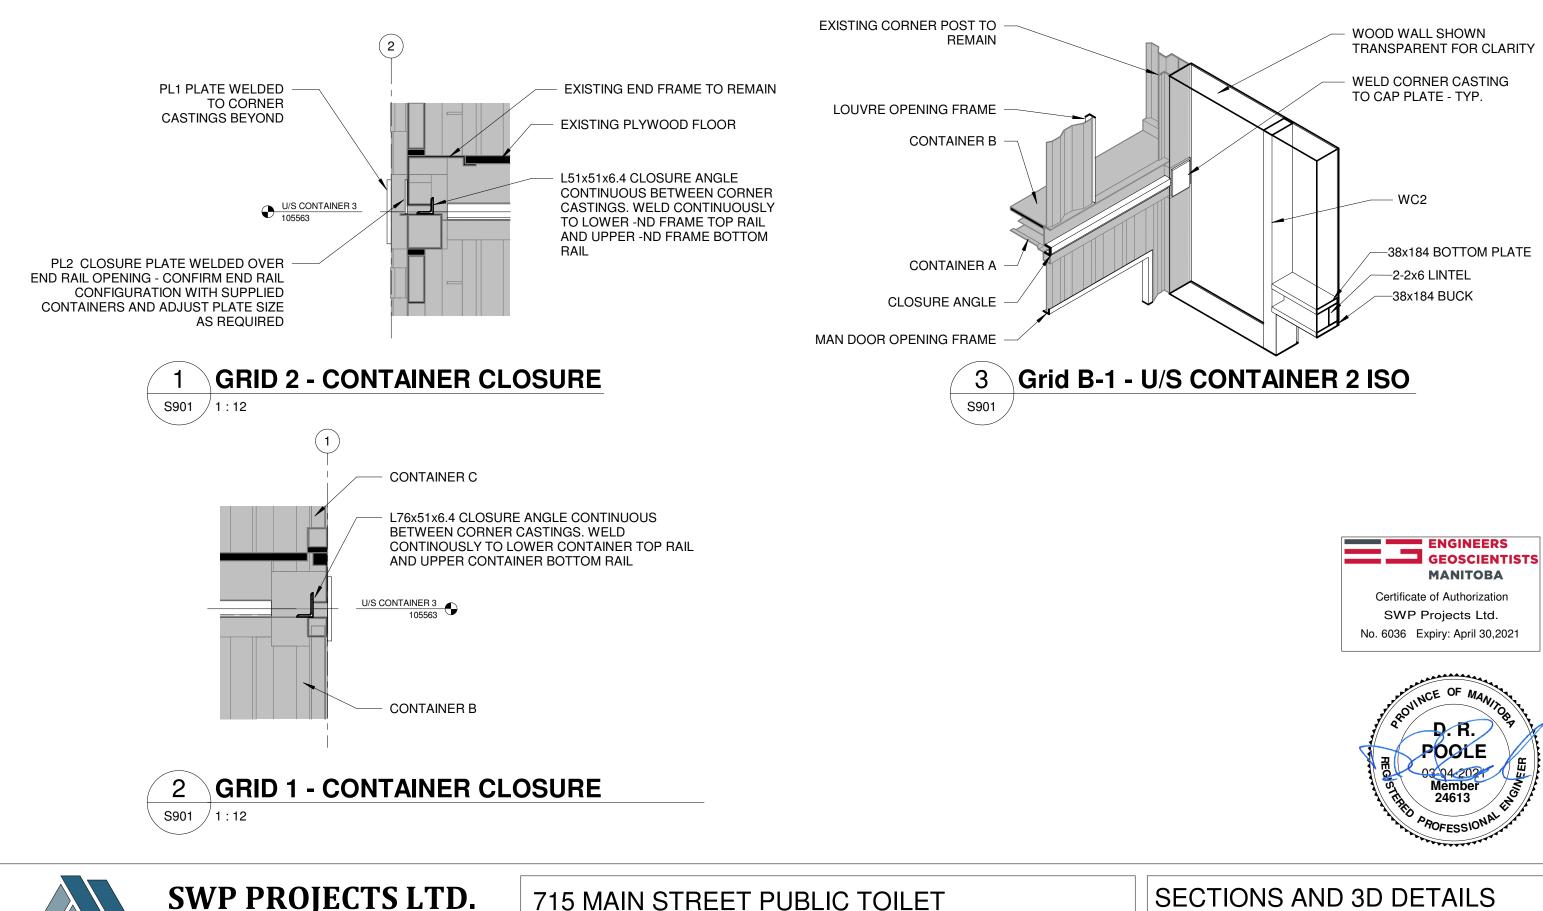
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# **PROJECTS LTD.**

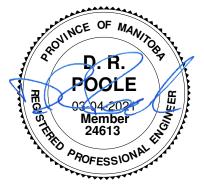IN STREET - 2ND FLR WINNIPEG, MB R3B 1E4

586.3636 330.2611 (É) david@totalprojectmgmt.ca
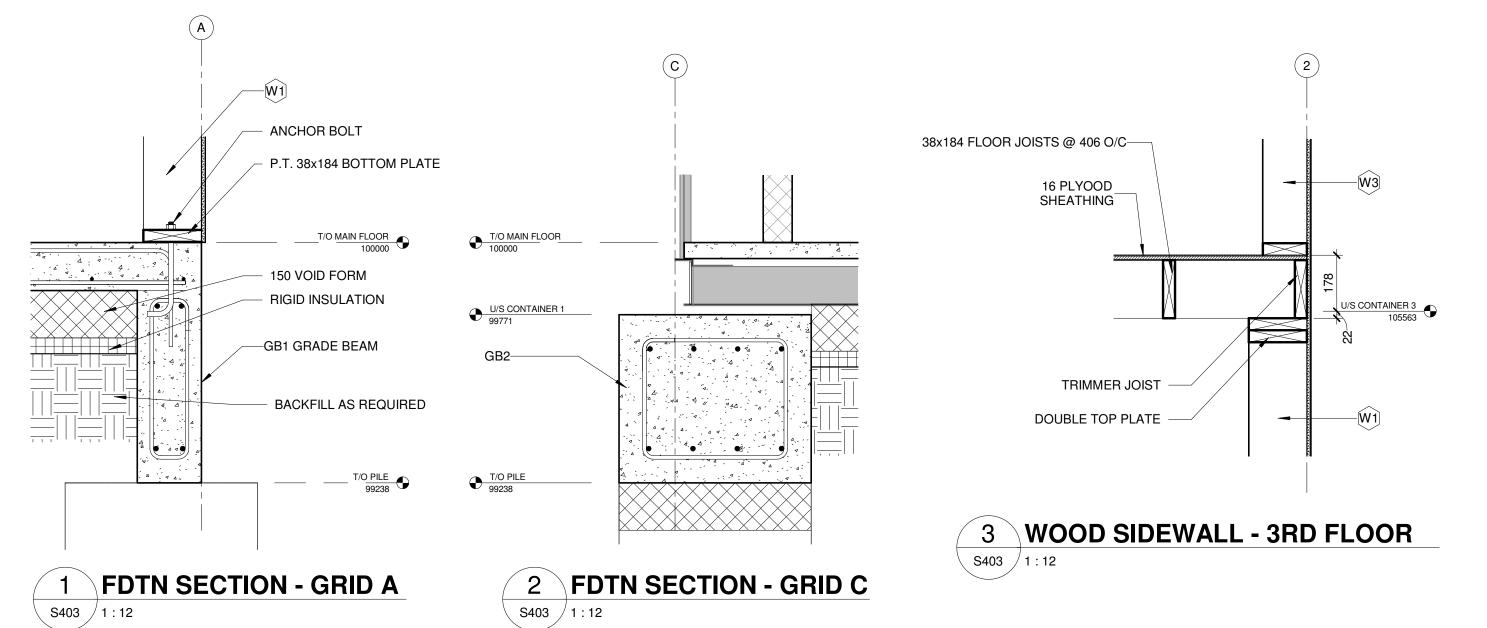
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THE CITY OF WINNIPEG


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**BID OPPORTUNITY 54-2021** 

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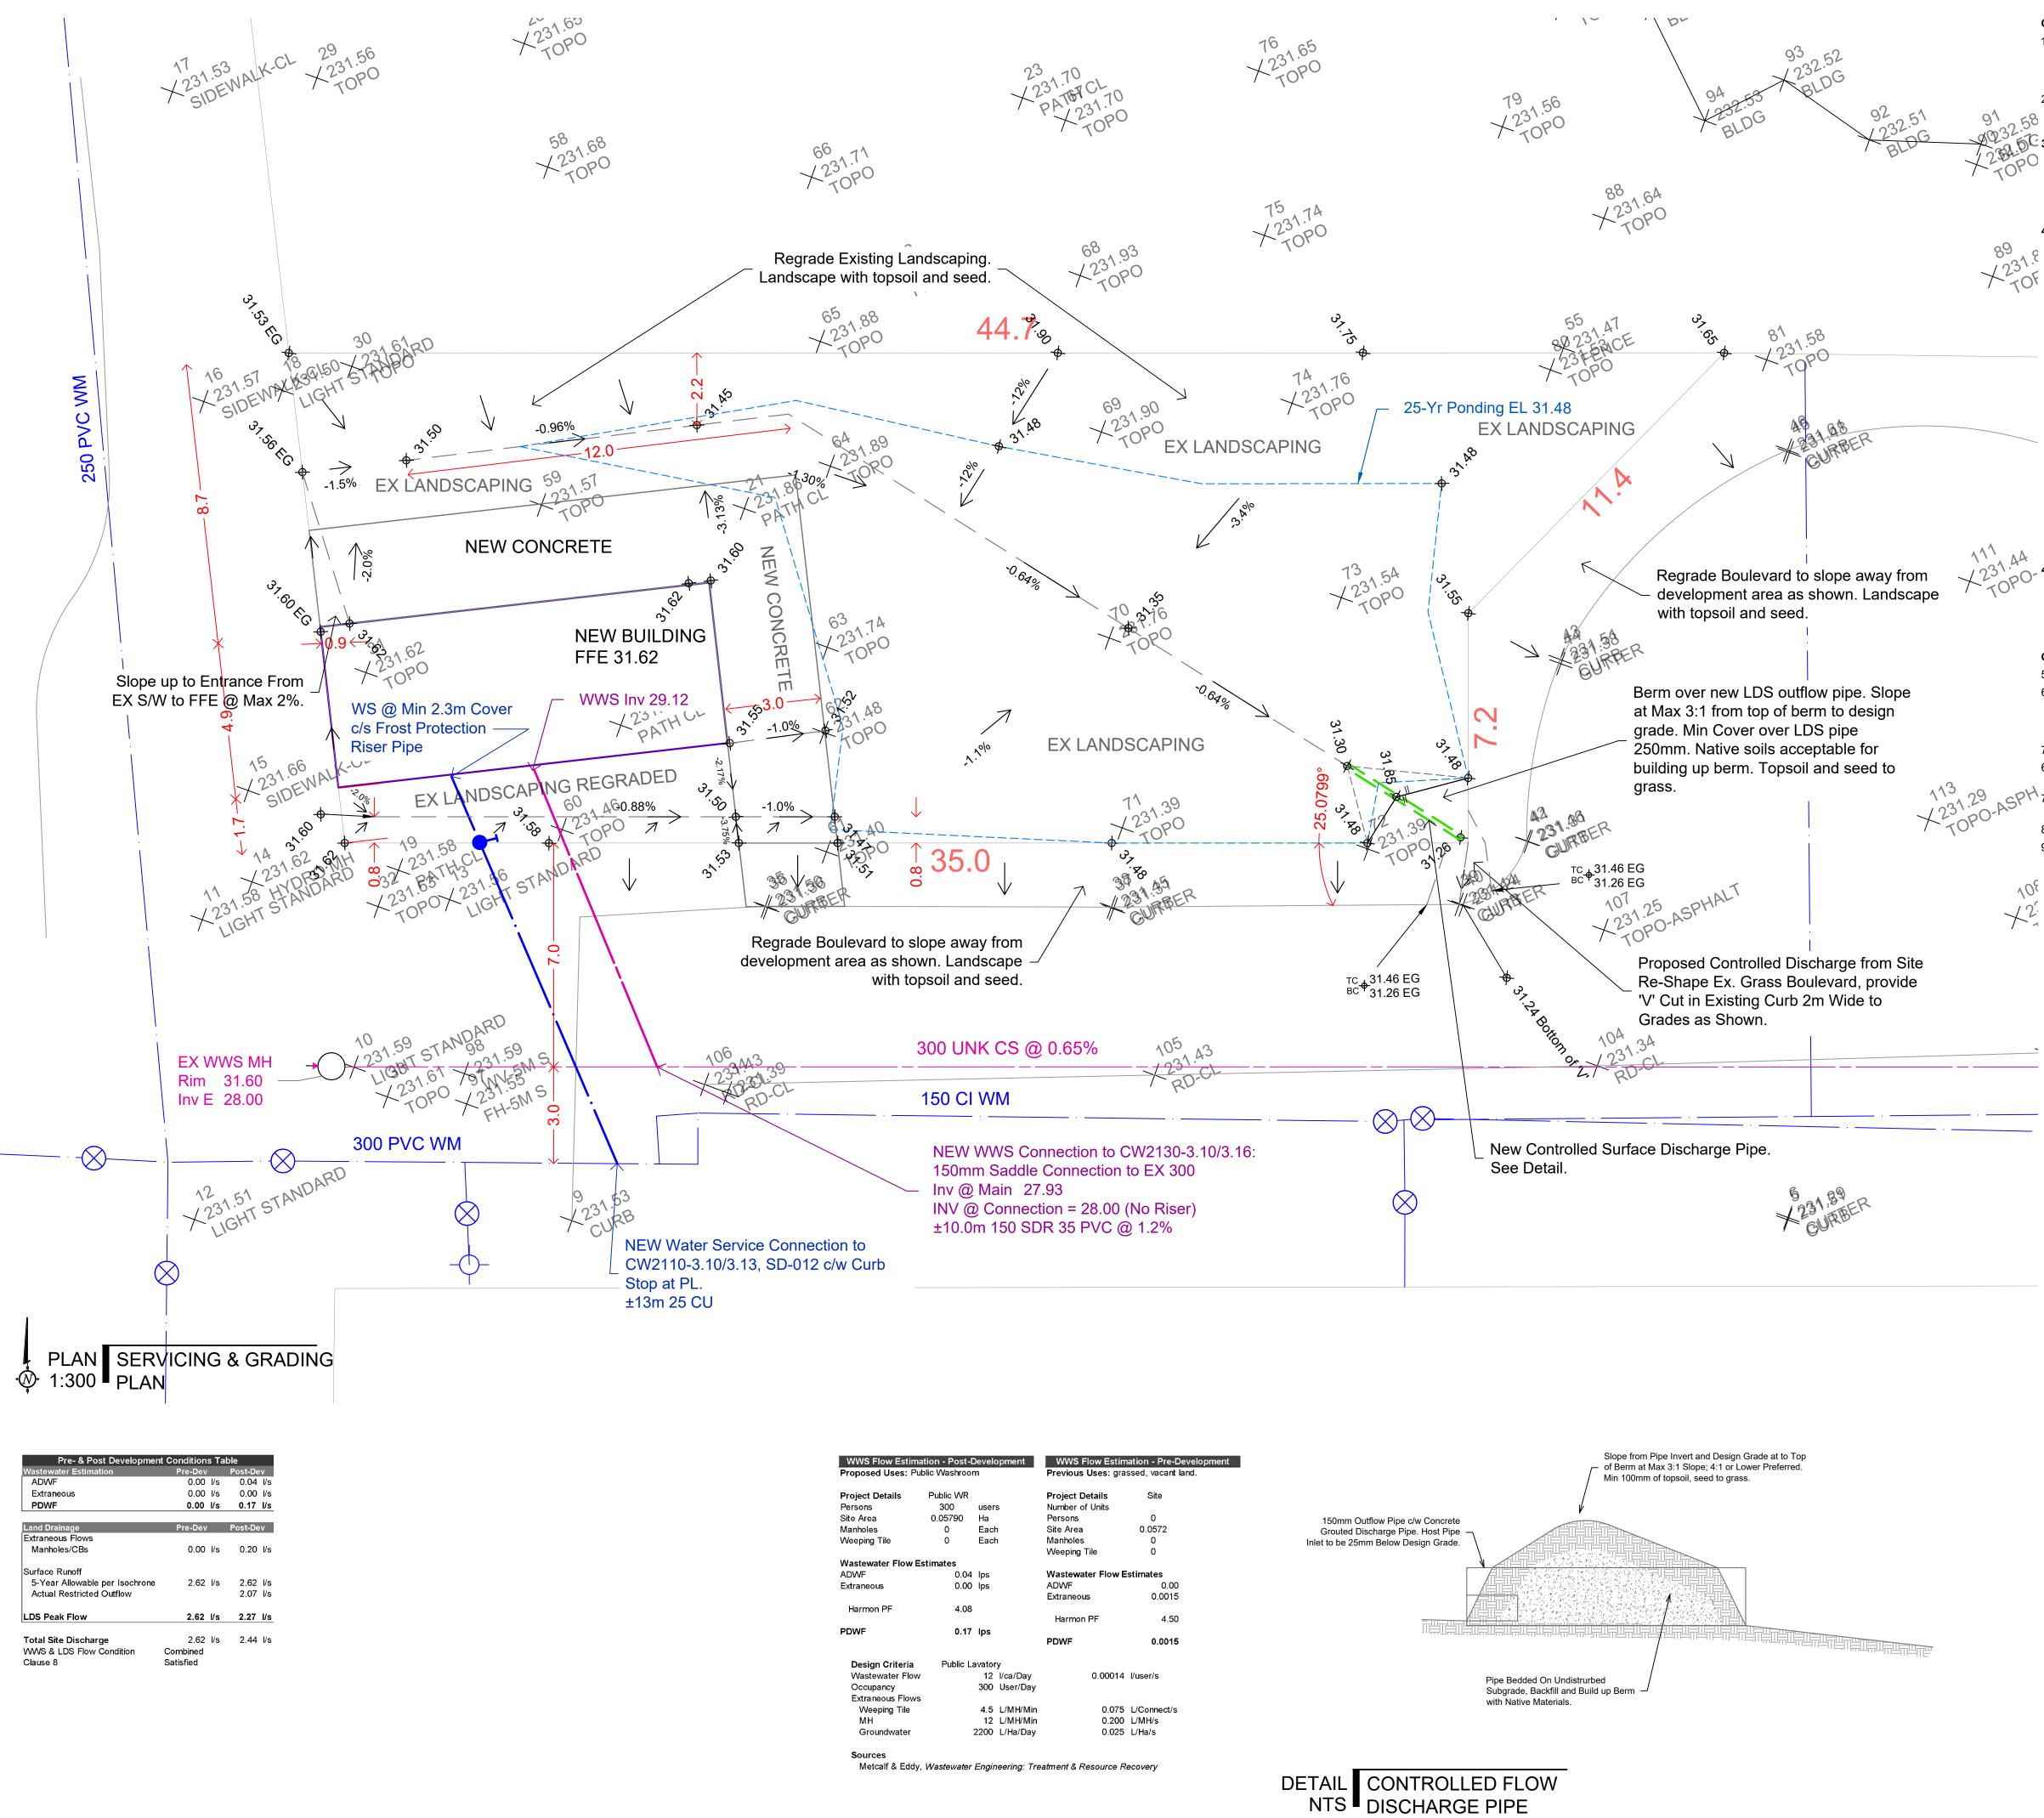
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Project number	20-104	
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dave@sbxconsulting.ca sbxconsulting.ca +1.204.823.1738

# **Construction Specifications**

- 1. All construction to conform to City of Winnipeg, Standard Construction Specifications and all references contained herein refer to these specifications. "SD" refers to City of Winnipeg standard details.
- 2. All materials used for construction must conform to City of Winnipeg, Approved Products for Undergound Use Within the City of Winnipeg except as indicated otherwise.

# General Design Notes

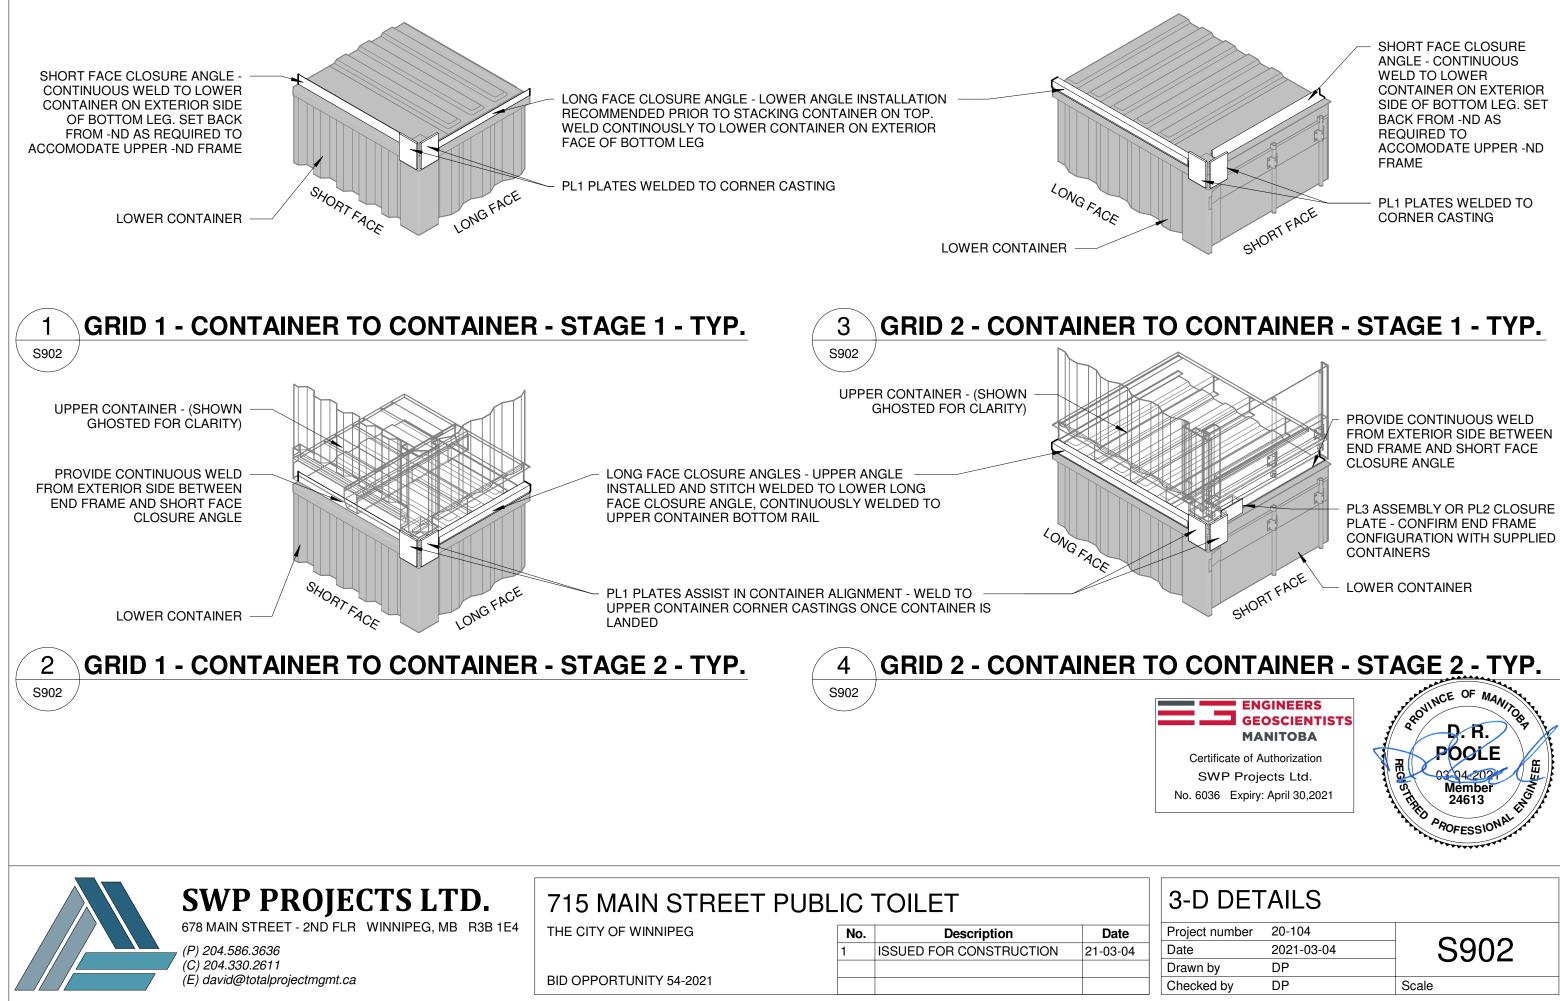- 3.1. No existing water or wastewater services to the site.
- 3.2. Proposed development is non-sprinklered.
- 3.3. No sump pits required.

# 4. Service Connections

- Water Service to CW-2110 4.1.
- 3.1.1. 25mmØ Copper.
- $\checkmark O^{V}$  3.2. WWS & LDS Service

123

- To CW2030/2130, Detail SD-014 3.1.1.
- 3.1.2. 150mmØ SDR35 PVC
- 3.2. Bedding to be Class B according SD-001.
- 3.3. Backfill according to SD-002:
- 3.1.1. In paved areas Class 2 or 3.
- 3.1.2. In landscaped areas Class 5.SD-001 Class 'B' Bedding Typical
- 3.2. SD-002:
- 3.2.1. Class '5' Backfill in landscaped & untraveled areas
- 3.2.2. Class '2' Backfill in gravel, hard-surfaced & traveled areas Consult Geotechnical Report and geotechnical engineer to 3.5.3. confirm the suitability of native soils for backfill.
- 3.6. SD-027B for Meter installation 3.7. Flushing, Disinfection, Chlorination, Sampling & Testing to
- CW-2125.

# 4. Pre- & Post-Development

- 4.1. Gross Site Area: 572 m2
- 4.2. See Tables for calculations.
- 4.3. This is a combined sewer district. *Clause 8 has been satisfied.*


# General Notes

- 5. Contractor to obtain all necessary permits. 6. Contractor to obtain clearances from all utilities before excavating. Confirm all existing infrastructure information in field before construction. Notify the Engineer immediately of any discrepancies
- that affect installation or design.
- 7. Confirm all dimensions before beginning construction.
- 6. Consult Geotechnical Report and geotechnical engineer to confirm the suitability of native soils for backfill. Topographic Surveyby Dixon & Co. 13 Jan 2021. Elevations are
- Geodetic using GPS Observations to GCVD28.
- 8. For abbreviated elevations add 200.00 to obtain geodetic elevations. 9. Existing mains information obtained from City of Winnipeg GIS.

 $+2^{2}$ 

SPt



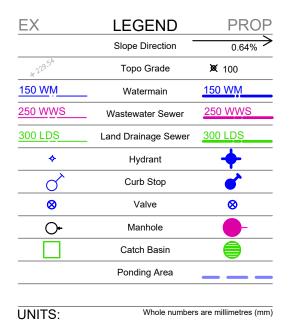

GEOSCIENTISTS MANITOBA

**Certificate of Authorization** 

7076798 Manitoba Inc.

a Sandbox Design & Consulting

No. 7281

R4 24 FEB 21

CONSTRUCTION

R3 27 JAN 21

CONSTRUCTION R2 23 JAN 21

CONSTRUCTION R1 20 JAN 21

drawn

approved

R4

FOR REVIEW

project code

21-001

sheet title

designed:

Whole numbers are millimetres (mm) Decimal numbers are metres (m) Convert Metric to Standard 1.0m = 3.2808ft

Lot Grading & Servicing Plan As Shown

715 Main Street, Winnipeg C1