

0.20 0.10 0

2 | 1-0557B-E0003-001

1-0557B-S0001-001

DRAWING NUMBER

FOUNDATION PLAN AND DETAILS

REFERENCE DRAWINGS

ELECTRICAL - EQUIPMENT ARRANGEMENT AND DISTRIBUTION - OUTDOOR MONITORING ENCLOSURE - SITE 1

REFERENCE DRAWING TITLE

SCALE: 1:8m (24"x36")

SCALE: 1: 40m (24"x36")

SCALE: 1: 400m (24"x36")

0.20

0.40

0.60

0.80

## **GENERAL NOTES:**

- 1. STORMWATER RETENTION BASIN MONITORING EQUIPMENT SHALL BE IN ELECTRICAL ENCLOSURE AND FLOOR MOUNTED ON A CONCRETE PAD. PROPOSED PAD LOCATION SHOWN IS APPROXIMATE AND TO BE CONFIRMED.
- 2. REFER TO STRUCTURAL DRAWING FOR PAD FOUNDATION DESIGN
- 3. WATER AND SEWER PIPE NETWORK PLAN (CAD FILE) AS PER CITY OF WINNIPEG DATED 2022/10/21.
- 4. ALL DIMENSIONS IN METERS UNLESS NOTED.
- 5. THE CABLE MUST BE NEW AND WITHOUT ANY SPLICE FROM MANITOBA HYDRO TRANSFORMER TO THE SRB PANEL.
- 6. THE LOCATION OF THE GROUNDING GRID IS TO BE DETERMINED ON THE FIELD.
- 7. CONTRACTOR IS TO REPAIR THE PATHWAYS TO THE CONDITION FOUND WHEN THE WORK IS COMPLETE IF THE CONTRACTOR DISTURBS THE PATHWAY.
- 8. THE SENSOR CABLE IS TO BE INSTALLED IN 25.4 MM RIGID PVC CONDUIT AND PLACED 915mm BELOW GRADE.
- 9. THE CONTRACTOR IS TO EXCAVATE THE AREA WHERE THE POWER CABLE FOR THE PANEL IS TO BE INSTALLED USING OPEN TRENCH AND DIRECTION BORE (FOR PORTION ACROSS THE PATHWAY) AND INSTALL THE POWER CABLE AS INDICATED IN THE CABLE TRENCH DETAIL. AFTER THE POWER CABLE HAS BEEN INSTALLED, THE CONTRACTOR IS TO BACK FILLED THE TRENCH AND REPAIR THE AREA OF EXCAVATION TO THE CONDITION FOUND.
- 10. THE CONTRACTOR IS TO EXCAVATE AND INSTALL THE RIGID PVC CONDUIT FOR THE WATER LEVEL SENSOR USING OPEN TRENCH AND DIRECTION BORE (FOR PORTION ACROSS THE PATHWAY). AFTER THE CONDUIT HAS BEEN INSTALLED, THE CONTRACTOR IS TO BACK FILL THE OPEN TRENCH AND REPAIR THE AREA OF EXCAVATION TO THE CONDITION FOUND.
- 11. THE CONTRACTOR IS TO INSTALL THE SRB PANEL AND ITS PAD
- 12. MANITOBA HYDRO IS TO CONNECT THE POWER CABLE FOR THE PANEL TO MH DISTRIBUTION TRANSFORMER.

## LEGEND:

—— GAS —— GAS LINE WATER SERVICE PIPE SEWER SERVICE PIPE ----- SEWER -----BURIED POWER CABLE


BURIED SENSOR CABLE MH TRANSFORMER

CP-B81 SRB

GROUND ROD

ENGINEERS
GEOSCIENTISTS **MANITOBA Certificate of Authorization** KGS Group

SHEET 1 OF 1

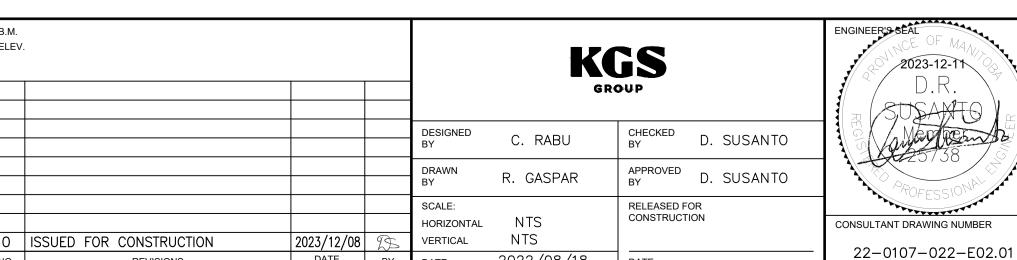

2022/08/18 DATE

- MARKER TAPE

-PRESSURE

DATE (YYYY/MM/DD)

ELEV.

TREATED WOOD PLANKS



Winnipeg

CITY DRAWING NUMBER

## THE CITY OF WINNIPEG

WATER AND WASTE DEPARTMENT **ENGINEERING DIVISION** 

STORM RETENTION BASIN 6-47 (WAVERLEY WEST) SRB 2023 WATER LEVEL MONITORING UPGRADES ELECTRICAL

SITE PLAN AND DETAILS OUTDOOR MONITORING ENCLOSURE

1-0557B-E0002-001

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