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Legend


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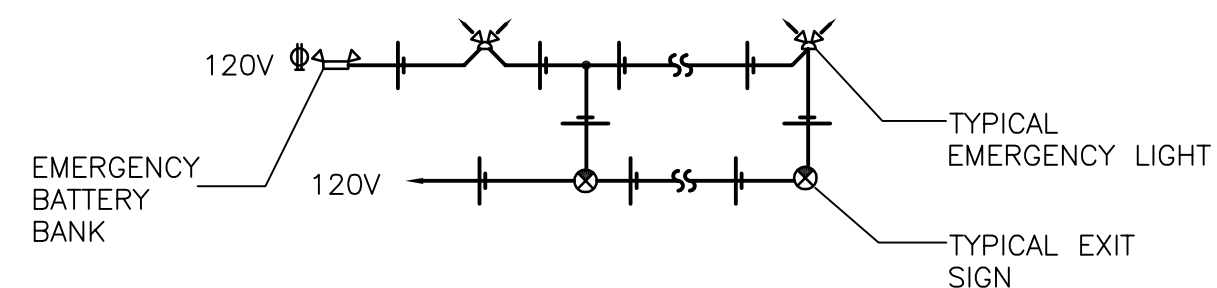
Certificate of Authorization
Stantec Consulting Ltd.
No. 1301

WINNIPEG TRANSIT MAINTENANCE FACILITY
OFFICE REDEVELOPMENTPARTIAL FLOOR PLAN - LIGHTING -
NEW CONSTRUCTION

Project No. 115421006	Scale 1/8"=1'-0"	
Drawing No. E-201	Sheet 7 of 18	Revision 0



1 PARTIAL FLOOR PLAN - LIGHTING - NEW CONSTRUCTION
E-201 1/8" = 1'-0"

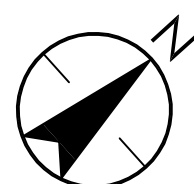

2 EMERGENCY LIGHTING & SIGNAGE RISER DIAGRAM
E-201 NTS

1. CONDUCTORS SIZED TO MANUFACTURER'S RECOMMENDATIONS. MAXIMUM 5% VOLTAGE DROP.
2. INTERLOCK 120V BATTERY FEED WITH GENERAL LIGHTING IN EACH AREA TO ACTIVATE EMERGENCY LIGHTING UPON LOSS OF GENERAL LIGHTING. PROVIDE RELAYS AS REQUIRED.
3. MINIMUM CAPACITY AND VOLTAGE TO MATCH EXISTING.
4. EMERGENCY LIGHTING TESTING TO BE CONDUCTED IN ACCORDANCE WITH THE CITY OF WINNIPEG INTEGRATED LIFE SAFETY SYSTEM TESTING.
5. EXIT SIGNS TO BE SELF POWERED C/W 10 YEAR BATTERY LIFE.