

	BREVIATIONS - original		BREVIATIONS - original
ABBREVIATION FOS	DESCRIPTION FACE OF STUD	ABBREVIATION P	DESCRIPTION
FOW FRR	FACE OF WALL FIRE RESISTANCE RATE(D)(ING)	P / PA P.E.	PAINT PROFESSIONAL ENGINEER
FS FT	FAR SIDE/FIRE SEPARATION FEET/FOOT FIRE TREATED	PB PDA / PAF	PARTICLE BOARD POWDER DRIVEN ANCHORS/POWDER
FTG	FOOTING	PED	ACTUATED FASTENER PEDESTAL
FTIT	FURNISHED BY TENANT, INSTALLED BY TENANT	PJ	PANEL JOINT
G1S	GOOD ONE SIDE	PL PLAM / P-LAM	PLATE PLASTIC LAMINATE
G2S GA	GOOD TWO SIDES GAUGE	PLB PLMB	PARALLAM BEAM PLUMBING
GALV GEN	GALVANIZED GENERAL	PLY PNL	PLYWOOD PANEL
GLB	GLULAM BEAM	POLY	POLYETHELENE
GLZ GR	GLAZING GRADE	PR PS	PAIR POUR STRIP
GRAN GRD	GRANULAR GRID ONLY	PSF	POUNDS PER SQUARE FOOT/PRESSED STEE FRAME
GWB GYP BD	GYPSUM WALL BOARD GYPSUM BOARD	PSI PSL	POUNDS PER SQUARE INCH PARALLEL STRAND LUMBER
		PT	PRESSURE TREATED / PORCELAIN TILE / PAINT
HB HC	HOSE BIB/HORIZONTAL BLINDS HOLLOW CORE/HANDICAP	PVC PVMT	POLY VINYL CHLORIDE PAVEMENT
HCM HD	HOLLOW CLAY MASONRY HEAVY DUTY	Q	
HDPE HDR	HIGH DENSITY POLYETHELENE HEADER	QT R	QUARRY TILE
HDWR	HARDWARE	R/RAD RB	RADIUS/RADIAL RUBBER BASE
HEF HGR	HORIZONTAL EACH FACE HANGER	RBE	ROOF BASE ELEVATION
HIF HL	HORIZONTAL INSIDE FACE HALF LITE	RCP RD	REFLECTED CEILING PLAN ROOF DRAIN
НМ	HOLLOW METAL	REF REINF	REFERENCE/REFRIGERATOR REINFORCE(D)(ING)
HMK HMW	HOLLOW METAL KNOCKDOWN HOLLOW METAL WELDED	REQ'D	REQUIRED
HOF HORIZ	HORIZONTAL OUTSIDE FACE HORIZONTAL	REQ'TS REV	REQUIREMENTS REVISION
HR(S)	HOUR(S)	RM RO	ROOM ROUGH OPENING
HS HSB	HEADED STUD HIGH STRENGTH BOLT	ROW	RIGHT OF WAY
HSS	HOLLOW STRUCTURAL STEEL	RWL S	RAIN WATER LEADER
HTG HVAC	HEATING HEATING, VENTILATION AND AIR	SAN	SANITARY
HWS	CONDITIONING HEADED WELD STUD	SAT SC	SUSPENDED ACOUSTICAL TILE SEALED CONCRETE / SOLID CORE WOOD /
ID	INSIDE DIAMETER	SCHED	SAW CUT SCHEDULE
ΙE	INVERT ELEVATION	SCM SEC.	STRUCTURAL CLAY MASONRY SECONDS
IF/ISF INCL	INSIDE FACE INCLUDE(D)	SEP	SEPARATE(D)(ION)
INFO	INFORMATION	SF SFRS	STOREFRONT / SQUARE FEET(FOOT) SEISMIC FORCE RESISTING SYSTEM
INSP INSUL	INSPECTION/INSPECTOR INSULATION	SH	SHELF/SHELVES
INT	INTERIOR	SHT SHTG	SHEET SHEATHING
JAN	JANITOR	SIM SLRS	SIMILAR SEISMIC LOAD RESISTIVE SYSTEM
JNT JST	JOINT JOIST	SLV	SHORT LEG VERTICAL
K	KIPS	SMS SOG	SHEET METAL SCREW SLAB ON GRADE
KG KM	KILOGRAM(S)	SP SPEC(S)	SPACE(D)(S) SPECIFICATION(S)
KM/H	KILOMETRE(S) KILOMETRE PER HOUR	SPF SQ	SPRUCE PINE FIRE SQUARE
KSI	KIPS PER SQUARE INCH	SS	STAINLESS STEEL/SOLID SURFACE
LAM LAV	LAMINATE LAVATORY	ST STA PT	STONE/STAIN STATION POINT
LB	LAG BOLT	STAGG STD	STAGGERED STANDARD
LCC LL	LEAD COATED COPPER LIVE LOAD	STIFF	STIFFENER
LLV LONG/LONGIT	LONG LEG VERTICAL LONGITUDINAL	STL STM	STEEL STORM
LP	LOWPOINT	STOR STRUCT	STORAGE STRUCTURAL
LSL LVL	LAMINATE STRAND LUMBER LAMINATED VENEER LUMBER	SUSP	SUSPENDED
LWC	LIGHTWEIGHT CONCRETE	T SV	SHEET VINYL
MANUF	MANUFACTURER MASONBY	T T&B	TEMPERED TOP AND BOTTOM
MAS MATL	MASONRY MATERIAL	T/	TOP OF CURB
MAX MB	MAXIMUM MACHINE BOLT	TEMP	TEMPERATURE / TEMPORARY
MCJ MDF/MDO	MASONRY CONTROL JOINT MEDIUM DENSITY FIBREBOARD/OVERLAY	THK TJ	THICK(NESS) TIE JOIST
MECH	MECHANICAL	TL TLL	TOTAL LOAD TOP LOWER LAYER
MEMB MEP	MEMBRANE MECHANICAL/ELECTRICAL/PLUMBING OR	TN	TOE NAIL
MFD	PROCESS MANUFACTURED	TO TOF	TOP OF TOP OF FOOTING
MFG	MANUFACTURING	TOG	TOP OF STEEL
MFR MGR	MANUFACTURER MANAGER	TOW	TOP OF WALL
MH MIN	MAN HOLE MINIMUM	TPO TRANS	THERMOPLASTIC POLY OLEFIN TRANSVERSE
MIR	MIRROR	TS TUL	TUBE STEEL TOP UPPER LAYER
MIRR MISC	MIRRORED MISCELLANEOUS	TYP	TYPICAL TYPICAL
MK MLP	MARK METAL LINEAR PANEL	U U/G	UNDERGROUND
MO	MASONRY OPENING	U/S	UNDERSIDE
	BIT MODIFIED BITUMINOUS	UC ULC	UNDER COUNTER UNDER WRITER'S LABORATORIES OF CANAL
MOD MP	METAL PANEL	UNO	UNLESS NOTED OTHERWISE
MP MPH	MILES PER HOUR	V	VADOUD BADDIED
MP MPH MTD MTL		VB	VAPOUR BARRIER VINYL COMPOSITION TILE
MP MPH MTD MTL (N)	MILES PER HOUR MOUNTED METAL NEW	VB VCT VEF	VINYL COMPOSITION TILE VERTICAL EACH FACE
MP MPH MTD MTL	MILES PER HOUR MOUNTED METAL	VB VCT	VINYL COMPOSITION TILE
MP MPH MTD MTL (N) NFPA NIC NO. / #	MILES PER HOUR MOUNTED METAL NEW NATIONAL FIRE PROTECTION ASSOCIATION NOT IN CONTRACT NUMBER	VB VCT VEF VERT VEST VFY	VINYL COMPOSITION TILE VERTICAL EACH FACE VERTICAL VESTIBULE VERIFY
MP MPH MTD MTL (N) NFPA NIC NO. /# NOM NR	MILES PER HOUR MOUNTED METAL NEW NATIONAL FIRE PROTECTION ASSOCIATION NOT IN CONTRACT	VB VCT VEF VERT VEST VFY VIF VOF	VINYL COMPOSITION TILE VERTICAL EACH FACE VERTICAL VESTIBULE VERIFY VERIFY IN FIELD/VERTICAL INSIDE FACE VERTICAL OUTSIDE FACE
MP MPH MTD MTL (N) NFPA NIC NO./# NOM NR NS	MILES PER HOUR MOUNTED METAL NEW NATIONAL FIRE PROTECTION ASSOCIATION NOT IN CONTRACT NUMBER NOMINAL NON RATED NEAR SIDE	VB VCT VEF VERT VEST VFY VIF	VINYL COMPOSITION TILE VERTICAL EACH FACE VERTICAL VESTIBULE VERIFY VERIFY IN FIELD/VERTICAL INSIDE FACE
MP MPH MTD MTL (N) NFPA NIC NO./# NOM NR NS NTE NTS	MILES PER HOUR MOUNTED METAL NEW NATIONAL FIRE PROTECTION ASSOCIATION NOT IN CONTRACT NUMBER NOMINAL NON RATED	VB VCT VEF VERT VEST VFY VIF VOF VP	VINYL COMPOSITION TILE VERTICAL EACH FACE VERTICAL VESTIBULE VERIFY VERIFY IN FIELD/VERTICAL INSIDE FACE VERTICAL OUTSIDE FACE VISION PANEL
MP MPH MTD MTL (N) NFPA NIC NO./# NOM NR NS NTE NTS	MILES PER HOUR MOUNTED METAL NEW NATIONAL FIRE PROTECTION ASSOCIATION NOT IN CONTRACT NUMBER NOMINAL NON RATED NEAR SIDE NOT TO EXCEED	VB VCT VEF VERT VEST VFY VIF VOF VP W W/ W/CRC W/O	VINYL COMPOSITION TILE VERTICAL EACH FACE VERTICAL VESTIBULE VERIFY VERIFY IN FIELD/VERTICAL INSIDE FACE VERTICAL OUTSIDE FACE VISION PANEL WITH COATING WITH CHEMICAL RESISTANCE WITHOUT
MP MPH MTD MTL (N) NFPA NIC NO. /# NOM NR NS OTE NTS	MILES PER HOUR MOUNTED METAL NEW NATIONAL FIRE PROTECTION ASSOCIATION NOT IN CONTRACT NUMBER NOMINAL NON RATED NEAR SIDE NOT TO EXCEED NOT TO SCALE OVERALL ON CENTRE	VB VCT VEF VERT VEST VFY VIF VOF VP W W/ W/CRC W/O WB	VINYL COMPOSITION TILE VERTICAL EACH FACE VERTICAL VESTIBULE VERIFY VERIFY IN FIELD/VERTICAL INSIDE FACE VERTICAL OUTSIDE FACE VISION PANEL WITH COATING WITH CHEMICAL RESISTANCE WITHOUT WOOD BASE
MP MPH MTD MTL (N) NFPA NIC NO. /# NOM NR NS NTE NTS	MILES PER HOUR MOUNTED METAL NEW NATIONAL FIRE PROTECTION ASSOCIATION NOT IN CONTRACT NUMBER NOMINAL NON RATED NEAR SIDE NOT TO EXCEED NOT TO SCALE OVERALL ON CENTRE OUTSIDE DIAMETER OWNER FURNISHED, CONTRACTOR	VB VCT VEF VERT VEST VFY VIF VOF VP W W/ W/CRC W/O WB WC WD	VINYL COMPOSITION TILE VERTICAL EACH FACE VERTICAL VESTIBULE VERIFY VERIFY IN FIELD/VERTICAL INSIDE FACE VERTICAL OUTSIDE FACE VISION PANEL WITH COATING WITH CHEMICAL RESISTANCE WITHOUT WOOD BASE WATER CLOSET/WALL COVERING WOOD
MP MPH MTD MTD MTL (N) NFPA NIC NO. /# NOM NR NS O O/A OC / O.C. OD OFCI	MILES PER HOUR MOUNTED METAL NEW NATIONAL FIRE PROTECTION ASSOCIATION NOT IN CONTRACT NUMBER NOMINAL NON RATED NEAR SIDE NOT TO EXCEED NOT TO SCALE OVERALL ON CENTRE OUTSIDE DIAMETER	VB VCT VEF VERT VEST VFY VIF VOF VP W W/ W/CRC W/O WB WC	VINYL COMPOSITION TILE VERTICAL EACH FACE VERTICAL VESTIBULE VERIFY VERIFY IN FIELD/VERTICAL INSIDE FACE VERTICAL OUTSIDE FACE VISION PANEL WITH COATING WITH CHEMICAL RESISTANCE WITHOUT WOOD BASE WATER CLOSET/WALL COVERING
MP MPH MTD MTD MTL (N) NFPA NIC NO. /# NOM NR NS OTE NTS O/A OC / O.C. OD OFCI OFOI OH	MILES PER HOUR MOUNTED METAL NEW NATIONAL FIRE PROTECTION ASSOCIATION NOT IN CONTRACT NUMBER NOMINAL NON RATED NEAR SIDE NOT TO EXCEED NOT TO SCALE OVERALL ON CENTRE OUTSIDE DIAMETER OWNER FURNISHED, CONTRACTOR INSTALLED OPPOSITE HAND/OVERHEAD	VB VCT VEF VERT VEST VFY VIF VOF VP W W/ W/CRC W/O WB WC WD WF	VINYL COMPOSITION TILE VERTICAL EACH FACE VERTICAL VESTIBULE VERIFY VERIFY IN FIELD/VERTICAL INSIDE FACE VERTICAL OUTSIDE FACE VISION PANEL WITH COATING WITH CHEMICAL RESISTANCE WITHOUT WOOD BASE WATER CLOSET/WALL COVERING WOOD WIDE FLANGE BEAM
MP MPH MTD MTD MTL (N) NFPA NIC NO. /# NOM NR NS O O/A OC / O.C. OD OFCI OFOI OH OHD OPNG	MILES PER HOUR MOUNTED METAL NEW NATIONAL FIRE PROTECTION ASSOCIATION NOT IN CONTRACT NUMBER NOMINAL NON RATED NEAR SIDE NOT TO EXCEED NOT TO SCALE OVERALL ON CENTRE OUTSIDE DIAMETER OWNER FURNISHED, CONTRACTOR INSTALLED OPPOSITE HAND/OVERHEAD OVERHEAD DOOR OPENING	VB VCT VEF VERT VEST VFY VIF VOF VP W W/ W/CRC W/O WB WC WD WF WH WP	VINYL COMPOSITION TILE VERTICAL EACH FACE VERTICAL VESTIBULE VERIFY VERIFY IN FIELD/VERTICAL INSIDE FACE VERTICAL OUTSIDE FACE VISION PANEL WITH COATING WITH CHEMICAL RESISTANCE WITHOUT WOOD BASE WATER CLOSET/WALL COVERING WOOD WIDE FLANGE BEAM WATER HEATER WATER PROOF/WOOD PANELING/WORK POINT WATER RESISTANT/WASHROOM
MP MPH MTD MTD MTL (N) NFPA NIC NO. /# NOM NR NS O/A OC / O.C. OD OFCI OFOI OH OHD	MILES PER HOUR MOUNTED METAL NEW NATIONAL FIRE PROTECTION ASSOCIATION NOT IN CONTRACT NUMBER NOMINAL NON RATED NEAR SIDE NOT TO EXCEED NOT TO SCALE OVERALL ON CENTRE OUTSIDE DIAMETER OWNER FURNISHED, CONTRACTOR INSTALLED OPPOSITE HAND/OVERHEAD OVERHEAD DOOR	VB VCT VEF VERT VEST VFY VIF VOF VP W W/ W/CRC W/O WB WC WD WF WH WP WR WR WR WR WR WS	VINYL COMPOSITION TILE VERTICAL EACH FACE VERTICAL VESTIBULE VERIFY VERIFY IN FIELD/VERTICAL INSIDE FACE VERTICAL OUTSIDE FACE VISION PANEL WITH COATING WITH CHEMICAL RESISTANCE WITHOUT WOOD BASE WATER CLOSET/WALL COVERING WOOD WIDE FLANGE BEAM WATER HEATER WATER PROOF/WOOD PANELING/WORK POINT WATER RESISTANT/WASHROOM WATER RESISTANT GYPSUM BOARD WATER STOP/WELDED STUD
MP MPH MTD MTL (N) NFPA NIC NO. /# NOM NR NS O/A OC / O.C. OD OFCI OFOI OH OHD OPNG OPP	MILES PER HOUR MOUNTED METAL NEW NATIONAL FIRE PROTECTION ASSOCIATION NOT IN CONTRACT NUMBER NOMINAL NON RATED NEAR SIDE NOT TO EXCEED NOT TO SCALE OVERALL ON CENTRE OUTSIDE DIAMETER OWNER FURNISHED, CONTRACTOR INSTALLED OPPOSITE HAND/OVERHEAD OPPOSITE	VB VCT VEF VERT VEST VFY VIF VOF VP W W/ W/CRC W/O WB WC WD WF WH WP WR WR WR WR WR WR VCT WR WR	VINYL COMPOSITION TILE VERTICAL EACH FACE VERTICAL VESTIBULE VERIFY VERIFY IN FIELD/VERTICAL INSIDE FACE VERTICAL OUTSIDE FACE VISION PANEL WITH COATING WITH CHEMICAL RESISTANCE WITHOUT WOOD BASE WATER CLOSET/WALL COVERING WOOD WIDE FLANGE BEAM WATER HEATER WATER PROOF/WOOD PANELING/WORK POINT WATER RESISTANT/WASHROOM WATER RESISTANT GYPSUM BOARD

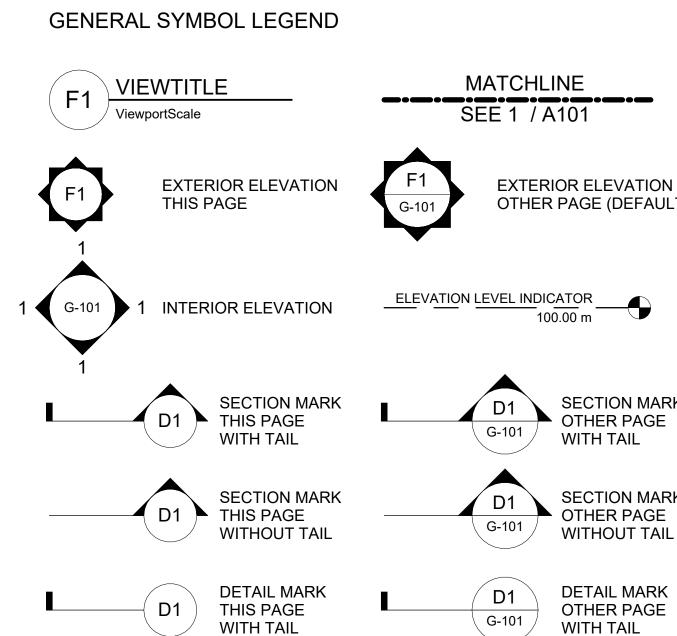

ARCHITECTURAL DRAWING LIST Sheet Number Sheet Name U2-B001 INDEX PAGE U2-B002 BUILDING CODE ANALYSIS U2-B101 UV ROOF PLANS U2-B102 PARTIAL MAIN FLOOR PLAN U2-B103 REFLECTED CEILING PLAN AND ROOF PLAN U2-B201 BUILDING ELEVATIONS AND SECTIONS U2-B301 WALL SECTIONS U2-B501 PLAN DETAILS U2-B502 SECTION DETAILS U2-B503 EXIT DOOR PORCH DETAILS U2-B504 EXISTING BUILDING SECTION & ACCESS LADDER DETAILS U2-B601 DOOR AND FRAME SCHEDULE UD-B101 PARTIAL EXISTING BUILDING PLAN -DEMOLITION

GENERAL NOTES:

- UNITS ARE IN MILLIMETERS (mm) UNLESS NOTED OTHERWISE
- DRAWINGS ARE NOT TO BE SCALED FOR SIZE OR DIMENSIONS
- COORDINATE DRAWINGS WITH STRUCTURAL, PROCESS, MECHANICAL, ELECTRICAL AND CIVIL DISCIPLINES.
- ANY DISCREPANCIES IN WORK, CLARIFY WITH CONSULTANT PRIOR TO CONTINUING. PROVIDE BLOCKING, STRAPPING, NAILING STRIPS, WOOD FRAMING ETC. AS INDICATED ON DRAWINGS
- OR AS REQUIRED. SIZE AND LOCATION OF WALL PENETRATIONS ARE APPROXIMATE. ALL PENETRATIONS MAY NOT BE
- INDICATED. COORDINATE PENETRATIONS WITH OTHER DISCIPLINES FOR EXACT SIZE AND LOCATION.
- SEAL EXTERIOR PENETRATIONS WITH FLASHING, BACKER RODS AND SEALANT AS REQUIRED TO PROVIDE A WATERTIGHT SEAL.
- SEAL ALL INTERIOR WALL AND FLOOR PENETRATIONS. FOR FIRE RATEDPENETRATIONS. SEAL AS REQUIRED WITH SPECIFIED FIRESTOPPING SYSTEM.

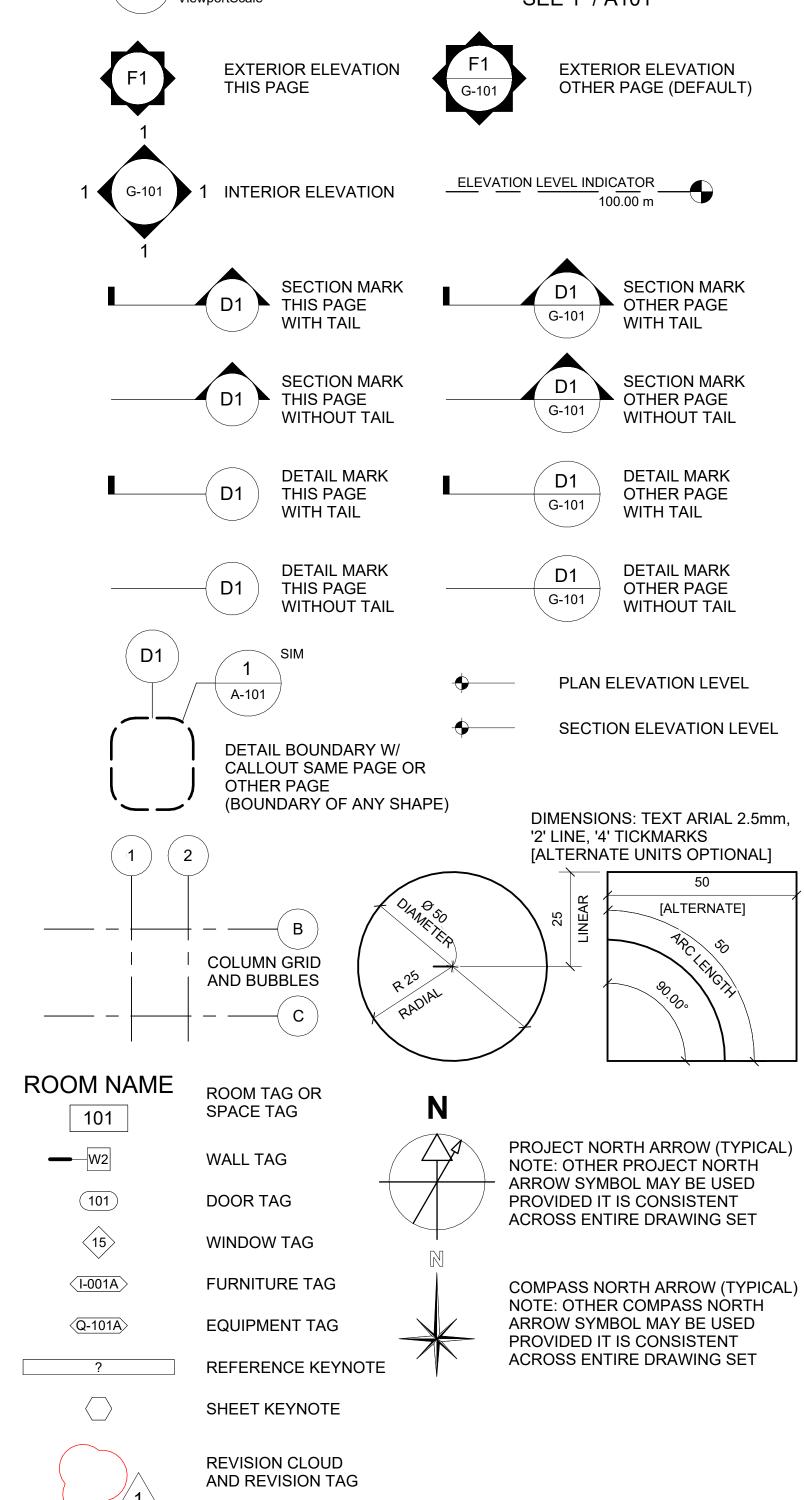

2025-02-27

							ENGINE
					AE	COM	لو
					DESIGNED BY: AC/KS	CHECKED BY:	
					DRAWN BY:	APPROVED BY: KS	
					SCALE: As indicated	RELEASED FOR CONSTRUCTION BY:	1/2
					DATE: 2025-02-26	DATE:	"
00	ISSUED FOR TENDER	2025-02-26	AC	JC	CONSULTANT NO.:	U2-B001	1

INEER'S SEAL KEVIN ARTHUR SIDDALL 2025-02-26

THE CITY OF WINNIPEG Winnipèg WATER AND WASTE DEPARTMENT

NORTH END SEWAGE TREATMENT PLANT NEWPCC UV UPGRADES ARCHITECTURAL NEW UV STORAGE ROOM INDEX PAGE

CITY DRAWING NUMBER

SHEET REV. SIZE 00 A1

TENDER NO. 30-2025

NAME OF PROJECT: NORTH END SEWAGE TREATMENT PLANT NEW UV STORAGE ROOM


PROJECT LOCATION:


CIVIC ADDRESS:

ITEM	2020 NATIONAL BUILDING CODE OF CANADA						CODE REFERENCE			
I LIVI	DATA MATRIX - PARTS 3 AND 9							FOR DIVISION A	DIVISION B UNLESS NOTED [A] OR [C] FOR DIVISION C.	
01	PROJECT DESCRIPTION:			□ NEW ■ ADDITIO	□ CH/ N OF	ANGE USE		■ PART 3	□ PART 9	
				■ ADDITIO						
02	MAJOR OCCUPANCY(S):									
	GROUP F							APPENDIX "A"		
03	BUILDING AREA (m²):	EXISTING:	536 m²	NEW:	74.5 m²	TOTAL	: 610.5 m²			
04	GROSS FLOOR AREA (m²):		536 m²	NEW:	74.5 m²	TOTAL				
05	MEZZANINE(S) AREA (m²):		75 m²	NEW:	0 m²	TOTAL	75 m²			
	MEZZANINE 10% OR LESS MEZZANINE 40% OR MORI	. ,			0 m ²					
06	NUMBER OF STOREYS:	ABOVE GRADE: 1	•	BELOW GF						
07	BUILDING HEIGHT (m):		6 m							
08	NUMBER OF STREETS / FI									
09	BUILDING CLASSIFICATION		- í					3.2.2.87		
10	SPRINKLER SYSTEM PRO	POSED:		☐ ENTIRE I	BUILDING ED COMPARTN	/ENTS		3.2.2.87		
					ED FLOOR ARE					
				□ BASEME	NT ONLY			INDEX		
				□ IN LIEU (OF ROOF RATI	NG		INDEX		
				■ NOT REC						
11	STANDPIPE SYSTEM REQ		YES	AV + 2 OM I	■ NO	4				
12	HOSE CABINET LO		YES	AX. + 3.01VI I	HOSE STREAM	1				
13	WATER SERVICE/SUPPLY		YES		□ NO					
14	HIGH BUILDING:	_ '	YES		■ NO IF Y	YES, REFEI GH BUILDIN	R TO IG REQUIREMENTS CHART			
15	CONSTRUCTION RESTRIC	TIONS:						3.2.2.87		
	REQUIRED:	□ COMBUSTIBLE PERI	MITTED				■ BOTH			
16	PROVIDED: HAZARDOUS SUBSTANCE	□ COMBUSTIBLE	YES	□ NON-0	OMBUSTIBLE		■ BOTH			
17	BARRIER-FREE DESIGN:		YES		■ NO (E	XPLAIN)	:	A.2.1.1.2.5.b		
18	BARRIER-FREE ENTRANC	ES:			`					
	No. OF ENTRANCE	S REQ'D TO BE BARRIEF	R FREE:	0						
	POWER DOOR OPE		YES		■ NO					
19	REQUIRED FIRE RESISTANCE	HORIZONTAL ASSEN RESISTANCE RA					iN No. (ULC) SCRIPTION (SB-2)	3.2.2.87		
	RATINGS:	(F.R.R.))							
	Ī	FLOOR: 45 min			FLOOR:					
		ROOF: 45 min			ROOF:					
	<u> </u>	MEZZANINE: 45 min			MEZZANINE:					
		FIRE RESISTANCE OF SUPPORTING N					iN No. (ULC) SCRIPTION (SB-2)			
		(F.R.R.))							
		FLOOR: 45 min			FLOOR:					
		ROOF: 45 min			ROOF:					
		MEZZANINE: 45 min		-	MEZZANINE:	ATINIO	SDECITIO			
20	SEPARATION	SPACE NAME:			REQUIRED RA	ATING:	SPECIFIC REFERENCE(S):			
	FIRE RESISTANCE RATINGS:	SUITES		+	N/A		3.1.1.1. & 3.3.4.2.		\dashv	
		PUBLIC CORRIDORS			N/A		3.3.1.4.			
	_	JANITOR ROOMS			N/A		3.3.1.22.			
		SERVICE ROOMS	CEC		N/A		3.6.2.1., 3.6.2.4., 3.6	6.2.5.		
		VERTICAL SERVICE SPA HORIZONTAL SERVICE S			N/A N/A		3.6.3. 3.6.4.		_	
	<u> </u>	ELEVATOR - HOISTWAY			N/A		3.5.3.		\dashv	
		ELEVATOR - MACHINE R	ROOM		N/A		3.5.3.3.			
		EXITS - STAIR TOWERS			N/A		3.4.4.			
		EXITS - CORRIDORS	0=:	EVITE	45 min		3.4.4.		_	
21		LOBBY SEPARATION TO	OTHER	EXITS	N/A		3.4.4.2.			
41	EXITS:	MAX. TRAVEL DISTANCE	 E:		40 m					
	F	MAX. LOBBY TRAVEL DIS			0 m					
	1	MAX. DEAD END CORRIE	OOR		20 m					


WALL FACE	AREA OF E.B.F. (m²)	AREA OF U.P.O. (m²)	LIMITING DISTANCE (m)	RATIO L/H OR H/L (1 : x)	PERMITTED MAX. % OF OPENINGS	PROPOSED MAX. % OF OPENINGS	REQUIRED F.R.R. OF WALL	LISTED DESIGN OR DESCRIPTION	NON-COMB. CONS'TN REQ'D	NON-COMB CLADDING REQ'D
NORTH	280 m²	22 m²	7 m	7:1	9 %	7.857143 %	45 Min		N	Y
EAST	138 m²	0 m²	6 m	2:1	7 %	0 %	45 Min	-	N	Y
SOUTH	280 m²	11.5 m²	60 m	7:1	100 %	4.107143 %	45 Min		N	Y
WEST	138 m²	22.6 m²	7 m	2:1	100 %	16.376812 %	45 Min		N	Y
CCUPANT	LOAD:			(REFE	R TO OCCUPAN	T LOAD CHAR	T FOR SPECIFIC	CS)		
OCCUP.	ANT LOAD BAS	SED ON:	-	sq.m./PEF	RSON 🗆 🛭	DESIGN OF BUI	LDING			
OCCUPANCY:					LOAD:		SONS:			
EXIST	ING BASEMEN	T: SERV	CE SPACE		N/A	0				
EVICTING BUILDING LOW HAZARD INDUCTRIAL				4.0	400					

23	00	OCCUPANT LOAD: (REFER TO OCCUPANT LOAD CHART FOR SPECIFICS)					
		OCCUPANT LOAD BASED ON	F BUILDING				
			OCCUPANCY:	LOAD:	PERSONS:		
		EXISTING BASEMENT:	SERVICE SPACE	N/A	0		
		EXISTING BUILDING:	LOW HAZARD INDUSTRIAL	4.6	132		
		NEW UV STORAGE ROOM:	LOW HAZARD INDUSTRIAL	4.6	13		
		LEVEL 03:	N/A	N/A	0		
		LEVEL 04:	N/A	N/A	0		
		LEVEL 05:	N/A	N/A	0		
		LEVEL 06:	N/A	N/A	0		
			TOTAL OCC	UPANT LOAD:	145 PEOPLE		
24	WA	ASHROOM REQUIREMENTS:	(REFER TO WA	SHROOM AND HEALTH R	EQUIREMENTS CHART)		
25	ОТ	HER:					

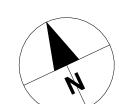


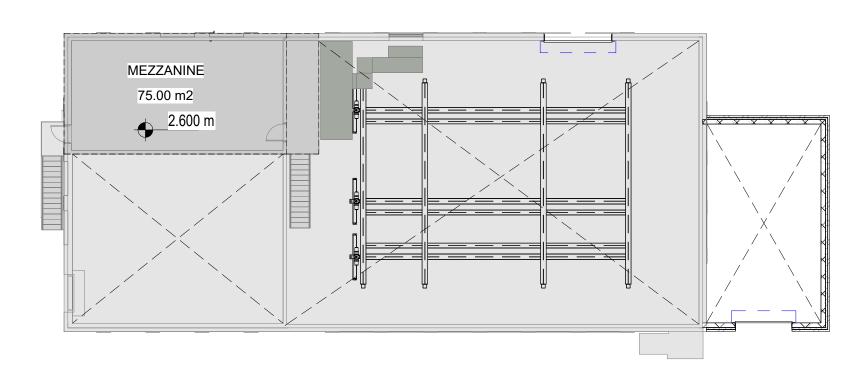

1 T.O. MEZZANINE

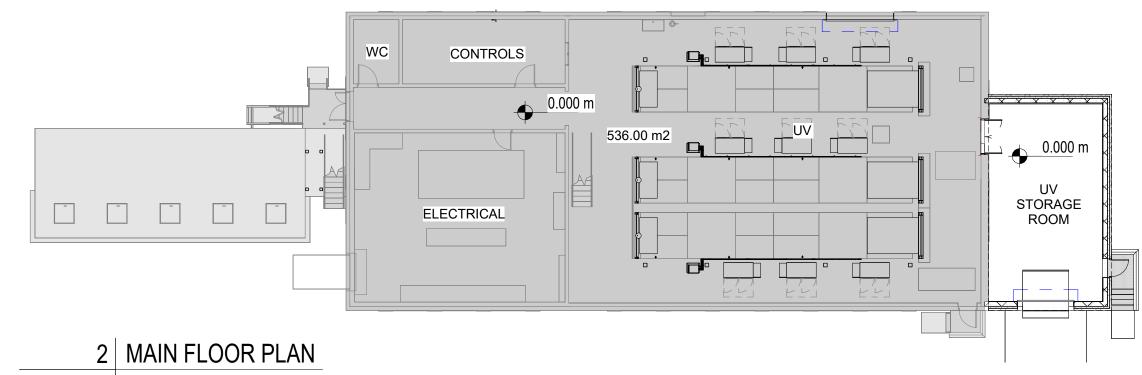

U2-B201

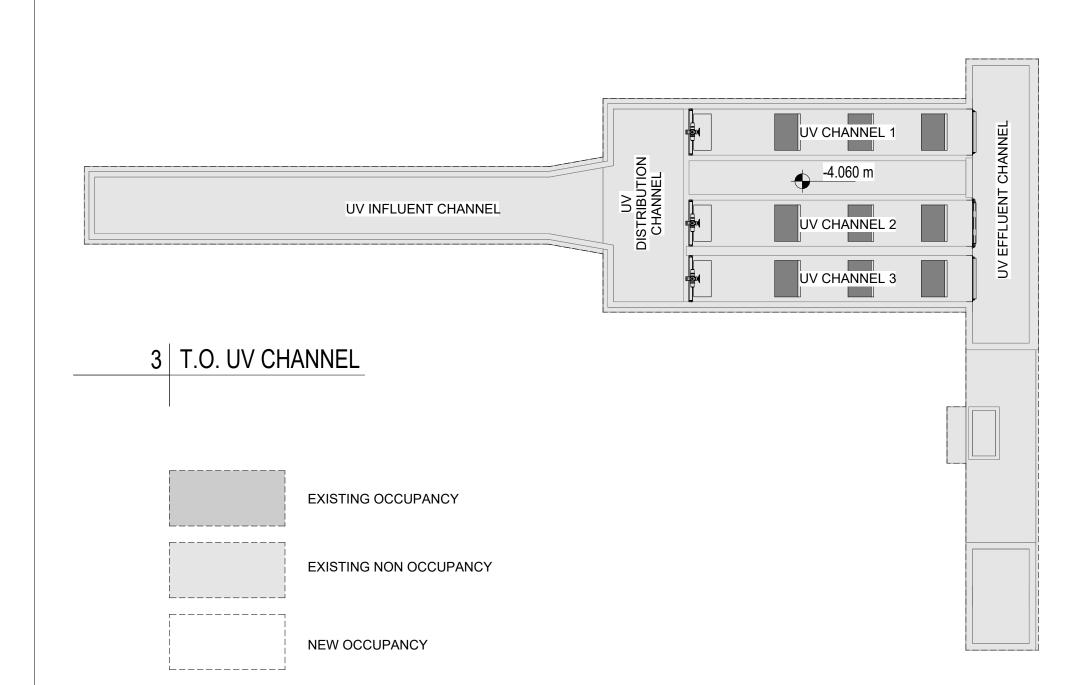

OCCUPANCY COLOURS LEGEND

Winnipeg

KEVIN ARTHUR SIDDALL

2025-02-26

THE CITY OF WINNIPEG WATER AND WASTE DEPARTMENT

NORTH END SEWAGE TREATMENT PLANT NEWPCC UV UPGRADES ARCHITECTURAL NEW UV STORAGE ROOM

TENDER NO. 30-2025


BUILDING CODE ANAYSIS


SHEET REV. SIZE 00 A1 CITY DRAWING NUMBER


2025-02-27


AECOM AC/KS SCALE: 1:200 RELEASED FOR CONSTRUCTION DATE: 2025-02-26 00 ISSUED FOR TENDER


NO. REVISIONS 2025-02-26 AC JC CONSULTANT NO.:
DATE DESIGN CHECK U2-B002

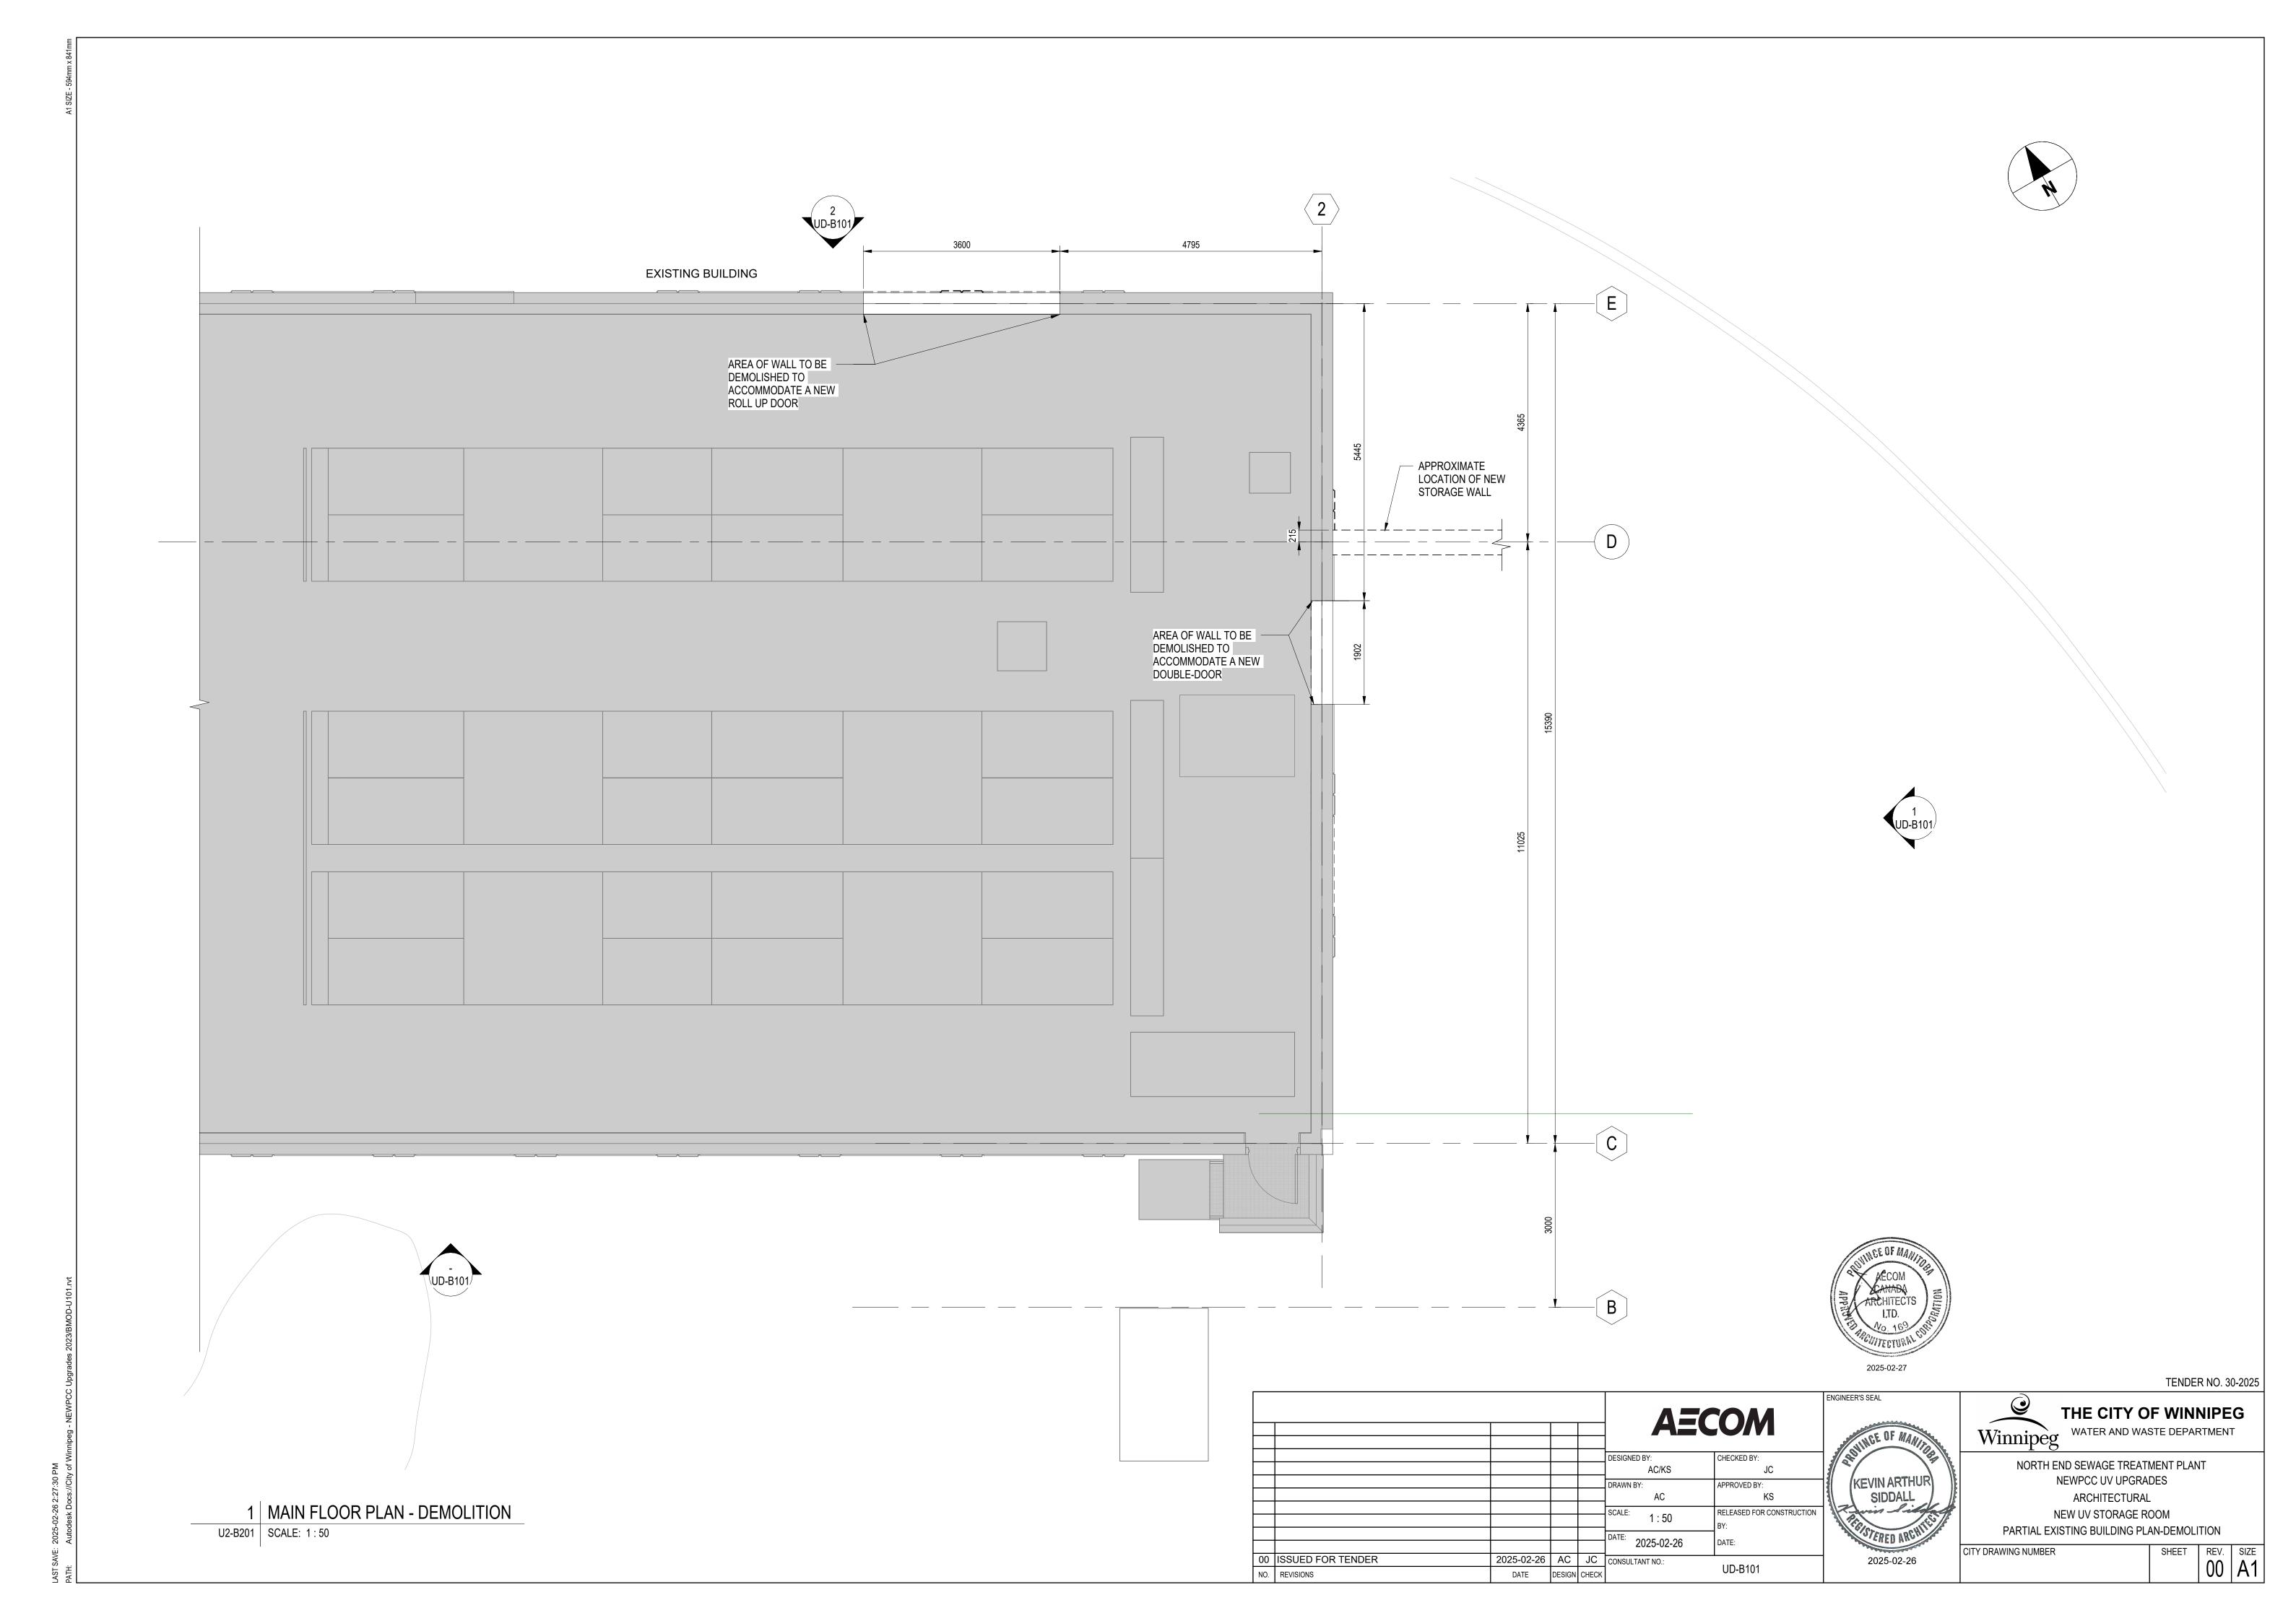


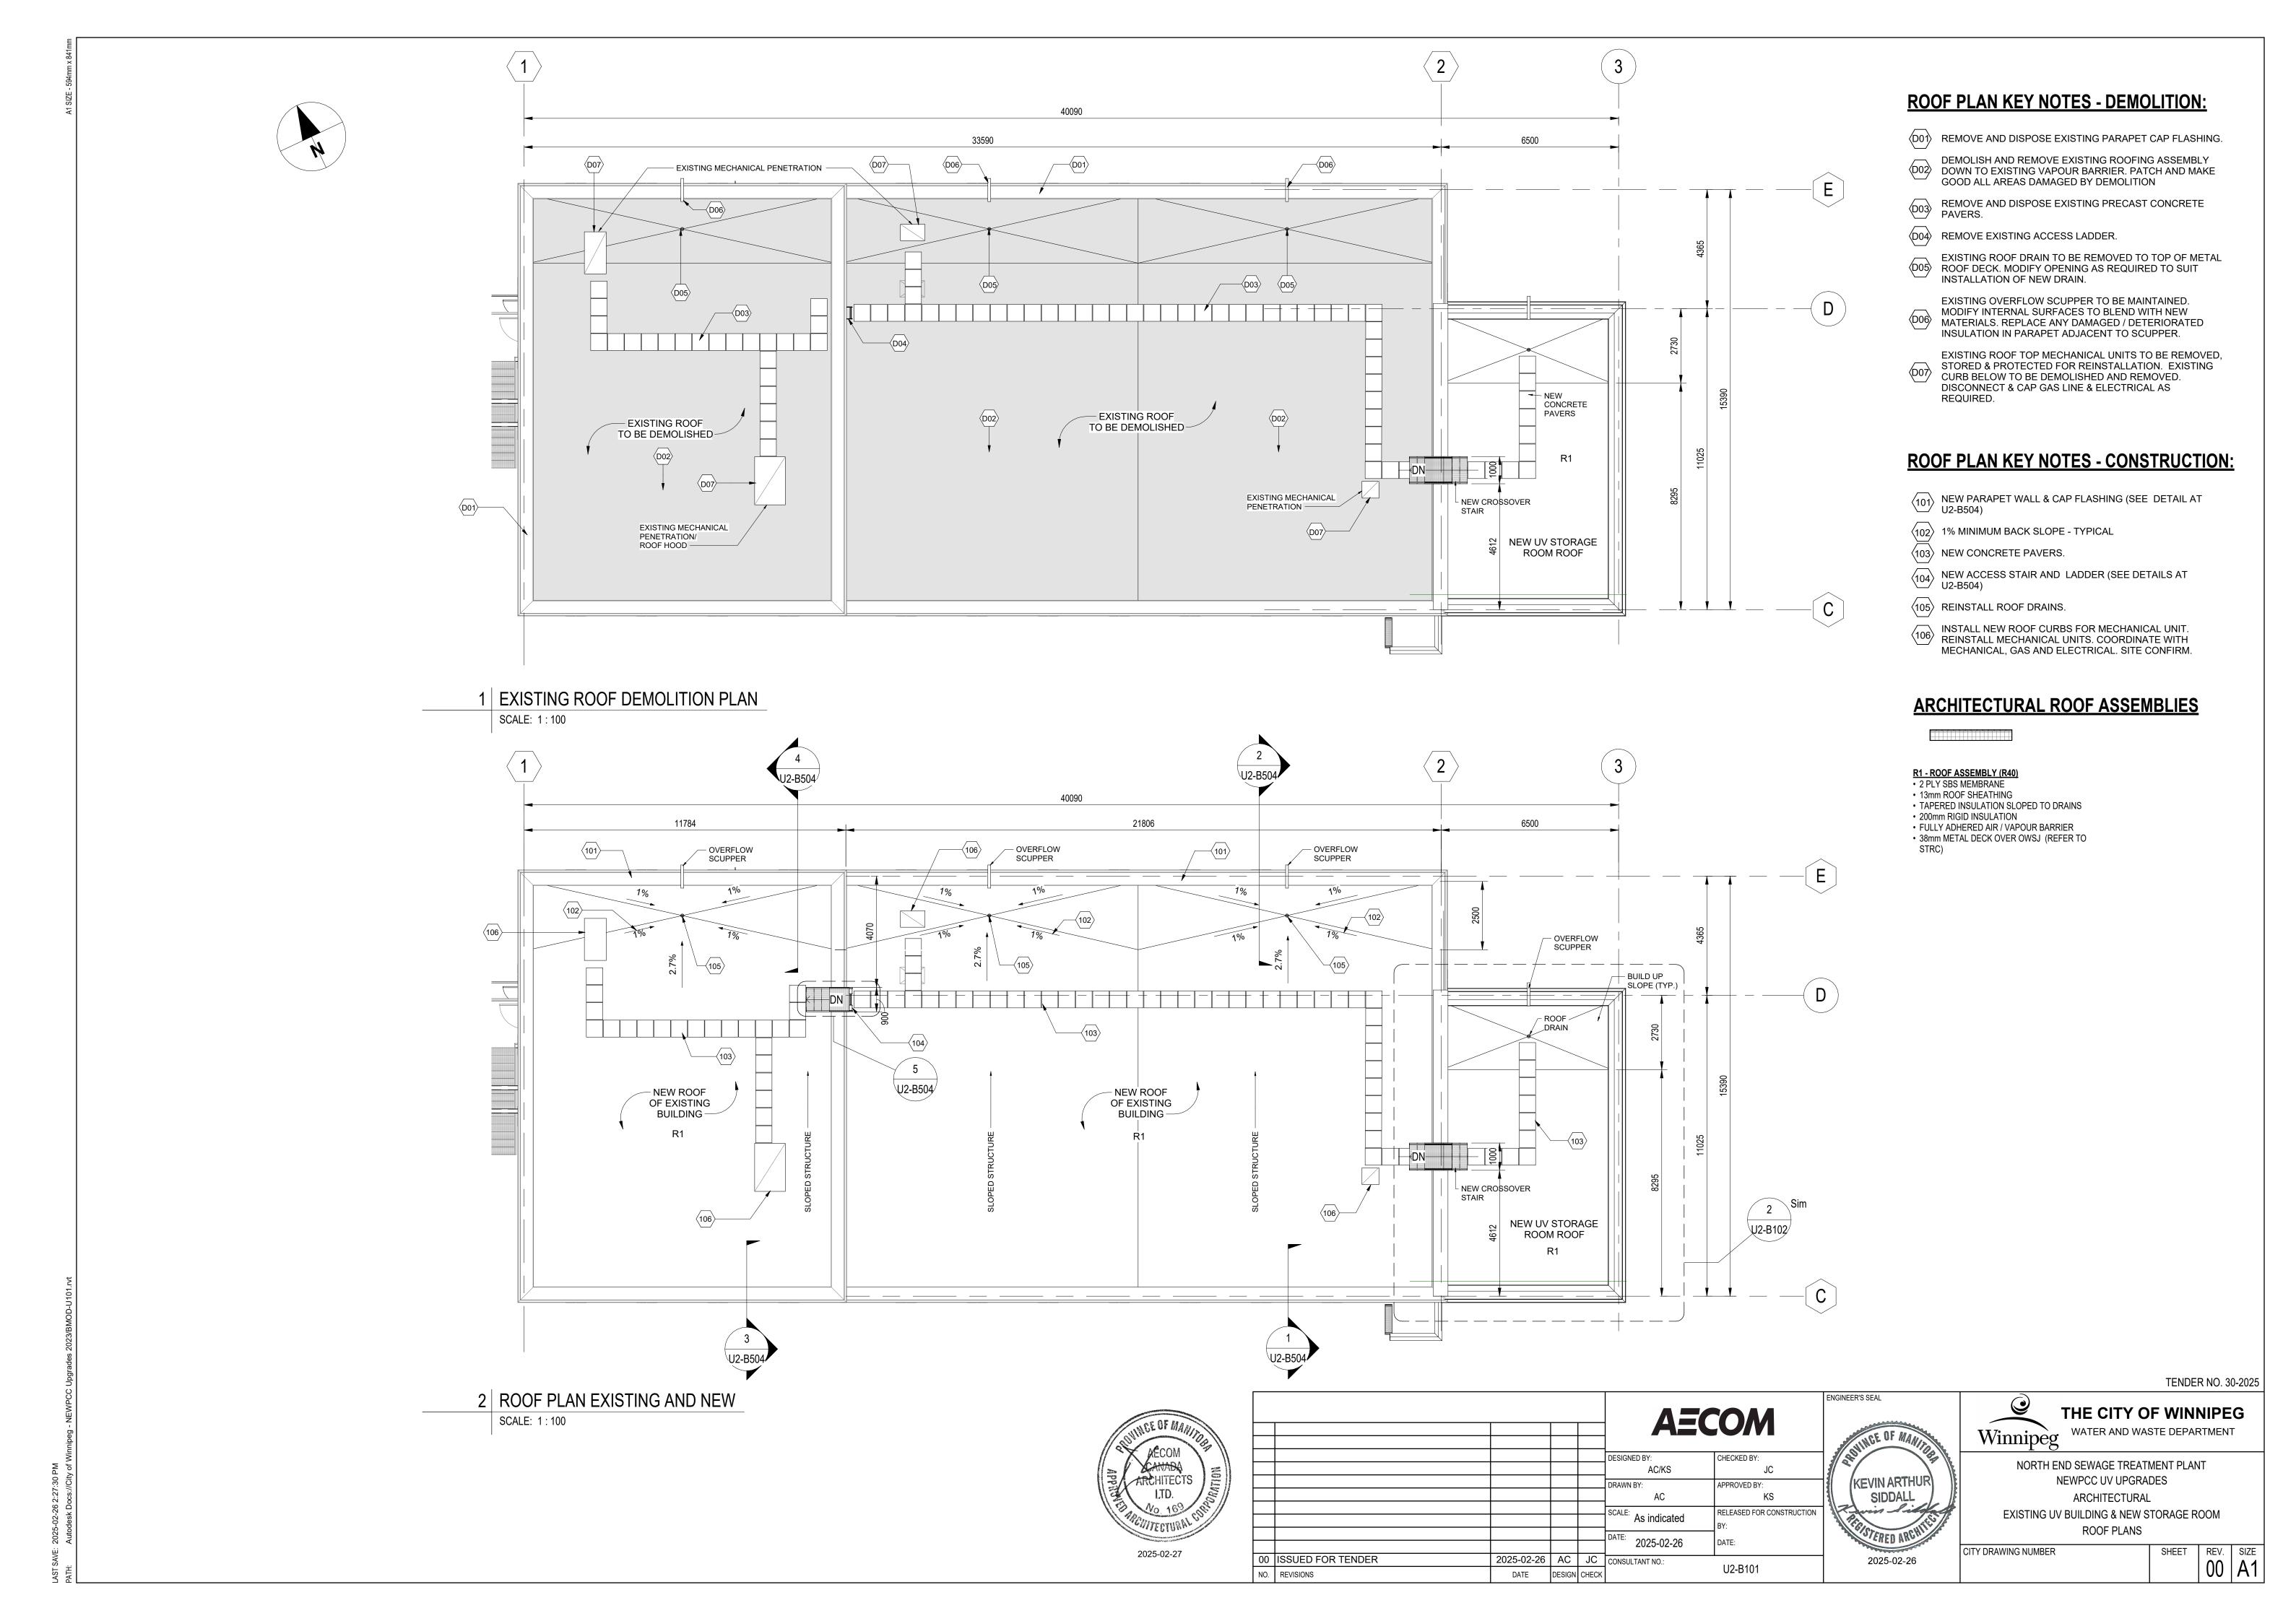


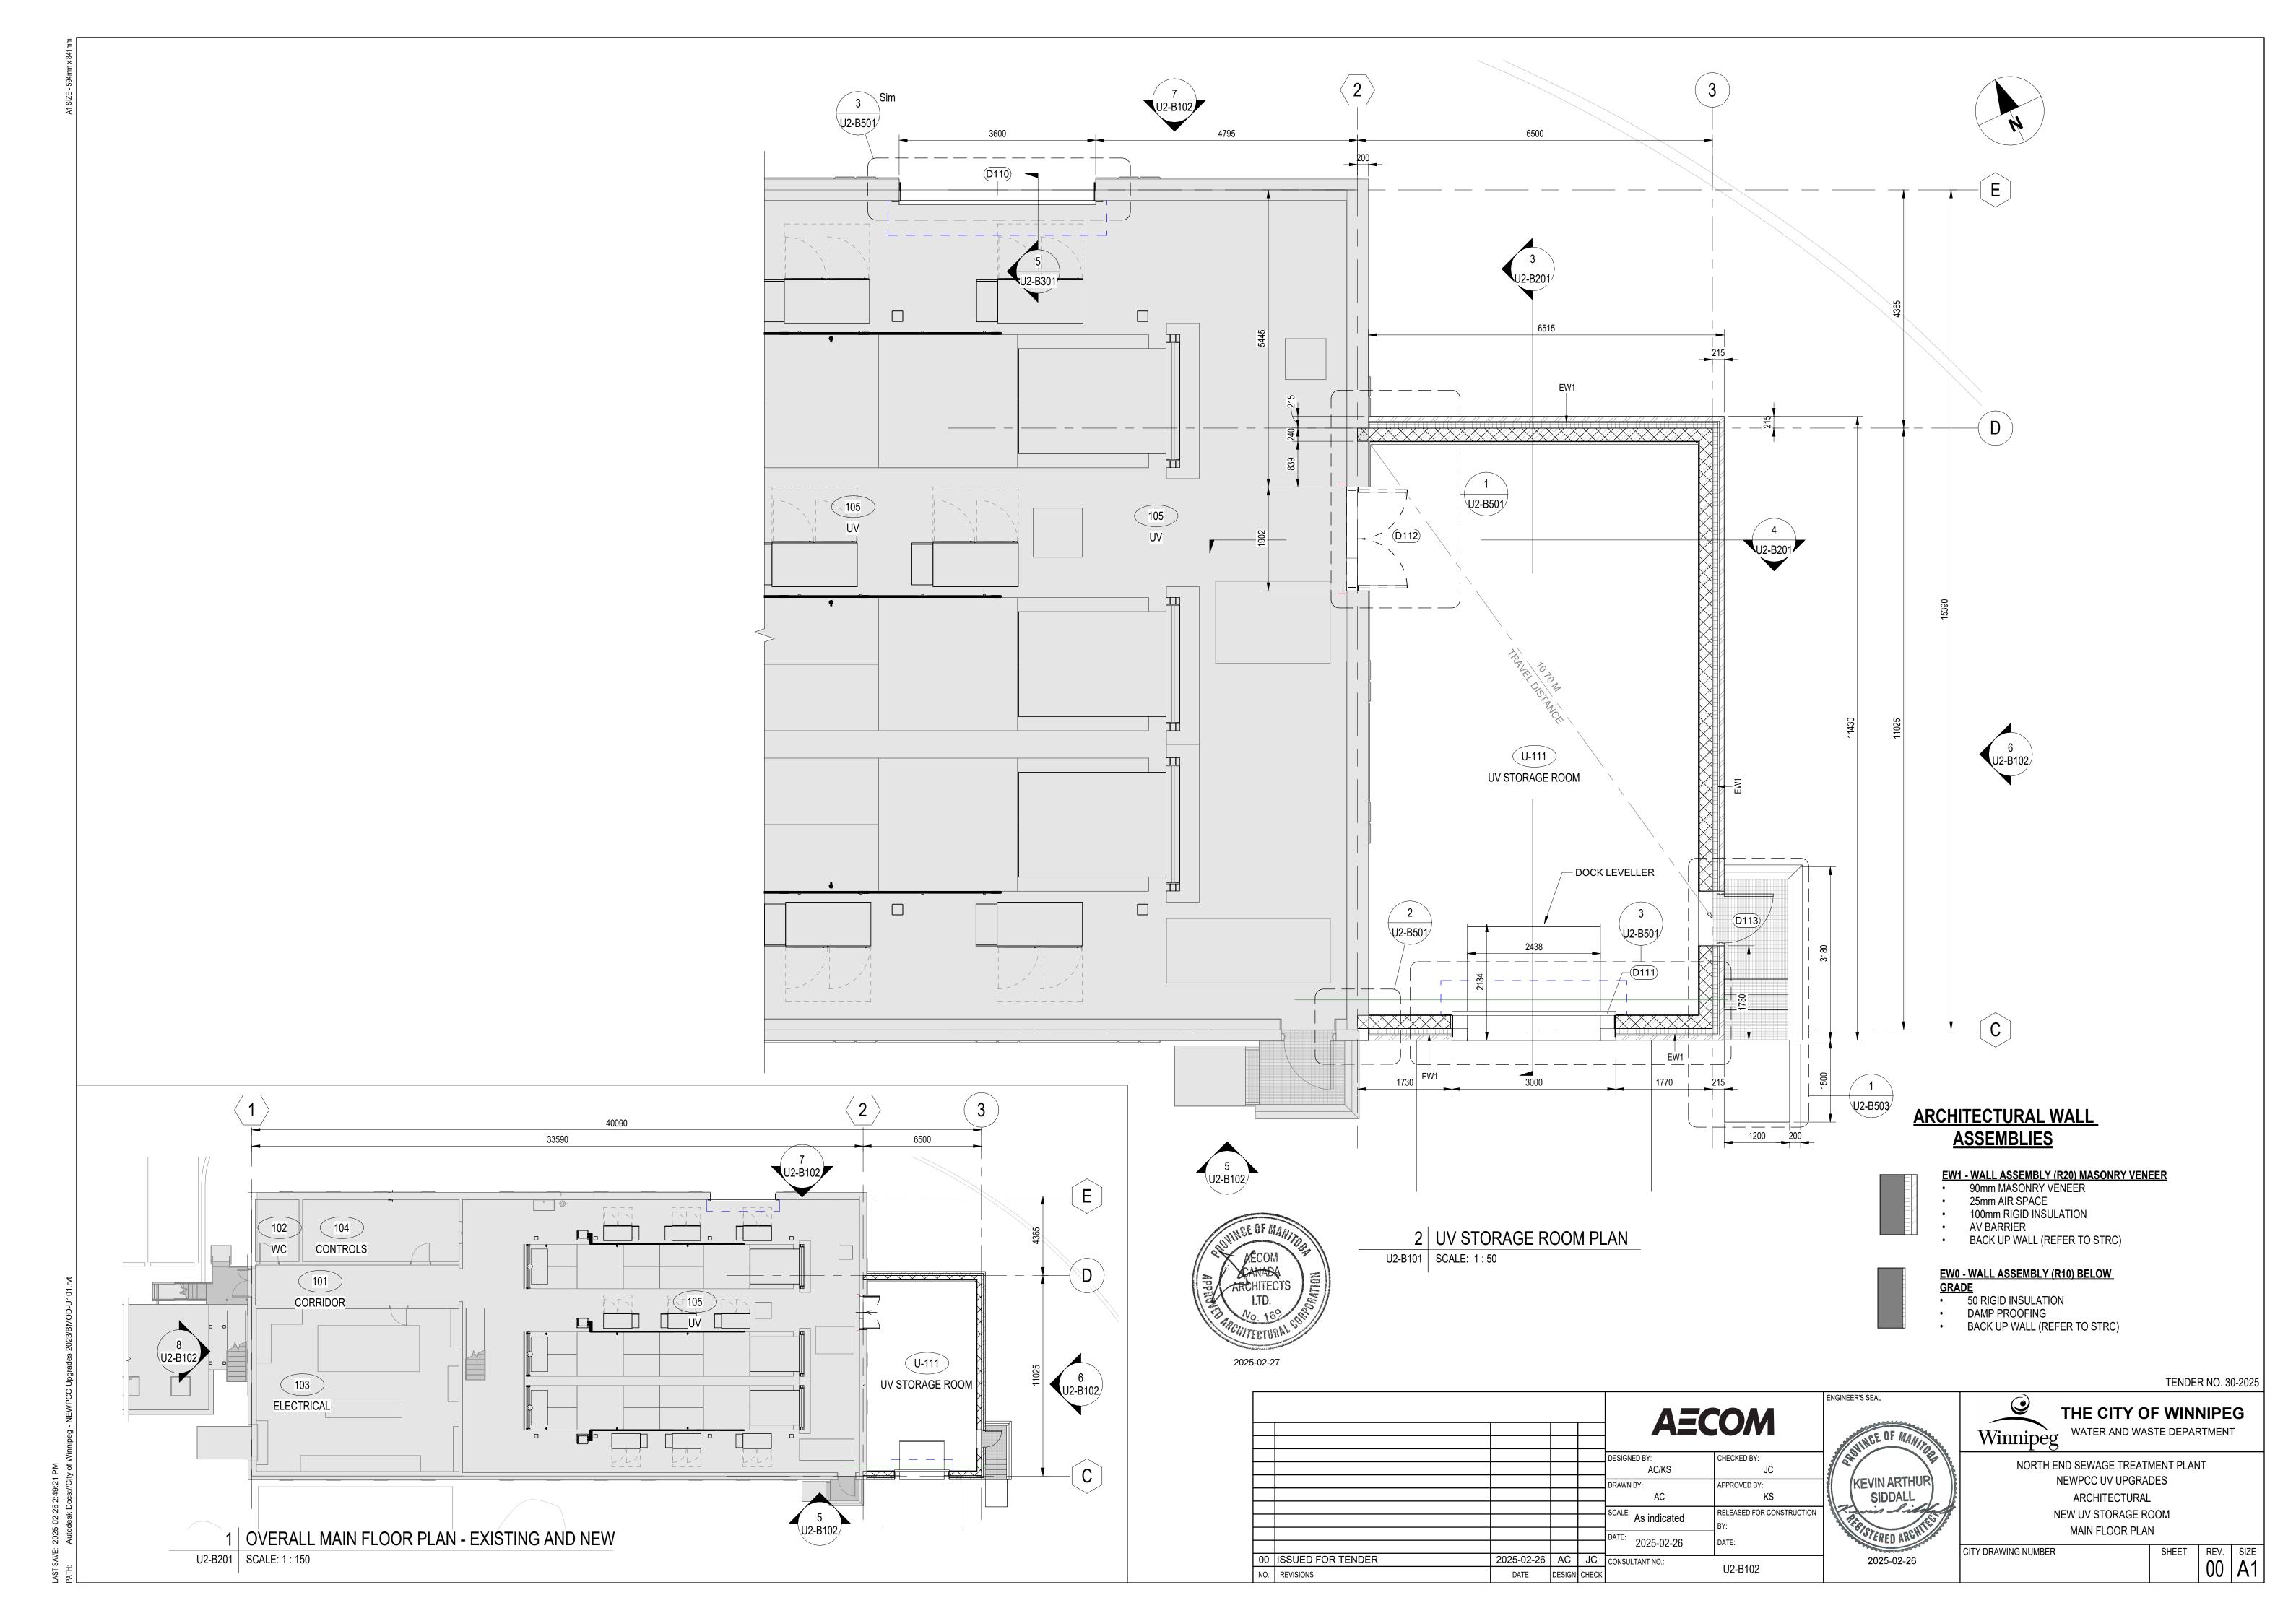


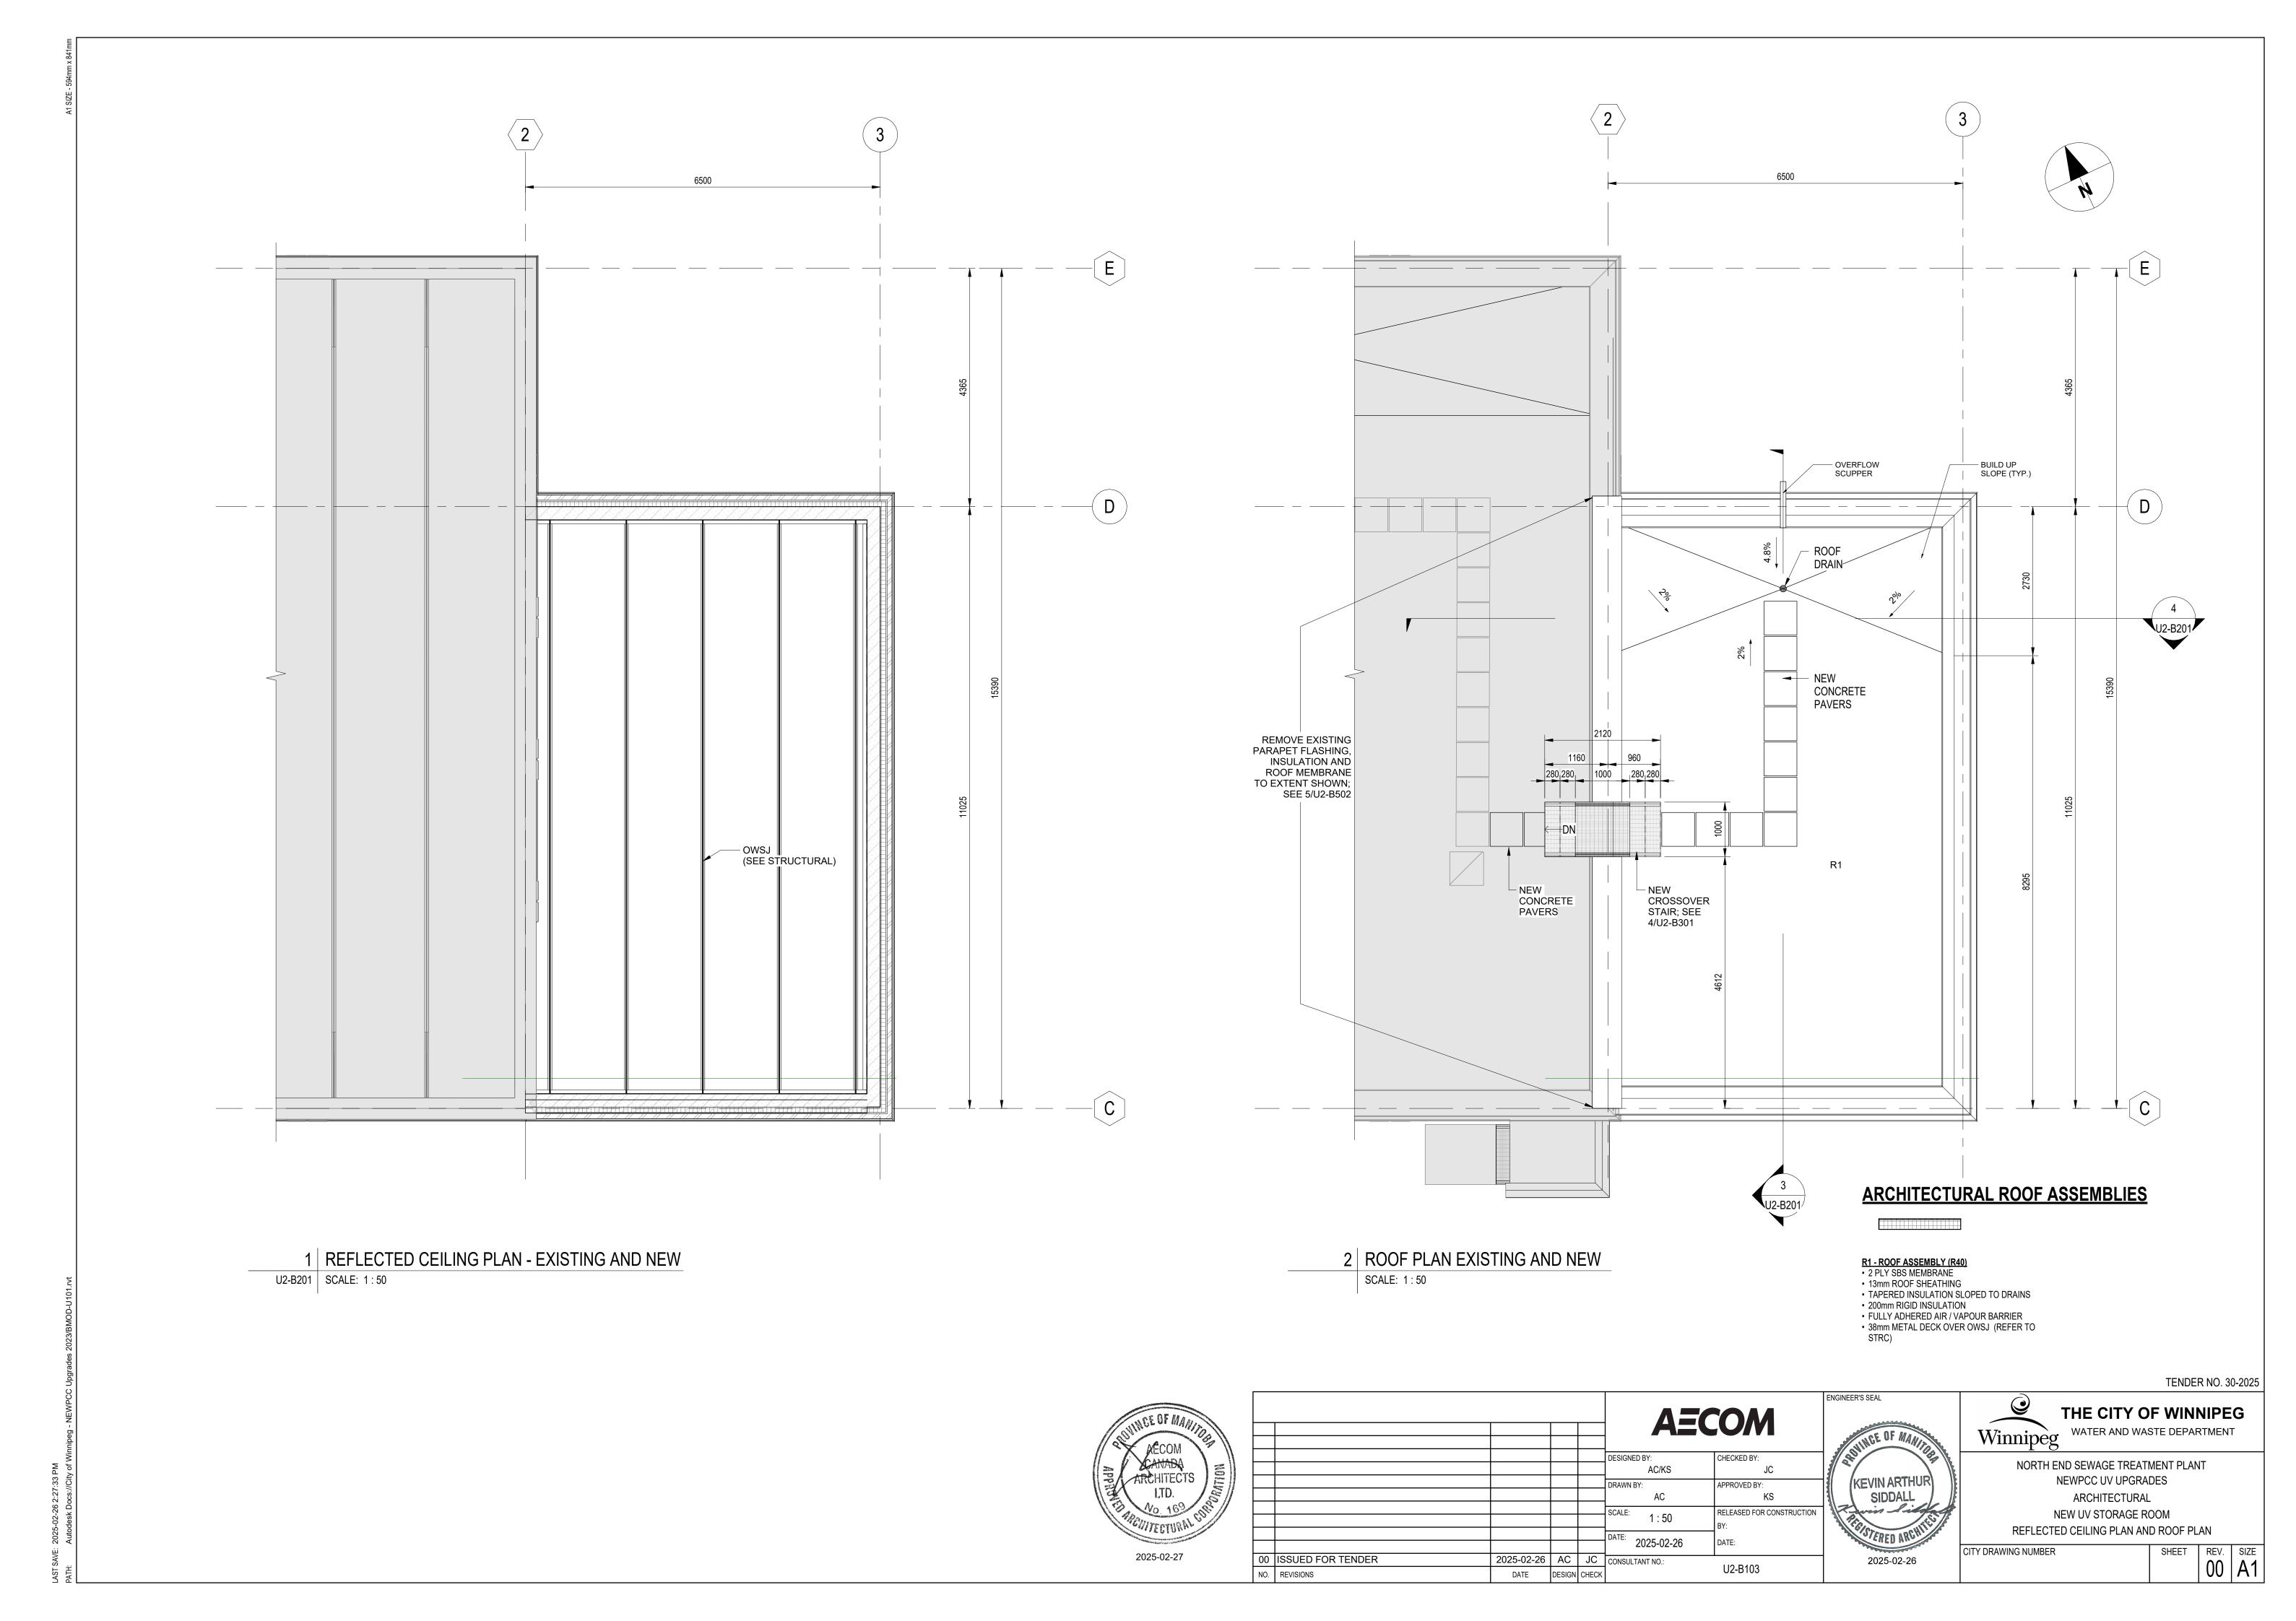


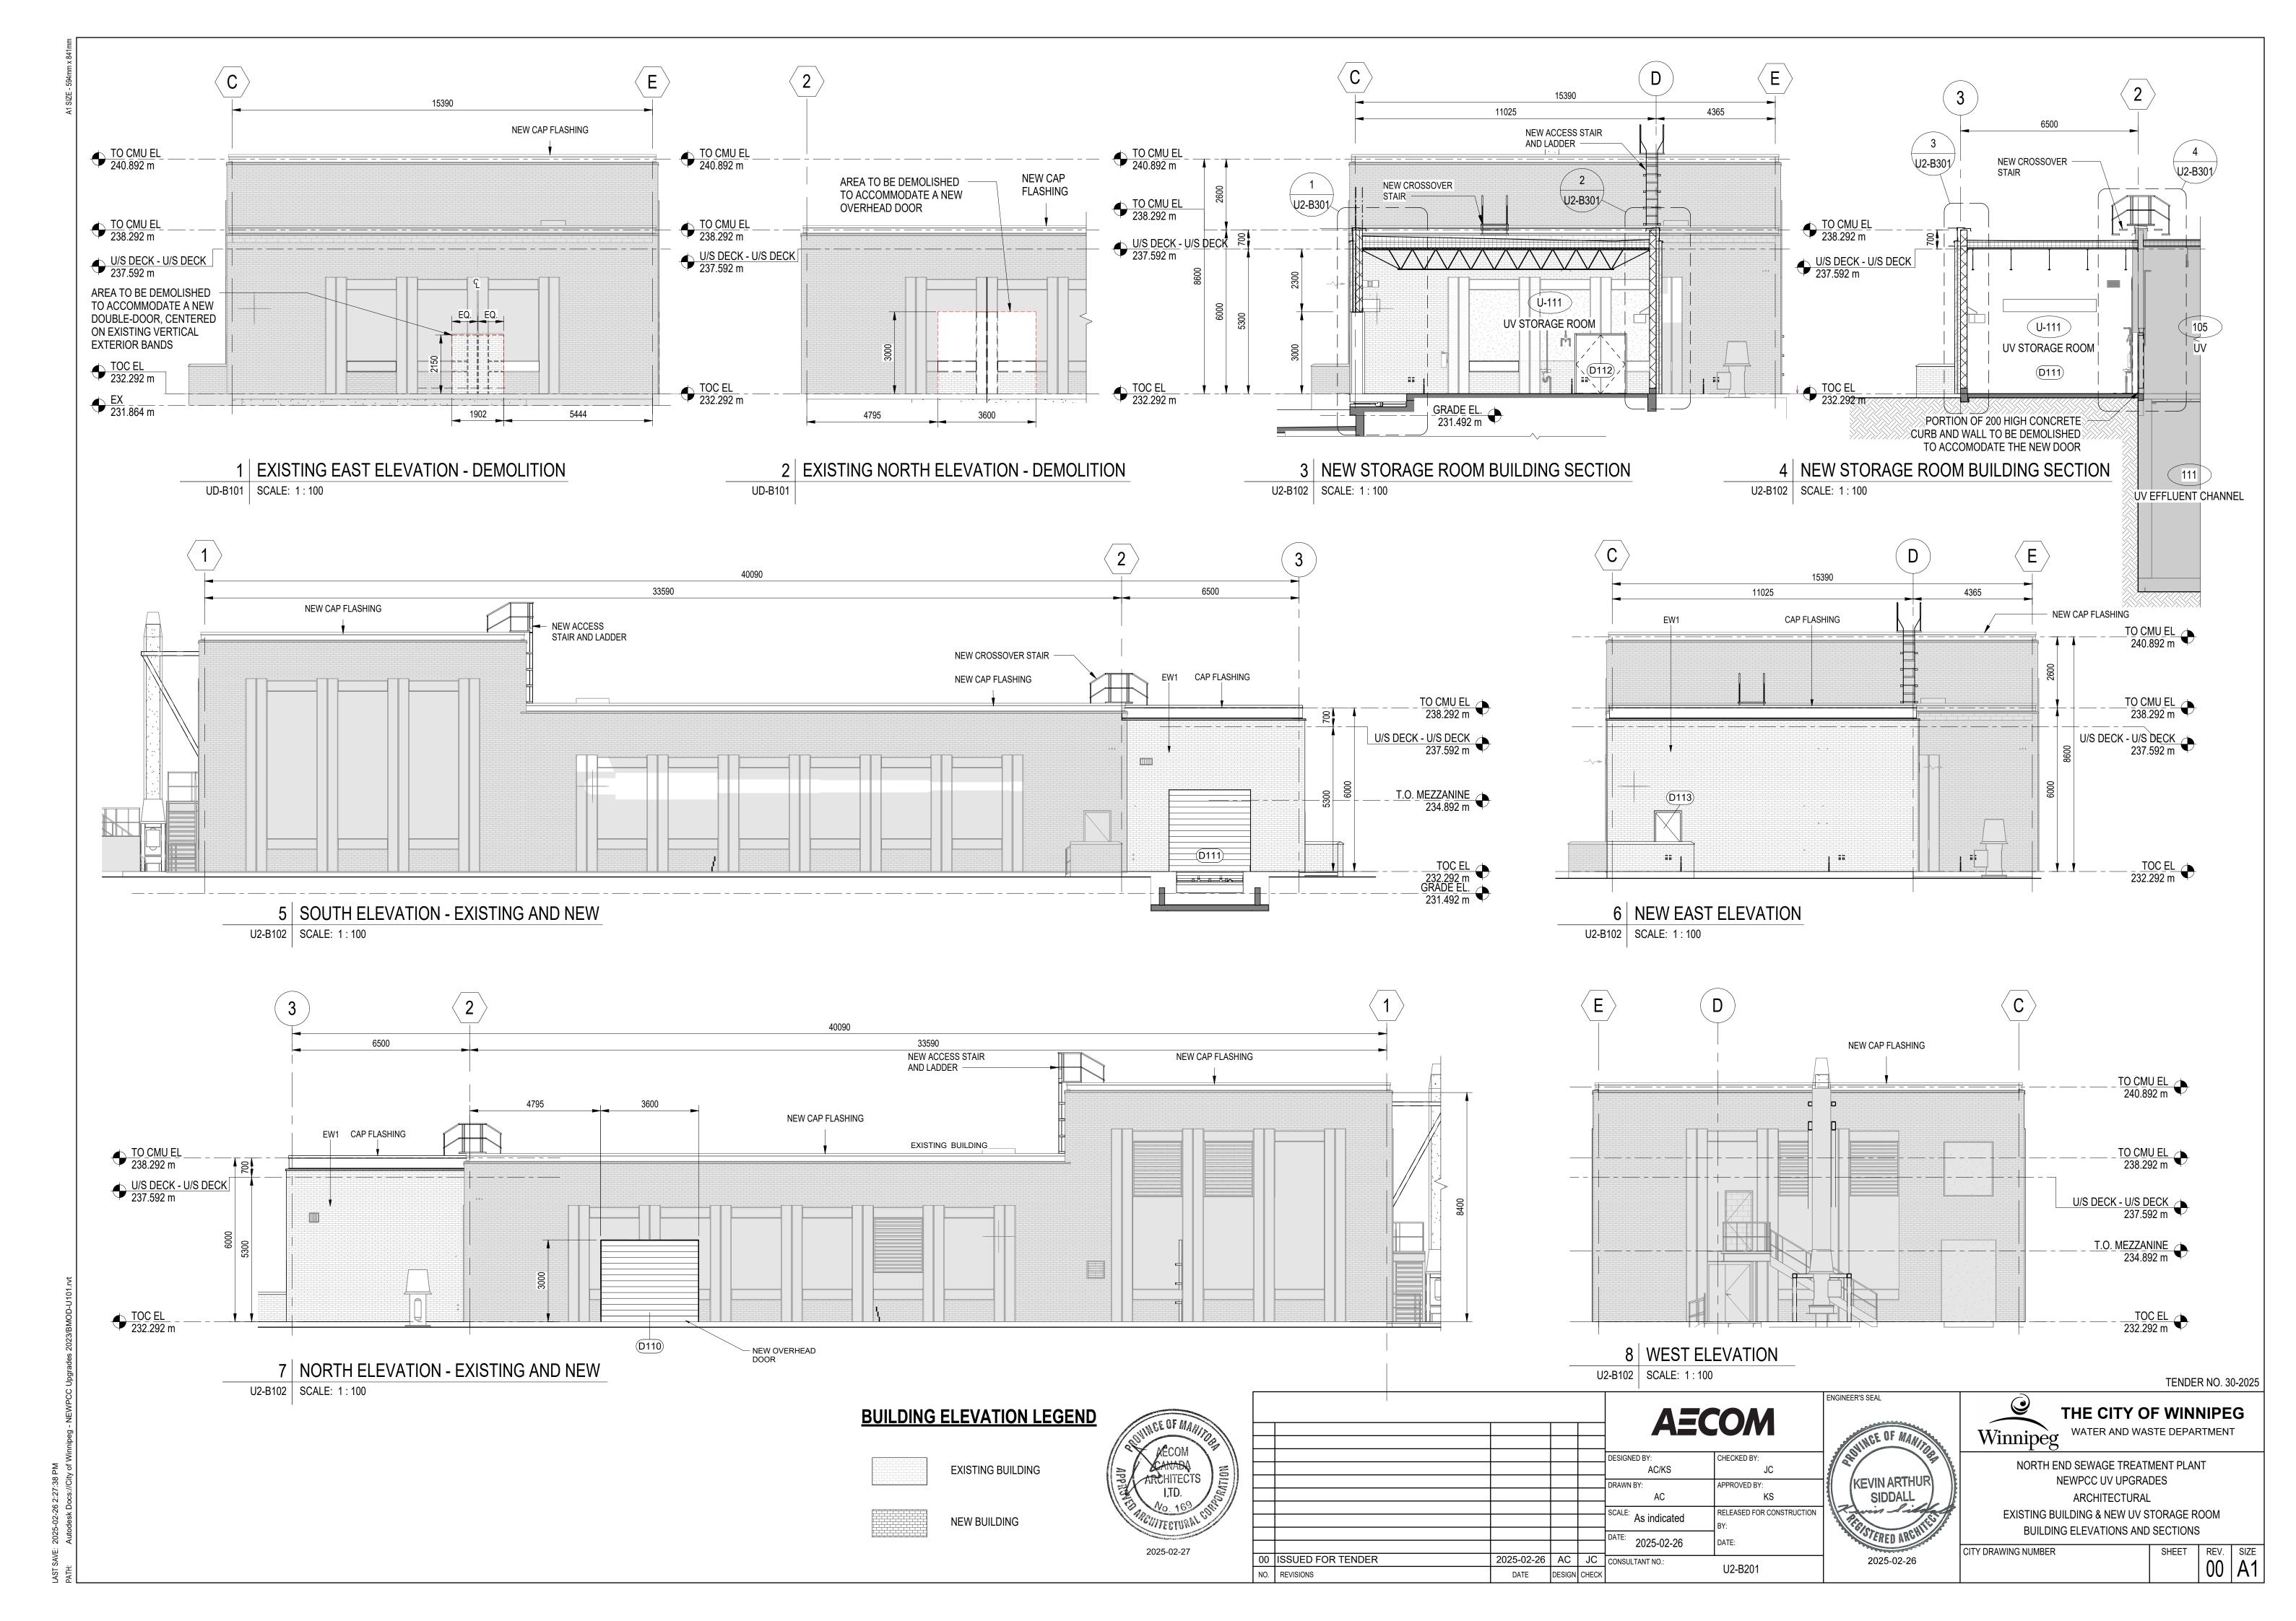


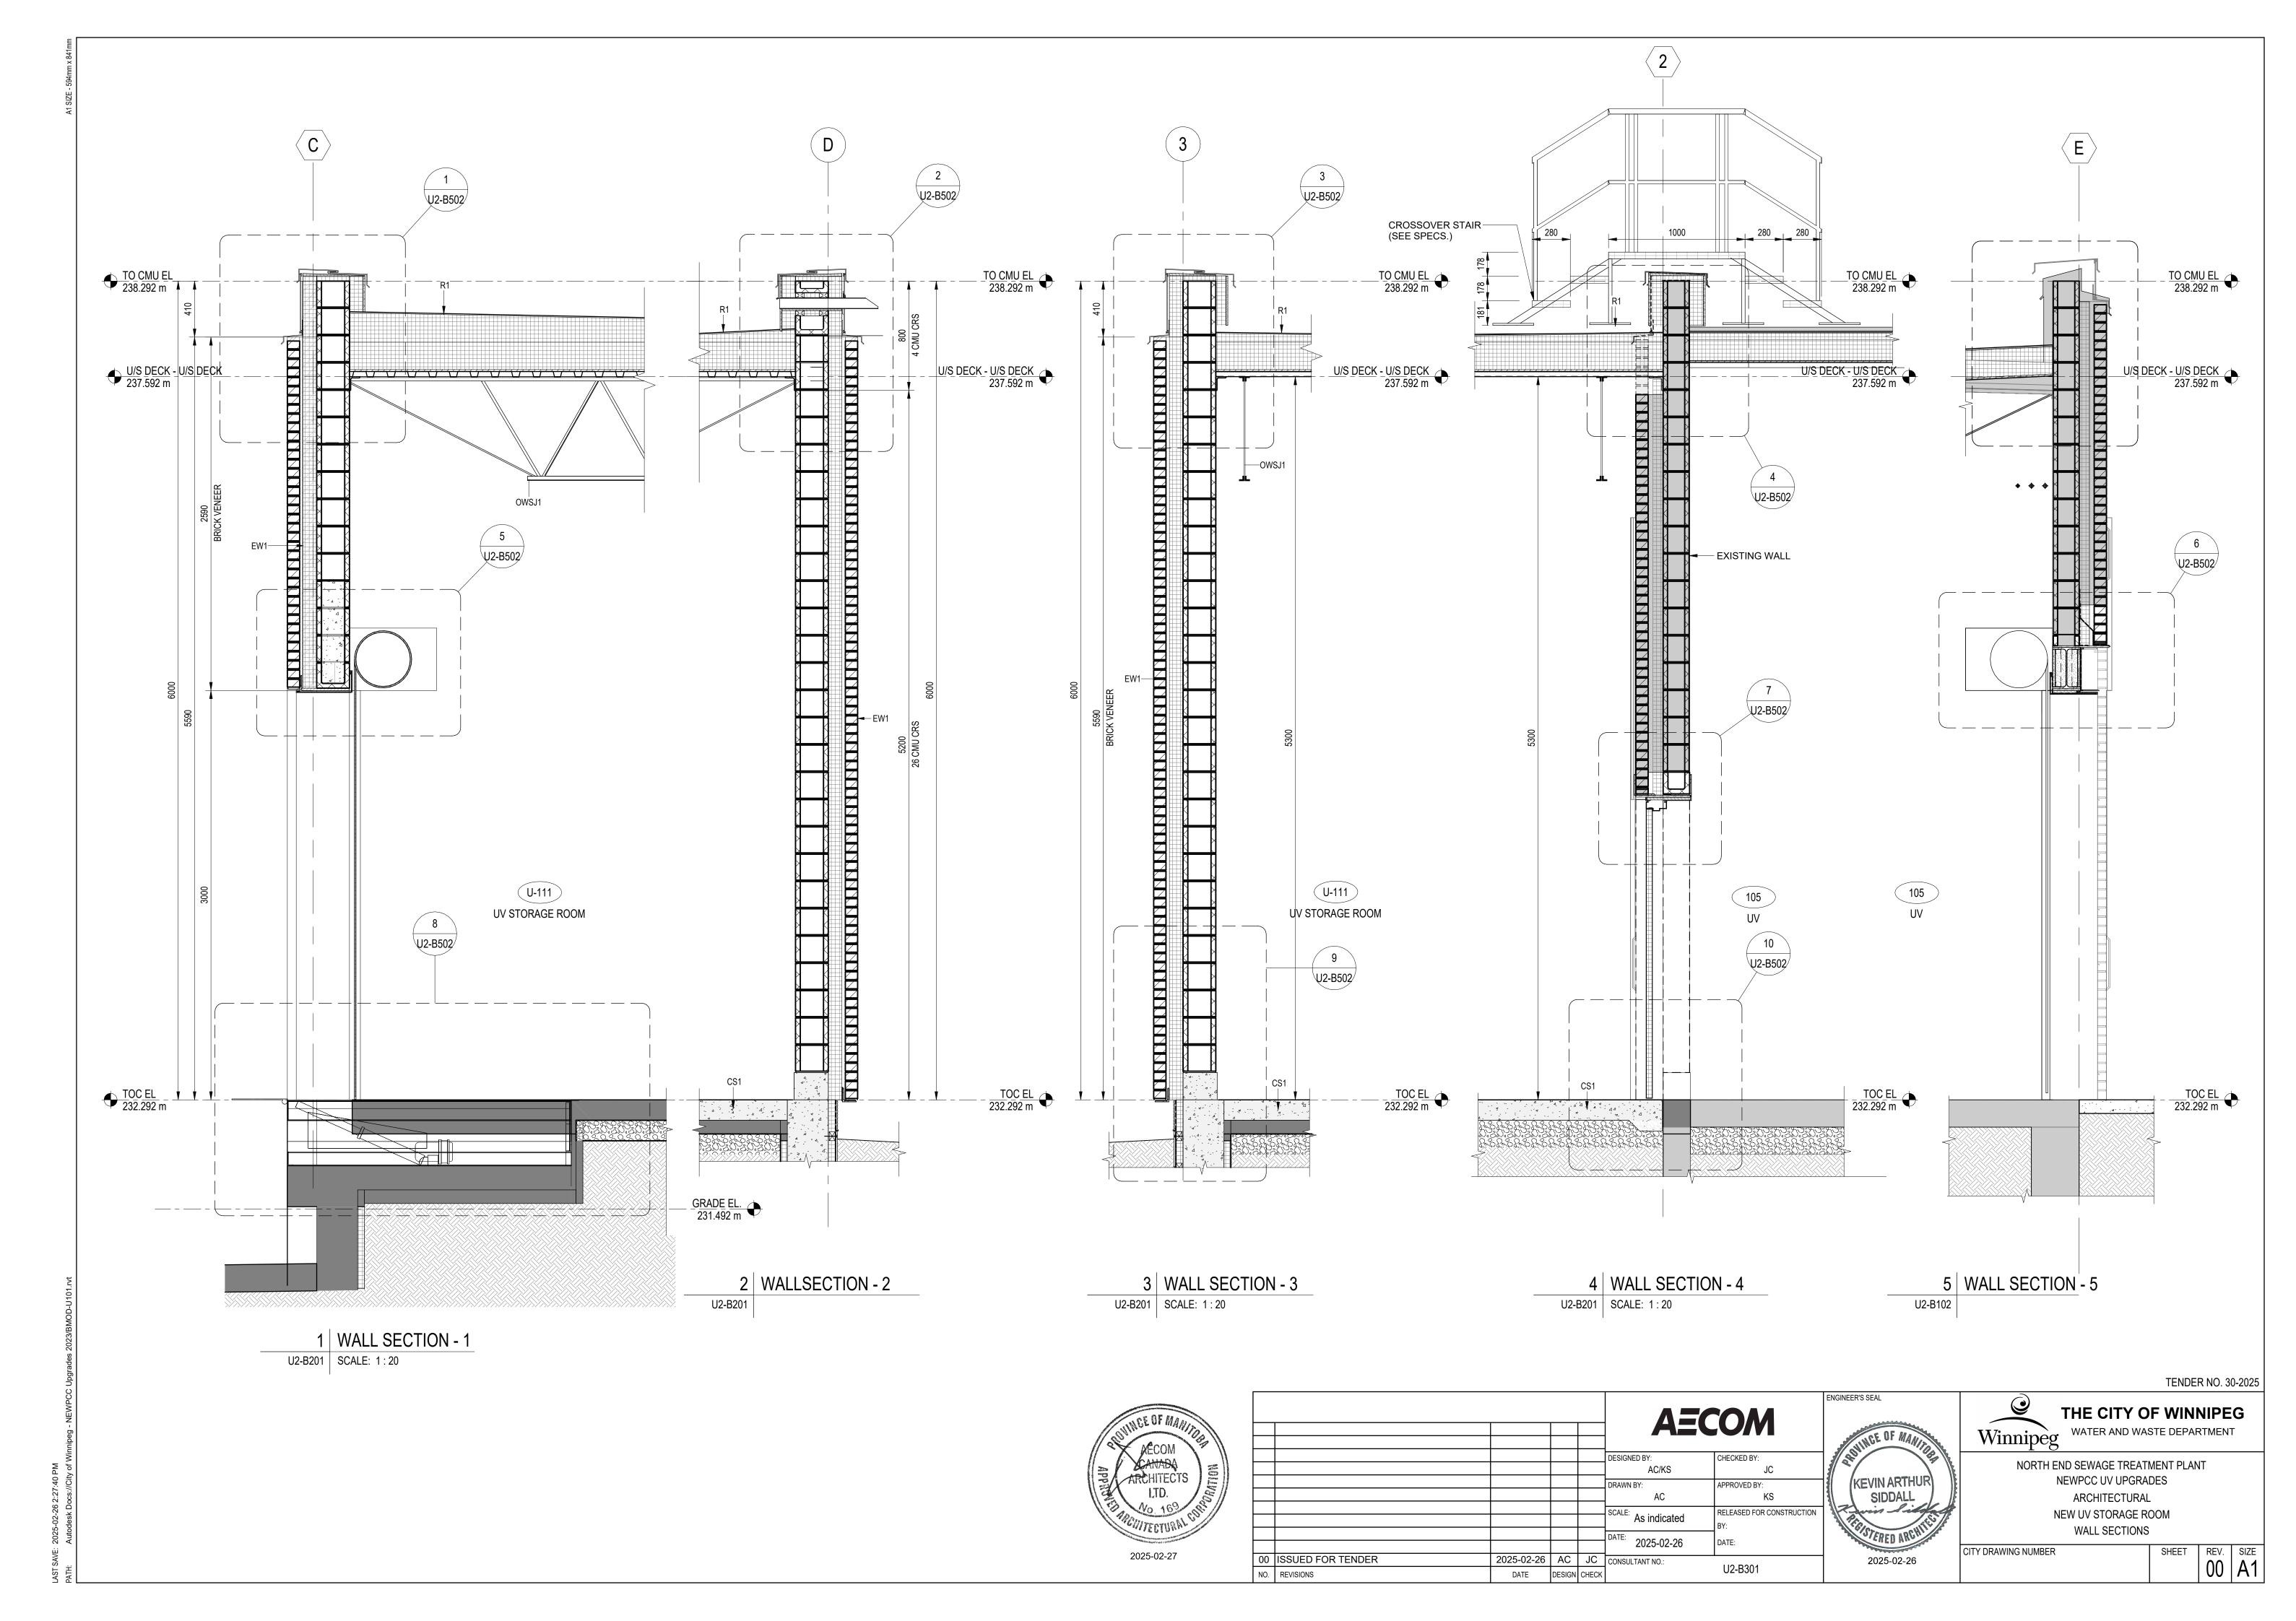

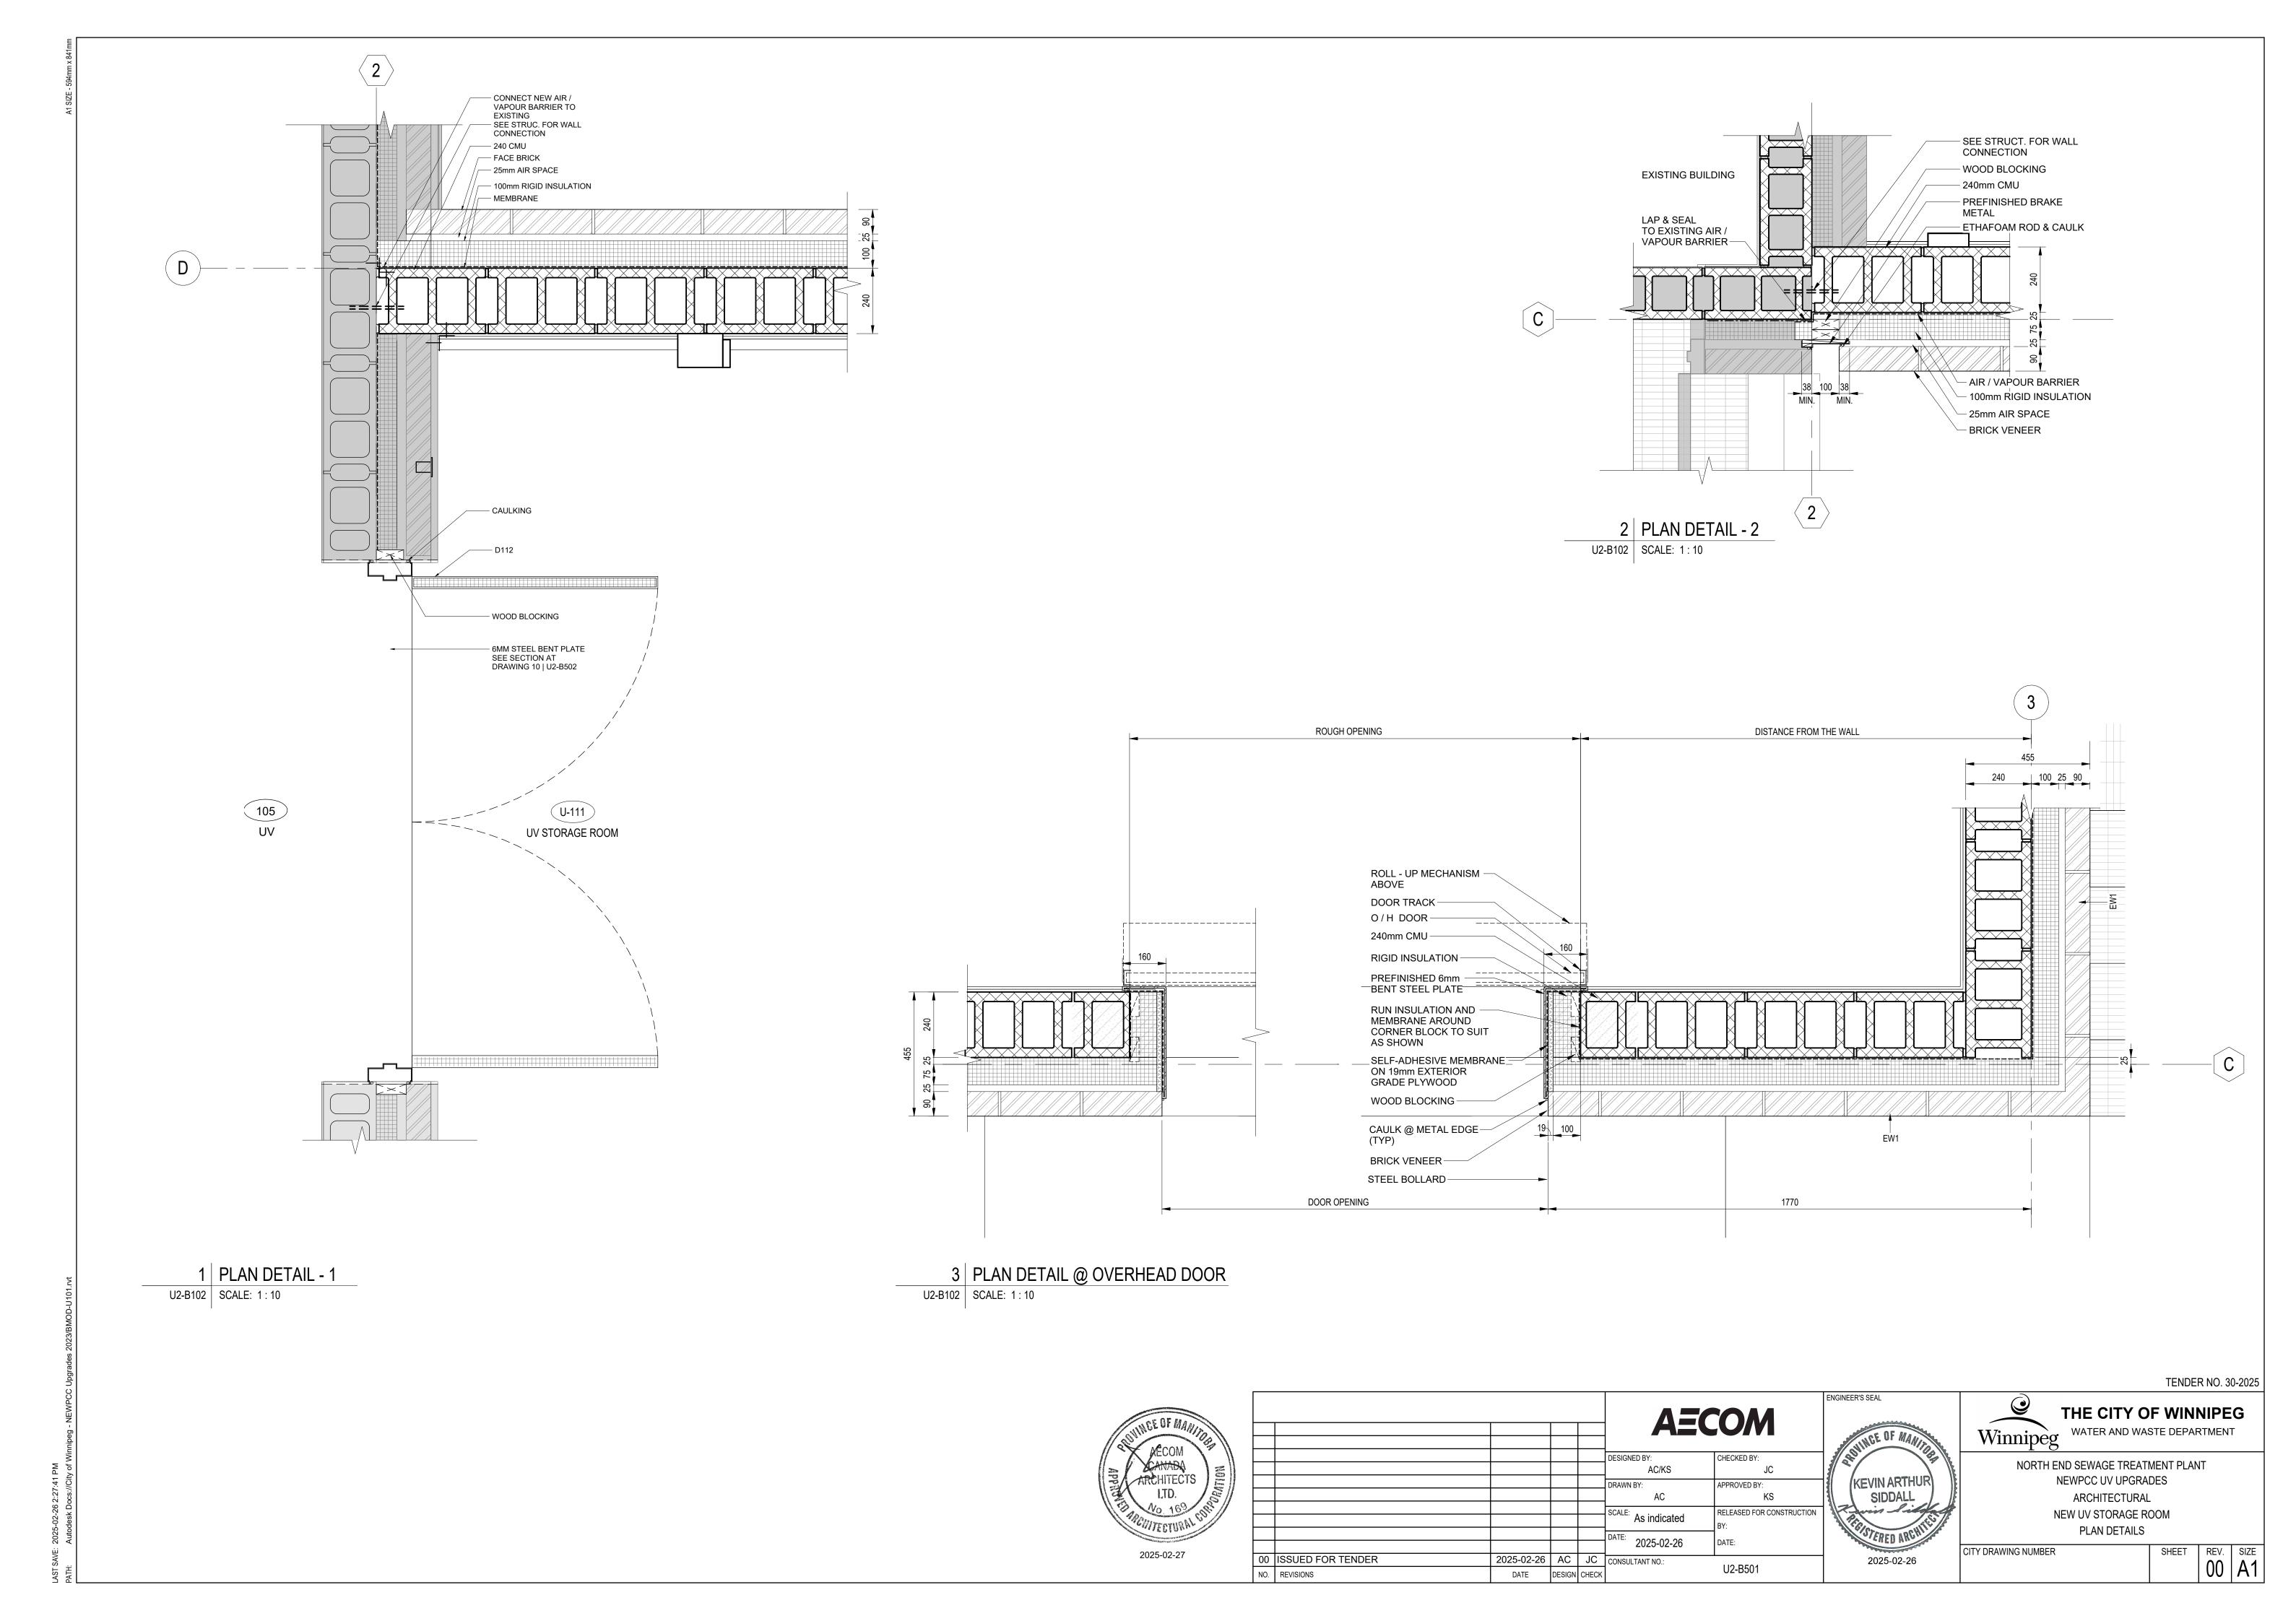


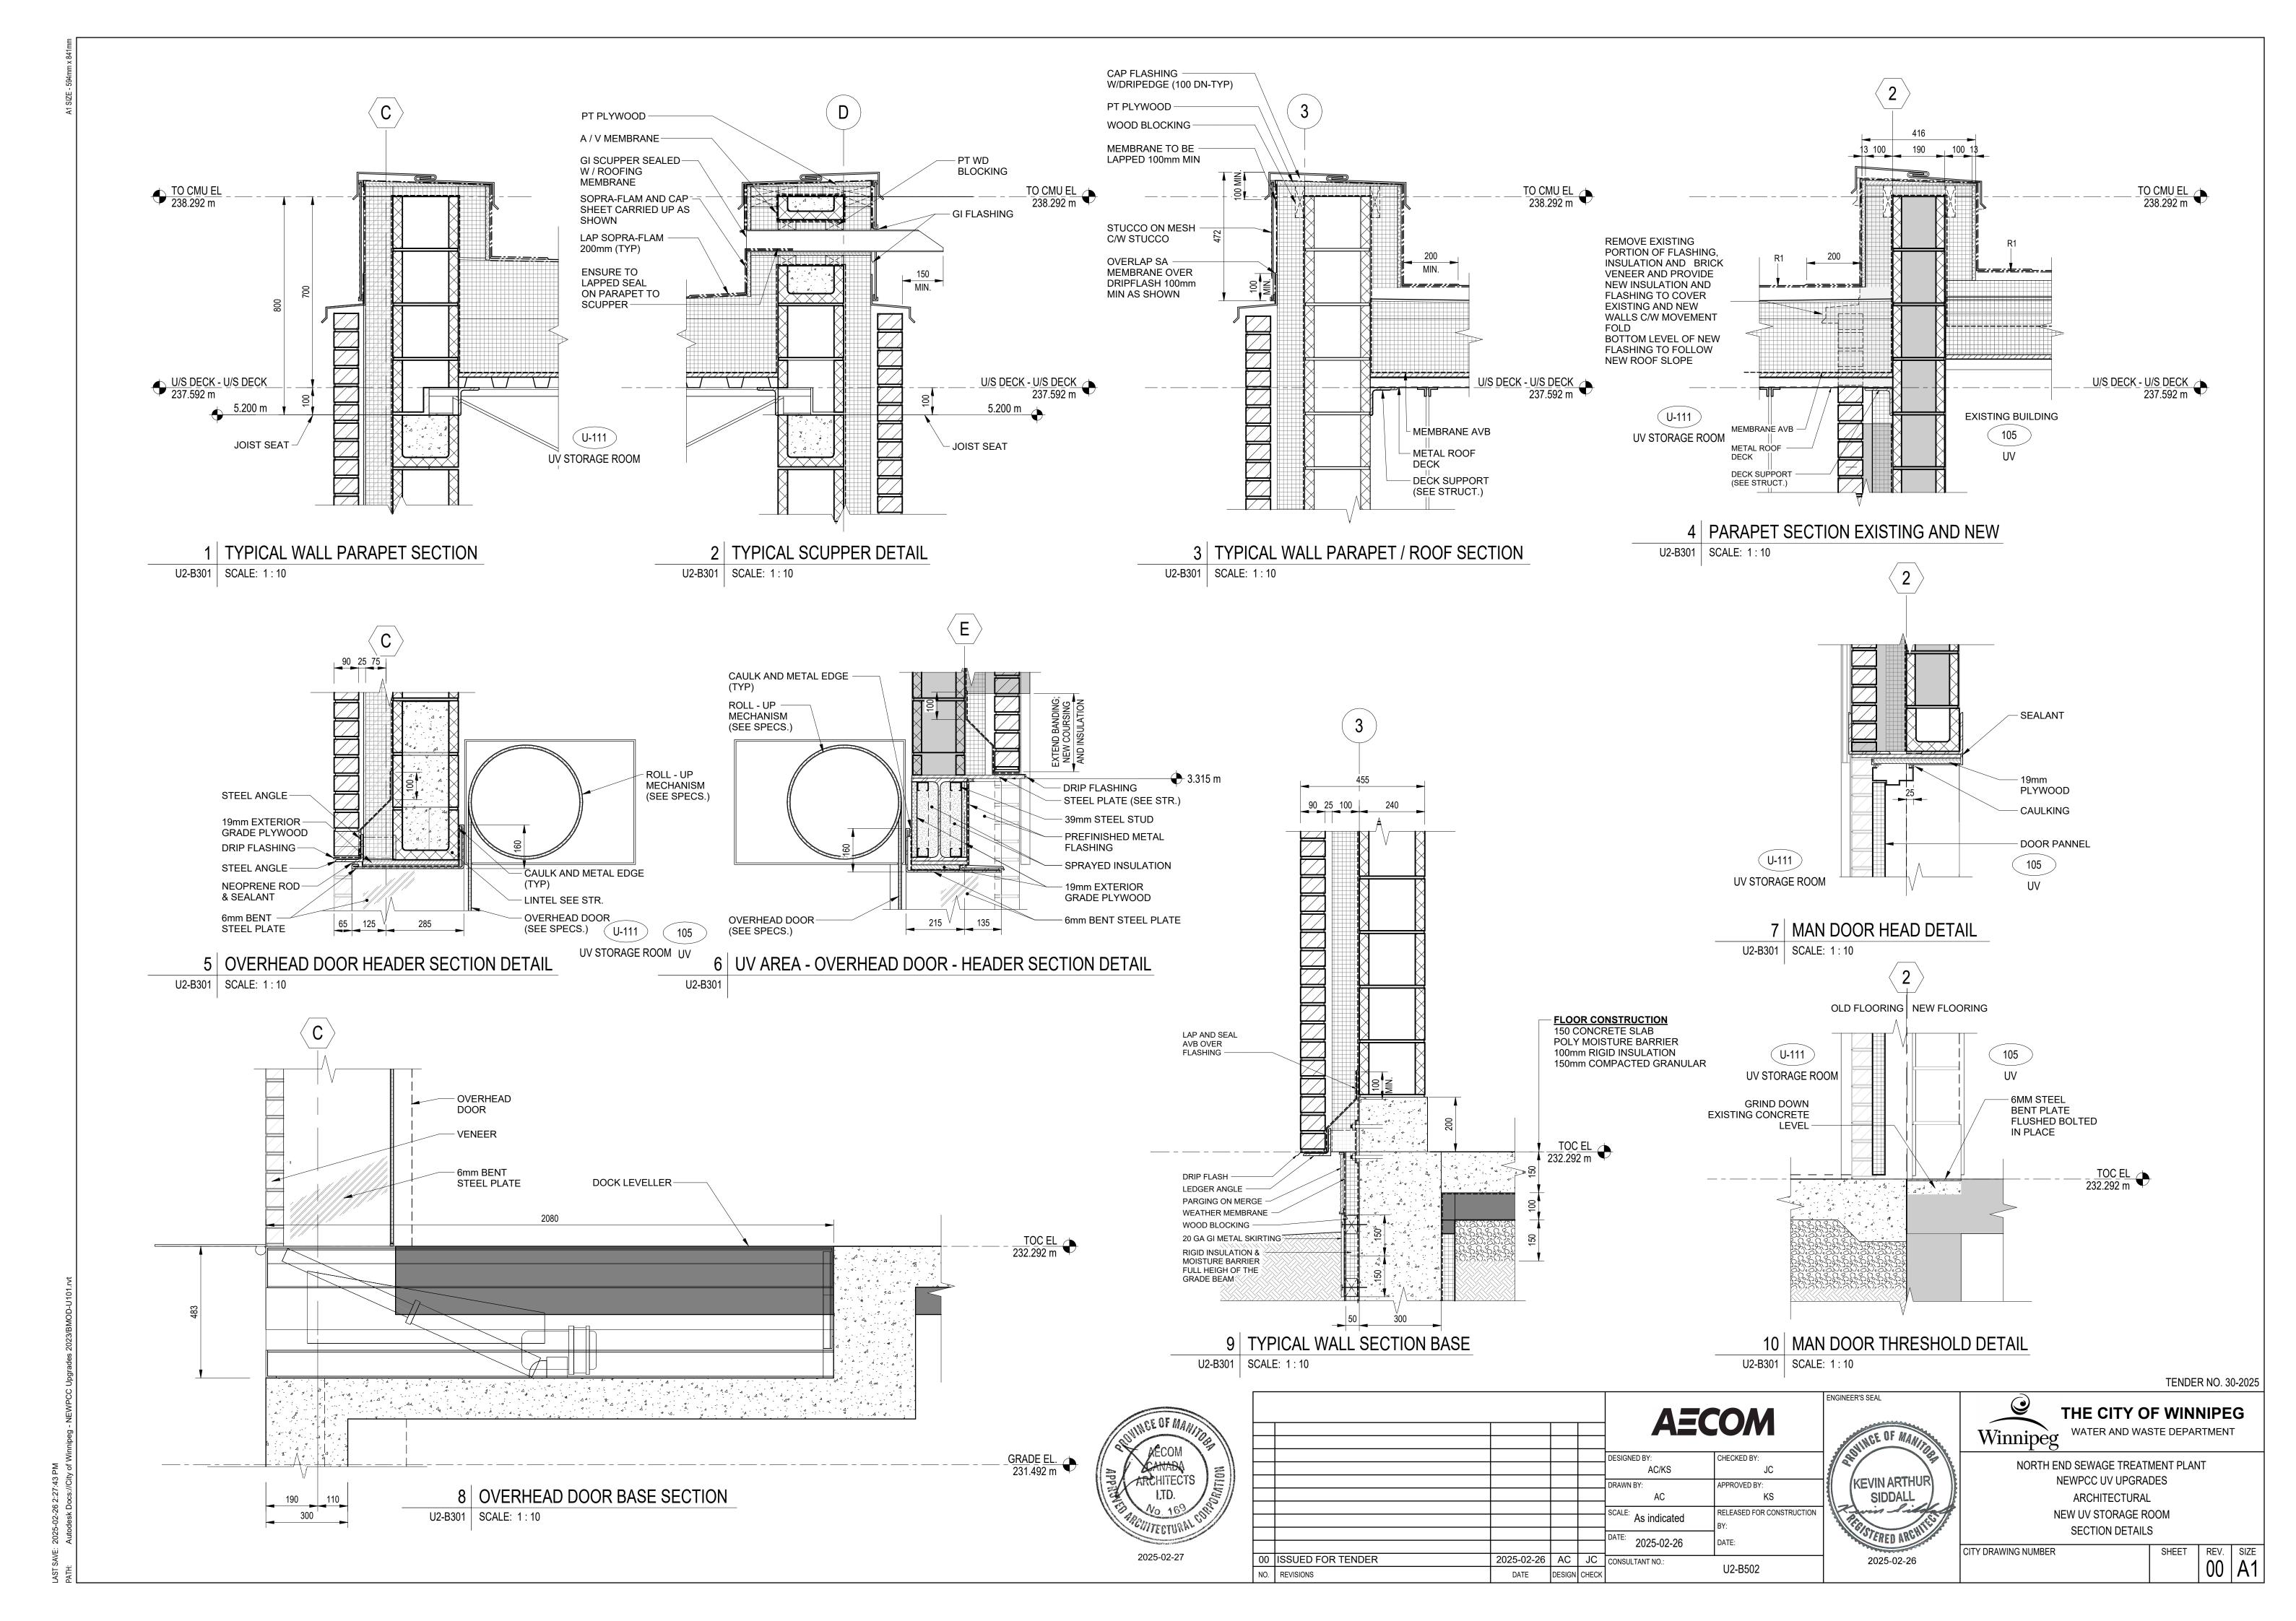


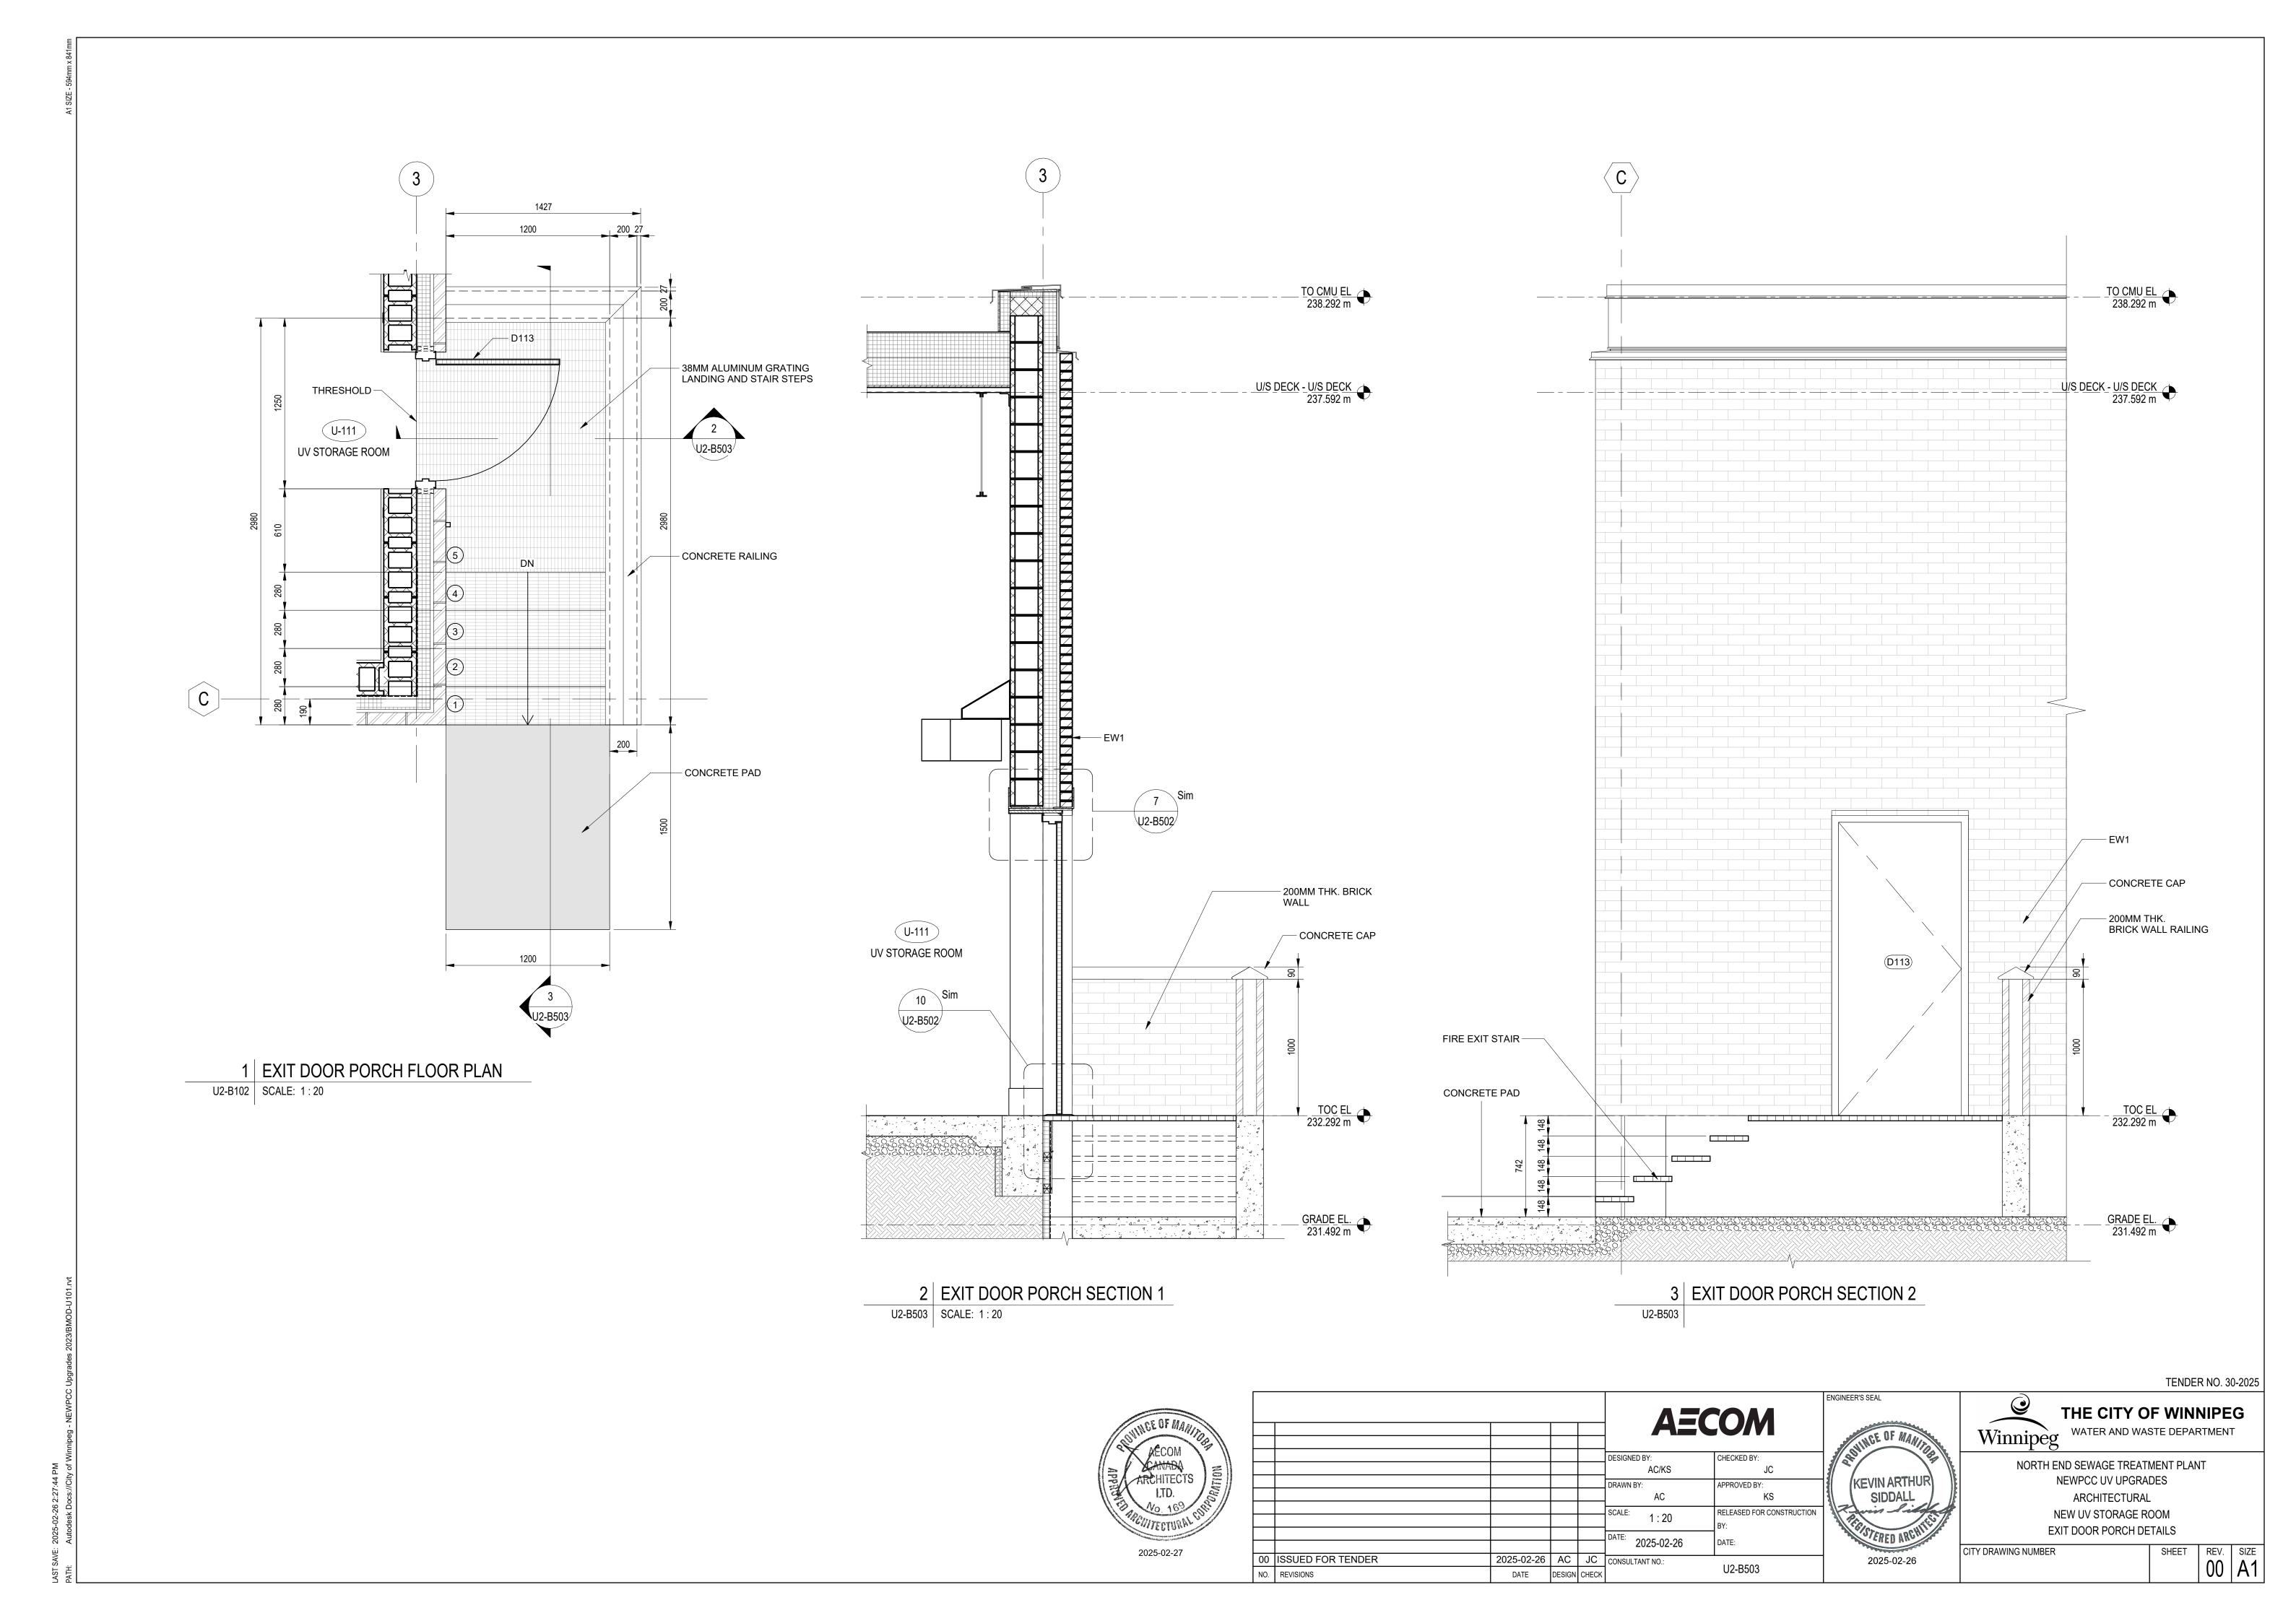

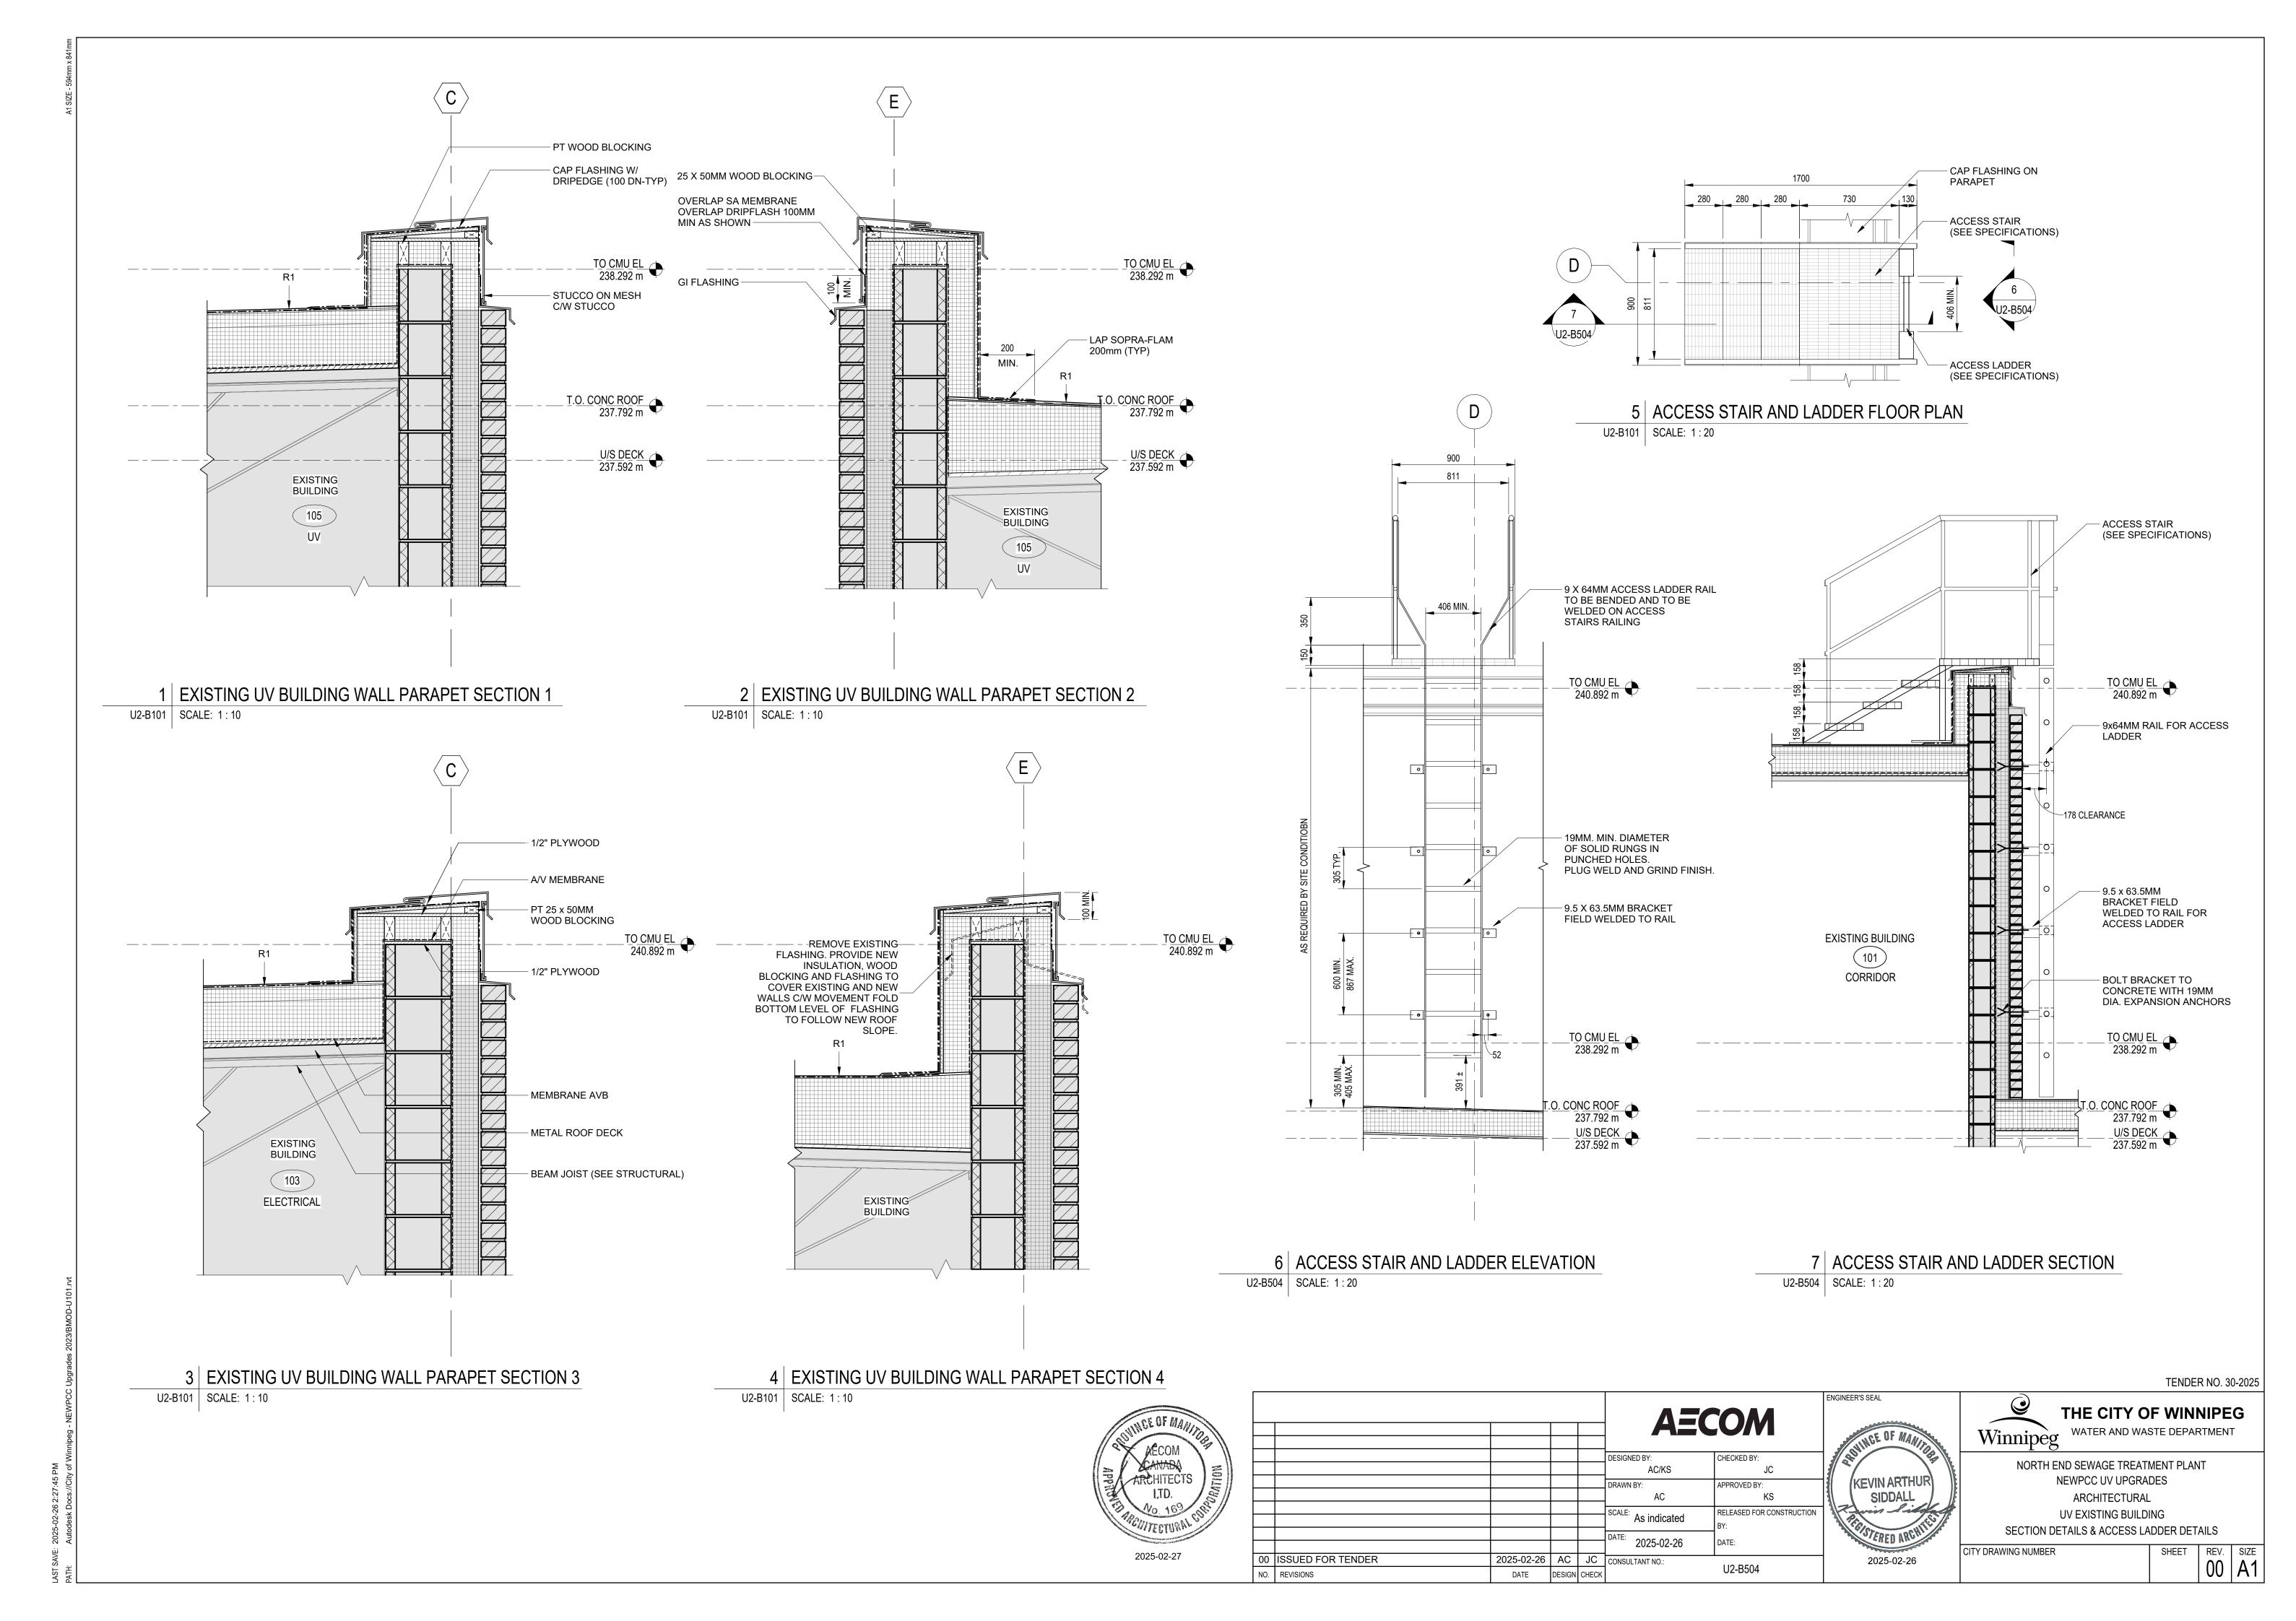

	DOOR SCHEDULE														
DOOR						DOOR		F	RAME						
DOOR#	ROOM NAME	DOOR TYPE	WIDTH	HEIGHT	THICK	DOOR MAT	CORE	DOOR FIN	FRAME TYPE	FRAME MAT	FRAME FIN	COLOR	HWD GROUP	FIRE RATING	COMMENTS
D110	UV	2A	3600	3000	80	COILING	PREFINISHED	PREFINISHED	N/A	N/A	PREFINISHED	PREFINISHED	N/A	N/A	
D111	UV STORAGE ROOM	2B	3000	3000	80	PANEL	PREFINISHED	PREFINISHED	N/A	N/A	PREFINISHED	PREFINISHED	N/A	N/A	DOOR #: OD-U5050 PER ELECTRICAL
D112	UV STORAGE ROOM	1	1800	2150	44	НМ	INSUL	PT	2	HM	PT	A	1	3/4 HR	
D113	UV STORAGE ROOM	3	900	2150	44	HM	INSUL	PT	2	HM	PT	A	1	3/4 HR	

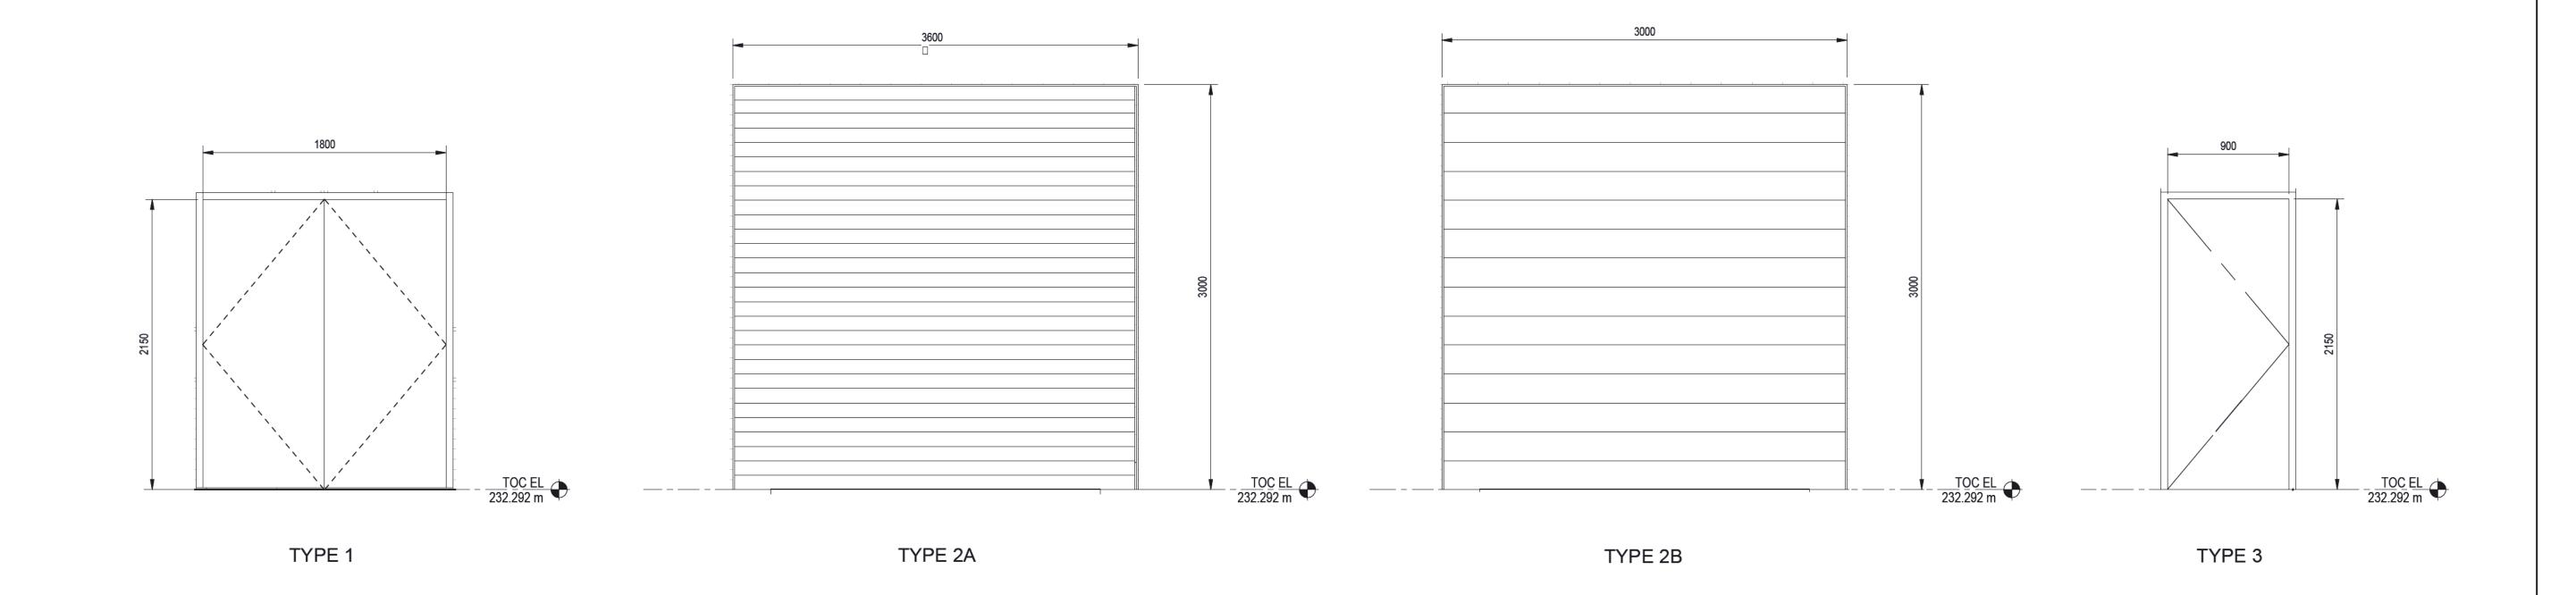

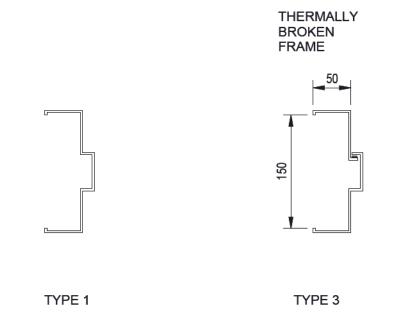

HARDWARE SCHEDULE

GROUP 1 D 112

6	6	BUTT HINGES	TA 314 114.30MM X 101.6MM (4 1/ 2" x 4") NRP	Mc KINNEY	26D
1	ı	LOCKSET	au5407 x ASA	YALE	26D
2	2	FLUSHBOLTS	F65	STANDARD METAL	26D
2	2	FLOOR STOP	S113	STANDARD METAL	26D
1		DOOR SWEEP	W245 - 914.40MM (36")	KN CROWDED	CA
1	l	THRESHOLD	CT11 - 1828.80MM (72")	KN CROWDED	CA
1		ASTRAGAL	W40P - 2133.60MM (84")	KN CROWDED	CA
1	l	CLOSER	7500	NORTON	689

GROUP 1 D 113

6	BUTT HINGES	CB168 114.30MM X 107.98 (
1	EXIT DEVICE	98NL-F
1	CLOSER	4020
1	FLOOR STOP	S101 SERIES
		90S 4
1	KICK PLATES	K10A x door width less 50mn
1	PERIMETER SEALS	CT50
1	HOLD OPENS	2088-9589 Wall Mount

98 (4 1/2 x 4 1/4") STANLEY 26D
VON DUPRIN US26D
LCN US26D
STANDARD METAL 626
GLYNN JOHNSON US32D
Omm STANDARD METAL C32D
KN CROWDER
SIMPLEX



3 FRAME TYPES

AECOM DESIGNED BY: AC/KS APPROVED BY: SCALE: As indicated RELEASED FOR CONSTRUCTION 2025-02-26 00 ISSUED FOR TENDER

NO. REVISIONS 2025-02-26 AC JC CONSULTANT NO.:
DATE DESIGN CHECK U2-B601

KEVIN ARTHUR SIDDALL

2025-02-26

Winnipeg WATER AND WASTE DEPARTMENT

WATER AND WASTE DEPARTMENT

WATER AND WASTE DEPARTMENT PLANT

NEWPCC UV UPGRADES ARCHITECTURAL NEW UV STORAGE ROOM DOOR & FRAME SCHEDULE

SHEET REV. SIZE 00 A1

TENDER NO. 30-2025

CITY DRAWING NUMBER