



DEAD LOAD = 15 PSF WIND LOAD = 15 PSF

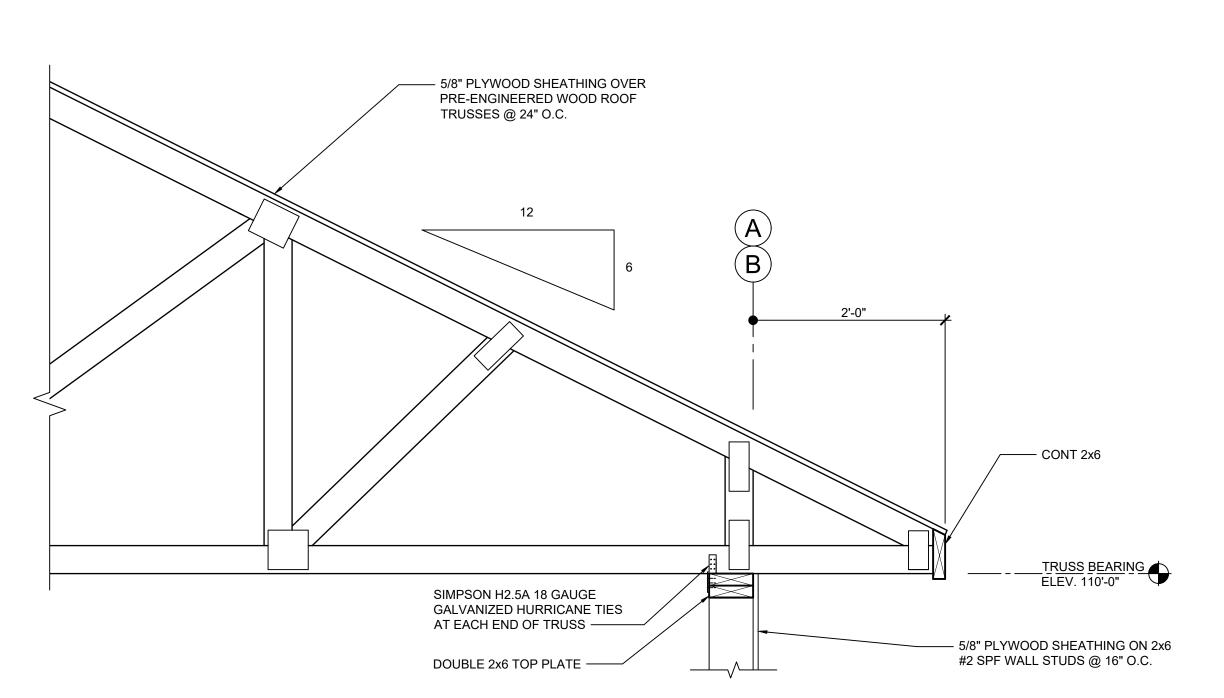

2 ROOF FRAMING SECTION S2 SCALE: 1" = 1'-0"

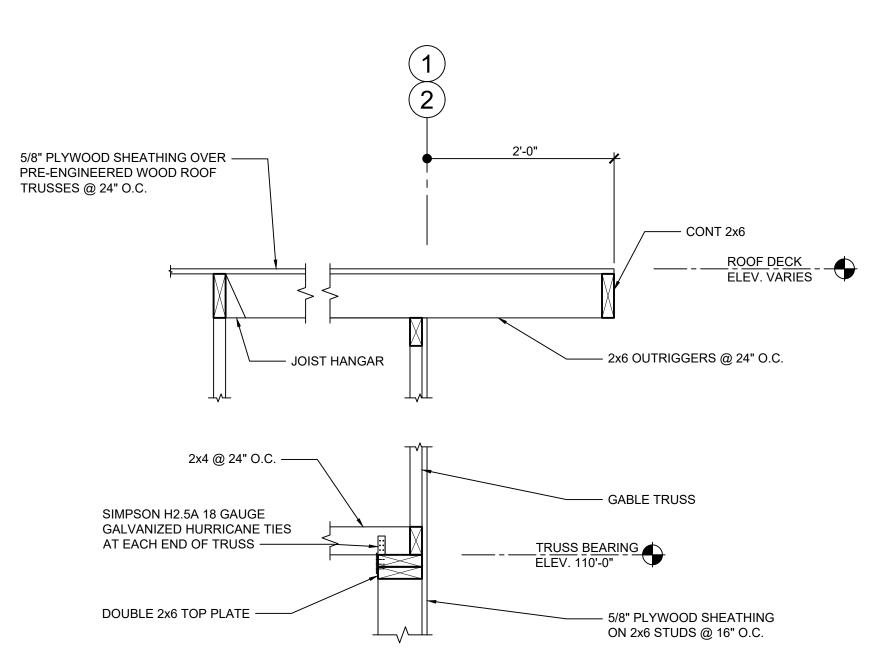

4 ROOF FRAMING SECTION S2 SCALE: 1" = 1'-0"

STRUCTURAL WOOD:

- . FRAMING LUMBER SHALL CONFORM TO THE LATEST EDITION OF CSA 0141 & SHALL BE OF THE FOLLOWING MINIMUM GRADES:
 - LINTELS, JOISTS & BEAMS: S-P-F NO. 2 STUD WALLS S-P-F NO. 2
- 2. ALL SHEATHING MATERIAL TO BE 5/8" STD. SPRUCE PLYWOOD IN ACCORDANCE WITH CSA 0325 UNLESS NOTED OTHERWISE. ALL SHEETS TO BE STAGGERED. FASTEN SHEET WITH 3" COMMON NAILS @ 300 O.C. ALONG ALL STUDS & AT 6" O.C. ALONG EDGES OF SHEET UNLESS NOTED OTHERWISE.
- 3. DESIGN ROOF TRUSSES, BRACING, BRIDGING & CONNECTORS TO THE REQUIREMENTS OF CSA 086.1-M89 & OTHER APPLICABLE STANDARDS TO SAFELY CARRY LOADS AS INDICATED ON THE DRAWINGS.


MANITOBA RESPONSIBLE FOR DESIGN.


- DRAWINGS.


 SUBMIT SHOP DRAWINGS BEARING STAMP OF
 QUALIFIED PROFESSIONAL ENGINEER LICENSED IN
- A. INDICATE SPECIES, SIZES & STRESS GRADES
 OF LUMBER USED AS TRUSS MEMBERS. SHOW
 PITCH, SPAN, CAMBER CONFIGURATION &
 SPACING OF TRUSSES. INDICATE
 CONNECTOR TYPES, THICKNESS SIZES,
 LOCATIONS & DESIGN VALUE. SHOW BEARING
 DETAILS.
- B. SUBMIT DIAGRAM INDICATING DESIGN LOAD
 OF EACH TRUSS MEMBER, SPECIAL LOADS,
 ALLOWABLE STRESS INCREASE &
 DEFLECTION LIMITS.
- TRUSS SUPPLIER SHALL BE RESPONSIBLE FOR FINAL INSPECTION & CERTIFICATION THAT TRUSSES ARE CONSTRUCTED & ERECTED AS PER TRUSS SUPPLIERS DESIGN ASSUMPTIONS.

GENERAL NOTES:

- THESE DRAWINGS SHALL NOT BE SCALED.
 THE CONTRACTOR SHALL VISIT THE SITE AND SATISFY ONESELF ALL DIMENSIONS, DATUM AND DETAILED INFORMATION SHOWN ARE CORRECT.
- THE CONTRACTOR IS TO REVIEW AND COORDINATE ALL ARCHITECTURAL, MECHANICAL, ELECTRICAL AND STRUCTURAL DRAWINGS FOR ADDITIONAL OPENINGS THROUGH FLOORS, WALLS, AND CEILINGS FOR DUCT, PIPE & ELECTRICAL RISERS AND ALL OPENINGS NOT SHOWN ON DRAWINGS.
 ALL PRODUCTS AND MATERIALS TO BE USED AND INSTALLED SHALL CONFORM WITH
- INSTALLED SHALL CONFORM WITH
 MANUFACTURER'S SPECIFICATIONS & APPLICABLE
 CODES.
- THIS BUILDING HAS BEEN DESIGNED IN ACCORDANCE WITH THE 2024 MANITOBA BUILDING CODE.

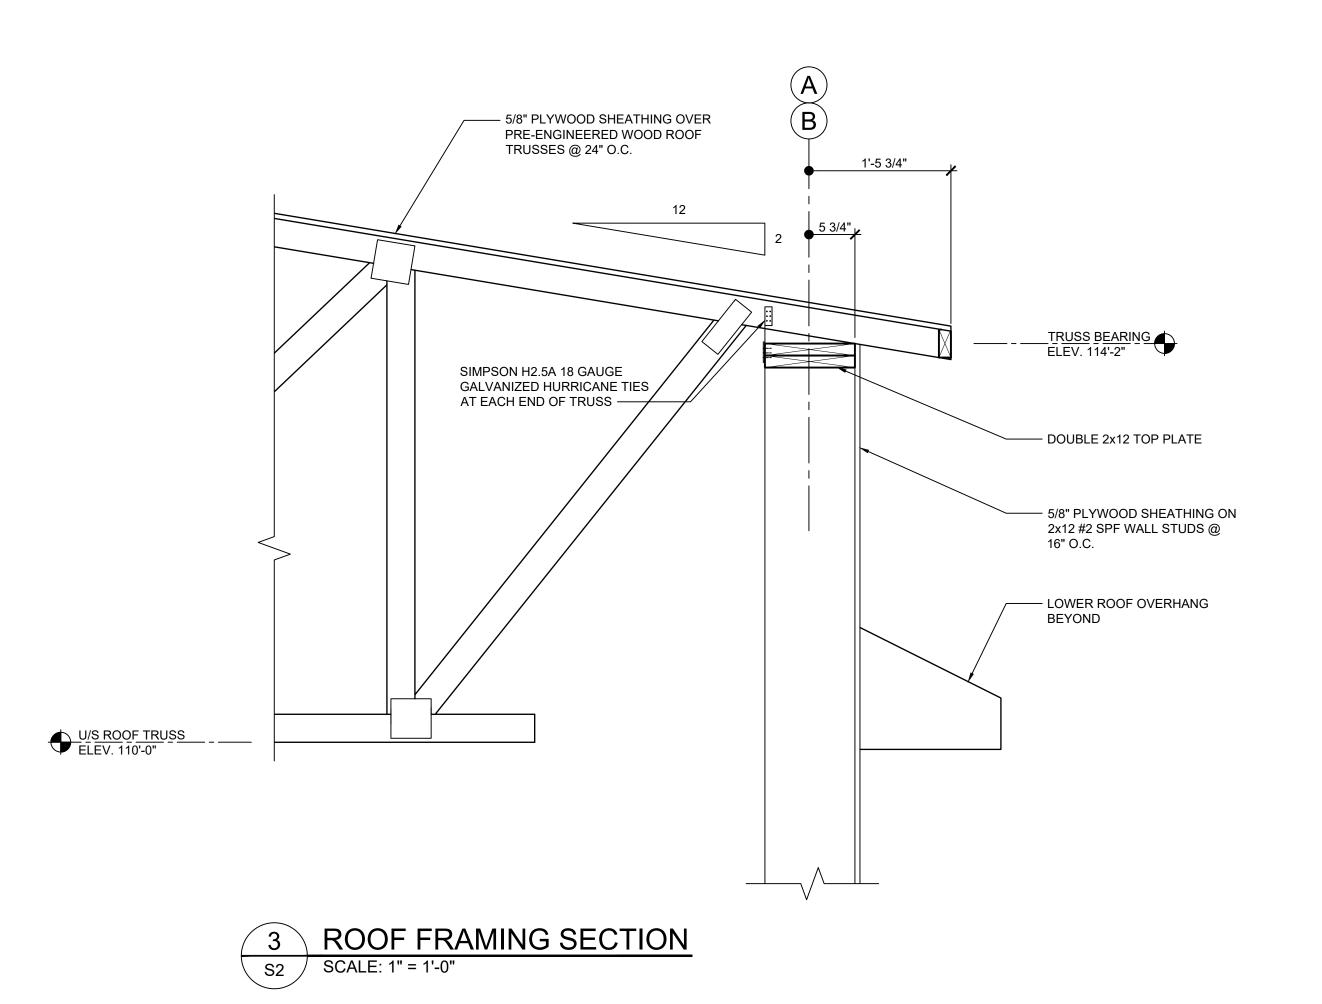

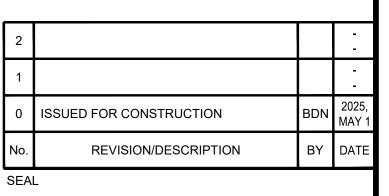

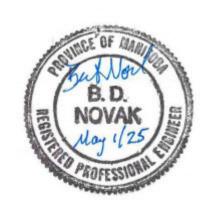

DATE DESIGN DRAWN CHECKED APPROVED 2025.01.05 BY: BDN BY: SJPB BY: BDN BY: BDN



THE CITY OF WINNIPEG

ASSETS & PROJECT MANAGEMENT DEPARTMENT

MUNICIPAL ACCOMMODATIONS DIVISION

3-65 GARRY STREET, R3C 4K4

PROJECT

PARKS & OPEN SPACE DIVISION
BUNN'S CREEK PARK - STORAGE GARAGE

365 McIVOR AVENUE

SHEET TITLE

ROOF FRAMING PLAN & SECTIONS

SCALE PROJECT No: SHEET No: S SHOWN 2023-049