

ELECTRICAL RENOVATION NOTES "X"

ALSO SEE GENERAL NOTES & SPECIFICATIONS.

ALL EXISTING/REWORK ELECTRICAL COMPONENTS & SYSTEMS SHALL MADE COMPLIANCE
TO THE 2021 CANADIAN ELECTRICAL CODE, PART I, 25TH EDITION (NOTED AS "CODE")
ADOPTED BY THE WINNIPEG ELECTRICAL BY-LAW NO. 72/2022. THIS INCLUDES
ABANDONED WIRES, CABLES, CONDUITS & ITS SUPPORTS SHALL BE REMOVED.
DO NOT DISTURB OR DISCONNECT ANY WIRING & CABLING IN AREA OF WORK REQUIRED
FOR OTHER AREAS.

1. PROVIDE EXTERIOR WELL, EXPANDED METAL WELL COVER, DRAINAGE TO WEEPING
TILES

- 1.1. PROVIDE (4) 3" EMT (2X2 MATRIX) BELOW GRADE FROM EXISTING CSTE LOAD SIDE TO (MD-1) AS SHOWN. SCAN CONCRETE WALL & MARK REBAR LOCATIONS TO ELIMINATE CUTTING INTO REBARS. CORED HOLES SHALL BE WATER-TIGHT USING LINK-SEAL
- 1.2. CORED HOLE LOCATIONS/CONDUITS SHALL SUIT CSTE (PREFER PLUMB)
 WITH-RESPECT-TO (MD-1). CONFIRM WITH CONTRACT ADMINISTRATOR AT AWARD.

2. GENERATOR

- 2.1. PROVIDE (TAP BOX), REFER TO ELECTRICAL SPEC. DRAWING.
- 2.1.1. SECURELY WALL MOUNT TO EXTERIOR WALL WITH TOP AT 6'-0" ABOVE FINISHED GRADE & 8" FROM WINDOW OPENING TO ALLOW FOR A SAFE CONNECTION DURING LOAD TEST.
- 2.2. PROVIDE U/G CONDUCTOR PATHWAYS FROM GENERATOR ELECTRICAL GLAND & STUB-UP AREA TO INSIDE (TAP BOX).
- 2.3. (TAP BOX) EXIT CONDUCTOR PATHWAYS ENTER INTO DRYING RM. 131 & RUN SECURELY BETWEEN ROOF DECK JOISTS THROUGH DRYING RM. 131 EAST WALL & RUN TIGHT AGAINST WALL ON APPARATUS SIDE DOWN THROUGH FLOOR INTO BASEMENT PIPE CHASE. PROVIDE WALL-MOUNTED LOW-PROFILE U-SHAPE GALVANIZED METAL SHROUD TO FULLY PROTECT CONDUCTORS.
- 2.4. PROVIDE CONDUCTOR PATHWAYS USING SECURELY CEILING-MOUNTED UNISTRUTS/ COMPONENTS IN PIPE CHASE.
- 2.5. RUN CONDUCTORS OUTSIDE PIPE CHASE ONTO TOP OF OWSJ & BETWEEN STEEL DECK FLUTES INTO ELECTRICAL ROOM B06 TO (ATS) UPPER CABINET CABLE ENTRANCE.
- 2.6. CONTROL CABLING IN 3/4" EMT TO WALL-MOUNTED DIGITAL GENSET CONTROLLER AT WATCHDESK 109.

3. WIRE FROM (ATS) TO (MD-1).

10' MINIMUM

N DSW (GEN-1)¹ C<u>DP-EP1-B</u>

FEEDERS & LOW VOLTAGE

DRYING 131

STRUCTURAL SLAB ON GRADE

APPARATUS ROOM STRUCTURAL SLAB ON GRADE

2.3

4. PROVIDE 4'X8'X3/4" THICK PLYWOOD SHEETS PAINTED WITH GREY FIRE RETARDANT PAINT TO COVER FULL WALL AREA BESIDE (CDP-E1).

5. PROVIDE 6" HIGH CONCRETE HOUSEKEEPING PAD TO EXTEND TO WEST WALL.

6. PROVIDE 6" HIGH CONCRETE HOUSEKEEPING PAD FOR (ATS). LOCATION TBD.

7. PROVIDE NEW PANELBOARDS, CIRCUIT BREAKERS & RE-CIRC PER PANEL SCHEDULE AS REFERENCE BUT SHALL FIELD SUIT PER EXISTING CONDITIONS.

8. REPLACE EXISTING WALL-MOUNTED TRANSFORMER WITH NEW (SEE DRAWING E9 SPEC). PROVIDE NEW WALL BRACKET TO SUIT, INSTALL/WIRE PER CODE. REWIRE LOAD SIDE WITH EXISTING TECK90. PROVIDE NEW FEEDERS TO (MD-1-B4) PER SLD DRAWING 7. GROUND PER CODE.

9. REPLACE EXISTING EXIT SIGN/LIGHT WITH RUNNING MAN SIGN COMBO UNIT. TYPE TO BE SAME AS EXISTING.

- 10. PROVIDE COMBINATION 120V SMOKE/CARBON MONOXIDE DETECTORS (PE/CO) WITH BATTERY BACKUP. CEILING MOUNTED 18" MINIMUM CLEARANCE FROM VENTS & COMPONENTS. INTERCONNECT ALL TO LOCALLY ALARM WITH REQUIRED CONTROLS TO EXISTING RELAY BOX ABOVE PANEL "EP-A" IN APPARATUS RM WITH ALL NECESSARY COMPONENTS, INCLUDING RELAYS.
- 11. PROVIDE CEILING MOUNTED HEAT DETECTORS. INTERCONNECT WITH COMBINATION 120V SMOKE/CARBON MONOXIDE DETECTORS (PE/CO).
- 12. REPLACE (2) LUMINAIRES, LIGHT SWITCH & FACEPLATE WITH NEW:
 12.1. THREE (3) TYPE "U" SUSPENDED HEIGHT AS PER EXISTING, CENTERED IN ROOM.
- 12.1. THREE (3) THE O SOSPENDED HEIGHT A
- 12.3. NEW STAINLESS STEEL FACEPLATE.
- 12.4. WIRE TO EXISTING CIRCUIT WITH ACUITY JOT ENABLE WIRELESS SOLUTION.
- 13. PROVIDE EMERGENCY DUAL-HEAD LIGHT/BATTERY COMBO (90-MINUTE MINUTE DURATION).

TO DISSUED FOR CONSTRUCTION TOTAL	09.11 2025
LA LISSUED FOR REVIEW IDTAL	08.15 2025
No. REVISION/DESCRIPTION BY	DATE

1. REFER TO DRAWING E1 & SPECIFICATIONS.

SEAL



DATE DESIGN DRAWN CHECKED APPROVED 2025.08.08 BY: DTA BY: DTA BY: BY:



THE CITY OF WINNIPEG

ASSETS & PROJECT MANAGEMENT DEPARTMENT
MUNICIPAL ACCOMMODATIONS DIVISION

3-65 GARRY STREET, R3C 4K4

PROJECT

WINNIPEG FIRE PARAMEDIC SERVICES FIRE STATION 1


ELECTRICAL DISTRIBUTION UPGRADE AND GENSET
65 ELLEN STREET TENDER No: 802-2025

SHEET TITLE

BASEMENT FLOOR PLAN
ELECTRICAL - RENOVATION
POWER AND SYSTEMS

POWER AND SYSTEMS

SCALE PROJECT No: SHEET No:
AS SHOWN 2024-070 E3

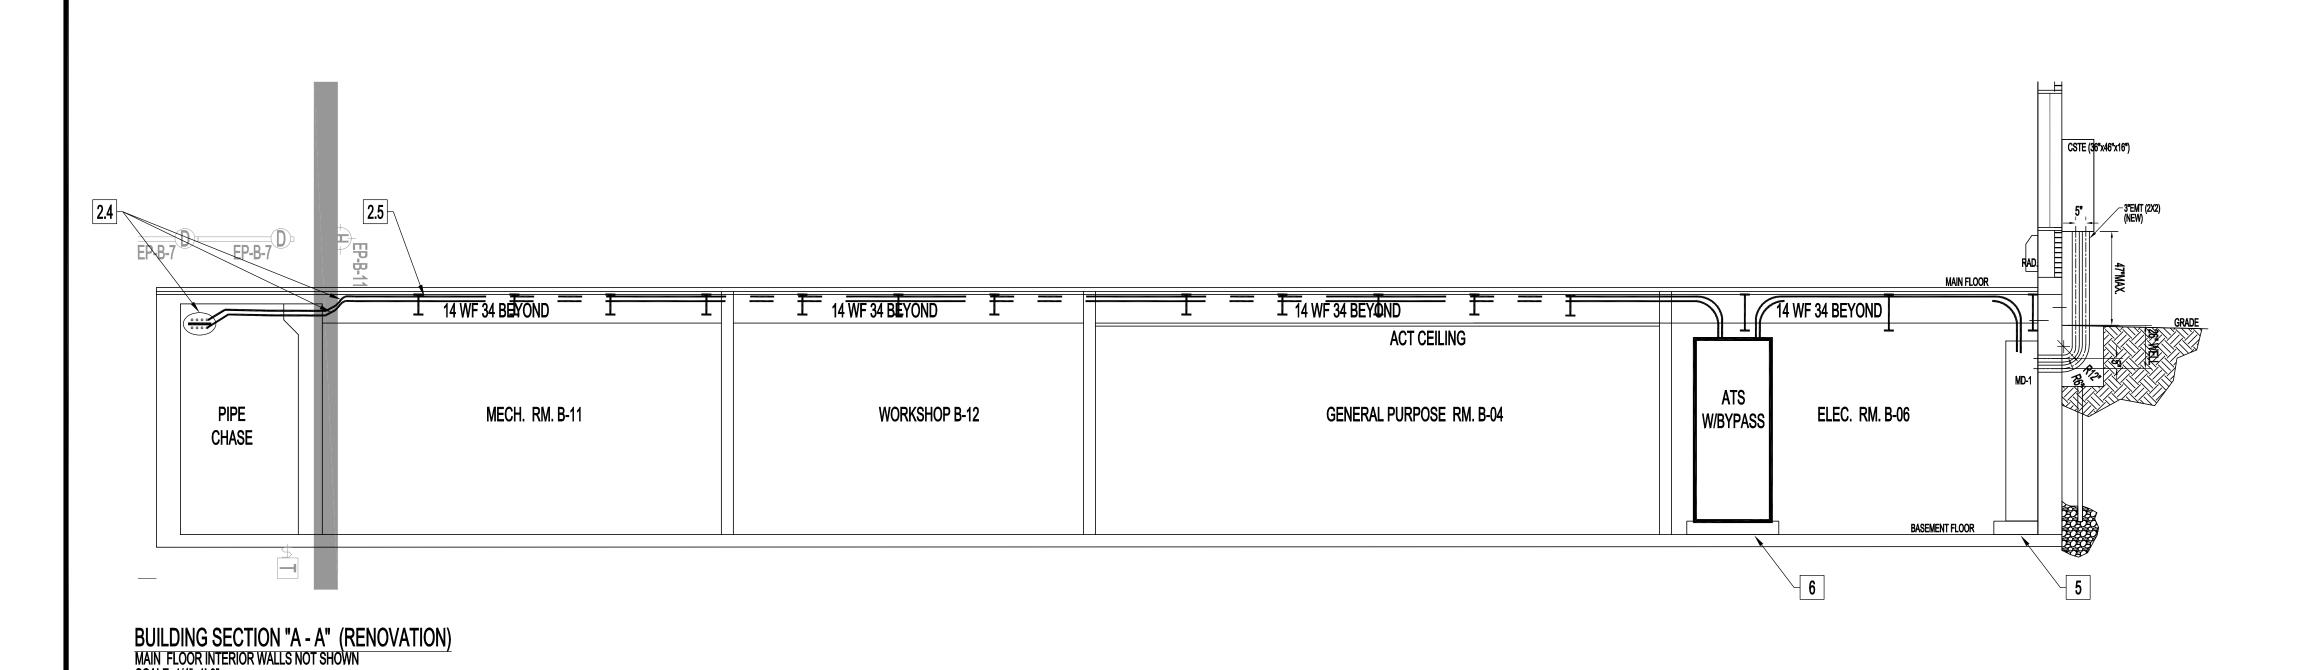

2.4

BOILER #1

AWLSPACE TCH

SCALE: 1/4"=1'-0"

APPARATUS ROOM STRUCTURAL SLAB

SCALE: 1/8"=1'-0"

BASEMENT FLOOR PLAN - RENOVATION

STAND-BY GENERATOR & PARTIAL SITE PLAN SHOWN FOR CLARITY