


GENERAL NOTES

1. THESE DRAWINGS SHALL NOT BE SCALED.
2. THE CONTRACTOR SHALL VISIT THE SITE AND SATISFY ONESELF ALL DIMENSIONS, DATUM AND DETAILED INFORMATION SHOWN ARE CORRECT.
3. THE CONTRACTOR IS TO REVIEW AND COORDINATE ALL ARCHITECTURAL, MECHANICAL, ELECTRICAL AND STRUCTURAL DRAWINGS FOR ADDITIONAL OPENINGS THROUGH FLOORS, WALLS, AND CEILINGS FOR DUCT, PIPE & ELECTRICAL RISERS AND ALL OPENINGS NOT SHOWN ON DRAWINGS.
4. ALL OPENINGS THROUGH FIRE ASSEMBLIES ARE TO BE FIRE STOPPED AND SEALED WITH ULC APPROVED FIRE STOPPING TO MAINTAIN THE INTEGRITY OF THE FIRE SEPARATION, AND PROVIDE A SMOKE-TIGHT BARRIER.
5. ALL PRODUCTS AND MATERIALS TO BE USED AND INSTALLED SHALL CONFORM WITH MANUFACTURER'S SPECIFICATIONS & APPLICABLE CODES.
6. THE CONTRACTOR SHALL BE RESPONSIBLE TO PATCH AND MAKE GOOD ALL EXISTING CONSTRUCTION AFFECTED BY THE REMOVAL OF ALL ITEMS FORMING THE PART OF THE RENOVATION WORK.
6. WHERE NEW FLOORING AND BASE IS TO BE INSTALLED IN EXISTING AREAS (REFER TO FLOOR PLAN AND ROOM SCHEDULE) THE EXISTING FLOORING SURFACE AND BASE MUST BE REMOVED, UNLESS OTHERWISE NOTED. ALL FLOOR SURFACES SHALL BE PREPARED IN ACCORDANCE TO MANUFACTURER'S RECOMMENDATIONS FOR INSTALLATION OF NEW FLOOR.
7. WHERE PAINTING OF EXISTING WALLS IS INDICATED ON THE ROOM SCHEDULE, THESE WALLS MUST BE CLEANED OF ANY EXISTING WALL COVERING, PATCHED & PREPARED TO ACCEPT NEW MATERIAL, UNLESS OTHERWISE NOTED.

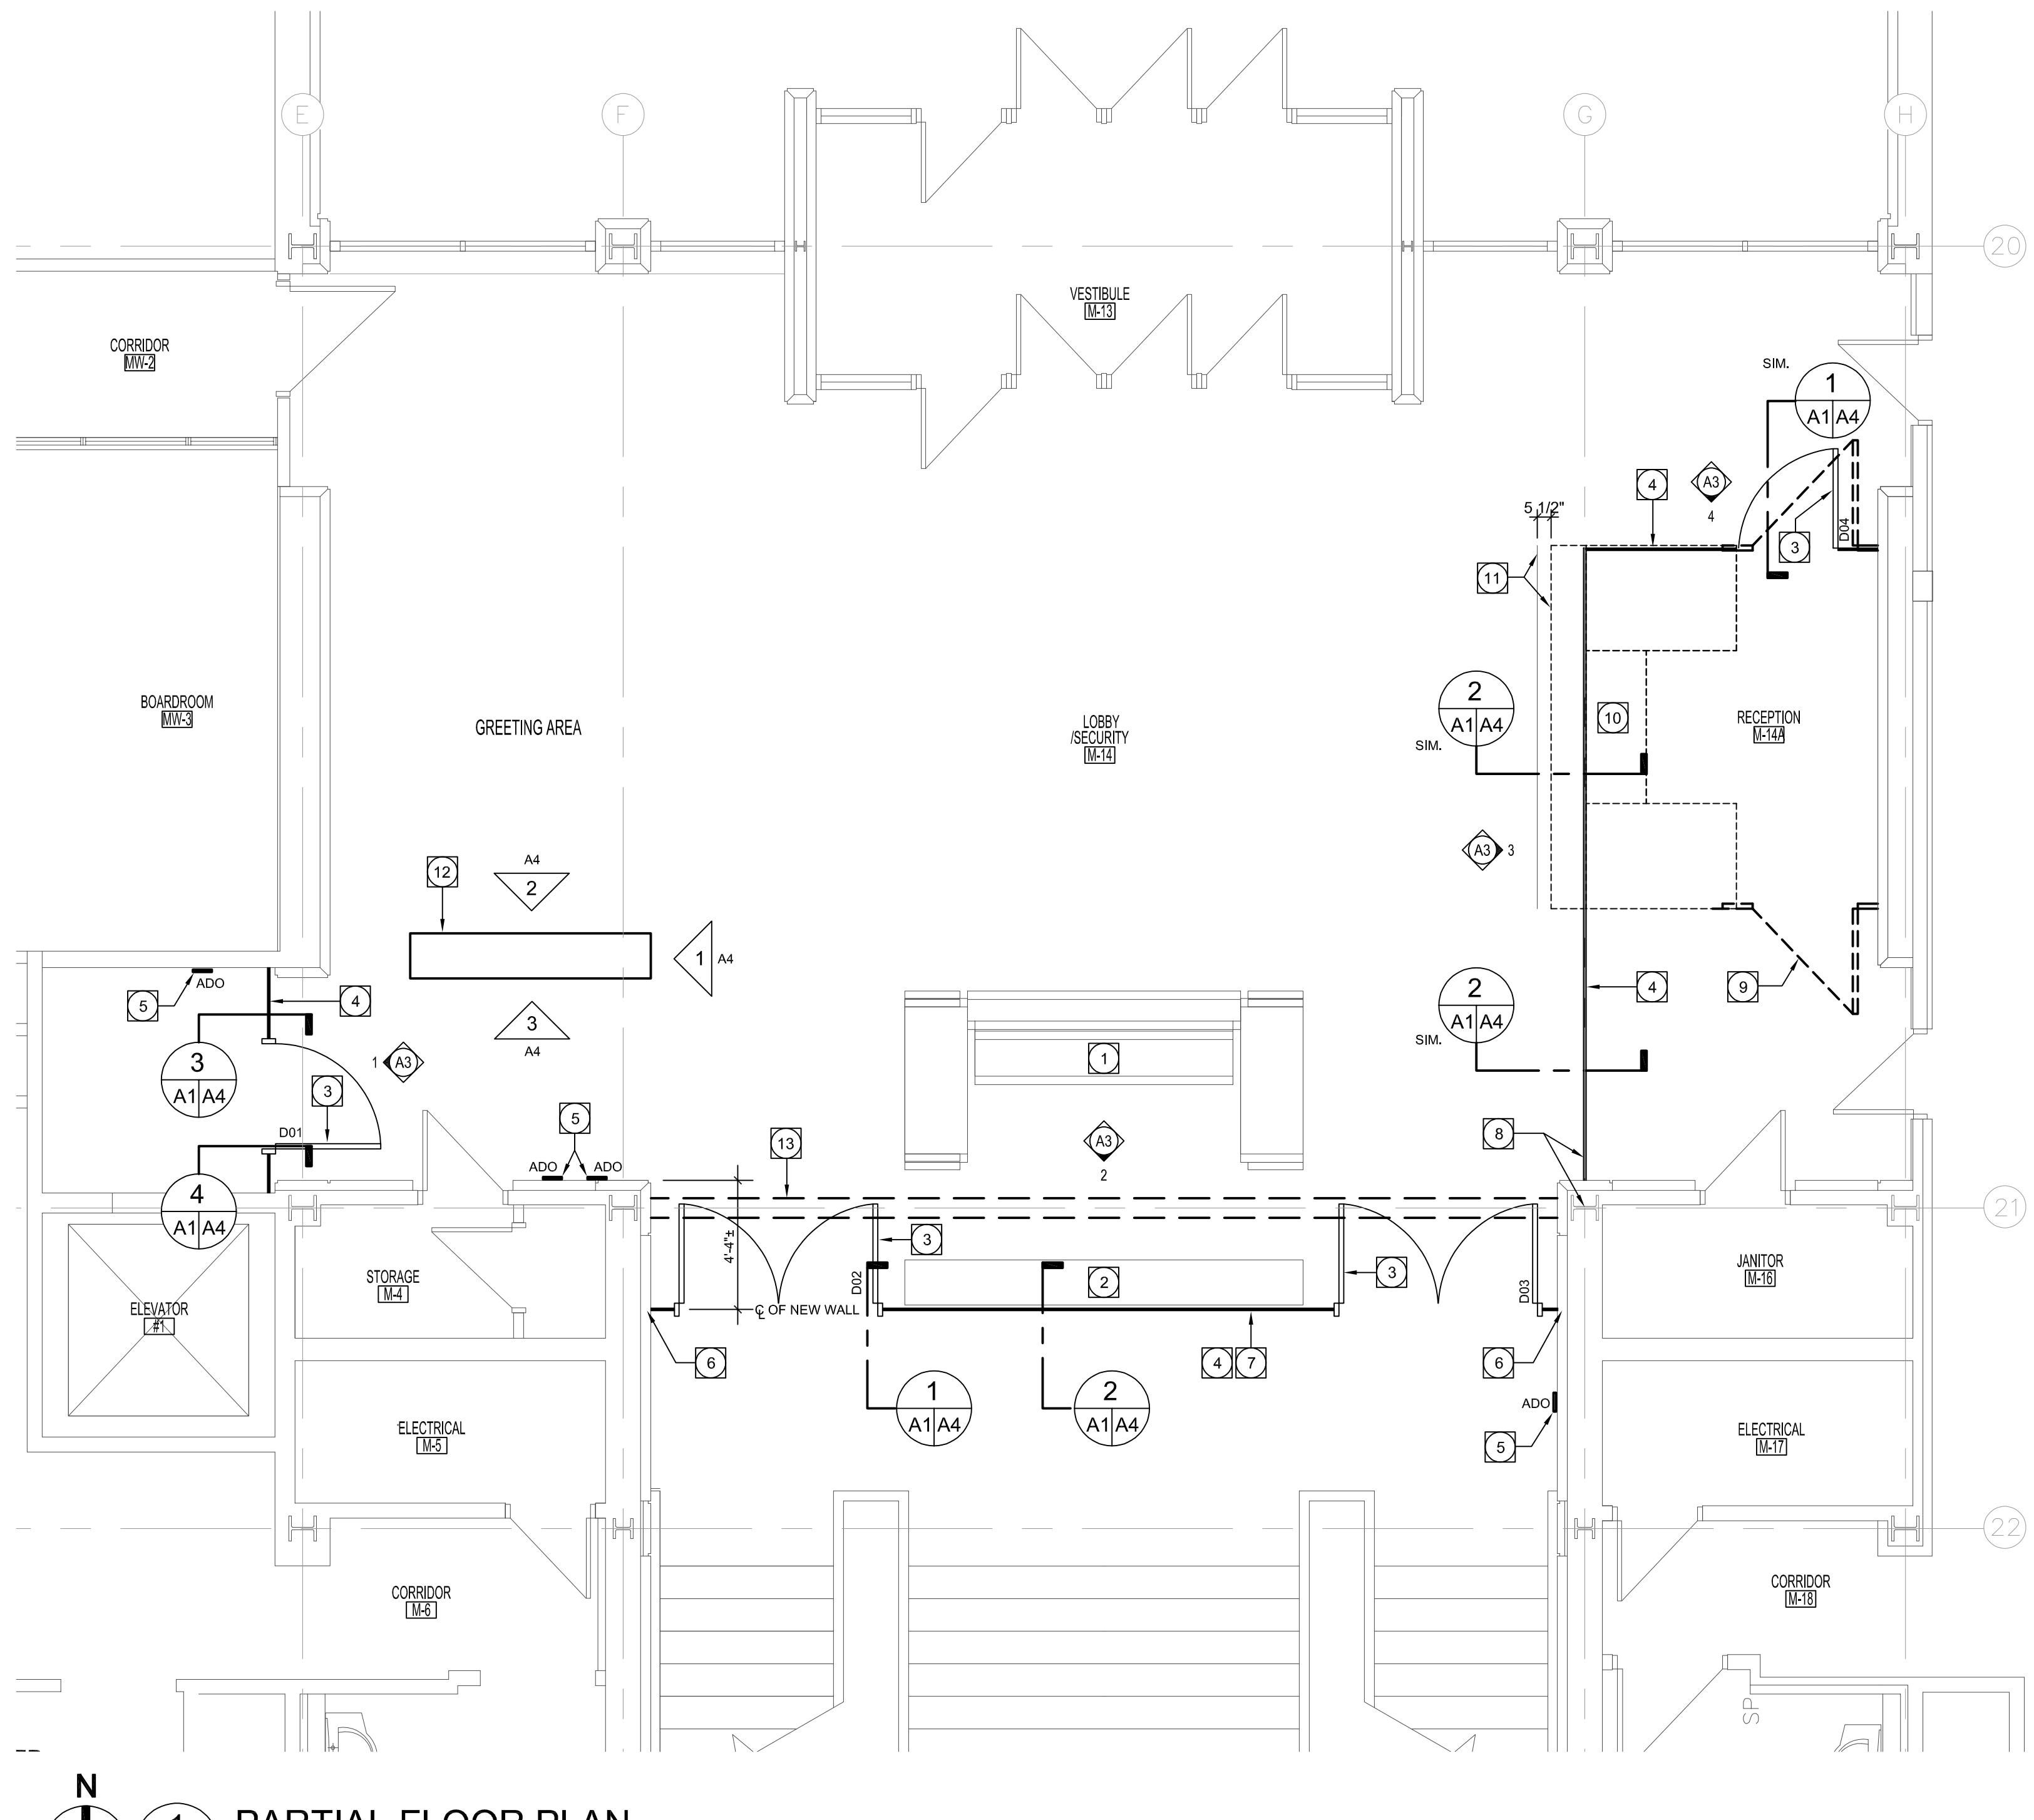

KEY NOTES


- 1 EXISTING SECURITY DESK.
- 2 EXISTING CREDENZA.
- 3 NEW GLASS DOORS. REFER TO ELEVATIONS AND SECTION DETAILS.
- 4 NEW GLASS PARTITION. REFER TO ELEVATIONS AND SECTION DETAILS.
- 5 NEW ADO TO MATCH EXISTING. REFER TO ELECTRICAL.
- 6 END OF NEW GLASS PARTITION NOT TO EXTEND INTO EXISTING LIGHT VALANCE ABOVE.
- 7 FACE OF NEW GLASS PARTITION TO RUN 1" FROM EXISTING CREDENZA.
- 8 NEW GLASS PARTITION TO BE CENTERED ON EXISTING COLUMN / BEAM.
- 9 REMOVE EXISTING GATE, TYPICAL BOTH SIDES.
- 10 EXISTING RECEPTION DESK.
- 11 MOVE EXISTING RECEPTION DESK APPROX. 5 1/2" AS INDICATED.
- 12 NEW MILLWORK LOCKERS. REFER TO ELEVATIONS / SECTIONS.
- 13 EXISTING 18WF77 BEAM ABOVE (LENGTH = 30'-0"±). EXISTING ASBESTOS CONTAINING FIREPROOFING TO BE REMOVED UNDER PROPER ASBESTOS ABATEMENT PROCEDURES. RE-FIREPROOF EXISTING BEAM WITH 2HR. RATED SPRAY-ON FIREPROOFING.

ASBESTOS

ASBESTOS MAYBE PRESENT BEHIND WALLS, CEILING SPACES & FLOORS. IF ASBESTOS OR ANY HAZARDOUS MATERIAL IS FOUND, STOP WORK IMMEDIATELY AND CONTACT CITY OF WINNIPEG CENTRAL CONTROLS @ 204 986-2351.

1	ISSUED FOR CONSTRUCTION	PAS	04.11 2025
A	ISSUED FOR CLASS 2 ESTIMATE	JWF	19.08 2025
No.	REVISION/DESCRIPTION	BY	DATE

SEAL

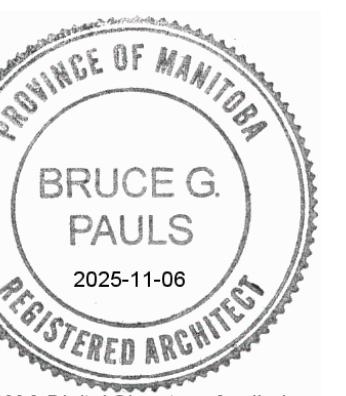

DATE 2025.06.27 DESIGN BY JWF / PAS DRAWN BY: PAS BY: APPROVED BY:



THE CITY OF WINNIPEG
ASSETS & PROJECT MANAGEMENT DEPARTMENT
MUNICIPAL ACCOMMODATIONS DIVISION
3-65 BARRY STREET, R3C 4K4

PROJECT
CITY HALL - COUNCIL BUILDING
RECEPTION SECURITY WALLS

510 MAIN STREET

SHEET TITLE
PARTIAL FLOOR PLAN

SCALE AS SHOWN PROJECT No: 2025-100 SHEET No: A1